

CONTRACT PLAN COMPONENTS

— ROADWAY PLANS

LEE COUNTY, FLORIDA  
DEPARTMENT OF TRANSPORTATION

BELL BOULEVARD (SR 82 TO SUNRISE BLVD.)  
SIDEWALK

COUNTY PROJECT ID: 6002

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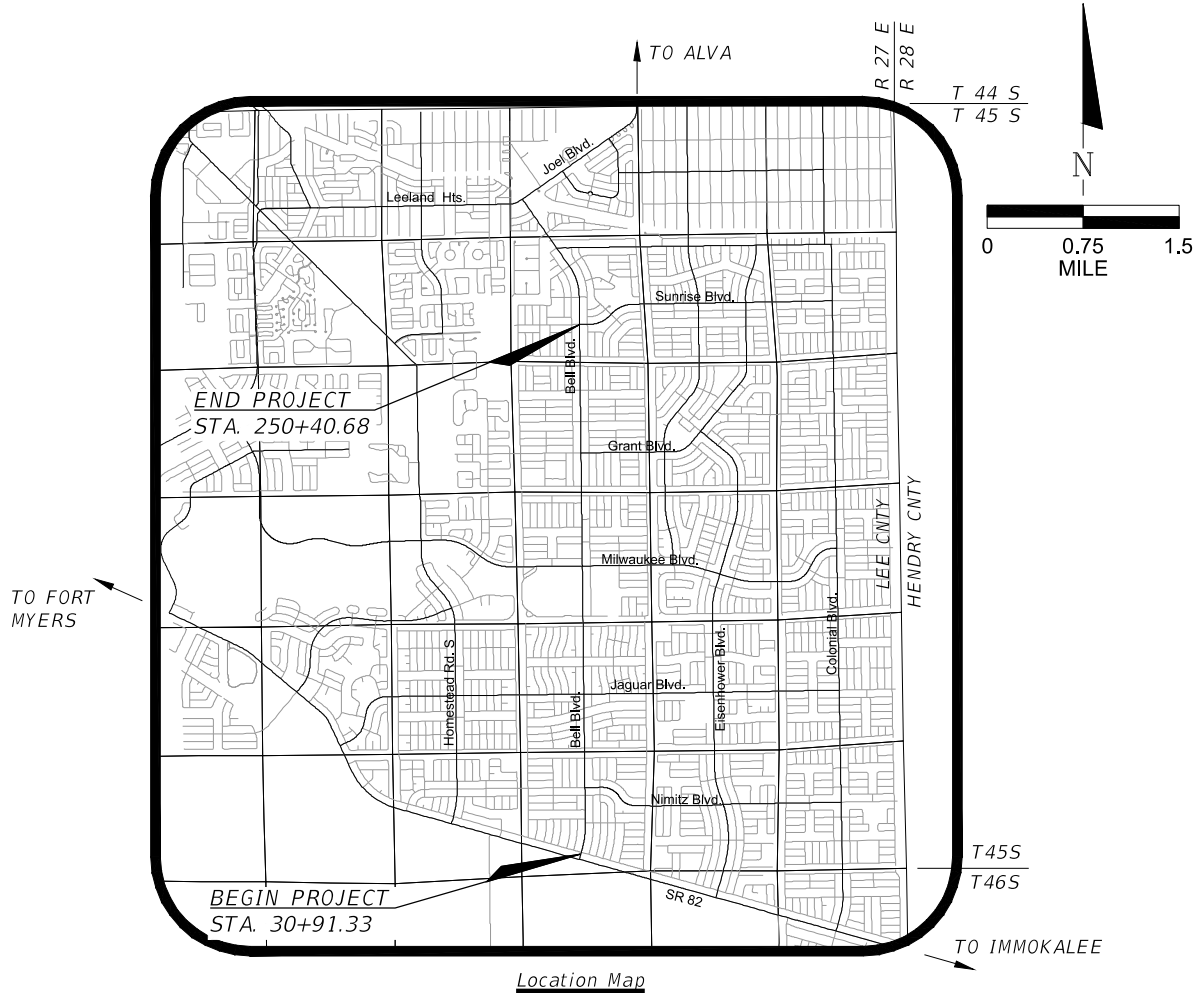
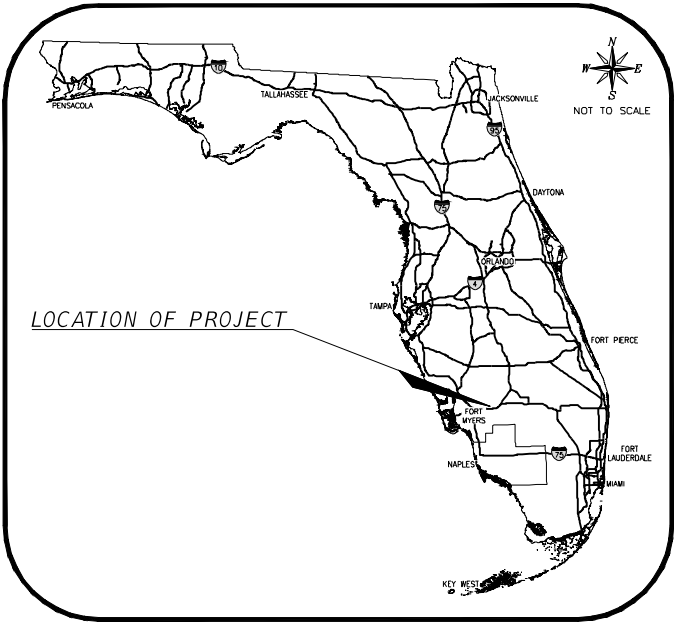
GOVERNING DESIGN STANDARDS:

FLORIDA DEPARTMENT OF TRANSPORTATION, FY 2024-25  
STANDARD PLANS FOR ROAD AND BRIDGE CONSTRUCTION AND  
APPLICABLE INTERIM REVISIONS (IRs).

STANDARD PLANS FOR ROAD CONSTRUCTION AND ASSOCIATED  
IRs ARE AVAILABLE AT THE FOLLOWING WEBSITE:  
<http://www.fdot.gov/roadway/Design/StandardPlans>

GOVERNING STANDARD SPECIFICATIONS:

DIVISION I OF THE LEE COUNTY DEPARTMENT OF TRANSPORTATION  
AND DIVISION II & III OF THE FLORIDA DEPARTMENT OF  
TRANSPORTATION, 2024-25 STANDARD SPECIFICATIONS FOR ROAD  
AND BRIDGE CONSTRUCTION AT THE FOLLOWING WEBSITE:  
<http://www.fdot.gov/programmanagement/Implemented/SpecBooks>




ROADWAY/DRAINAGE PLANS  
ENGINEER OF RECORD:

R. DANIEL FLYNN, P.E.  
Q. GRADY MINOR & ASSOC., P.A.  
3800 VIA DEL REY  
BONITA SPRINGS, FL 34134  
FLORIDA P.E. LICENSE NO. 76205  
EB/LB 0005151  
(239) 947-1144

LEE COUNTY  
PROJECT MANAGER:

KEITH RIDDLE, CGC

REVISIONS				 Q. Grady Minor and Associates, P.A. 3800 Via Del Rey Bonita Springs, Florida 34134 Phone: 239.947.1144 R. DANIEL FLYNN, P.E. NO. 76205	LEE COUNTY		KEY SHEET	SHEET NO.  1
DATE	DESCRIPTION	DATE	DESCRIPTION		ROAD NO.	COUNTY PROJECT NO.		
					BELL BLVD. SR 82 TO SUNRISE BLVD. SIDEWALK	6002		

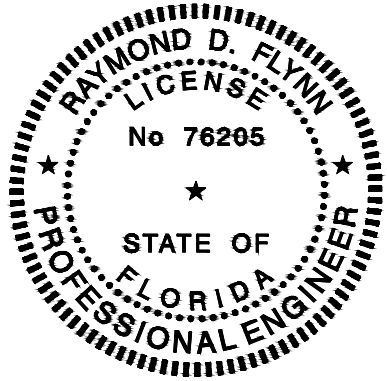

R. Daniel Flynn,  
P.E.

Digitally signed  
by R. Daniel  
Flynn, P.E.  
Date:  
2024.03.15  
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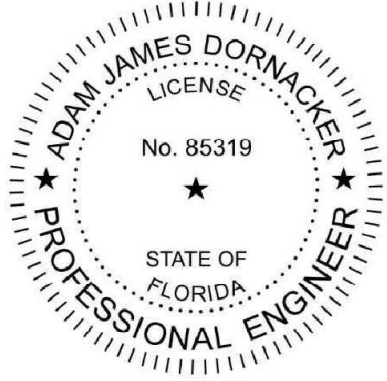
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ON THE DATE ADJACENT TO THE SEAL

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3800 VIA DEL REY  
BONITA SPRINGS, FL 34134  
RAYMOND D. FLYNN, P.E. 76205

THE ABOVE NAMED PROFESSIONAL ENGINEER SHALL BE RESPONSIBLE FOR THE FOLLOWING SHEETS IN ACCORDANCE WITH RULE 61G15-23.004, F.A.C.



THIS ITEM HAS BEEN DIGITALLY SIGNED AND SEALED BY:

Adam J  
Dornacker

Digitally signed by Adam J Dornacker  
DN: c=US, o=Florida,  
dnQualifier=A01410C0000018D6501B85000  
06104B, cn=Adam J Dornacker  
Date: 2024.03.15 16:54:02 -04'00'

ON THE DATE ADJACENT TO THE SEAL

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5621 2nd STREET WEST  
LEHIGH ACRES, FL 33971  
ADAM J. DORNACKER, P.E. 76205

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<u>SHEET NO.</u>	<u>SHEET DESCRIPTION</u>	<u>SHEET NO.</u>	<u>SHEET DESCRIPTION</u>
		72-80	ROADWAY SOIL SURVEY
1	KEY SHEET		
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REVISIONS				LEE COUNTY		SIGNATURE SHEET	SHEET NO.
DATE	DESCRIPTION	DATE	DESCRIPTION				
				ROAD NO.	COUNTY PROJECT NO.		2
				BELL BLVD. SR 82 TO SUNRISE BLVD. SIDEWALK	6002		



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BELL BLVD SR 82 TO SUNRISE BLVD. SIDEWALK PROJECT - SUMMARY OF PAY ITEMS			
Pay Item No.	Item Description	Unit	Quantity
101-1	MOBILIZATION	LS	1
102-1	MAINTENANCE OF TRAFFIC	LS	1
102-3	COMMERCIAL MATERIAL FOR TEMPORARY DRIVEWAY MAINTENANCE	CY	957.7
104-10-3	SEDIMENT BARRIER	LF	21130
104-18	INLET PROTECTION SYSTEM	EA	66
107-1	LITTER REMOVAL	AC	215.65
107-2	MOWING	AC	215.65
110-1-1	CLEARING & GRUBBING	AC	8.45
110-4-10	REMOVAL OF EXISTING CONCRETE	SY	5195
110-7-1	MAILBOX, F&I SINGLE	EA	75
120-1	REGULAR EXCAVATION	CY	2413.0
120-6	EMBANKMENT	CY	1795.0
160-4	TYPE B STABILIZATION	SY	1592
285-709	OPTIONAL BASE, BASE GROUP 09	SY	1523
327-70-1	MILLING EXISTING ASPHALT PAVEMENT, 1" AVG DEPTH	SY	3284
334-1-13	SUPERPAVE ASPHALTIC CONC, TRAFFIC C	TN	122.6
337-7-82	ASPHALT CONCRETE FRICTION COURSE,TRAFFIC C, FC-9.5, PG 76-22	TN	262.4
425-1521	INLETS, DT BOT, TYPE C, <10'	EA	33
425-2-61	MANHOLE, P-8, <10'	EA	1
430-94-1	DESILTING PIPE, 0 - 24"	LF	2633
430-174-118	PIPE CULV, OPT MATL, ROUND, 18"SD	LF	1342
430-174-124	PIPE CULV, OPT MATL, ROUND, 24"SD	LF	5
430-174-215	PIPE CULVERT,OPTIONAL MATERIAL,OTHER-ELIP/ARCH, 15"SD	LF	1113
430-984-125	MITERED END SECTION, OPTIONAL ROUND, 18" SD	EA	1
430-984-623	MITERED END SECTION, OPTIONAL OTHER - ELLIP/ARCH, 15" SD	EA	68
522-2	CONCRETE SIDEWALK AND DRIVEWAYS, 6" THICK	SY	19597
527-2	DETECTABLE WARNINGS	SF	984
570-1-2	PERFORMANCE TURF, SOD	SY	21314
580-12-35	ROOT BARRIER- 24"	LF	1611
700-1-11	SINGLE POST SIGN, F&I GROUND MOUNT, UP TO 12 SF	AS	1
700-1-50	SINGLE POST SIGN, RELOCATE	AS	11
700-1-60	SINGLE POST SIGN, REMOVE	AS	2
705-10-2	OBJECT MARKER, TYPE 2	EA	20
710-90	PAINTED PAVEMENT MARKINGS, FINAL SURFACE	LS	1
711-11123	THERMOPLASTIC, STANDARD, WHITE, SOLID, 12" FOR CROSSWALK AND ROUNDABOUT	LF	2831
711-11125	THERMOPLASTIC, STANDARD, WHITE, SOLID, 24" FOR STOP LINE AND CROSSWALK	LF	355
711-11224	THERMOPLASTIC, STANDARD, YELLOW, SOLID, 18" FOR DIAGONAL OR CHEVRON	LF	20
711-14125	THERMOPLASTIC, PREFORMED, WHITE, SOLID, 24" FOR CROSSWALK	LF	580
711-16101	THERMOPLASTIC, STANDARD-OTHER SURFACES, WHITE, SOLID, 6"	GM	0.004
711-16201	THERMOPLASTIC, STANDARD-OTHER SURFACES, YELLOW, SOLID, 6"	GM	0.015

PAY ITEM NOTES:

- 107-1 & 107-2 PROJECT DURATION 300 DAYS
- 110-1-1  
TREE TRIMMING, TREE REMOVAL & OTHER LANDSCAPING REMOVAL AS SHOWN ON PLANS IS INCLUDED IN CLEARING & GRUBBING.  
CONTRACTOR TO SUBMIT THEIR TREE REMOVAL PLAN, INCLUDING STUMP GRINDING PLAN, TO THE COUNTY FOR APPROVAL PRIOR TO CLEARING AND GRUBBING.  
  
COST ASSOCIATED WITH REMOVING AND PLACING PAVERS ON PALLET INCLUDED IN ITEM 110-1-1 CLEARING AND GRUBBING.  
  
ASPHALT AND BASE REMOVAL AS SHOWN IN THE PLANS SHALL BE INCLUDED IN PAY ITEM 110-1-1 CLEARING AND GRUBBING.
- 102-3  
COMMERCIAL MATERIAL SHALL NOT BE USED TO CORRECT MOT DEFICIENCIES SUCH AS DROP OFFS.
- 337-7-82  
ANY NECESSARY ADJUSTMENT TO EXISTING MANHOLES OR VALVES ARE INCLUDED IN ITEM 337-7-82.
- 430-94-1  
CLEAN AND DESILT ALL EXISTING STORM DRAIN PIPES AND INLETS AND PROVIDE VIDEO DOCUMENTATION POST CLEANING.
- 430-984-XXX  
MITERED END SECTIONS SHALL BE CONSTRUCTED AT OR BELOW ELEVATION OF ADJACENT DRIVEWAY AND ARE AT A MAXIMUM 4:1 UNLESS OTHERWISE NOTED.
- 522-2  
ANY NECESSARY ADJUSTMENTS TO EXISTING MANHOLES OR VALVES ARE INCLUDED IN ITEM 522-2.
- 527-2  
ALL DETECTABLE WARNING WARNINGS SHALL BE WET-SET.

GENERAL NOTES:

1. THE HORIZONTAL CONTROL FOR THIS PROJECT IS BASED ON THE FLORIDA STATE PLAN COORDINATE SYSTEM, WEST ZONE, NORTH AMERICAN DATUM OF 1983 (NAD83 DATUM WITH 2011 ADJUSTMENT). BENCHMARK ELEVATIONS ARE BASED ON THE NORTH AMERICAN VERTICAL DATUM OF 1988 (NAVD 88).
2. EXISTING FACILITIES SHALL BE RESTORED TO THAT WHICH EXISTED PRIOR TO COMMENCING CONSTRUCTION AT NO ADDITIONAL COST TO OWNER.
3. EXISTING DRAINAGE STRUCTURES WITHIN CONSTRUCTION LIMITS SHALL REMAIN UNLESS OTHERWISE NOTED. ALL EXISTING DRAINAGE TO BE MAINTAINED THROUGHOUT CONSTRUCTION.
4. ALL EXCAVATION IN CLOSE PROXIMITY TO A POWER POLE SHALL UTILIZE TRENCH BOXED OR OTHER MEANS OF SHORING TO ENSURE THE POLES ARE NOT UNDERMINED.
5. THE LOCATIONS OF THE EXISTING UTILITIES SHOWN IN THE PLANS ARE BASED ON LIMITED INVESTIGATION TECHNIQUES AND SHOULD BE CONSIDERED APPROXIMATE ONLY.

UTILITY AGENCY OWNERS:


<u>COMPANY NUMBER</u>	<u>SERVICE</u>	<u>CONTACT</u>	<u>TELEPHONE</u>
LEE COUNTY ELECTRIC CO-OP	ELECTRIC, STREET LIGHTS	TOM BAILY	239-656-2414
CENTURYLINK	FIBER, TELEPHONE	BILL MCCLOUD	850-599-1444
FLORIDA GOVERNMENTAL UTILITIES AUTHORITY - LEHIGH (FGUA)	SEWER, WATER	LINA MARIA QUINTERO, PE	727-858-2396
COMCAST	CATV	JOSH DAVIS	239-253-7642

6. NOTIFY ALL UTILITY COMPANIES IN THE AREA AT LEAST 48 HOURS PRIOR TO CONSTRUCTION AND CALL THE SUNSHINE STATE ONE AT 1-800-432-4770.
7. EXISTING UTILITIES ARE TO REMAIN IN PLACE UNLESS OTHERWISE NOTED.
8. ANY PUBLIC LAND CORNER WITHIN THE LIMITS OF CONSTRUCTION IS TO BE PROTECTED. IF A CORNER MONUMENT IS IN DANGER OF BEING DESTROYED AND HAS NOT BEEN PROPERLY REFERENCED, THE CONTRACTOR SHALL NOTIFY LEE COUNTY, WITHOUT DELAY, BY TELEPHONE AT 239-533-9400.
9. ALL EROSION CONTROL DEVICES ARE TO BE INSTALLED IN ACCORDANCE WITH THE STATE OF FLORIDA EROSION AND SEDIMENT CONTROL MANUAL.
10. AT THE COMPLETION OF THIS PROJECT, ALL DISTURBED AREAS THAT ARE NOT TO BE PAVED OR CONCRETE SHALL BE SODDED. QUANTITIES SHOWN INCLUDE THAT AREA INTENDED TO BE DISTURBED WHICH IS DETAILED ON THE TYPICAL SECTIONS. OTHER DISTURBED AREAS ARE CONTRACTOR'S RESPONSIBILITY.
11. ALL PROPOSED PIPE WITHIN THE RIGHT-OF-WAY SHALL BE REINFORCED CONCRETE PIPE (RCP/ERCP).
12. CONTRACTOR SHALL NOTIFY RESIDENCES AND BUSINESSES AT LEAST 48 HOURS IN ADVANCE OF ANY DISRUPTION IN SERVICE, INCLUDING DRIVEWAY CUTS.
13. PROMPTLY NOTIFY ALL FIELD CHANGES TO THE ENGINEER.
14. CONSTRUCTION STAKING IS THE CONTRACTOR'S RESPONSIBILITY TO PROVIDE. THE CONTRACTOR SHALL BE RESPONSIBLE FOR COORDINATING THESE SERVICES DURING CONSTRUCTION.
15. ALL EXISTING TREES WITHIN THE EXISTING RIGHT OF WAY ARE TO BE TRIMMED TO MAINTAIN TEN (10) FEET VERTICAL CLEARANCE AND TWO (2) FEET HORIZONTAL CLEARANCE FROM SIDEWALK. TRIMMING IS INCLUDED IN PAY ITEM 110-1-1.

16. DRIVEWAY ACCESS SHALL BE PROVIDED TO RESIDENTS AT ALL TIMES UNLESS PREVIOUSLY APPROVED BY THE COUNTY.
17. CONTRACTOR IS RESPONSIBLE FOR OBTAINING A DEWATERING PERMIT AT THEIR OWN EXPENSE, IF REQUIRED.
18. PRIOR TO CONSTRUCTION, A GOPHER TORTOISE RELOCATION PERMIT WILL BE REQUIRED FROM THE FWCC TO RELOCATE TORTOISES TO AN APPROVED OFF-SITE RECIPIENT AREA. THE GOPHER TORTOISE RELOCATION WILL NOT BE PART OF THE CONTRACTOR'S SCOPE OF WORK BUT THE CONTRACTOR SHALL BE AWARE THAT GOPHER TORTOISE BURROWS ARE WITHIN THE PROJECT LIMITS AND THE CONTRACTOR SHALL NOT DISTURB THE BURROWS.
19. THE CONTRACTOR SHALL BE RESPONSIBLE FOR CAPPING DAMAGED IRRIGATION LINES WITHIN THE ROW.
20. THE CONTRACTOR SHALL BE AWARE OF RESIDENTIAL DRAIN FIELDS, WELLS AND SEPTIC TANKS IN CLOSE PROXIMITY OF THE CONSTRUCTION LIMITS AND USE EXTREME CAUTION DURING EXCAVATION AND TREE REMOVAL. THE CONTRACTOR SHALL BE RESPONSIBLE FOR ANY DAMAGE TO EXISTING DRAIN FIELDS, WELLS AND SEPTIC TANKS.

REVISIONS				<div><div></div><div>Q. Grady Minor and Associates, P.A. 3800 Via Del Rey Bonita Springs, Florida 34134 Phone: 239.947.1144 R. DANIEL FLYNN, P.E. NO. 76205</div></div> <div>Civil Engineers • Land Surveyors • Planners • Landscape Architects <small>CERT. of AUTH. EB 0005151    CERT. of AUTH. LB 0005151    BUSINESS LC 26000266</small></div>	LEE COUNTY		GENERAL NOTES	SHEET NO.
DATE	DESCRIPTION	DATE	DESCRIPTION					
								4



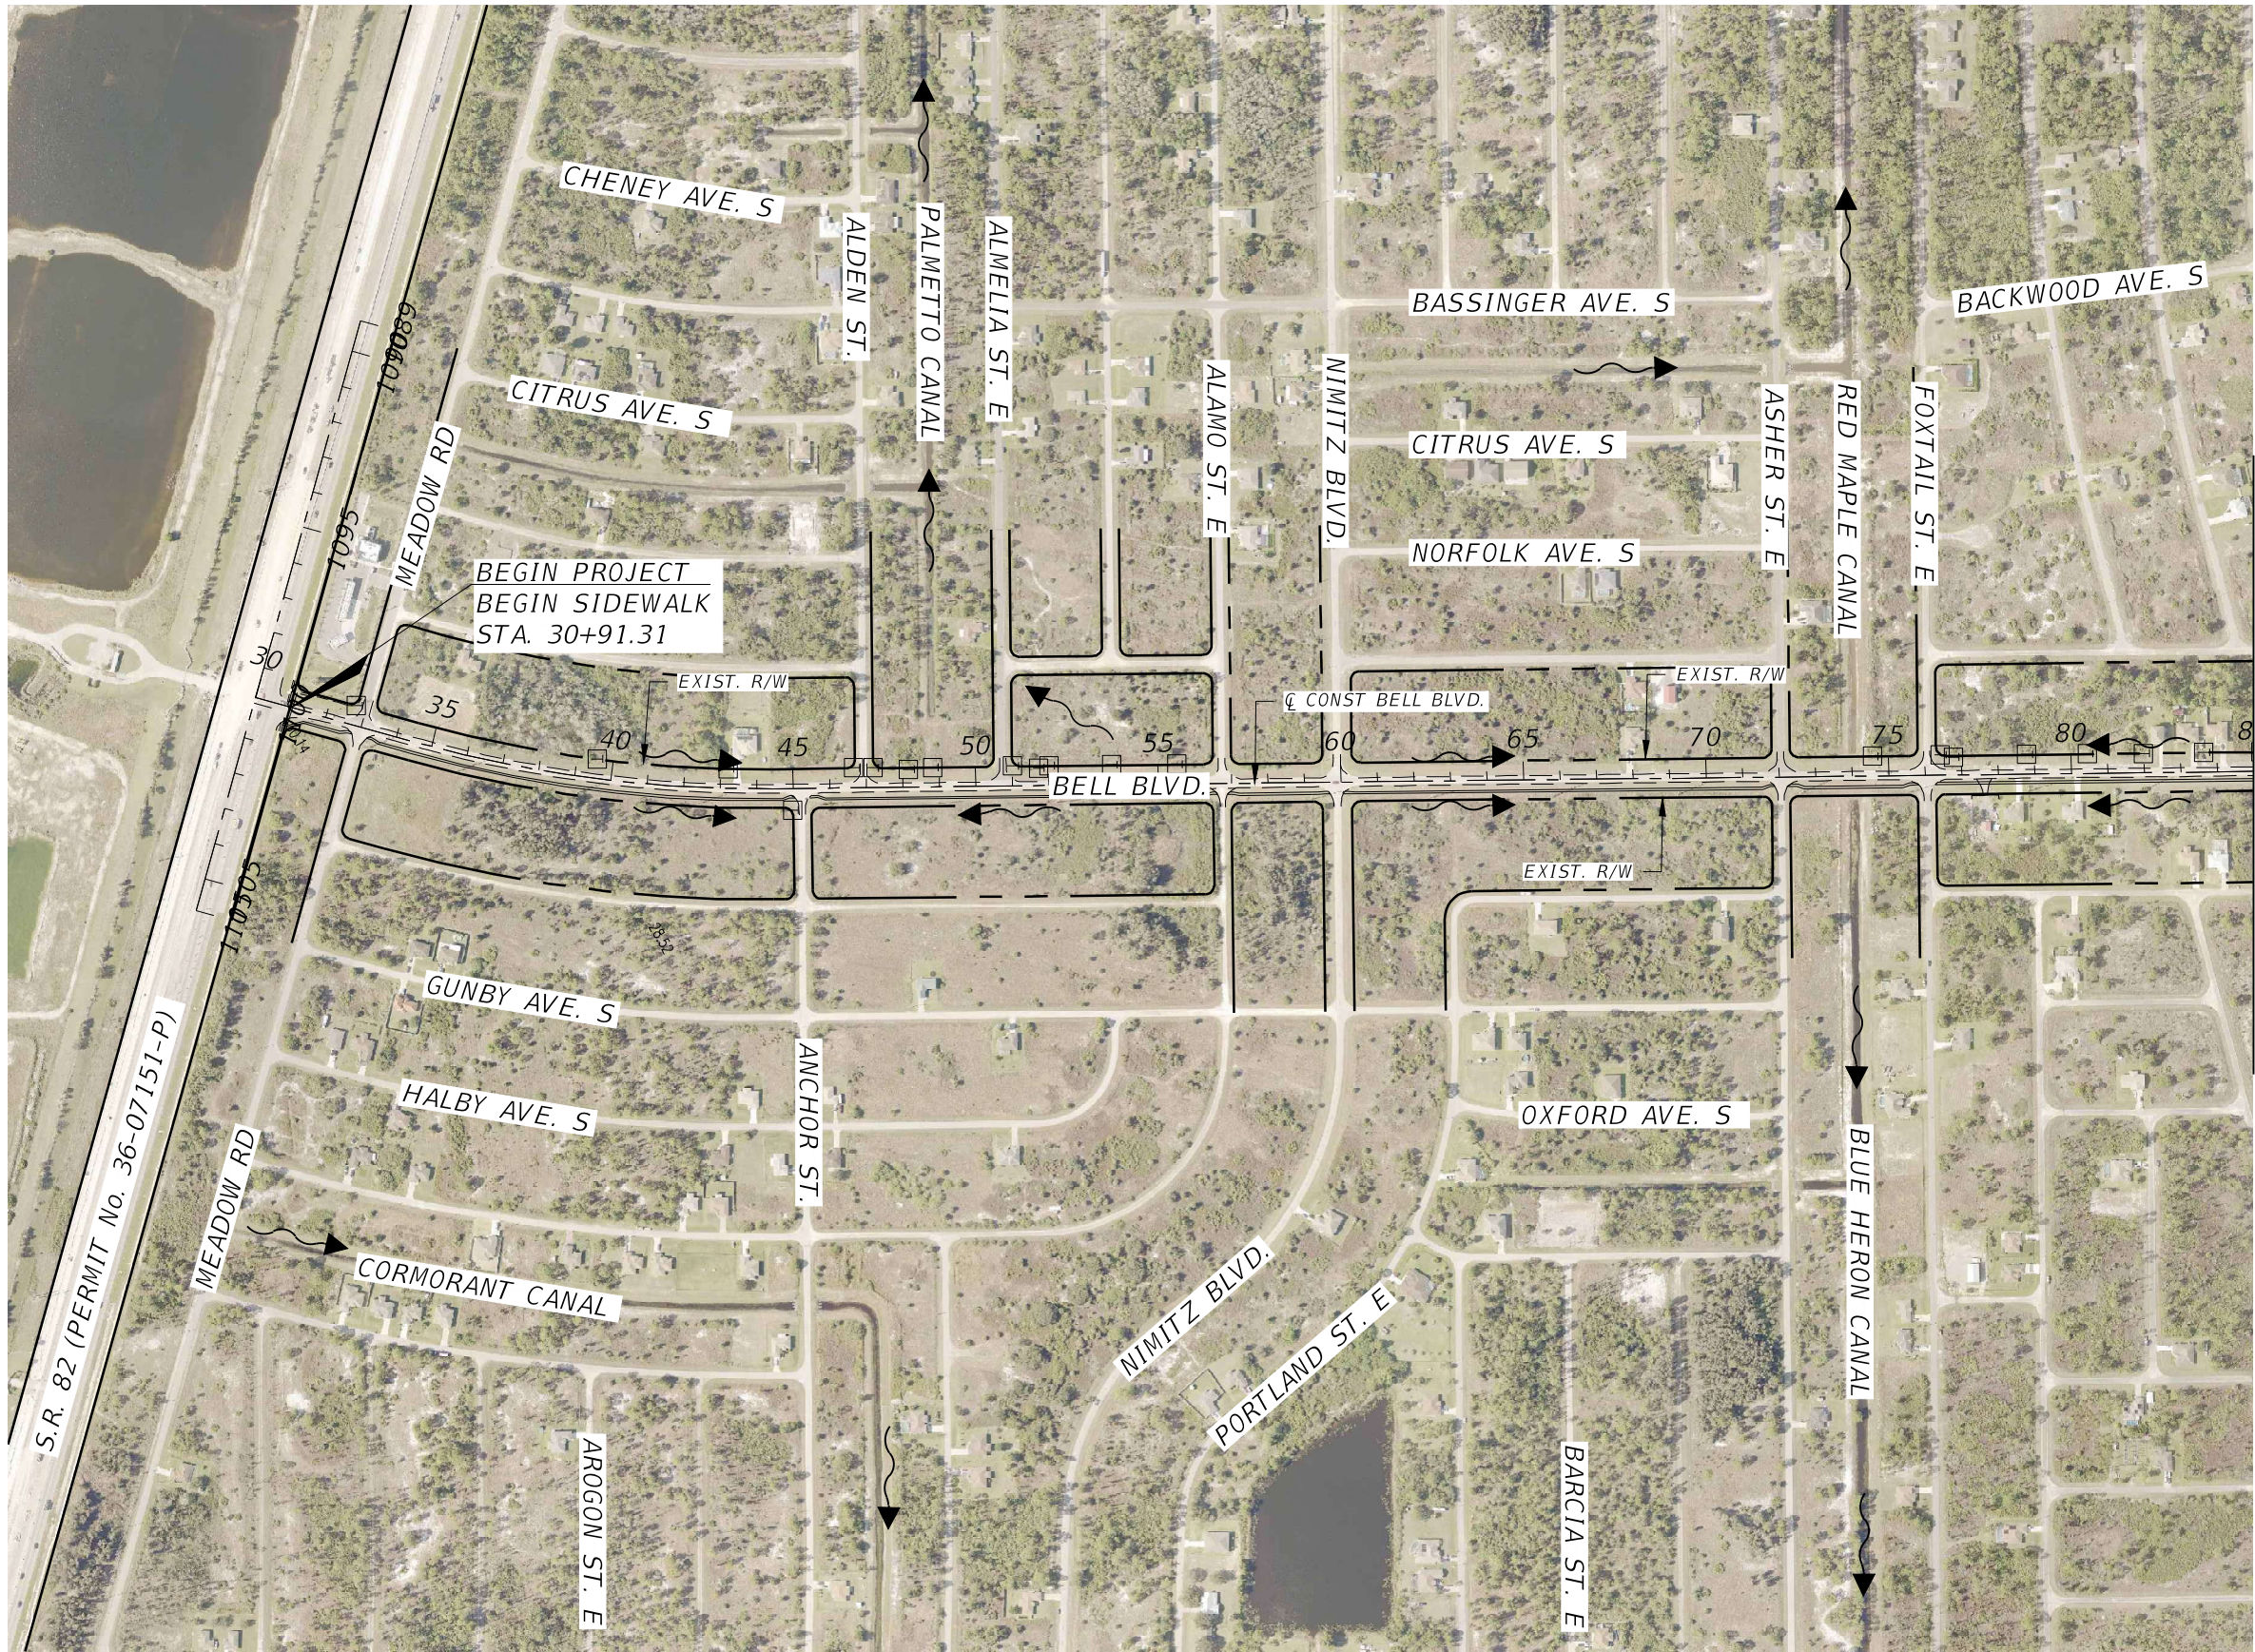


NOTE:  
DO NOT USE THE INFORMATION ON THIS SHEET FOR CONSTRUCTION PURPOSES. THIS SHEET IS IN THE PLANS FOR DOCUMENTATION AND TO ASSIST CONSTRUCTION PERSONNEL WITH DRAINAGE CONCERNS.

ELEVATIONS SHOWN HEREON ARE BASED UPON NORTH AMERICAN VERTICAL DATUM 1988 (NAVD '88).

REVISIONS			
DATE	DESCRIPTION	DATE	DESCRIPTION





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R. DANIEL FLYNN, P.E. NO. 76205

LEE COUNTY	
ROAD NO.	COUNTY PROJECT NO.
BELL BLVD. SR 82 TO SUNRISE BLVD. SIDEWALK	6002

DRAINAGE MAP	
SHEET NO.	
5	



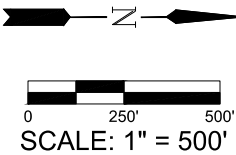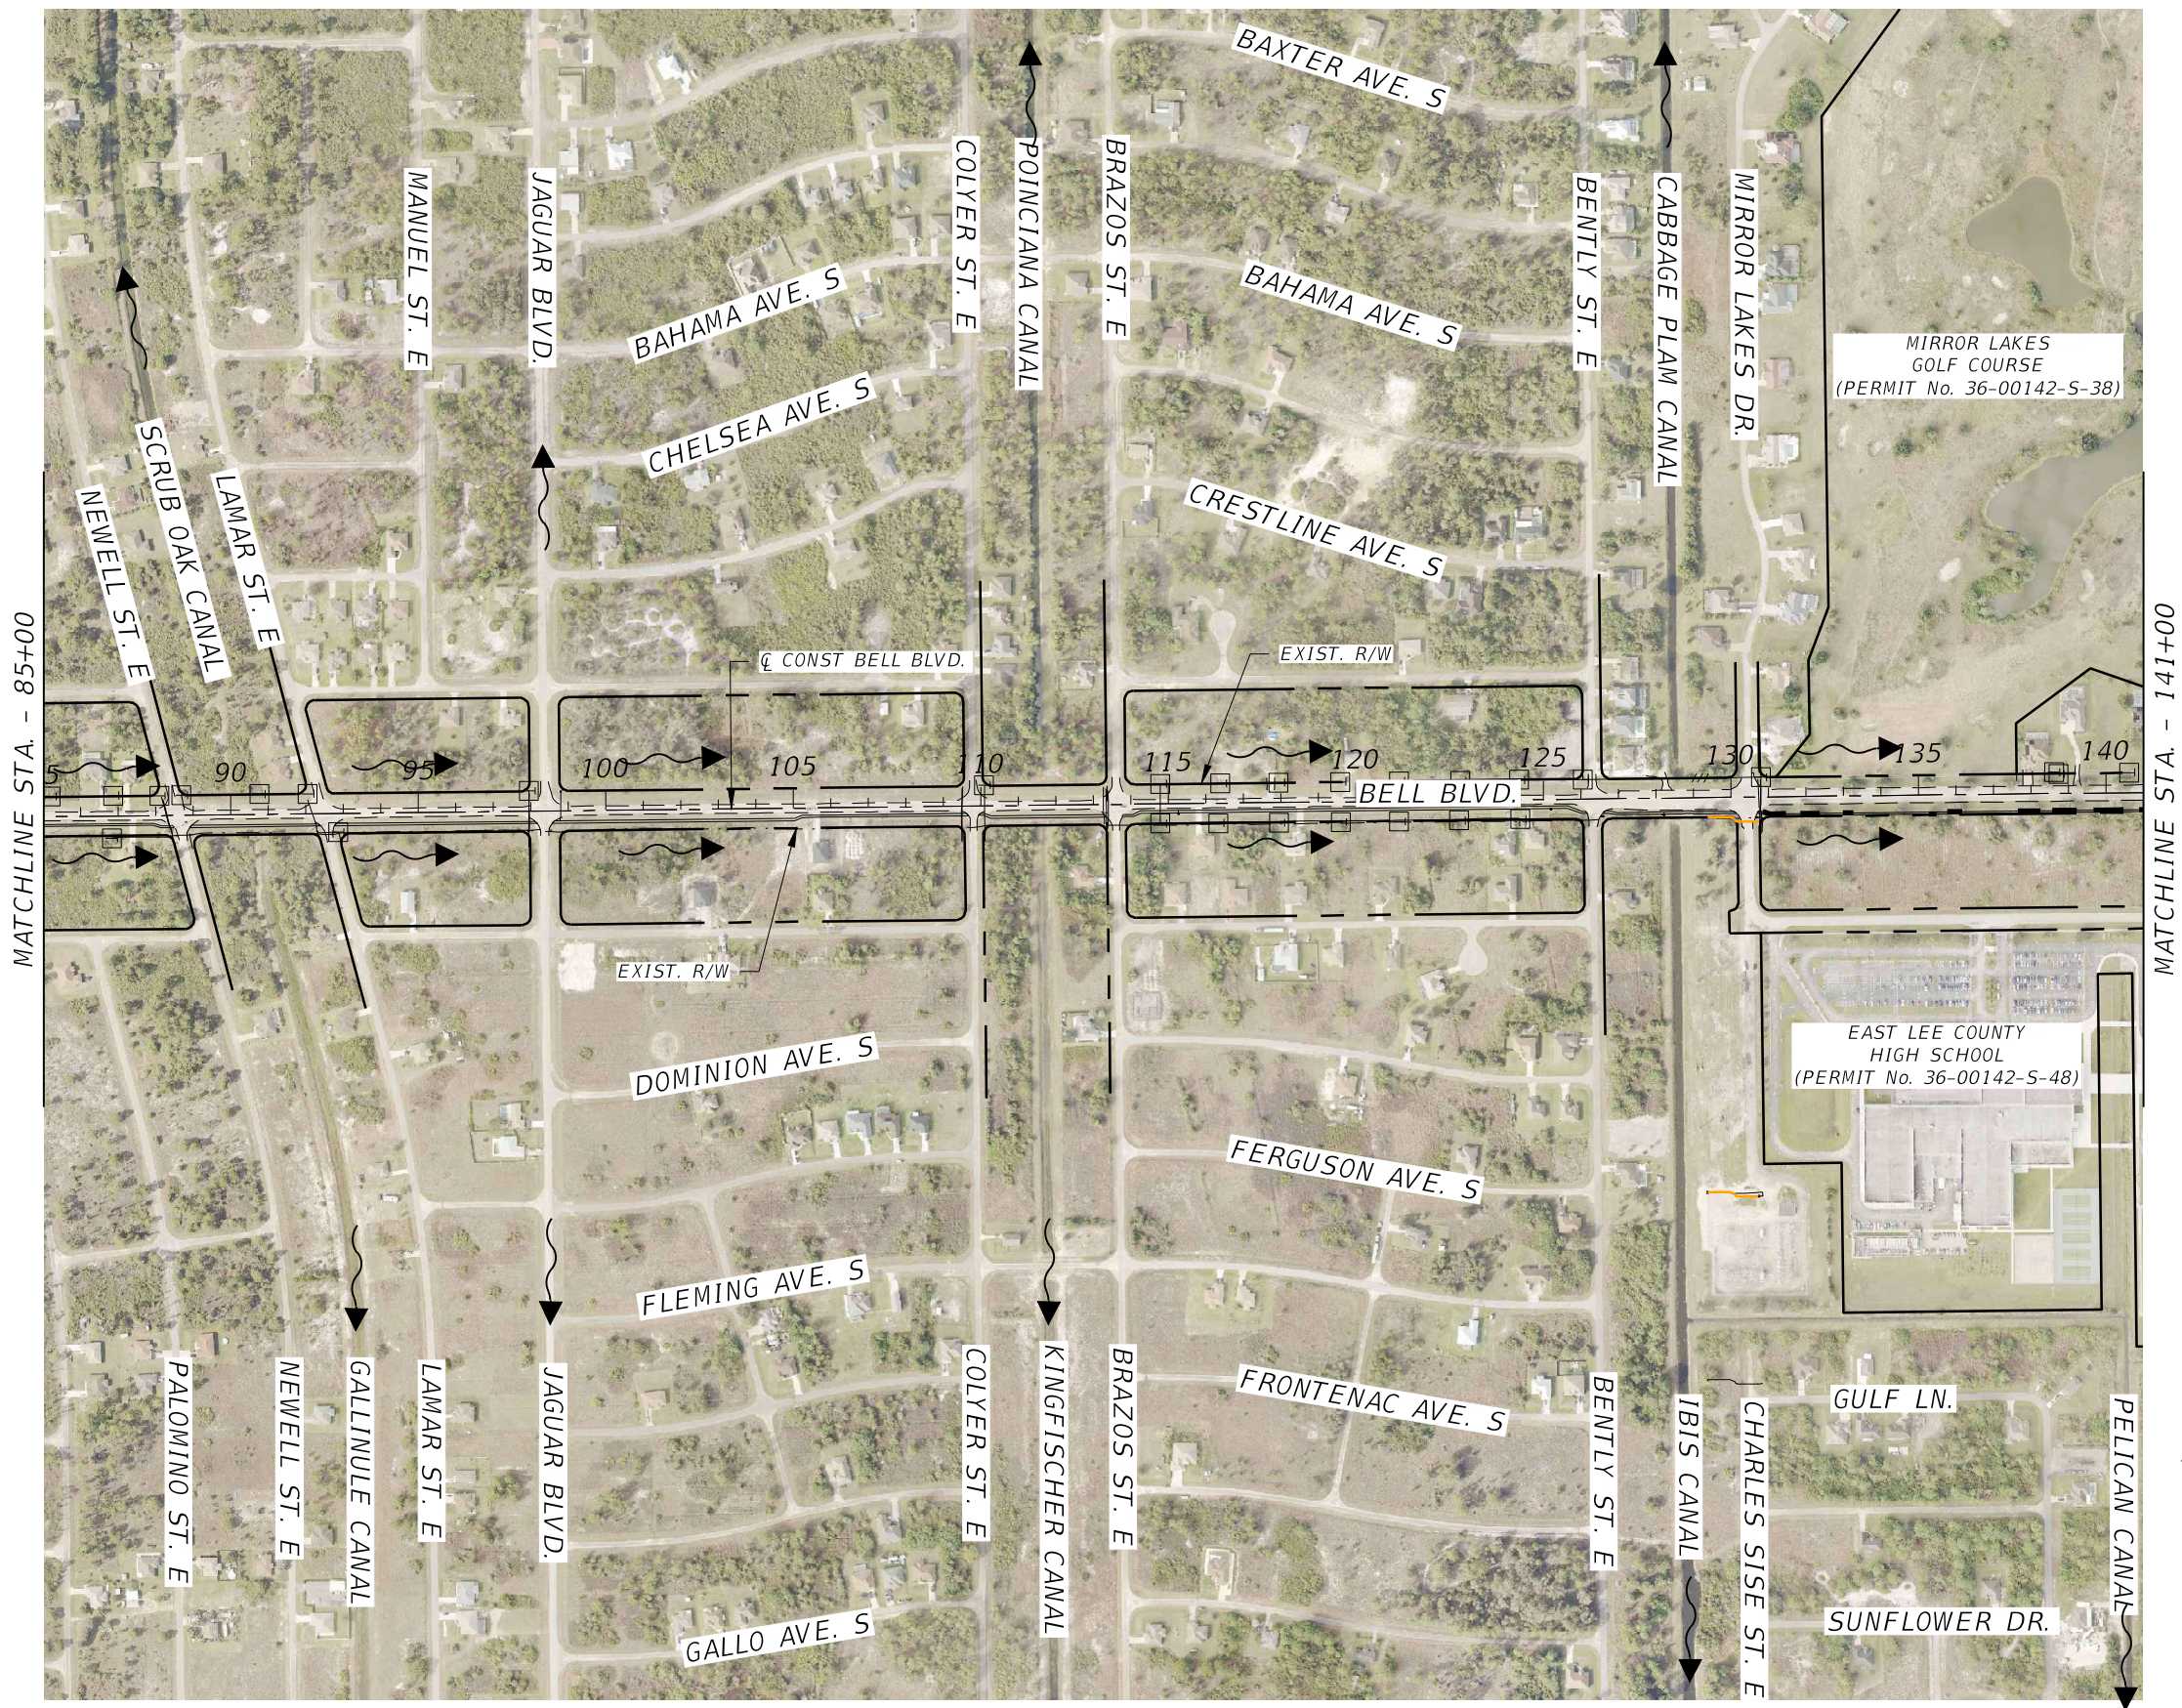


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DATE	DESCRIPTION	DATE	DESCRIPTION		ROAD NO.	COUNTY PROJECT NO.		6
					BELL BLVD. SR 82 TO SUNRISE BLVD. SIDEWALK	6002		






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DATE	DESCRIPTION	DATE	DESCRIPTION		ROAD NO.	COUNTY PROJECT NO.		7
					BELL BLVD. SR 82 TO SUNRISE BLVD. SIDEWALK	6002		

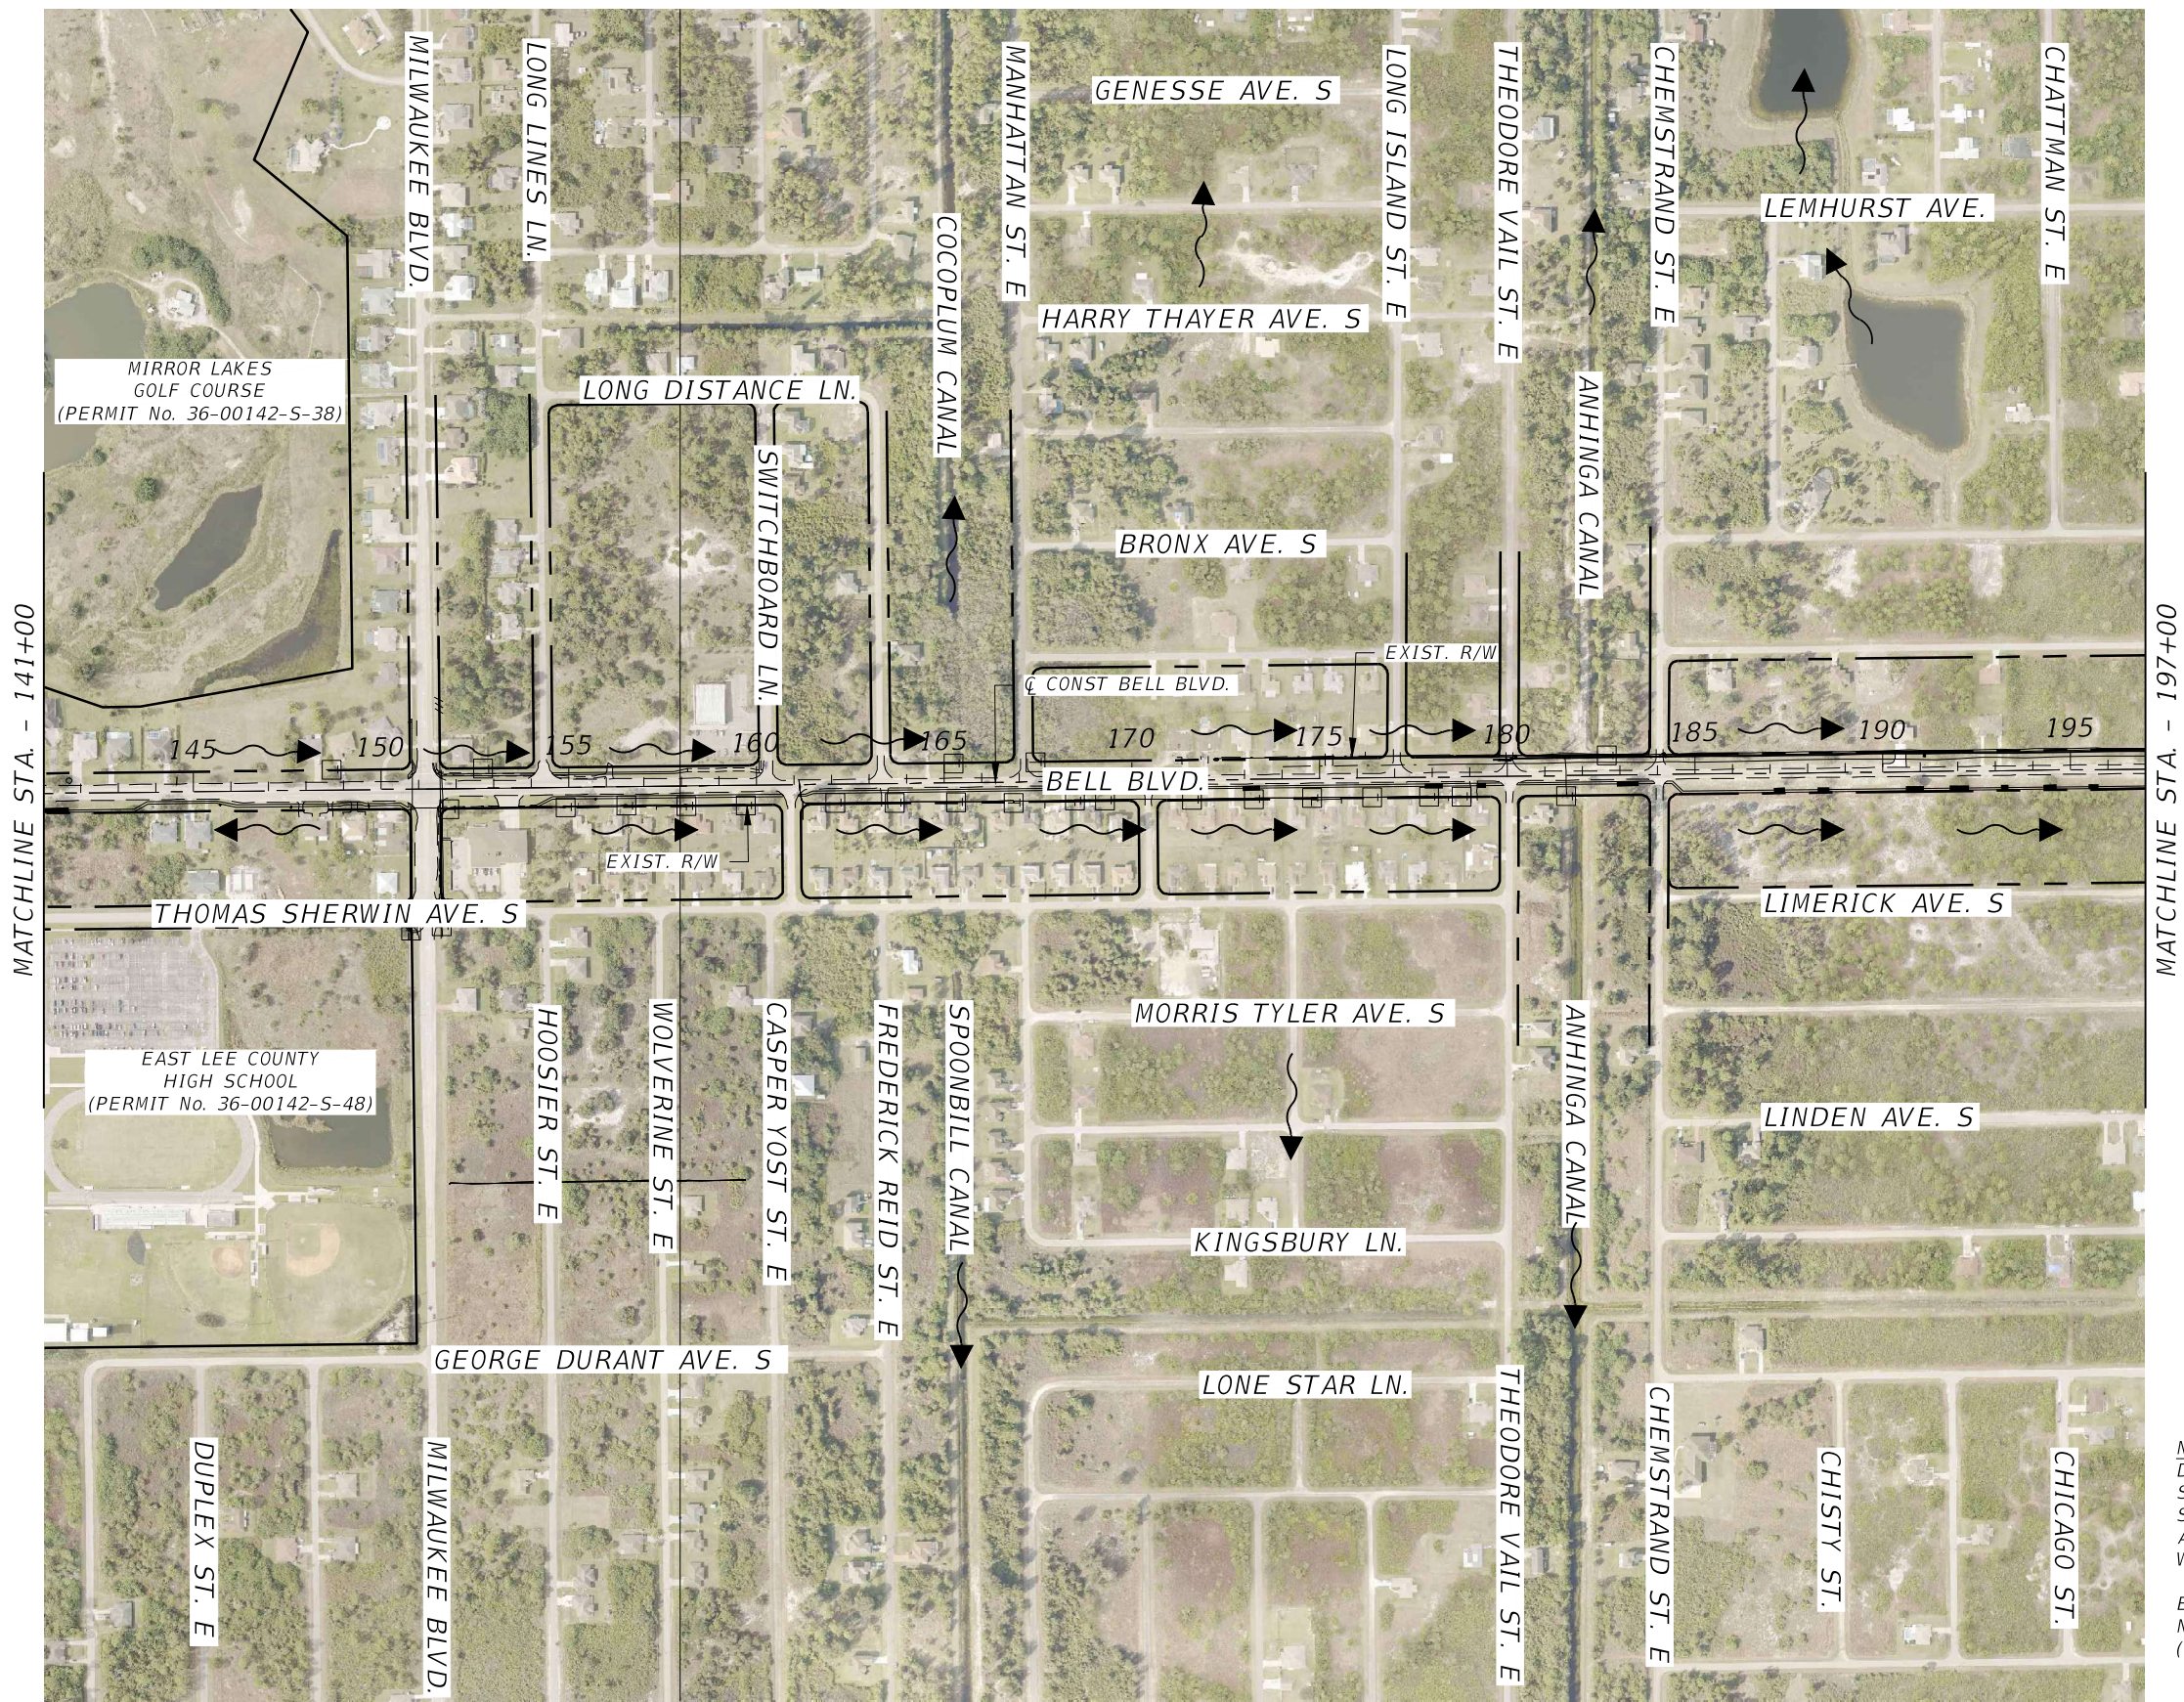



END PROJECT  
END SIDEWALK  
STA. 250+40.68
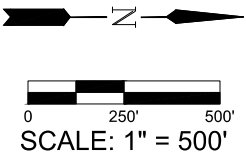
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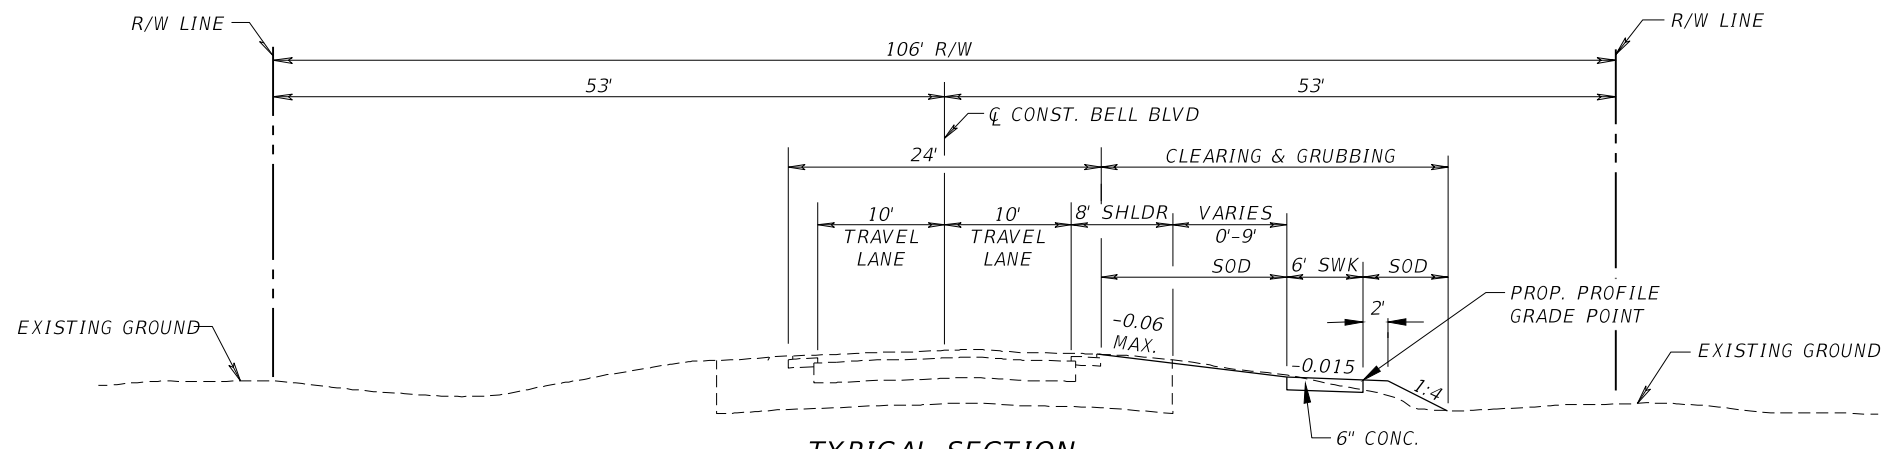
REVISIONS				LEE COUNTY		DRAINAGE MAP	SHEET NO.
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				BELL BLVD. SR 82 TO SUNRISE BLVD. SIDEWALK	6002		8




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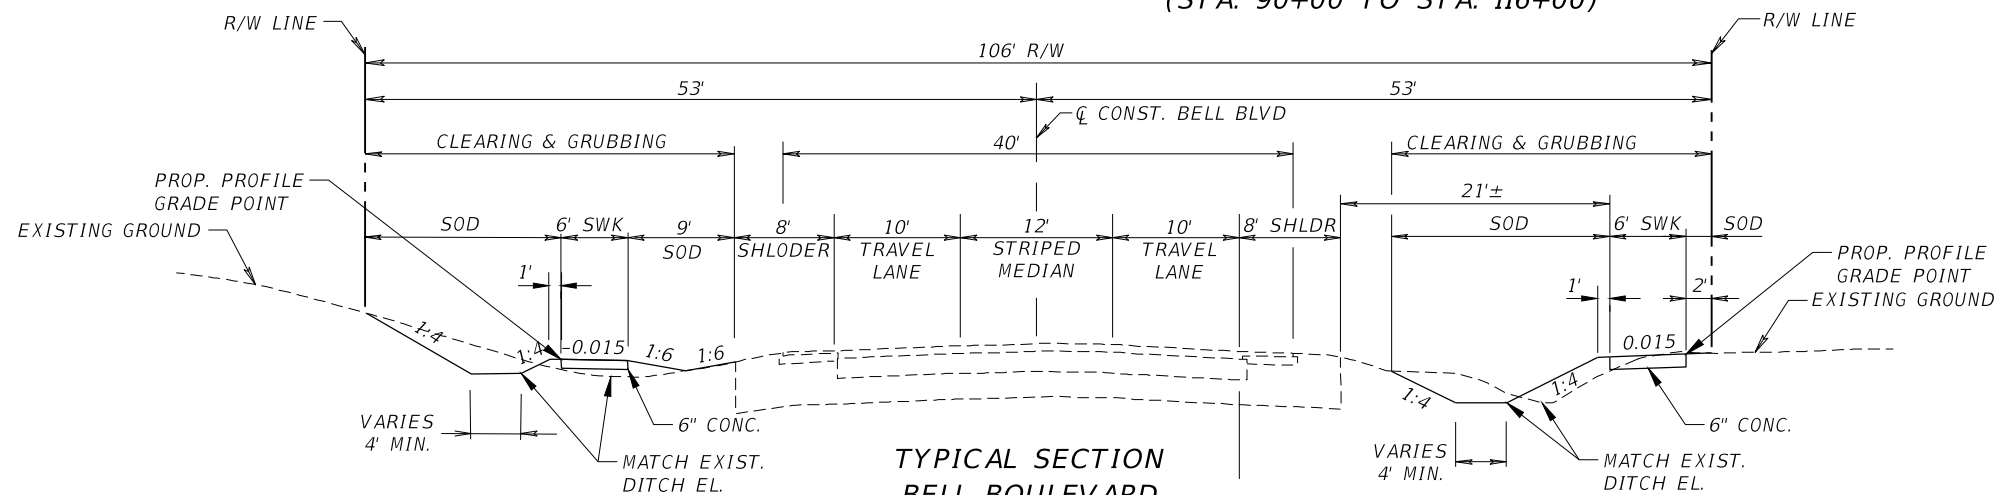





**TYPICAL SECTION  
BELL BOULEVARD  
(STA. 30+91.31 TO STA. 126+15.13)**



**TYPICAL SECTION  
BELL BOULEVARD  
(STA. 90+00 TO STA. 116+00)**

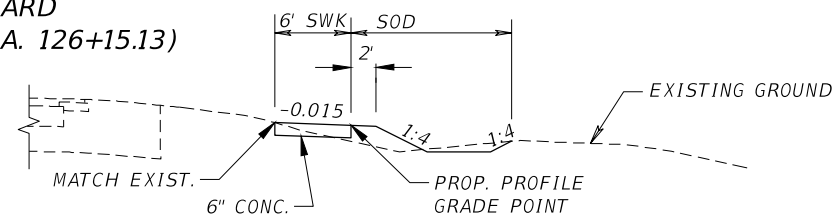




**TYPICAL SECTION  
BELL BOULEVARD  
(STA. 130+13.45 TO STA. 145+41.46)  
(STA. 150+48.94 TO STA. 158+15.69(LT.))**

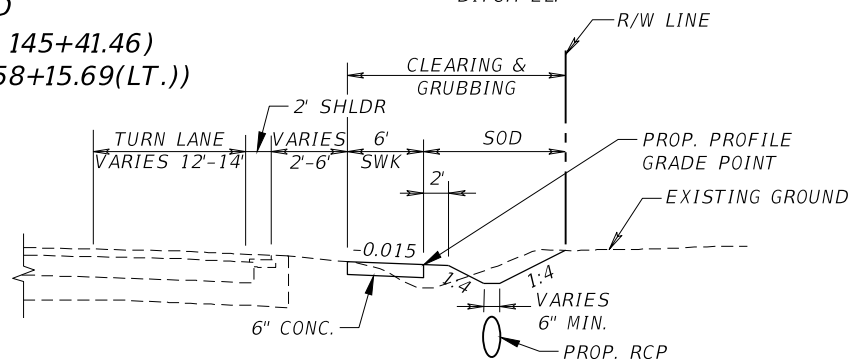

**TYPICAL SECTION  
BELL BOULEVARD  
(STA. 126+15.13 TO STA. 130+13.45)  
(STA. 145+41.46 TO STA. 150+94.38)  
(STA. 153+95.74 TO STA. 160+71.30)**


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DATE	DESCRIPTION	DATE	DESCRIPTION		ROAD NO.	COUNTY PROJECT NO.		
					BELL BLVD. SR 82 TO SUNRISE BLVD. SIDEWALK	6002		

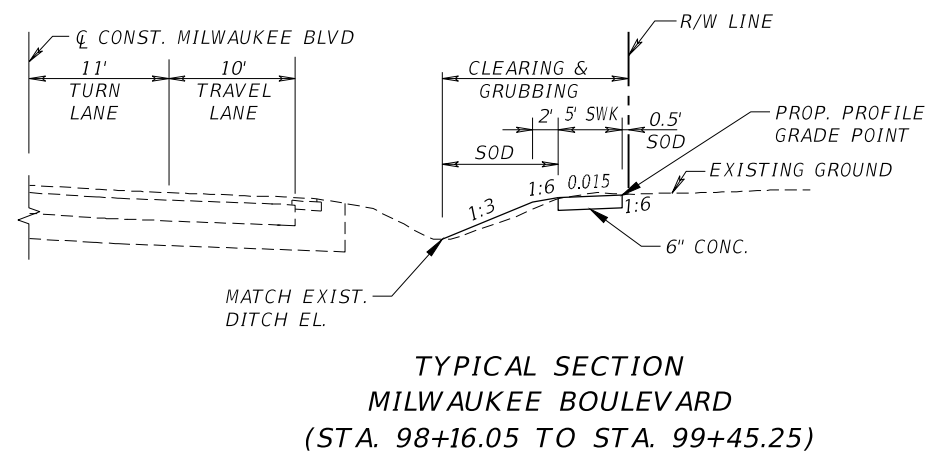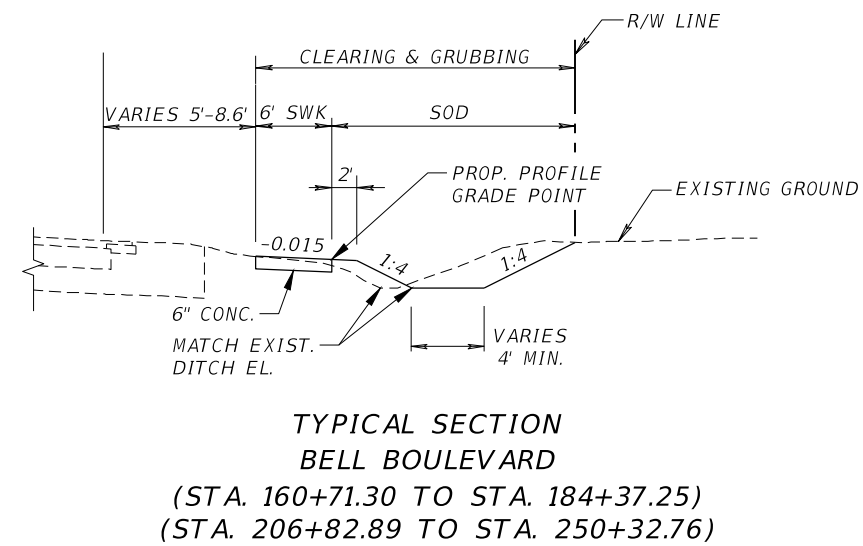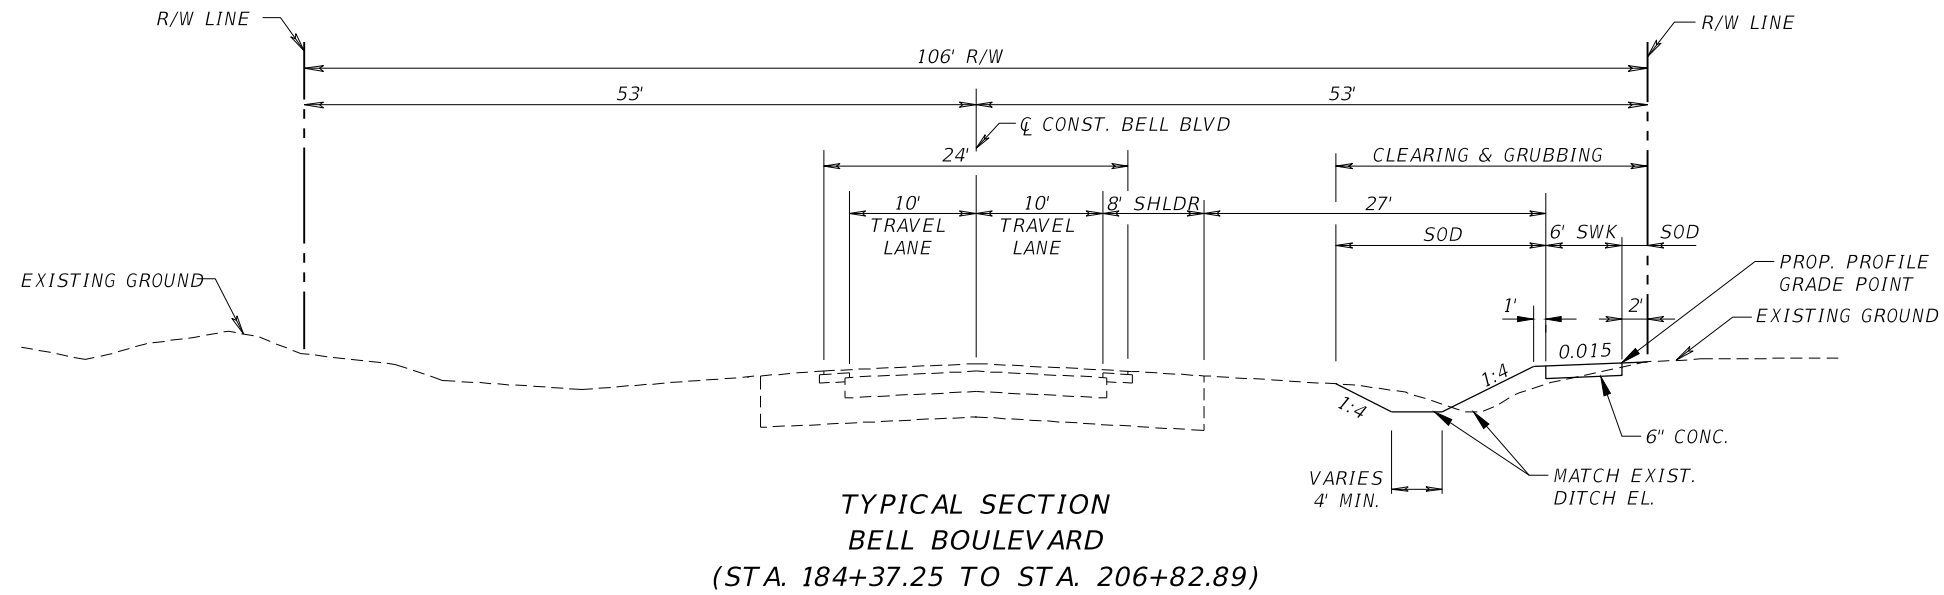


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REVISIONS				<div><p>Q. Grady Minor and Associates, P.A. 3800 Via Del Rey Bonita Springs, Florida 34134 Phone: 239.947.1144 R. DANIEL FLYNN, P.E. NO. 76205</p><p>Civil Engineers • Land Surveyors • Planners • Landscape Architects <small>Cert. of Auth. EB 0005151    Cert. of Auth. LB 0005151    Business Lic. 26000266</small></p></div>	LEE COUNTY		TYPICAL SECTIONS	SHEET NO.
DATE	DESCRIPTION	DATE	DESCRIPTION		ROAD NO.	COUNTY PROJECT NO.		10
					BELL BLVD. SR 82 TO SUNRISE BLVD. SIDEWALK	6002		




- NOTES:**
1. THE CONTRACTOR IS RESPONSIBLE FOR RESTORING ALL PORTIONS OF DRIVEWAYS DAMAGED DURING CONSTRUCTION TO EQUAL TO OR BETTER CONDITIONS THAN EXISTED BEFORE CONSTRUCTION.
  2. THE CONTRACTOR IS RESPONSIBLE FOR ANY DAMAGE TO THE ASPHALT ROADWAY DURING DRIVEWAY INSTALLATION. DAMAGES SHALL BE RESTORED TO THE DIMENSIONS AS DETAILED ON ROADWAY RESTORATION DETAIL THIS PAGE. COST ASSOCIATED WITH ROADWAY RESTORATION IS INCIDENTAL TO PAY ITEM 522-2 CONCRETE SIDEWALK AND DRIVEWAYS, 6" THICK.
  3. DRIVEWAYS SHALL BE SAW CUT IN A STRAIGHT LINE PERPENDICULAR TO THE CENTERLINE OF THE DRIVEWAY.
  4. DRIVEWAYS SHALL BE REMOVED AND REINSTALLED AS DETAILED IN THE SPECIFICATIONS. PROVIDE EXPANSION JOINT FILLER BETWEEN NEW AND EXISTING DRIVEWAY. AFTER PLACING NEW CONCRETE, SAW CUT TO CONTROL CRACKING WITHIN 24 HOURS.
  5. WHEN RECONSTRUCTING DRIVEWAYS, THE CONTRACTOR SHALL EXTEND THE WORK TO THE NEAREST EXISTING CONSTRUCTION JOINT IF WITHIN 3 FEET OF THE LIMIT OF WORK SHOWN ON PLAN AND WITHIN R.O.W. THIS WORK WILL BE PAID FOR UNDER PAY ITEM 0522 2 CONCRETE SIDEWALK AND DRIVEWAYS, 6" THICK.
  6. DRIVEWAYS WITH A PROPOSED, OR EXISTING DRAINAGE PIPE, WITH LESS THAN 6-INCHES OF SEPARATION FROM THE BOTTOM OF THE CONCRETE DRIVEWAY TO THE TOP OF THE RCP/ERCP PIPE SHALL HAVE AN EXPANSION JOINT ON THE DRIVEWAY LOCATED ALONG THE CROWN OF THE PIPE. DRIVEWAY SHALL MAINTAIN A MINIMUM 1" SEPARATION BETWEEN THE BOTTOM OF THE CONCRETE DRIVEWAY AND TOP OF THE RCP/ERCP PIPE.
  7. ALL AREAS DISTURBED THAT ARE NOT TO BE PAVED SHALL BE SODDED.
  8. PAVER DRIVEWAYS SHALL BE RECONSTRUCTED WITH CONCRETE. CONTRACTOR TO PLACE EXISTING PAVERS ON A PALLET AND SHALL BE PROVIDED TO PROPERTY OWNER. COST ASSOCIATED WITH REMOVING AND PLACING PAVERS ON PALLET INCLUDED IN ITEM 110-1-1 CLEARING AND GRUBBING.

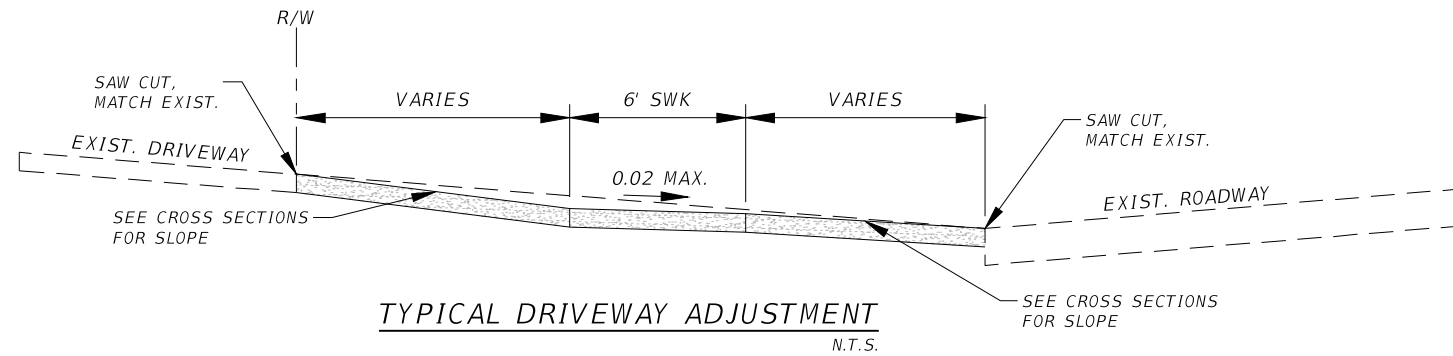


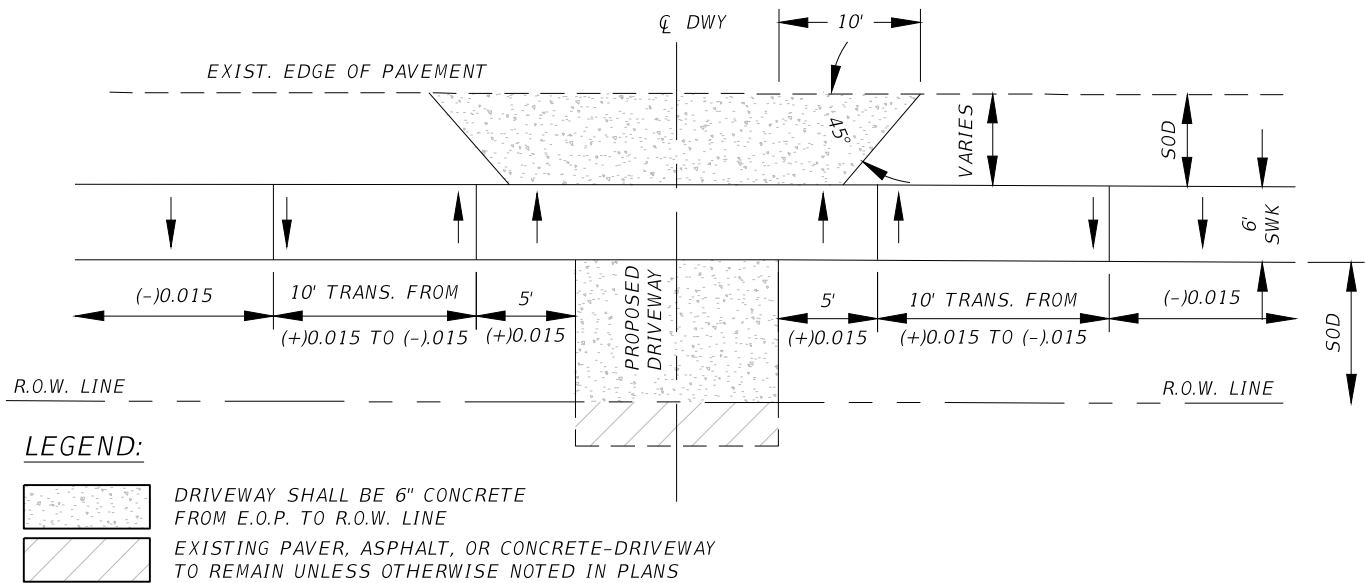- LEGEND:**
- DRIVEWAY SHALL BE 6" CONCRETE FROM E.O.P. TO R.O.W. LINE
  - EXISTING PAVER, ASPHALT, OR CONCRETE-DRIVEWAY TO REMAIN UNLESS OTHERWISE NOTED IN PLANS

**TYPICAL DRIVEWAY PLAN**  
N.T.S.

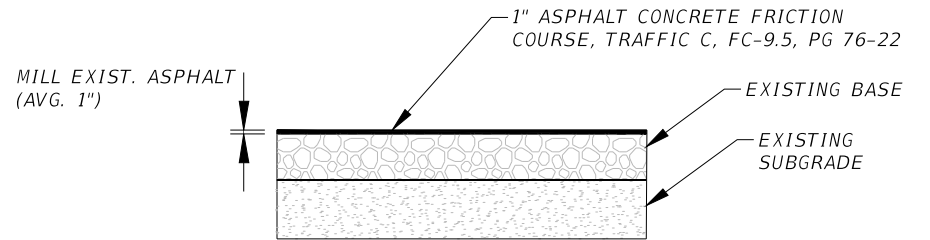


**TYPICAL TURNOUT MILLING & RESURFACING SECTION**  
N.T.S.

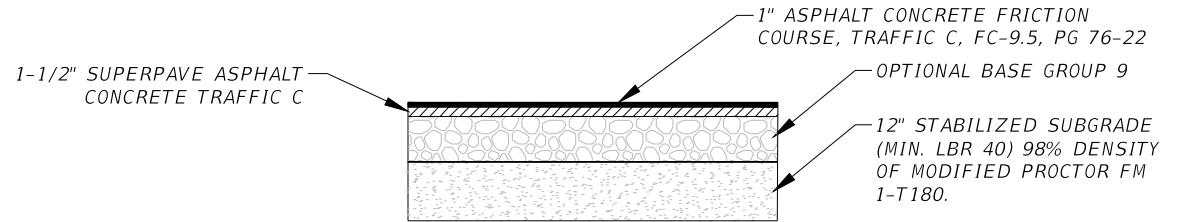


1. LIMEROCK BASE MUST EXTEND 4" BEYOND EDGE OF PAVEMENT.
2. STABILIZED SUBGRADE MUST EXTEND 12" BEYOND EDGE OF PAVEMENT.

**TYPICAL ROADWAY RECONSTRUCTION SECTION**  
N.T.S.

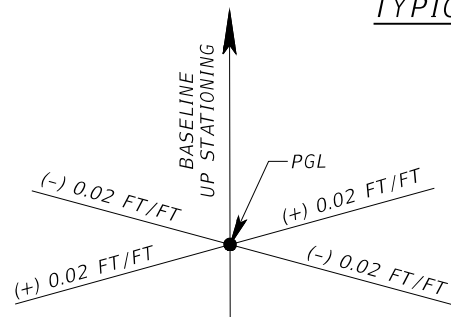




- NOTE:**  
ROADWAY CROSS SLOPE AS DETAILED IN ROADWAY PLANS IS AS FOLLOWS:  
ANY CROSS SLOPE WHICH EXTENDS ABOVE AND TO THE LEFT OR BELOW AND TO THE RIGHT OF THE PGL IS CONSIDERED A NEGATIVE (-) CROSS SLOPE.  
ANY CROSS SLOPE WHICH EXTENDS BELOW AND TO THE LEFT OR ABOVE AND TO THE RIGHT OF THE PGL IS CONSIDERED A POSITIVE (+) CROSS SLOPE.

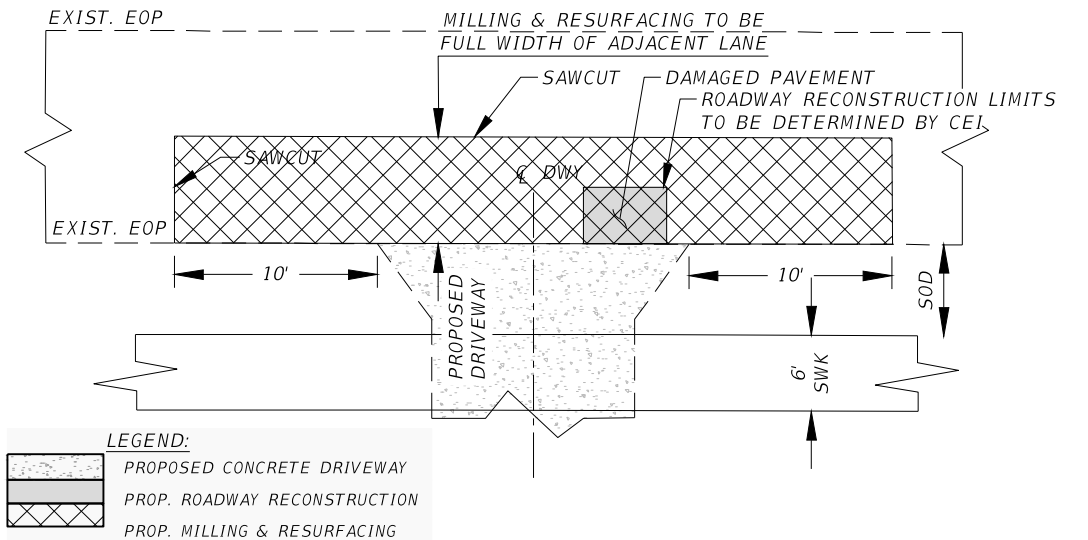



- LEGEND:**
- PROPOSED CONCRETE DRIVEWAY
  - PROP. ROADWAY RECONSTRUCTION
  - PROP. MILLING & RESURFACING

**ROADWAY RESTORATION DETAIL**  
N.T.S.

REVISIONS				<div> <div>  <div> Q. Grady Minor and Associates, P.A.  3800 Via Del Rey  Bonita Springs, Florida 34134  Phone: 239.947.1144  R. DANIEL FLYNN, P.E. NO. 76205 </div> </div> <div> Civil Engineers • Land Surveyors • Planners • Landscape Architects  <small>CERT. OF AUTH. EB 0005151    CERT. OF AUTH. LB 0005151    BUSINESS LC 26000266</small> </div> </div>	<div> <div>LEE COUNTY</div> <div> ROAD NO.    COUNTY PROJECT NO.  BELL BLVD. SR 82 TO  SUNRISE BLVD. SIDEWALK    6002 </div> </div>	TYPICAL SECTION DETAILS	SHEET NO.  11
DATE	DESCRIPTION	DATE	DESCRIPTION				

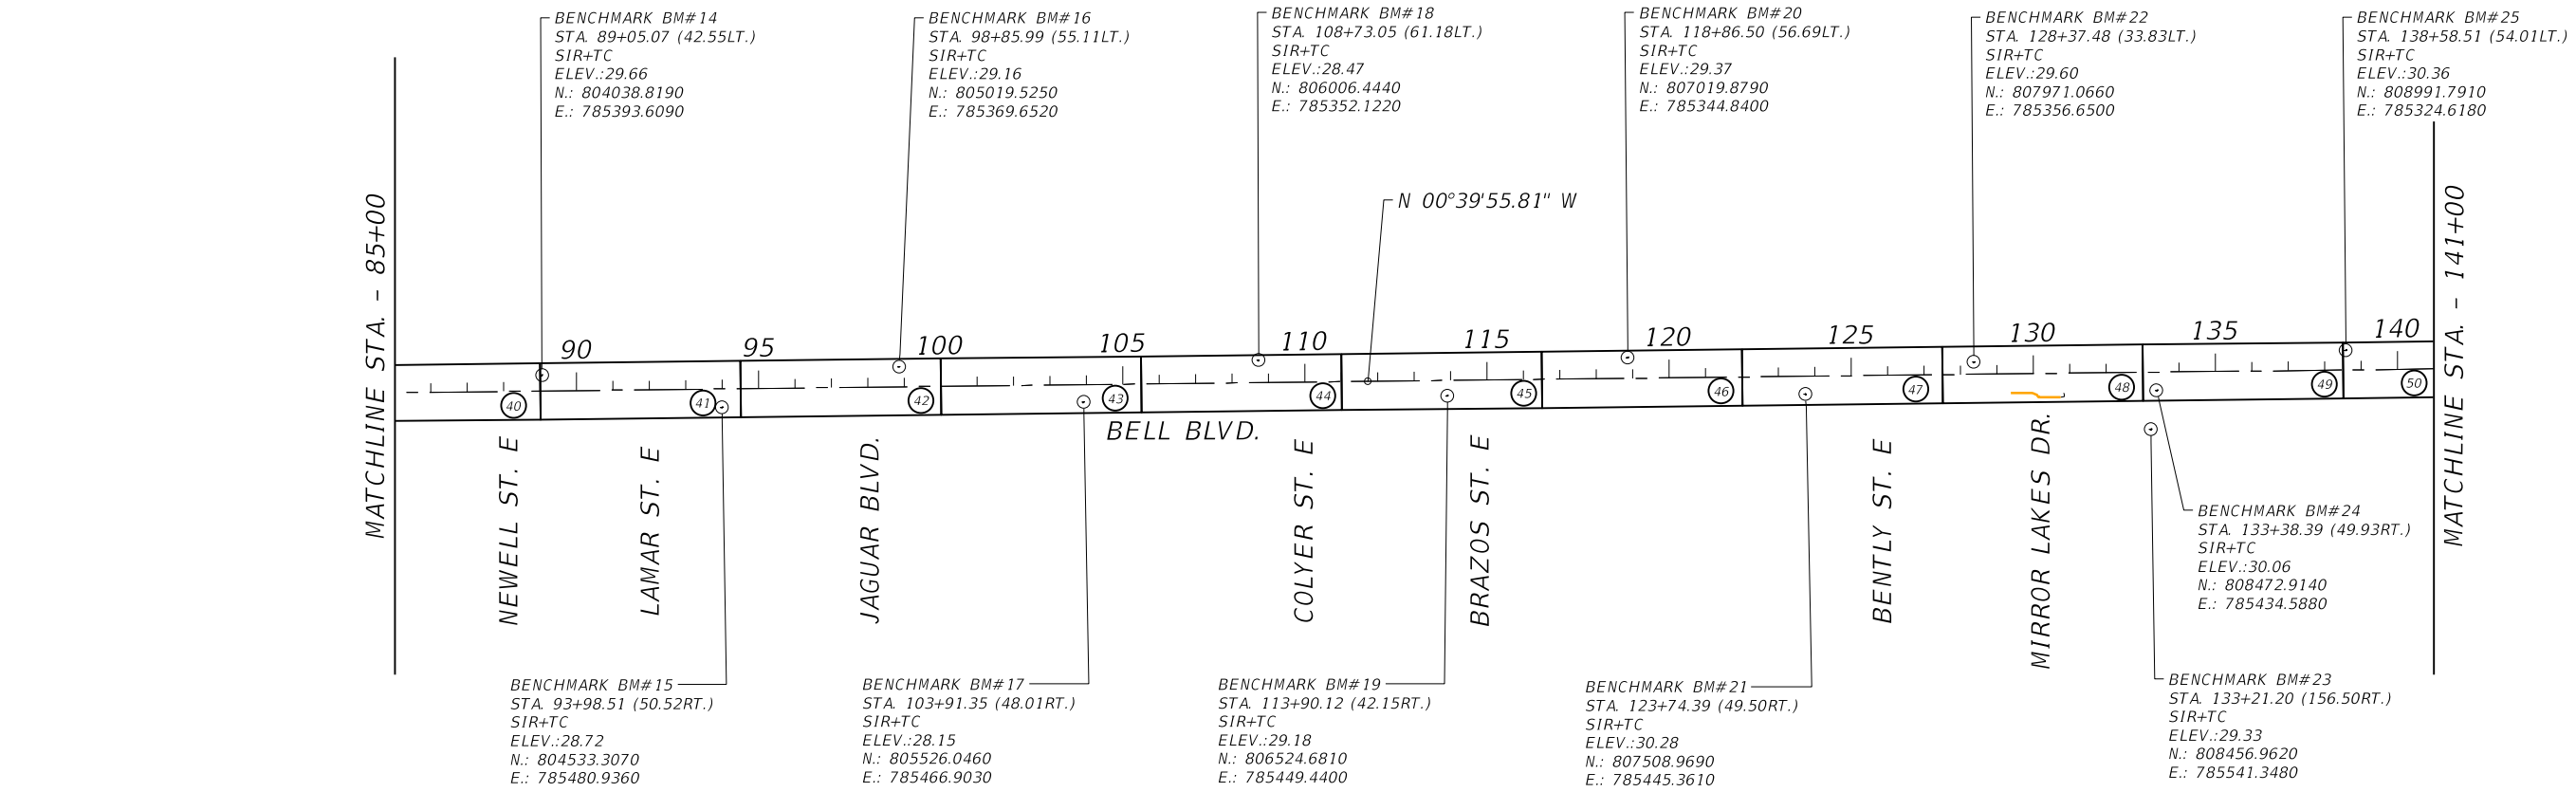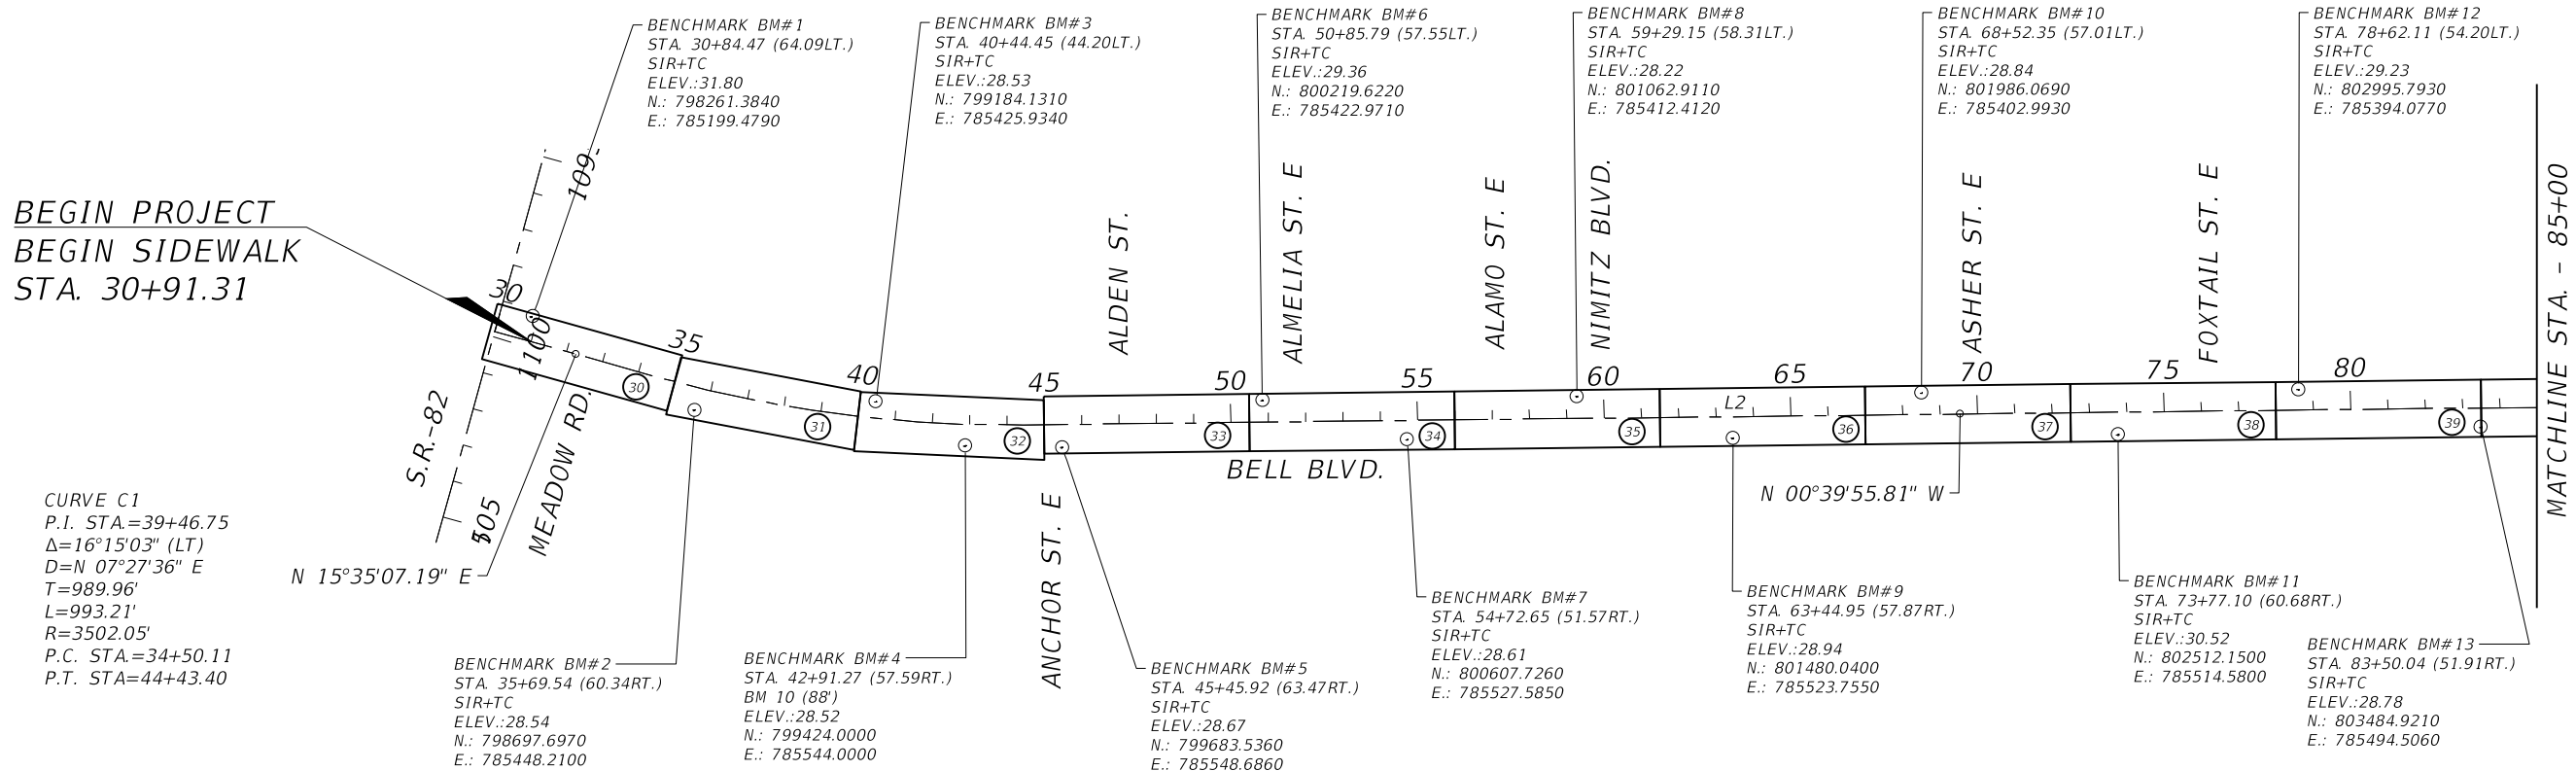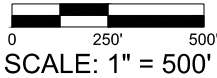

R E V I S I O N S				<div><div>Q. Grady Minor and Associates, P.A. 3800 Via Del Rey Bonita Springs, Florida 34134 Phone: 239.947.1144 R. DANIEL FLYNN, P.E. NO. 76205</div></div> <div>Civil Engineers • Land Surveyors • Planners • Landscape Architects <small>CERT. of AUTH. EB 0005151    CERT. of AUTH. LB 0005151    BUSINESS LC 2600266</small></div>	LEE COUNTY		PROJECT LAYOUT & CONTROL	SHEET NO.
DATE	DESCRIPTION	DATE	DESCRIPTION		ROAD NO.	COUNTY PROJECT NO.		
					BELL BLVD. SR 82 TO SUNRISE BLVD. SIDEWALK	6002		12

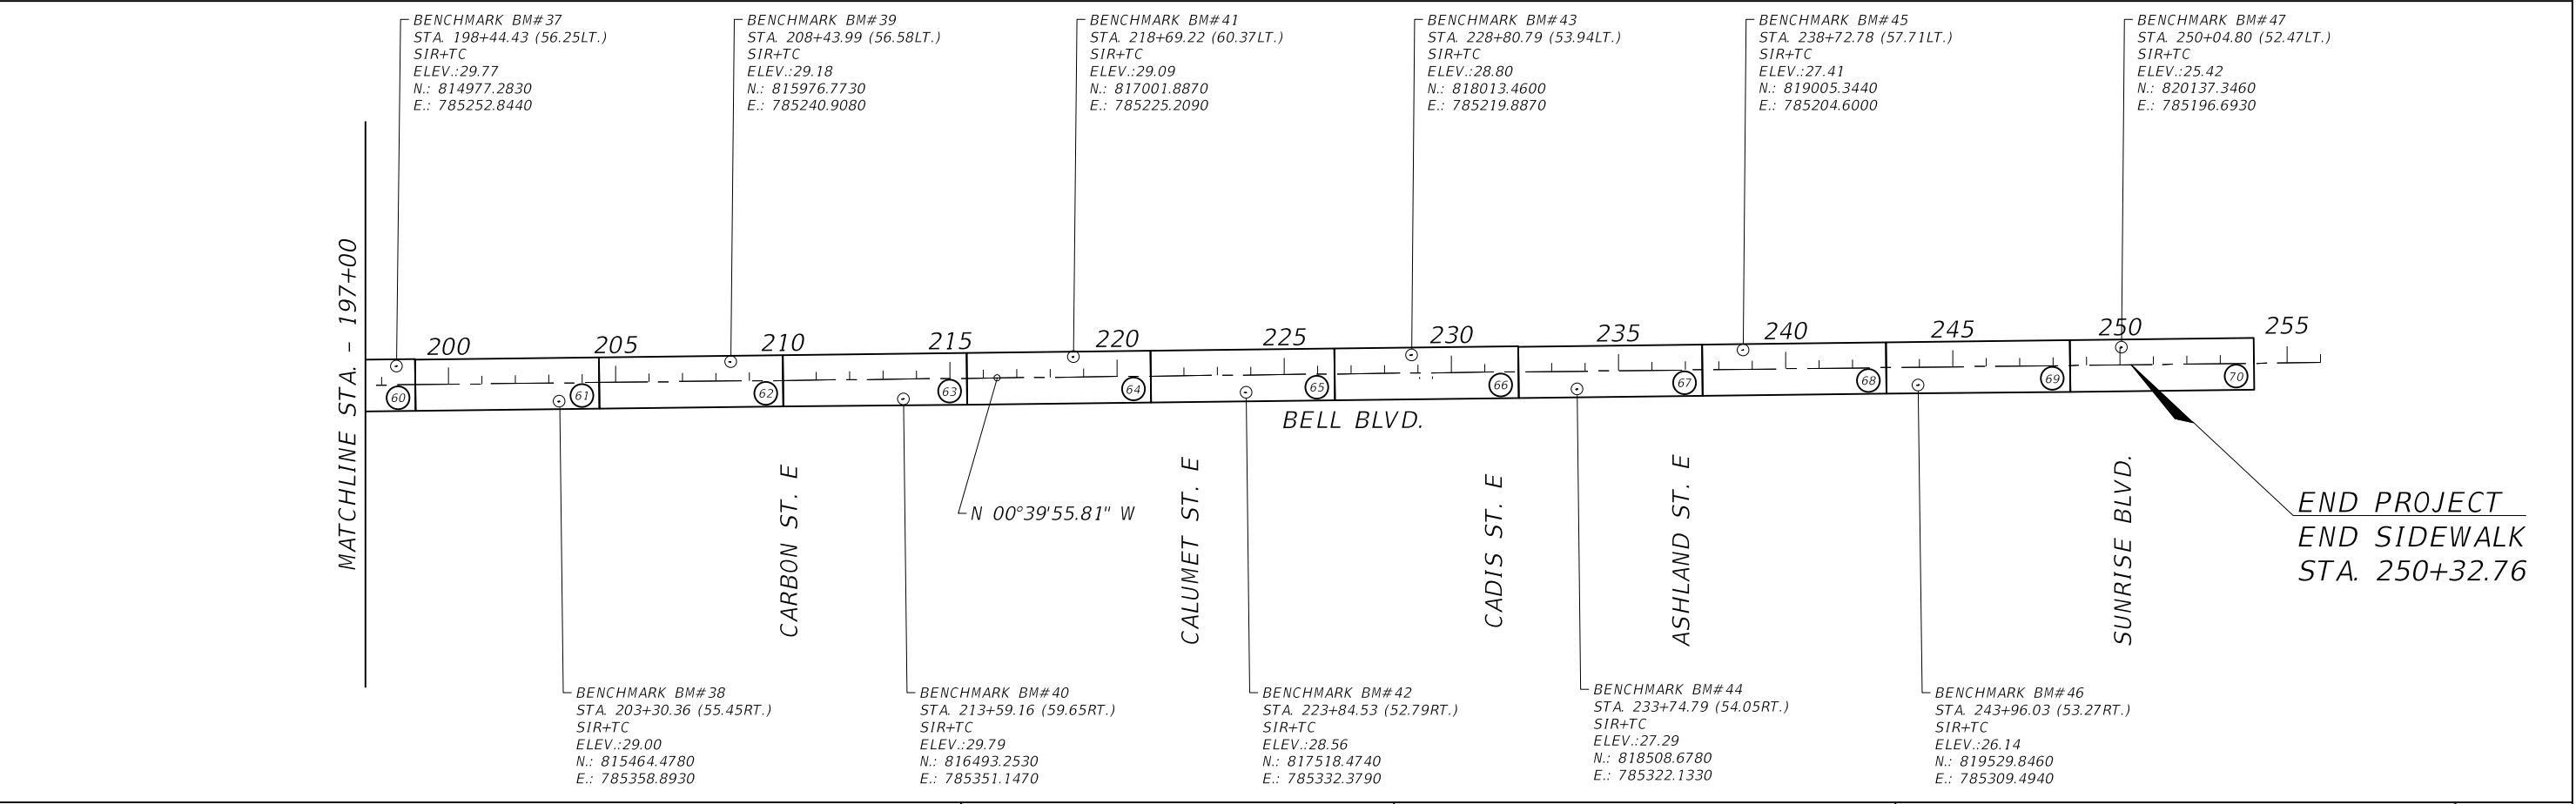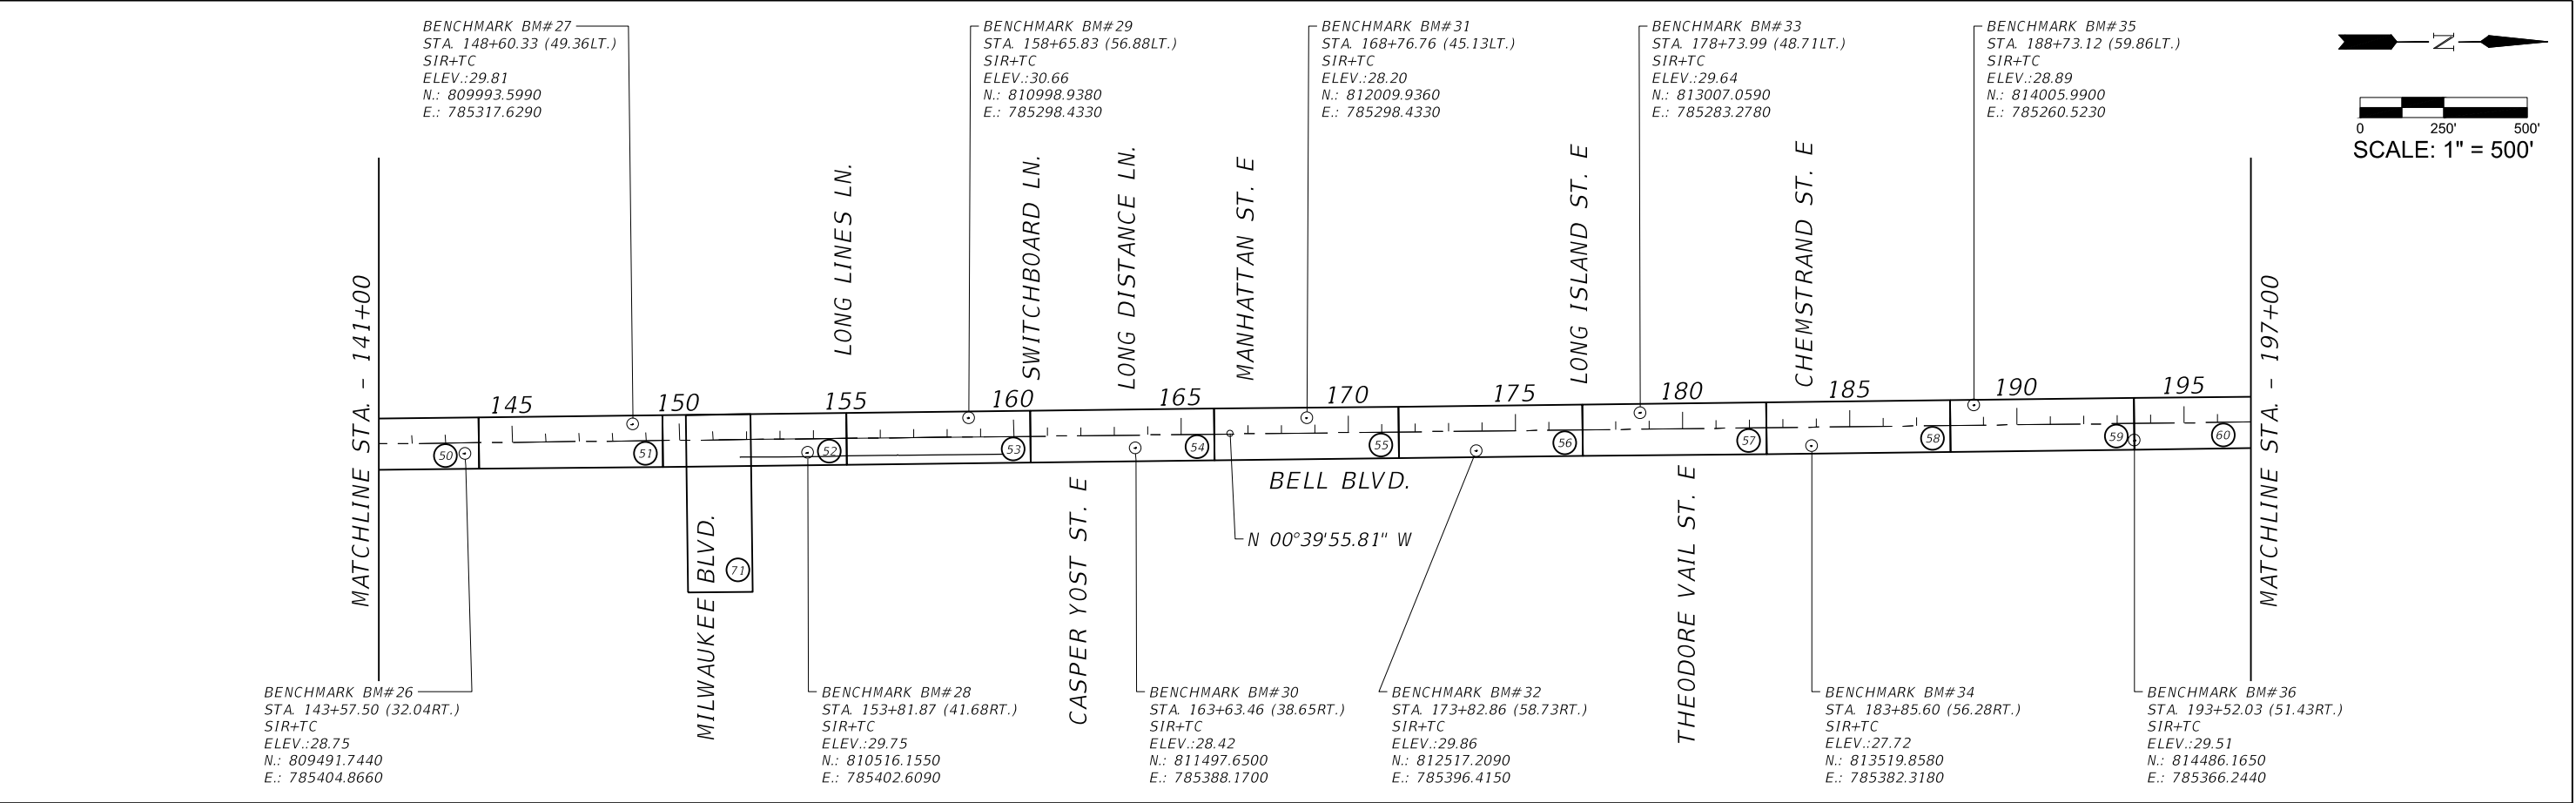

REVISIONS				<div><div></div><div><b>GradyMinor</b> Civil Engineers • Land Surveyors • Planners • Landscape Architects <small>CERT. of AUTH. EB 0005151      CERT. of AUTH. LB 0005151      BUSINESS LC 26000266</small></div></div> <div><div><b>Q. Grady Minor and Associates, P.A.</b> 3800 Via Del Rey Bonita Springs, Florida 34134 Phone: 239.947.1144 R. DANIEL FLYNN, P.E. NO. 76205</div></div>	<b>LEE COUNTY</b>		<b>PROJECT LAYOUT &amp; CONTROL</b>	SHEET NO.
DATE	DESCRIPTION	DATE	DESCRIPTION		BELL BLVD. SR 82 TO SUNRISE BLVD. SIDEWALK	COUNTY PROJECT NO. 6002		<b>13</b>

SUMMARY OF SIDEWALK									
LOCATION			SIDE	SIDEWALK CONCRETE 6" THICKNESS		DETECTABLE WARNING SURFACE		DESIGN REMARKS	CONSTRUCTION REMARKS
STA	TO	STA.		522 2		527 2			
				AREA (SY)		AREA (SF)			
				P	F	P	F		
30+91.31	TO	31+10.10	RT	13					
31+10.10	TO	31+44.74	RT	28				TRANSITION	
31+44.74	TO	32+47.12	RT	68					
32+47.12	TO	32+67.12	RT	15				TRANSITION	
32+67.12	TO	32+80.93	RT	9		18			
33+22.60	TO	33+36.11	RT	9		17			
33+36.11	TO	33+56.11	RT	14				TRANSITION	
33+56.11	TO	44+70.80	RT	743					
44+70.80	TO	44+90.80	RT	14				TRANSITION	
44+90.80	TO	45+05.25	RT	10		19			
45+44.45	TO	45+67.34	RT	15		20			
45+67.34	TO	45+87.34	RT	15				TRANSITION	
45+87.34	TO	51+07.64	RT	347					
51+23.51	TO	56+28.96	RT	337					
56+28.96	TO	56+48.96	RT	14				TRANSITION	
56+48.96	TO	56+61.40	RT	8		15			
56+89.68	TO	57+03.21	RT	9		17			
57+03.21	TO	57+23.21	RT	14				TRANSITION	
57+23.21	TO	59+37.09	RT	143					
59+37.09	TO	59+57.09	RT	13				TRANSITION	
59+57.09	TO	59+70.32	RT	9		15			
60+06.31	TO	60+18.02	RT	8		14			
60+18.02	TO	60+38.02	RT	14				TRANSITION	
60+38.02	TO	71+55.38	RT	745					
71+55.38	TO	71+75.38	RT	15				TRANSITION	
71+75.38	TO	71+87.86	RT	8		16			
72+22.57	TO	72+49.14	RT	18		22			
72+49.14	TO	72+69.14	RT	15				TRANSITION	
72+69.14	TO	75+39.01	RT	180					
75+39.01	TO	75+59.01	RT	15				TRANSITION	
75+59.01	TO	75+81.74	RT	15		24			
76+26.83	TO	77+54.81	RT	85		17			
77+74.27	TO	78+48.04	RT	49					
78+63.70	TO	80+08.69	RT	97					
80+24.52	TO	87+31.60	RT	471					
87+47.53	TO	87+92.42	RT	30					
87+92.42	TO	88+12.42	RT	15				TRANSITION	
88+12.42	TO	88+48.60	RT	24		20			
88+89.62	TO	92+39.36	RT	233		34			
92+75.75	TO	98+16.29	RT	360		33			
98+55.80	TO	105+02.85	RT	431		18			
105+02.85	TO	105+22.85	RT	15				TRANSITION	
SHEET TOTAL				4689		321			

SUMMARY OF SIDEWALK									
LOCATION			SIDE	SIDEWALK CONCRETE 6" THICKNESS		DETECTABLE WARNING SURFACE		DESIGN REMARKS	CONSTRUCTION REMARKS
				522 2		527 2			
STA	TO	STA.		AREA (SY)		AREA (SF)			
				P	F	P	F		
105+22.85	TO	105+55.62	RT	22					
105+71.44	TO	106+66.54	RT	63					
106+82.38	TO	109+66.11	RT	189		17			
109+93.09	TO	110+06.16	RT	9		17			
110+06.16	TO	110+26.16	RT	15				TRANSITION	
110+26.16	TO	113+34.36	RT	205		17			
113+76.82	TO	114+05.79	RT	19		17			
114+05.79	TO	114+25.79	RT	16				TRANSITION	
114+25.79	TO	115+72.20	RT	98					
115+88.09	TO	118+42.50	RT	170					
118+58.32	TO	124+01.30	RT	362					
124+19.32	TO	124+53.53	RT	23					
124+69.30	TO	125+62.22	RT	62					
125+62.22	TO	126+00.47	RT	28				TRANSITION	
126+00.47	TO	126+15.13	RT	10		14			
126+57.59	TO	126+74.28	RT	11		20			
126+74.28	TO	126+94.28	RT	14				TRANSITION	
126+94.28	TO	128+67.82	RT	116					
128+67.82	TO	128+78.15	RT	7				TRANSITION	
128+78.15	TO	128+91.90	RT	9					
128+91.90	TO	129+01.90	RT	7				TRANSITION	
129+01.90	TO	130+13.45	RT	74		24			
130+69.56	TO	130+74.21	RT	1		15			
130+74.21	TO	131+02.05	RT	20				TRANSITION	
131+02.05	TO	143+41.46	RT	826					
143+41.46	TO	143+76.47	RT	27				TRANSITION	
143+76.47	TO	143+97.78	RT	14					
144+06.59	TO	144+43.06	RT	24					
144+52.09	TO	144+86.02	RT	23					
144+94.93	TO	145+31.20	RT	24					
145+39.99	TO	145+58.37	RT	12					
145+58.37	TO	146+12.26	RT	39				TRANSITION	
146+12.26	TO	147+79.39	RT	111					
147+90.76	TO	148+58.03	RT	45					
148+69.43	TO	148+89.81	RT	14					
148+89.81	TO	148+99.85	RT	7				TRANSITION	
148+99.85	TO	149+19.60	RT	13					
149+35.26	TO	149+50.00	RT	10					
149+50.00	TO	149+57.55	RT	5				TRANSITION	
149+57.55	TO	150+10.72	RT	35					
150+29.50	TO	150+48.92	RT	13					
150+48.90	TO	150+68.92	RT	15				TRANSITION	
SHEET TOTAL				2810		141			



SUMMARY OF SIDEWALK									
LOCATION			SIDE	SIDEWALK CONCRETE 6" THICKNESS		DETECTABL E WARNING SURFACE		DESIGN REMARKS	CONSTRUCTION REMARKS
STA	TO	STA.		522 2		527 2			
				AREA (SY)		AREA (SF)			
				P	F	P	F		
150+68.92	TO	150+90.11	RT	20		29		PERPENDICULAR	
151+49.54	TO	151+61.46	RT	19		36		PERPENDICULAR	
152+16.65	TO	152+21.65	RT	3					
152+66.62	TO	152+71.62	RT	3					
152+91.81	TO	153+12.25	RT	11					
153+64.26	TO	153+69.51	RT	3					
153+95.63	TO	154+10.36	RT	8					
154+10.36	TO	154+56.28	RT	34				TRANSITION	
154+56.28	TO	155+07.68	RT	34					
151+48.94	TO	151+62.83	LT	23		31		PERPENDICULAR	
151+65.73	TO	154+10.40	LT	163		23			
154+54.83	TO	156+02.21	LT	98		23			
156+18.21	TO	157+80.00	LT	108					
157+80.00	TO	158+15.69	LT	28				TRANSITION	
155+24.83	TO	156+16.85	RT	61					
156+32.67	TO	156+68.29	RT	24					
156+84.14	TO	157+78.56	RT	63					
157+94.46	TO	158+30.19	RT	24					
158+46.03	TO	159+37.05	RT	61					
159+52.92	TO	159+96.57	RT	29					
160+12.49	TO	160+71.30	RT	39		15			
161+09.70	TO	161+29.96	RT	14		15			
161+29.96	TO	161+49.96	RT	15				TRANSITION	
161+49.96	TO	161+67.05	RT	11					
161+82.86	TO	162+25.80	RT	29					
162+41.57	TO	163+31.98	RT	60					
163+47.75	TO	163+85.62	RT	25					
164+01.47	TO	164+91.82	RT	60					
165+07.57	TO	165+45.61	RT	25					
165+61.35	TO	166+54.05	RT	62					
166+69.74	TO	167+03.69	RT	23					
167+19.52	TO	167+74.48	RT	37					
167+86.52	TO	168+14.31	RT	19					
168+30.15	TO	168+64.16	RT	23					
168+80.16	TO	170+25.93	RT	97		23			
170+59.75	TO	171+00.80	RT	27		21			
171+16.65	TO	172+01.55	RT	57					
172+17.49	TO	172+56.20	RT	26					
172+72.08	TO	173+62.02	RT	60					
173+77.80	TO	174+16.30	RT	26					
174+32.09	TO	175+23.30	RT	61					
175+39.12	TO	175+74.39	RT	24					
SHEET TOTAL				1633		214			

SUMMARY OF SIDEWALK									
LOCATION			SIDE	SIDEWALK CONCRETE 6" THICKNESS		DETECTABLE WARNING SURFACE		DESIGN REMARKS	CONSTRUCTION REMARKS
STA	TO	STA.		522 2		527 2			
				AREA (SY)		AREA (SF)			
				P	F	P	F		
175+90.31	TO	176+81.60	RT	61					
176+97.40	TO	177+36.35	RT	26					
177+52.25	TO	178+43.38	RT	61					
178+59.09	TO	179+01.98	RT	29					
179+17.79	TO	179+90.19	RT	48		18			
180+23.83	TO	183+91.92	RT	245		37			
184+17.42	TO	184+37.25	RT	13		19			
184+37.25	TO	184+64.74	RT	28				TRANSITION	
184+64.74	TO	196+97.01	RT	822					
196+97.01	TO	197+47.01	RT	37				TRANSITION	
197+47.01	TO	197+60.70	RT	9		16			
197+97.23	TO	198+11.89	RT	10		17			
198+11.89	TO	198+61.89	RT	36				TRANSITION	
198+61.89	TO	206+45.99	RT	523					
206+45.99	TO	206+82.89	RT	32				TRANSITION	
206+82.89	TO	207+25.19	RT	28					
207+34.13	TO	207+72.45	RT	26					
207+81.09	TO	208+38.47	RT	38					
208+54.41	TO	209+88.64	RT	89					
210+10.75	TO	210+59.36	RT	32		20			
210+87.16	TO	213+65.79	RT	186		18			
213+74.63	TO	214+11.25	RT	24					
214+20.18	TO	214+63.41	RT	29					
214+83.74	TO	215+25.22	RT	28					
215+34.00	TO	215+71.97	RT	25					
215+80.94	TO	216+06.79	RT	17					
216+17.65	TO	216+44.51	RT	18					
216+60.51	TO	220+12.61	RT	235					
220+22.57	TO	220+42.05	RT	13					
220+51.85	TO	223+37.48	RT	190		15			
223+72.67	TO	225+89.66	RT	145		19			
226+11.18	TO	226+68.94	RT	39					
226+93.19	TO	227+33.55	RT	27					
227+43.55	TO	227+79.54	RT	24					
227+89.54	TO	228+14.24	RT	16					
228+24.24	TO	228+61.78	RT	25					
228+71.78	TO	228+95.06	RT	16					
229+05.06	TO	229+41.73	RT	24					
229+52.20	TO	231+45.05	RT	129					
231+60.73	TO	233+34.97	RT	116		17			
233+66.99	TO	237+31.85	RT	243		40			
237+65.70	TO	240+41.17	RT	184		18			
240+57.16	TO	243+15.97	RT	173					
SHEET TOTAL				4117		253			

REVISIONS			
DATE	DESCRIPTION	DATE	DESCRIPTION



Civil Engineers • Land Surveyors • Planners • Landscape Architects  
Cert. of Auth. LD 0005151 Cert. of Auth. LD 0005151

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Phone: 239.947.1144  
R. DANIEL FLYNN, P.E. NO. 76205

LEE COUNTY	
ROAD NO.	COUNTY PROJECT NO.
BELL BLVD. SR 82 TO SUNRISE BLVD. SIDEWALK	6002

SUMMARY OF QUANTITIES

SHEET NO.  
15

SUMMARY OF SIDEWALK									
LOCATION			SIDE	SIDEWALK CONCRETE 6" THICKNESS		DETECTABLE WARNING SURFACE		DESIGN REMARKS	CONSTRUCTION REMARKS
STA	TO	STA.		522 2		527 2			
				AREA (SY)		AREA (SF)			
				P	F	P	F		
243+31.89	TO	247+13.61	RT	254					
247+29.72	TO	250+32.76	RT	202		26			
98+16.05	TO	98+46.00	RT	20				MILWAUKEE BLVD.	
98+46.00	TO	98+56.05	RT	6				MILWAUKEE BLVD. (TRANS.)	
98+56.05	TO	98+85.20	RT	19				MILWAUKEE BLVD.	
98+95.16	TO	99+23.28	RT	19				MILWAUKEE BLVD.	
99+23.28	TO	99+39.35	RT	11				MILWAUKEE BLVD. (TRANS.)	
99+39.35	TO	99+73.11	RT	26		29		MILWAUKEE BLVD.	
102+14.76	TO	102+19.76	LT	3				MILWAUKEE BLVD.	
102+29.74	TO	102+34.74	LT	3				MILWAUKEE BLVD.	
102+89.80	TO	103+08.98	LT	11				MILWAUKEE BLVD.	
103+53.98	TO	103+68.89	LT	20				MILWAUKEE BLVD.	
103+68.89	TO	103+75.63	RT	7				MILWAUKEE BLVD.	
TO				0					
SHEET TOTAL				602		55			
PROJECT TOTAL				13852		984		SEE SUMMARY OF DRIVEWAYS FOR ADDITIONAL QUANTITY FOR PAY ITEM 522-2	

SUMMARY OF STABILIZATION, BASE AND MILLING											
LOCATION			SIDE	TYPE B STABILIZATION		OPTIONAL BASE GROUP 9		MILLING EXIST. ASPHALT PAVEMENT, 1"		DESIGN REMARKS	CONSTRUCTION REMARKS
STA	TO	STA.		160 4		285 709		327 70 1			
				AREA (SY)		AREA (SY)		AREA (SY)			
				P	F	P	F	P	F		
56+44.65	TO	57+09.83	RT	139		131					
59+44.93	TO	60+35.99	RT					182			
75+51.18	TO	76+58.08	RT					198			
97+84.43	TO	98+93.99	RT					232			
113+04.04	TO	114+08.61	RT	231		222					
125+74.02	TO	126+85.25	RT					332			
128+98.68	TO	131+11.39	RT	499		482					
150+65.00	TO	151+70.00	LT/RT					1100			
160+48.93	TO	161+22.85	RT	174		166					
170+06.66	TO	170+74.72	RT	132		125					
183+74.30	TO	184+36.41	RT	95		89					
197+33.45	TO	198+37.29	RT	214		204					
210+43.87	TO	211+08.46	RT					116			
223+17.81	TO	223+93.67	RT					139			
233+20.02	TO	233+89.66	RT	109		103					
237+15.01	TO	237+83.70	RT					101			
102+80.00	TO	103+75.00	LT/RT					885		MILWAUKEE BLVD.	
TO											
TO											
TO											
SHEET TOTAL				1592		1523		3284			
PROJECT TOTAL				1592		1523		3284			

SUMMARY OF ASPHALT													
LOCATION			SIDE	334 1 13	SUPERPAVE ASPHALTIC CONCRETE, TRAFFIC C			337 7 82	ASPHALT CONCRETE FRICTION COURSE,TRAFFIC C, FC-9.5, PG 76- 22			DESIGN REMARKS	CONSTRUCTION REMARKS
STA	TO	STA.		AREA (SY)	THICKNESS (IN)	TONS		AREA (SY)	THICKNESS (IN)	TONS			
						P	F			P	F		
56+44.65	TO	57+09.83	RT	127	1.5	10.5		127	1.0	7.0			
59+44.93	TO	60+35.99	RT					182	1.0	10.0			
75+51.18	TO	76+58.08	RT					198	1.0	10.9			
97+84.43	TO	98+93.99	RT					232	1.0	12.8			
113+04.04	TO	114+08.61	RT	217	1.5	17.9		217	1.0	11.9			
125+74.02	TO	126+85.25	RT					332	1.0	18.3			
128+98.68	TO	131+11.39	RT	472	1.5	38.9		472	1.0	26.0			
150+65.00	TO	151+70.00	LT/RT					1100	1.0	60.5		BELL BLVD @ MILWAUKEE BLVD	
160+48.93	TO	161+22.85	RT	162	1.5	13.4		162	1.0	8.9			
170+06.66	TO	170+74.72	RT	122	1.5	10.1		122	1.0	6.7			
183+74.30	TO	184+36.41	RT	86	1.5	7.1		86	1.0	4.7			
197+33.45	TO	198+37.29	RT	200	1.5	16.5		200	1.0	11.0			
210+43.87	TO	211+08.46	RT					116	1.0	6.4			
223+17.81	TO	223+93.67	RT					139	1.0	7.6			
233+20.02	TO	233+89.66	RT	100	1.5	8.3		100	1.0	5.5			
237+15.01	TO	237+83.70	RT					101	1.0	5.6			
102+81.76	TO	103+75.53	LT/RT					885	1.0	48.7		MILWAUKEE BLVD @ THOMAS SHERWIN AVE. S	
SHEET TOTAL				1486		122.6		4771		262.4			
PROJECT TOTAL				1486		122.6		4771		262.4			

REVISIONS			
DATE	DESCRIPTION	DATE	DESCRIPTION



GradyMinor  
Civil Engineers • Land Surveyors • Planners • Landscape Architects  
Cert. of Auth. LD 0005151 Cert. of Auth. LD 0005151

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R. DANIEL FLYNN, P.E. NO. 76205

LEE COUNTY	
ROAD NO.	COUNTY PROJECT NO.
BELL BLVD. SR 82 TO SUNRISE BLVD. SIDEWALK	6002

SUMMARY OF QUANTITIES	
SHEET NO.	
16	

SUMMARY OF DRIVEWAYS AND REMOVAL OF EXIST. CONC.									
LOCATION	SIDE	CONC. DRIVEWAYS 6" THICK (SY)		COMMERCIAL MATERIAL FOR TEMPORARY DRIVEWAY MAINTENANCE, 6" THICK (CY)		REMOVAL OF EXIST. CONC. (SY)		DESIGN REMARKS	CONSTRUCTION REMARKS
STA		522 2		102-3		110-4-10			
		P	F	P	F	P	F		
51+15.58	RT	84		14.0		74			
77+64.56									
78+55.83	RT	85		14.1		78			
80+16.52	RT	85		14.2		83			
87+39.57	RT	85		14.2		83			
105+63.53	RT	84		14.0		79			
106+74.46	RT	84		14.1		75			
115+80.14	RT	84		14.0		79			
118+50.41	RT	84		14.0		78			
124+10.31	RT	93		15.5		86			
124+61.41	RT	83		13.9		76			
144+02.19	RT	41		6.9		35			
144+47.57	RT	41		6.9		35			
144+90.48	RT	50		8.4		43			
145+35.60	RT	41		6.9		35			
147+85.08	RT								
148+63.73	RT								
149+27.43	RT								
150+20.05	RT	55		9.1		52			
151+56.41	RT					19			
152+16.65	RT					3			
152+66.62	RT					3			
152+91.81	RT					11			
153+69.51	RT					3			
154+00.71	RT					8			
155+16.32	RT	74		12.4		63			
156+10.19	LT	69		11.5					
156+24.76	RT	70		11.7		62			
156+76.22	RT	70		11.6		61			
157+86.53	RT	72		11.9		63			
158+38.12	RT	73		12.1		63			
159+44.98	RT	75		12.5		66			
160+04.53	RT	77		12.8		67			
161+74.95	RT	85		14.2		79			
162+33.69	RT	85		14.1		77			
163+39.86	RT	85		14.1		78			
163+93.55	RT	84		14.0		80			
164+99.69	RT	85		14.1		79			
165+53.48	RT	85		14.1		79			
166+61.90	RT	83		13.9		79			
167+11.61	RT	86		14.3		80			
167+80.62	RT	64		10.7		57			
168+22.23	RT	87		14.4		79			
168+72.16	RT	94		15.6		87			
171+08.61	RT	80		13.4		79			
172+09.52	RT	84		14.0		81			
SHEET TOTAL		2747		457.8		2498			

SUMMARY OF DRIVEWAYS AND REMOVAL OF EXIST. CONC.									
LOCATION	SIDE	CONC. DRIVEWAYS 6" THICK (SY)		COMMERCIAL MATERIAL FOR TEMPORARY DRIVEWAY MAINTENANCE, 6" THICK (CY)		REMOVAL OF EXIST. CONC. (SY)		DESIGN REMARKS	CONSTRUCTION REMARKS
STA		522 2		102-3		110-4-10			
		P	F	P	F	P	F		
172+64.14	RT	84		14.0		79			
173+69.91	RT	84		14.0		78			
174+24.20	RT	86		14.3		80			
175+31.20	RT	83		13.9		79			
175+82.35	RT	84		14.0		80			
176+89.50	RT	83		13.8		79			
177+44.30	RT	85		14.2		80			
178+51.24	RT	85		14.2		79			
179+09.89	RT	85		14.1		80			
207+29.66	RT	54		9.0		50			
207+76.77	RT	54		8.9		50			
208+46.44	RT	86		14.3		78			
210+00.00	RT	112		18.7		112			
213+70.25	RT	53		8.8		47			
214+15.72	RT	53		8.9		47			
214+73.58	RT	106		17.7		103			
215+29.61	RT	52		8.6		46			
215+76.46	RT	53		8.8		48			
216+12.22	RT	63		10.6		7			
216+52.51	RT	87		14.5		7			
220+17.59	RT	74		12.4		65			
220+46.95	RT	73		12.2		66			
226+00.42	RT	115		19.1		106			
226+86.19	RT	116		19.4		111			
227+38.55	RT	58		9.6		48			
227+84.54	RT	57		9.5		50			
228+19.24	RT	58		9.6		48			
228+66.78	RT	57		9.6		50			
229+00.06	RT	57		9.5		48			
229+46.97	RT	59		9.9		54			
231+52.89	RT	84		14.0		77			
240+49.16	RT	85		14.2		80			
243+23.93	RT	85		14.1		83			
247+21.66	RT	90		15.0		81			
98+80.00	RT	24		4.0		24		MILWAUKEE BLVD.	
102+14.76	LT					3		MILWAUKEE BLVD.	
102+29.70	LT					3		MILWAUKEE BLVD.	
102+89.80	LT					9		MILWAUKEE BLVD.	
102+94.83	LT					3		MILWAUKEE BLVD.	
102+94.83	LT					3		MILWAUKEE BLVD.	
FUTURE		375		62.5		375		COUNTY CONTROLLED ALLOWANCE FOR FUTURE HOME SITES (ASSUMED 5 NEW HOMES)	
SHEET TOTAL		2999		499.9		2697			
PROJECT TOTAL		5746		957.7		5195		SEE SUMMARY OF SIDEWALK FOR ADDITIONAL QUANTITY FOR PAY ITEM 522-2	

REVISIONS			
DATE	DESCRIPTION	DATE	DESCRIPTION



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LEE COUNTY	
ROAD NO.	COUNTY PROJECT NO.
BELL BLVD. SR 82 TO SUNRISE BLVD. SIDEWALK	6002

SUMMARY OF QUANTITIES	

SHEET NO.
17

SUMMARY OF MAILBOXES					
LOCATION	SIDE	MAILBOX, F&I SINGLE (EA)		DESIGN REMARKS	CONSTRUCTION REMARKS
STA		110 7 1			
		P	F		
51+34.00	RT	1			
77+44.50	RT	1			
78+34.50	RT	1			
79+95.00	RT	1			
87+61.50	RT	1			
105+85.50	RT	1			
106+96.50	RT	1			
114+16.00	RT	1			
116+02.00	RT	1			
118+73.00	RT	1			
123+77.50	RT	1			
124+82.50	RT	1			
144+20.50	RT	1			
144+29.00	RT	1			
144+72.00	RT	1			
145+54.00	RT	1			
148+02.00	RT	1			
148+47.00	RT	1			
149+50.00	RT	1			
149+97.00	RT	1			
155+38.50	RT	1			
156+46.50	RT	1			
156+98.00	RT	1			
157+65.00	RT	1			
158+16.00	RT	1			
159+23.00	RT	1			
159+82.00	RT	1			
161+53.00	RT	1			
162+55.50	RT	1			
163+19.00	RT	1			
163+72.00	RT	1			
164+78.00	RT	1			
165+75.00	RT	1			
166+40.00	RT	1			
167+33.50	RT	1			
168+00.00	RT	1			
168+44.00	RT	1			
168+94.00	RT	1			
171+28.00	RT	1			
171+88.00	RT	1			
172+86.50	RT	1			
173+92.00	RT	1			
174+46.00	RT	1			
SHEET TOTAL		43			

SUMMARY OF MAILBOXES					
LOCATION	SIDE	MAILBOX, F&I SINGLE (EA)		DESIGN REMARKS	CONSTRUCTION REMARKS
STA		110 7 1			
		P	F		
175+09.50	RT	1			
175+60.00	RT	1			
176+68.00	RT	1			
177+23.00	RT	1			
178+29.50	RT	1			
178+88.00	RT	1			
207+53.00	RT	2			
208+25.00	RT	1			
209+77.00	RT	1			
213+91.00	RT	1			
213+94.50	RT	1			
214+31.00	RT	1			
214+50.00	RT	1			
216+31.50	RT	2			
220+00.00	RT	1			
220+66.00	RT	1			
225+77.00	RT	1			
226+24.00	RT	1			
226+56.00	RT	1			
227+03.50	RT	1			
227+62.00	RT	2			
228+44.00	RT	2			
229+24.50	RT	2			
231+75.00	RT	1			
240+27.50	RT	1			
243+02.00	RT	1			
247+00.00	RT	1			
SHEET TOTAL		32			
PROJECT TOTAL		75			

SUMMARY OF SIGNAGE AND STRIPING																							
LOCATION	SIDE	SINGLE POST SIGN, F&I GROUND MOUNT, UP TO 12 SF		SINGLE POST SIGN, RELOCATE		SINGLE POST SIGN, REMOVE		OBJECT MARKER, TYPE 2		THRMPLSTC., STANDARD, WHITE, SOLID, 6"		THRMPLSTC., STANDARD YELLOW, SOLID, 6"		THRMPLSTC., STANDARD, WHITE, 12"		THRMPLSTC., STANDARD WHITE 24"		THRMPLSTC., PREFORMED WHITE 24"		THRMPLSTC., STANDARD YELLOW SOLID, 18" FOR DIAGONAL		DESIGN REMARKS	CONSTRUCTION REMARKS
STA		700-1-11		700 1 50		700 1 60		705 10 2		711 16101		711 16201		711 11123		711 11125		711 14125		711 11224			
		AS		AS		AS		EA		GM		GM		LF		LF		LF		LF			
		P	F	P	F	P	F	P	F	P	F	P	F	P	F	P	F	P	F	P	F		
31+00.00	RT			1																			
33+00.00	RT													101		18							
35+30.00	RT					1																	
45+25.00	RT													98		13							
56+80.00	RT													70		11							
59+90.00	RT													86		13							
72+05.00	RT													90		14							
76+05.00	RT													114		14							
88+75.00	RT													98		14							
92+55.00	RT													88		15							
98+35.00	RT													94		13							
109+80.00	RT													70		10							
113+60.00	RT													100		14							
115+25.00	RT			1																			
125+20.00	RT			1																			
126+30.00	RT													100		15							
126+60.00	RT			1																			
128+20.00	RT			1																			
129+80.00	RT			1																			
130+45.00	RT													133		20							
130+75.00	RT			1																			
145+80.00	RT			1																			
147+65.00	RT			1																			
149+75.00	RT			1																			
151+15.00	RT									0.004		0.015		128		26		100		20		BELL BLVD. EAST SIDE OF INT.	
151+15.00	LT													112				90				BELL BLVD. WEST SIDE OF INT.	
154+33.00	LT													95		16							
155+75.00	RT			1																			
156+50.00	RT					1																	
160+90.00	RT													88		15							
170+43.00	RT													86		12							
180+10.00	RT													84		11							
184+05.00	RT													70		10							
197+80.00	RT													88		14							
210+75.00	RT													75		10							
215+93.96	RT							4														STORM DRAIN STRUCTURE (S-79)	
216+33.23	RT							4														STORM DRAIN STRUCTURE (S-81)	
220+32.31	RT							4														STORM DRAIN STRUCTURE (S-84)	
223+50.00	RT													88		14							
228+01.06	RT							4														STORM DRAIN STRUCTURE (S-93)	
228+83.35	RT							4														STORM DRAIN STRUCTURE (S-97)	
233+50.00	RT													82		13							
237+50.00	RT													90		13							
250+25.00	RT	1																					
100+00.00	RT													138				110				MILWAUKEE BLVD. SOUTH SIDE OF INT	
100+00.00	LT													138				110				MILWAUKEE BLVD. NORTH SIDE OF INT	
103+30.00	LT													99		17		70				MILWAUKEE BLVD. NORTH SIDE OF INT	
103+30.00	LT/RT													128				100				THOMAS SHERWIN AVE. EAST SIDE	
PROJECT TOTAL		1		11		2		20		0.004		0.015		2831		355		580		20			

SUMMARY OF PERFORMANCE TURF, SOD								
LOCATION			SIDE	AVG WIDTH (FT)	PEFFORMANCE TURF, SOD (SY)		DESIGN REMARKS	CONSTRUCTION REMARKS
STA	TO	STA.			570 1 2			
					SY			
					P	F		
30+91.31	TO	32+80.93	RT	16.9	356			
33+22.60	TO	45+05.25	RT	11.5	1514			
45+44.45	TO	51+07.64	RT	6.5	409			
51+23.51	TO	56+61.40	RT	3.3	198			
56+89.68	TO	59+70.32	RT	2.8	88			
60+06.31	TO	71+87.86	RT	5.0	658			
72+22.57	TO	75+81.74	RT	3.8	153			
76+26.83	TO	77+54.81	RT	6.4	91			
77+74.27	TO	78+48.04	RT	15.6	127			
78+63.70	TO	80+08.69	RT	6.5	105			
80+24.52	TO	87+31.60	RT	5.7	448			
87+47.53	TO	88+48.60	RT	5.1	57			
88+89.62	TO	92+39.36	RT	10.8	420			
92+75.75	TO	98+16.29	RT	8.7	525			
98+55.80	TO	105+55.62	RT	8.8	685			
105+71.44	TO	106+66.54	RT	5.6	59			
106+82.38	TO	109+66.11	RT	8.4	264			
109+93.09	TO	113+34.36	RT	10.0	379			
113+76.82	TO	115+72.20	RT	5.9	128			
115+88.09	TO	118+42.50	RT	15.2	430			
118+58.32	TO	124+01.30	RT	6.3	381			
124+19.32	TO	124+53.53	RT	27.3	104			
124+69.30	TO	126+15.13	RT	15.0	242			
126+57.59	TO	130+15.92	RT	13.7	547			
130+68.26	TO	143+97.78	RT	10.0	1479			
144+06.59	TO	144+43.06	RT	22.6	91			
144+52.09	TO	144+86.02	RT	21.8	82			
144+94.93	TO	145+31.20	RT	22.7	91			
145+39.99	TO	147+79.39	RT	12.2	325			
147+90.76	TO	148+58.03	RT	17.1	128			
148+69.43	TO	149+19.60	RT	16.5	92			
149+35.26	TO	150+10.72	RT	16.7	140			
150+29.50	TO	150+90.11	RT		85			
154+00.71	TO	155+07.68	RT	14.9	177			
155+24.83	TO	156+16.85	RT	28.5	292			
156+32.67	TO	156+68.29	RT	25.3	100			
156+84.14	TO	157+78.56	RT	28.6	300			
157+94.46	TO	158+30.19	RT	30.3	120			
158+46.03	TO	159+37.05	RT	30.6	309			
159+52.92	TO	159+96.57	RT	30.9	150			
160+12.49	TO	160+71.30	RT	30.9	202			
161+09.70	TO	161+67.05	RT	28.0	178			
SHEET TOTAL					12711			

SUMMARY OF PERFORMANCE TURF, SOD								
LOCATION			SIDE	AVG WIDTH (FT)	PEFFORMANCE TURF, SOD (SY)		DESIGN REMARKS	CONSTRUCTION REMARKS
					570 1 2			
STA	TO	STA.			SY			
					P	F		
161+82.86	T0	162+25.80	RT	23.0	110			
162+41.57	T0	163+31.98	RT	23.8	239			
163+47.75	T0	163+85.62	RT	27.8	117			
164+01.47	T0	164+91.82	RT	26.3	264			
165+07.57	T0	165+45.61	RT	22.8	96			
165+61.35	T0	166+54.05	RT	19.5	201			
166+69.74	T0	167+03.69	RT	26.2	99			
167+19.52	T0	167+74.48	RT	21.9	134			
167+86.52	T0	168+14.31	RT	20.0	62			
168+30.15	T0	168+64.16	RT	21.6	82			
168+80.16	T0	170+25.93	RT	18.7	303			
170+59.75	T0	171+00.80	RT	22.8	104			
171+16.65	T0	172+01.55	RT	19.0	179			
172+17.49	T0	172+56.20	RT	22.7	98			
172+72.08	T0	173+62.02	RT	3.8	38			
173+77.80	T0	174+16.30	RT	5.0	21			
174+32.09	T0	175+23.30	RT	5.1	52			
175+39.12	T0	175+74.39	RT	4.8	19			
175+90.31	T0	176+81.60	RT	5.4	55			
176+97.40	T0	177+36.35	RT	6.0	26			
177+52.25	T0	178+43.38	RT	6.7	68			
178+59.09	T0	179+01.98	RT	3.3	15			
179+17.79	T0	179+90.19	RT	4.4	35			
180+23.83	T0	183+91.92	RT	2.7	110			
184+17.42	T0	197+60.70	RT	5.8	859			
197+97.23	T0	207+25.19	RT	7.1	730			
207+34.13	T0	207+72.45	RT	2.3	10			
207+81.09	T0	208+38.47	RT	2.4	15			
208+54.41	T0	209+88.64	RT	1.9	28			
210+10.75	T0	210+59.36	RT	3.1	17			
210+87.60	T0	213+65.79	RT	13.0	402			
213+74.63	T0	214+11.25	RT	23.3	95			
214+20.18	T0	214+63.41	RT	25.6	123			
214+83.74	T0	215+25.22	RT	23.3	108			
215+34.00	T0	215+71.97	RT	18.6	79			
215+80.94	T0	216+06.79	RT	30.6	88			
216+17.65	T0	216+44.51	RT	29.2	87			
216+60.51	T0	220+12.61	RT	18.7	733			
220+22.57	T0	220+42.05	RT	32.6	71			
220+51.85	T0	223+37.48	RT	16.7	530			
223+72.67	T0	225+89.66	RT	1.9	45			
226+11.18	T0	226+68.94	RT	5.3	34			
226+93.19	T0	227+33.55	RT	21.1	94			
SHEET TOTAL					6561			

REVISIONS				<div><div>Q. Grady Minor and Associates, P.A. 3800 Via Del Rey Bonita Springs, Florida 34134 Phone: 239.947.1144 R. DANIEL FLYNN, P.E. NO. 76205</div></div> <div><div>Civil Engineers</div>•<div>Land Surveyors</div>•<div>Planners</div>•<div>Landscape Architects</div><div><small>Certs. of Auth. LD 0005151    Certs. of Auth. LD 0005151    Business LC 20000268</small></div></div>
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SUMMARY OF PERFORMANCE TURF, SOD								
LOCATION			SIDE	AVG WIDTH (FT)	PEFFORMANCE TURF, SOD (SY)		DESIGN REMARKS	CONSTRUCTION REMARKS
					570 1 2			
STA	TO	STA.			SY			
					P	F		
227+43.55	TO	227+79.54	RT	20.0	80			
227+89.54	TO	228+14.24	RT	15.1	41			
228+24.24	TO	228+61.78	RT	3.5	15			
228+71.78	TO	228+95.06	RT	15.1	39			
229+05.06	TO	229+41.73	RT	19.5	79			
229+52.20	TO	231+45.05	RT	2.3	48			
231+60.73	TO	233+34.97	RT	1.9	37			
233+66.99	TO	237+31.85	RT	4.2	171			
237+65.70	TO	240+41.17	RT	2.5	78			
240+57.16	TO	243+15.97	RT	3.8	108			
243+31.89	TO	247+13.61	RT	5.9	251			
247+29.72	TO	250+32.76	RT	2.2	73			
151+48.94	TO	154+10.30	LT	11.6	337			
154+54.77	TO	156+02.18	LT	9.8	161			
156+18.24	TO	158+15.81	LT	13.2	290			
98+16.05	TO	98+85.20	RT	7.3	56		MILWAUKEE BLVD.	
98+95.16	TO	99+73.11	RT		137		MILWAUKEE BLVD.	
102+89.79	TO	103+08.98	LT	4.0	9		MILWAUKEE BLVD.	
103+53.98	TO	103+68.89	LT		27			
103+63.89	TO	103+68.89	RT		6			
	TO				0			
	TO				0			
	TO				0			
SHEET TOTAL					2042			
PROJECT TOTAL					21314			

SUMMARY OF ROOT BARRIER					
LOCATION	SIDE	ROOT BARRIER- 24" (LF)		DESIGN REMARKS	CONSTRUCTION REMARKS
STA		580 12 35			
		P	F		
131+13.00	RT	63			
132+10.00	RT	52			
133+07.00	RT	29			
135+40.00	RT	20			
135+95.00	RT	39			
137+94.00	RT	61			
138+88.00	RT	63			
140+07.50	RT	80			
141+27.00	RT	80			
173+17.00	RT	48			
178+03.00	RT	48			
179+40.00	RT	24			
183+19.00	RT	58			
187+24.00	RT	31			
188+50.00	RT	31			
190+80.00	RT	48			
192+00.00	RT	46			
193+20.00	RT	19			
194+50.00	RT	35			
195+60.00	RT	26			
202+80.00	RT	49			
203+80.00	RT	49			
205+00.00	RT	51			
206+20.00	RT	20			
211+40.00	RT	49			
212+80.00	RT	41			
225+40.00	RT	48			
229+20.00	RT	35			
236+50.00	RT	37			
238+50.00	RT	48			
239+80.00	RT	43			
242+40.00	RT	42			
243+40.00	RT	49			
245+00.00	RT	46			
246+00.00	RT	43			
247+00.00	RT	60			
PROJECT TOTAL		1611			

SUMMARY OF EROSION AND SEDIMENT CONTROL DEVICES									
LOCATION			SIDE	SEDIMENT BARRIER		INLET PROTECTION SYSTEM		DESIGN REMARKS	CONSTRUCTION REMARKS
				104 10 3		104 18			
STA	TO	STA.		LF		EA			
				P	F	P	F		
30+91.31	TO	32+90.00	RT	199					
33+10.00	TO	45+10.00	RT	1200					
45+45.00	TO	51+07.64	RT	563					
51+20.00	TO	51+20.00	RT			1		INLET PROTECTION FOR SIDE DRAIN AT DRIVEWAY	
51+23.51	TO	56+65.00	RT	541					
51+30.00	TO	51+30.00	RT			1		INLET PROTECTION FOR SIDE DRAIN AT DRIVEWAY	
56+90.00	TO	59+70.00	RT	280					
60+05.00	TO	71+90.00	RT	1185					
72+10.00	TO	75+90.00	RT	380					
76+15.00	TO	77+54.81	RT	140					
77+74.27	TO	78+48.04	RT	74					
78+40.00	TO	78+40.00	RT			1		INLET PROTECTION FOR SIDE DRAIN AT DRIVEWAY	
78+63.70	TO	80+08.69	RT	145					
78+80.00	TO	78+80.00	RT			1		INLET PROTECTION FOR SIDE DRAIN AT DRIVEWAY	
80+00.00	TO	80+00.00	RT			1		INLET PROTECTION FOR SIDE DRAIN AT DRIVEWAY	
80+24.52	TO	87+31.60	RT	707					
80+30.00	TO	80+30.00	RT			1		INLET PROTECTION FOR SIDE DRAIN AT DRIVEWAY	
87+20.00	TO	87+20.00	RT			1		INLET PROTECTION FOR SIDE DRAIN AT DRIVEWAY	
87+47.53	TO	88+40.00	RT	92					
87+60.00	TO	87+60.00	RT			1		INLET PROTECTION FOR SIDE DRAIN AT DRIVEWAY	
88+80.00	TO	92+40.00	RT	360					
92+70.00	TO	98+20.00	RT	550					
98+70.00	TO	105+55.62	RT	686					
105+50.00	TO	105+50.00	RT			1		INLET PROTECTION FOR SIDE DRAIN AT DRIVEWAY	
105+71.44	TO	106+66.54	RT	95					
105+80.00	TO	105+80.00	RT			1		INLET PROTECTION FOR SIDE DRAIN AT DRIVEWAY	
106+60.00	TO	106+60.00	RT			1		INLET PROTECTION FOR SIDE DRAIN AT DRIVEWAY	
106+82.38	TO	109+65.00	RT	283					
106+90.00	TO	106+90.00	RT			1		INLET PROTECTION FOR SIDE DRAIN AT DRIVEWAY	
109+65.00	TO	109+65.00	RT			1		INLET PROTECTION FOR CROSS DRAIN AT COLYER ST.	
109+95.00	TO	109+95.00	RT			1		INLET PROTECTION FOR CROSS DRAIN AT COLYER ST.	
109+95.00	TO	113+40.00	RT	345					
113+75.00	TO	115+72.20	RT	197					
115+60.00	TO	115+60.00	RT			1		INLET PROTECTION FOR SIDE DRAIN AT DRIVEWAY	
115+88.09	TO	118+42.50	RT	254					
115+95.00	TO	115+95.00	RT			1		INLET PROTECTION FOR SIDE DRAIN AT DRIVEWAY	
118+30.00	TO	118+30.00	RT			1		INLET PROTECTION FOR SIDE DRAIN AT DRIVEWAY	
118+58.32	TO	124+01.30	RT	543					
118+65.00	TO	118+65.00	RT			1		INLET PROTECTION FOR SIDE DRAIN AT DRIVEWAY	
123+90.00	TO	123+90.00	RT			1		INLET PROTECTION FOR SIDE DRAIN AT DRIVEWAY	
124+19.32	TO	124+53.53	RT	34					
124+25.00	TO	124+25.00	RT			1		INLET PROTECTION FOR SIDE DRAIN AT DRIVEWAY	
124+40.00	TO	124+40.00	RT			1		INLET PROTECTION FOR SIDE DRAIN AT DRIVEWAY	
124+69.30	TO	126+20.00	RT	151					
SHEET TOTAL				9004		21			


SUMMARY OF EROSION AND SEDIMENT CONTROL DEVICES									
LOCATION			SIDE	SEDIMENT BARRIER		INLET PROTECTION SYSTEM		DESIGN REMARKS	CONSTRUCTION REMARKS
STA	TO	STA.		104 10 3		104 18			
				LF		EA			
P	F	P	F						
124+80.00	T0	124+80.00	RT		1		INLET PROTECTION FOR SIDE DRAIN AT DRIVEWAY		
126+70.00	T0	130+20.00	RT	350					
128+50.00	T0	128+50.00	RT		1		CROSS DRAIN BELL BLVD.		
130+55.00	T0	143+97.78	RT	1343					
143+76.47	T0	143+97.78	RT	21					
144+06.59	T0	144+43.06	RT	36					
144+52.09	T0	144+86.02	RT	34					
144+94.93	T0	145+31.20	RT	36					
145+39.99	T0	147+79.39	RT	239					
147+90.76	T0	148+58.03	RT	67					
148+69.43	T0	149+19.60	RT	50					
149+35.26	T0	150+10.72	RT	75					
150+29.50	T0	150+90.00	RT	61					
151+50.00	T0	154+15.00	LT	265					
152+75.00	T0	152+75.00	LT		1		INLET PROTECTION FOR DBI AT EXIST. SIDEWALK		
153+00.00	T0	153+00.00	LT		1		INLET PROTECTION FOR SIDE DRAIN AT EXIST. SIDEWALK		
153+85.00	T0	155+07.68	RT	123					
154+50.00	T0	155+95.00	LT	145					
155+24.83	T0	156+16.85	RT	92					
156+19.00	T0	158+18.00	LT	199					
156+32.67	T0	156+68.29	RT	36					
156+84.14	T0	157+78.56	RT	94					
157+94.46	T0	158+30.19	RT	36					
158+46.03	T0	159+37.05	RT	91					
159+52.92	T0	159+96.57	RT	44					
160+12.49	T0	160+80.00	RT	68					
161+10.00	T0	161+67.05	RT	57					
161+82.86	T0	162+25.80	RT	43					
162+41.57	T0	163+31.98	RT	90					
163+47.75	T0	163+85.62	RT	38					
164+01.47	T0	164+91.82	RT	90					
165+07.57	T0	165+45.61	RT	38					
165+21.00	T0	165+21.00	RT		1		INLET PROTECTION FOR CATCH BASIN		
165+61.35	T0	166+54.05	RT	93					
166+69.74	T0	167+03.69	RT	34					
167+19.52	T0	167+74.48	RT	55					
167+86.52	T0	168+14.31	RT	28					
168+30.15	T0	168+64.16	RT	34					
164+80.16	T0	170+30.00	RT	550					
170+55.00	T0	171+00.80	RT	46					
170+95.00	T0	170+95.00	RT		1		INLET PROTECTION FOR SIDE DRAIN AT DRIVEWAY		
171+16.65	T0	172+01.55	RT	85					
171+25.00	T0	171+25.00	RT		1		INLET PROTECTION FOR SIDE DRAIN AT DRIVEWAY		
171+95.00	T0	171+95.00	RT		1		INLET PROTECTION FOR SIDE DRAIN AT DRIVEWAY		
172+17.49	T0	172+56.20	RT	39					
172+25.00	T0	172+25.00	RT		1		INLET PROTECTION FOR SIDE DRAIN AT DRIVEWAY		
SHEET TOTAL				4825		9			

REVISIONS				<div><p>Q. Grady Minor and Associates, P.A. 3800 Via Del Rey Bonita Springs, Florida 34134 Phone: 239.947.1144 R. DANIEL FLYNN, P.E. NO. 76205</p><p><b>GradyMinor</b> Civil Engineers • Land Surveyors • Planners • Landscape Architects <small>Certs. of Auth. CD 9005151    Cert. of Auth. LD 9005151    Business LC 20000286</small></p></div>	LEE COUNTY		SUMMARY OF QUANTITIES	SHEET NO.
DATE	DESCRIPTION	DATE	DESCRIPTION		ROAD NO.	COUNTY PROJECT NO.		22
					BELL BLVD. SR 82 TO SUNRISE BLVD. SIDEWALK	6002		

SUMMARY OF EROSION AND SEDIMENT CONTROL DEVICES										
LOCATION			SIDE	SEDIMENT BARRIER		INLET PROTECTION SYSTEM		DESIGN REMARKS	CONSTRUCTION REMARKS	
				104 10 3		104 18				
STA	TO	STA.		LF		EA				
				P	F	P	F			
172+53.00	T0	172+53.00	RT			1		INLET PROTECTION FOR SIDE DRAIN AT DRIVEWAY		
172+72.08	T0	173+62.02	RT	90						
172+80.00	T0	172+80.00	RT			1		INLET PROTECTION FOR SIDE DRAIN AT DRIVEWAY		
173+55.00	T0	173+55.00	RT			1		INLET PROTECTION FOR SIDE DRAIN AT DRIVEWAY		
173+77.80	T0	174+16.30	RT	39						
173+85.00	T0	173+85.00	RT			1		INLET PROTECTION FOR SIDE DRAIN AT DRIVEWAY		
174+10.00	T0	174+10.00	RT			1		INLET PROTECTION FOR SIDE DRAIN AT DRIVEWAY		
174+32.09	T0	175+23.30	RT	91						
174+40.00	T0	174+40.00	RT			1		INLET PROTECTION FOR SIDE DRAIN AT DRIVEWAY		
175+15.00	T0	175+15.00	RT			1		INLET PROTECTION FOR SIDE DRAIN AT DRIVEWAY		
175+39.12	T0	175+74.39	RT	35						
175+45.00	T0	175+45.00	RT			1		INLET PROTECTION FOR SIDE DRAIN AT DRIVEWAY		
175+65.00	T0	175+65.00	RT			1		INLET PROTECTION FOR SIDE DRAIN AT DRIVEWAY		
175+90.31	T0	176+81.60	RT	91						
176+00.00	T0	176+00.00	RT			1		INLET PROTECTION FOR SIDE DRAIN AT DRIVEWAY		
176+70.00	T0	176+70.00	RT			1		INLET PROTECTION FOR SIDE DRAIN AT DRIVEWAY		
176+97.40	T0	177+36.35	RT	39						
177+10.00	T0	177+10.00	RT			1		INLET PROTECTION FOR SIDE DRAIN AT DRIVEWAY		
177+25.00	T0	177+25.00	RT			1		INLET PROTECTION FOR SIDE DRAIN AT DRIVEWAY		
177+52.25	T0	178+43.38	RT	91						
177+60.00	T0	177+60.00	RT			1		INLET PROTECTION FOR SIDE DRAIN AT DRIVEWAY		
178+30.00	T0	178+30.00	RT			1		INLET PROTECTION FOR SIDE DRAIN AT DRIVEWAY		
178+59.09	T0	179+01.98	RT	43						
178+70.00	T0	178+70.00	RT			1		INLET PROTECTION FOR SIDE DRAIN AT DRIVEWAY		
178+95.00	T0	178+95.00	RT			1		INLET PROTECTION FOR SIDE DRAIN AT DRIVEWAY		
179+17.79	T0	179+95.00	RT	77						
179+30.00	T0	179+30.00	RT			1		INLET PROTECTION FOR SIDE DRAIN AT DRIVEWAY		
179+85.00	T0	179+85.00	RT			1		THEODORE VAIL ST. SIDE DRAIN		
180+15.00	T0	183+95.00	RT	380		1		INLET PROTECTION FOR SIDE DRAIN AT DRIVEWAY		
180+25.00	T0	180+25.00	RT			1		THEODORE VAIL ST. SIDE DRAIN		
181+80.00	T0	181+80.00	RT			1				
184+15.00	T0	197+65.00	RT	1350						
197+90.00	T0	207+25.19	RT	935						
207+25.00	T0	207+25.00	RT			1		INLET PROTECTION FOR SIDE DRAIN AT DRIVEWAY		
207+34.13	T0	207+72.45	RT	38						
207+40.00	T0	207+40.00	RT			1		INLET PROTECTION FOR SIDE DRAIN AT DRIVEWAY		
207+70.00	T0	207+70.00	RT			1		INLET PROTECTION FOR SIDE DRAIN AT DRIVEWAY		
207+81.09	T0	208+38.47	RT	57						
207+85.00	T0	207+85.00	RT			1		INLET PROTECTION FOR SIDE DRAIN AT DRIVEWAY		
208+30.00	T0	208+30.00	RT			1		INLET PROTECTION FOR SIDE DRAIN AT DRIVEWAY		
208+54.41	T0	209+88.64	RT	134						
208+65.00	T0	208+65.00	RT			1		INLET PROTECTION FOR SIDE DRAIN AT DRIVEWAY		
SHEET TOTAL				3492		28				

SUMMARY OF EROSION AND SEDIMENT CONTROL DEVICES										
LOCATION			SIDE	SEDIMENT BARRIER		INLET PROTECTION SYSTEM		DESIGN REMARKS	CONSTRUCTION REMARKS	
STA	TO	STA.		104 10 3		104 18				
				LF		EA				
			P	F	P	F				
209+80.00	TO	209+80.00	RT			1		INLET PROTECTION FOR SIDE DRAIN AT DRIVEWAY		
210+10.75	TO	210+59.36	RT	49						
210+15.00	TO	210+15.00	RT			1		INLET PROTECTION FOR SIDE DRAIN AT DRIVEWAY		
210+85.00	TO	213+65.79	RT	281						
213+74.63	TO	214+11.25	RT	37						
214+20.18	TO	214+63.41	RT	43						
214+83.74	TO	215+25.22	RT	41						
215+34.00	TO	215+71.97	RT	38						
215+80.94	TO	216+06.79	RT	26						
216+17.65	TO	216+44.51	RT	27						
216+60.51	TO	220+00.00	RT	339						
220+22.57	TO	220+42.05	RT	19						
220+60.00	TO	223+45.00	RT	285						
223+60.00	TO	225+89.66	RT	230						
226+11.18	TO	226+68.94	RT	58						
226+93.19	TO	227+33.55	RT	40						
227+43.55	TO	227+79.54	RT	36						
227+89.54	TO	228+14.24	RT	25						
228+24.24	TO	228+61.78	RT	38						
228+71.78	TO	228+95.06	RT	23						
229+05.06	TO	229+41.73	RT	37						
229+52.20	TO	231+45.05	RT	193						
231+60.73	TO	233+38.00	RT	177						
233+65.00	TO	237+35.00	RT	370						
237+62.00	TO	240+41.17	RT	279						
240+30.00	TO	240+30.00	RT			1		INLET PROTECTION FOR SIDE DRAIN AT DRIVEWAY		
240+57.16	TO	243+15.97	RT	259						
240+60.00	TO	240+60.00	RT			1		INLET PROTECTION FOR SIDE DRAIN AT DRIVEWAY		
243+10.00	TO	243+10.00	RT			1		INLET PROTECTION FOR SIDE DRAIN AT DRIVEWAY		
243+31.89	TO	247+13.61	RT	382				MILWAUKEE BLVD.		
243+60.00	TO	243+60.00	RT			1		INLET PROTECTION FOR SIDE DRAIN AT DRIVEWAY		
247+00.00	TO	247+00.00	RT			1		INLET PROTECTION FOR SIDE DRAIN AT DRIVEWAY		
247+29.72	TO	250+40.00	RT	310				MILWAUKEE BLVD.		
247+40.00	TO	247+40.00	RT			1		INLET PROTECTION FOR SIDE DRAIN AT DRIVEWAY		
98+16.05	TO	99+40.00	RT	124				MILWAUKEE BLVD.		
102+89.80	TO	103+15.00	RT	25						
103+50.00	TO	103+70.00	RT	20						
	TO		RT							
	TO		RT							
	TO		RT							
SHEET TOTAL				3811		8				
PROJECT QUANTITY				21130		66				

REVISIONS			
DATE	DESCRIPTION	DATE	DESCRIPTION



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Civil Engineers  
Certs. of Auth. LD 0005151

Land Surveyors  
Certs. of Auth. LD 0005151

Planners  
Business LC 20000268

Landscape Architects  
Business LC 20000268

LEE COUNTY	
ROAD NO.	COUNTY PROJECT NO.
BELL BLVD. SR 82 TO SUNRISE BLVD. SIDEWALK	6002

SUMMARY OF QUANTITIES

SUMMARY OF LITTER REMOVAL AND MOWING																
CONST. PHASE	LOCATION			SIDE	DURATION (DAYS)	FREQUENCY (DAYS)	LITTER REMOVAL				MOWING				DESIGN NOTES	CONSTRUCTION NOTES
							107 1				107 2					
	STATION	TO	STATION				CYCLES	AREA		CYCLES	AREA					
								AC/CYCLE	TOTAL (AC)		AC/CYCLE	TOTAL (AC)				
								P	F			P	F			
1	30+91.31	T0	126+15.13	RT	300	30	10	8.96	89.64			8.96	89.64			
1	126+15.13	T0	130+13.45	RT	300	30	10	0.28	2.83			0.28	2.83			
1	130+13.45	T0	145+41.46	RT	300	30	10	1.23	12.28			1.23	12.28			
1	145+41.46	T0	150+94.38	RT	300	30	10	0.39	3.93			0.39	3.93			
1	151+69.76	T0	158+18.50	LT	300	30	10	0.52	5.21			0.52	5.21			
1	154+10.00	T0	160+71.30	RT	300	30	10	0.47	4.71			0.47	4.71			
1	160+71.30	T0	184+37.25	RT	300	30	10	2.23	22.27			2.23	22.27			
1	184+37.25	T0	206+82.89	RT	300	30	10	2.11	21.14			2.11	21.14			
1	206+82.89	T0	250+32.76	RT	300	30	10	4.09	40.94			4.09	40.94			
1	98+16.05	T0	103+69.00	LT/RT	300	30	10	1.27	12.69			1.27	12.69		MILWAUKEE BLVD.	
		T0														
								TOTAL	215.65			TOTAL	215.65			



SUMMARY OF DRAINAGE STRUCTURES:

QUANTITY	STR. NO.	STATION	SIDE	DESCRIPTION	BARRELS	STORM DRAIN RCP		STORM DRAIN ERCP	SIDE DRAIN MES		MANHOLES	DITCH BOTTOM INLETS	REMARKS
						18"	24"		18"	12"X18"	P-8	C	
								12"X18"	18"	12"X18"	< 10'	<10'	
P	S-1	77+49.81	RT	Mitered End Section, Pipe	1			24		1			
F													
P	S-2	77+78.35	RT	Mitered End Section						1			
F													
P	S-5	126+65.93	RT	DBI, Pipe	1	185						1	
F													
P	S-6	128+50.64	RT	DBI, Pipe	1		5					1	CROSS DRAIN TO CONC. JACKET
F													
P	S-7	129+35.51	RT	Manhole, Pipe	1	88					1		
F													
P	S-8	129+99.94	RT	DBI, Pipe	1	68						1	
F													
P	S-9	130+73.55	RT	DBI, Pipe	1	74						1	
F													
P	S-10	130+97.16	RT	Mitered End Section		31			1				
F													
P	S-11	143+47.46	RT	DBI, Pipe	1	43						1	
F													
P	S-12	143+87.78	RT	DBI, Pipe	1	37						1	
F													
P	S-13	144+25.22	RT	DBI, Pipe	1	38						1	
F													
P	S-14	144+62.81	RT	DBI, Pipe	1	52						1	
F													
P	S-15	145+14.32	RT	DBI, Pipe	1	48						1	
F													
P	S-16	145+62.26	RT	DBI, Pipe	1	113						1	
F													
P	S-17	146+74.74	RT	DBI, Pipe	1	95						1	
F													
P	S-18	147+69.39	RT	DBI, Pipe	1	57						1	
F													
P	S-19	148+26.76	RT	DBI, Pipe	1	56						1	
F													
P	S-20	148+83.19	RT	DBI, Pipe	1	91						1	
F													
P	S-21	149+74.14	RT	DBI, Pipe	1	73						1	
F													
P	S-22	150+47.51	RT	DBI								1	
F													
P	S-23	154+12.16	RT	DBI, Pipe	1	37						1	
F													
P	S-24	154+49.23	RT	DBI								1	
F													
P	S-25	154+97.44	RT	Mitered End Section, Pipe	1			32		1			
F													
P	S-26	155+35.04	RT	Mitered End Section						1			
F													
P	S-27	156+06.70	RT	Mitered End Section, Pipe	1			32		1			
F													
P	S-28	156+42.75	RT	Mitered End Section						1			
F													
SHEET TOTAL						1186	5	88	1	6	1	18	






SUMMARY OF DRAINAGE STRUCTURES:

QUANTITY	STR. NO.	STATION	SIDE	DESCRIPTION	BARRELS	STORM DRAIN RCP		STORM DRAIN ERCP 12" X18"	SIDE DRAIN MES		MANHOLES	DITCH BOTTOM	REMARKS
						18"	24"		18"	12" X18"	P-8 < 10'	C <10'	
P	S-29	156+58.23	RT	Mitered End Section, Pipe	1			32		1			
F													
P	S-30	156+94.28	RT	Mitered End Section						1			
F													
P	S-31	157+68.99	RT	Mitered End Section, Pipe	1			32		1			
F													
P	S-32	158+03.75	RT	Mitered End Section						1			
F													
P	S-33	158+23.69	RT	Mitered End Section, Pipe	1			24		1			
F													
P	S-34	158+52.23	RT	Mitered End Section						1			
F													
P	S-35	159+30.71	RT	Mitered End Section, Pipe	1			24		1			
F													
P	S-36	159+59.25	RT	Mitered End Section						1			
F													
P	S-37	159+90.27	RT	Mitered End Section, Pipe	1			24		1			
F													
P	S-38	160+18.81	RT	Mitered End Section						1			
F													
P	S-39	161+60.87	RT	Mitered End Section, Pipe	1			24		1			
F													
P	S-40	161+89.41	RT	Mitered End Section						1			
F													
P	S-41	162+19.46	RT	Mitered End Section, Pipe	1			24		1			
F													
P	S-42	162+48.00	RT	Mitered End Section						1			
F													
P	S-43	163+25.59	RT	Mitered End Section, Pipe	1			24		1			
F													
P	S-44	163+54.13	RT	Mitered End Section						1			
F													
P	S-45	163+79.27	RT	Mitered End Section, Pipe	1			24		1			
F													
P	S-46	164+07.81	RT	Mitered End Section						1			
F													
P	S-47	164+85.09	RT	Mitered End Section, Pipe	1			24		1			
F													
P	S-48	165+13.63	RT	Mitered End Section						1			
F													
P	S-49	165+39.15	RT	Mitered End Section, Pipe	1			24		1			
F													
P	S-50	165+67.69	RT	Mitered End Section						1			
F													
P	S-51	166+47.68	RT	Mitered End Section, Pipe	1			24		1			
F													
P	S-52	166+76.22	RT	Mitered End Section						1			
F													
P	S-53	166+97.35	RT	Mitered End Section, Pipe	1			24		1			
F													
P	S-54	167+25.89	RT	Mitered End Section						1			
F													
SHEET TOTAL						0	0	328	0	26	0	0	



SUMMARY OF DRAINAGE STRUCTURES:

QUANTITY	STR. NO.	STATION	SIDE	DESCRIPTION	BARRELS	STORM DRAIN RCP		STORM DRAIN ERCP 12"X18"	SIDE DRAIN MES		MANHOLES	DITCH BOTTOM	REMARKS
						18"	24"		18"	12"X18"	P-8 < 10'	C <10'	
P	S-55	167+66.16	RT	Mitered End Section, Pipe	1			24		1			
F													
P	S-56	167+94.70	RT	Mitered End Section						1			
F													
P	S-57	168+08.37	RT	Mitered End Section, Pipe	1			24		1			
F													
P	S-58	168+36.91	RT	Mitered End Section						1			
F		Q											
P	S-59	168+57.89	RT	Mitered End Section, Pipe	1			24		1			
F													
P	S-60	168+86.43	RT	Mitered End Section						1			
F													
P	S-61	184+39.80	RT	DBI, Pipe	1	31						1	
F													
P	S-62	184+63.97	RT	DBI								1	
F													
P	S-63	197+17.63	RT	DBI, Pipe	1	33						1	
F													
P	S-64	197+48.12	RT	DBI								1	
F													
P	S-65	198+14.45	RT	DBI, Pipe	1	35						1	
F													
P	S-66	198+47.83	RT	DBI								1	
F													
P	S-67	206+47.84	RT	DBI, Pipe	1	37						1	
F													
P	S-68	206+83.68	RT	DBI								1	
F													
P	S-69	213+59.91	RT	Mitered End Section, Pipe	1			16		1			
F													
P	S-70	213+80.45	RT	Mitered End Section						1			
F													
P	S-71	214+05.48	RT	Mitered End Section, Pipe	1			16		1			
F													
P	S-72	214+26.02	RT	Mitered End Section						1			
F													
P	S-73	214+54.95	RT	Mitered End Section, Pipe	1			32		1			
F													
P	S-74	214+91.49	RT	Mitered End Section						1			
F													
P	S-75	215+19.36	RT	Mitered End Section, Pipe	1			16		1			
F													
P	S-76	215+39.90	RT	Mitered End Section						1			
F													
P	S-77	215+59.69	RT	Mitered End Section, Pipe	1			32		1			
F													
P	S-79	215+93.96	RT	DBI, Pipe	1			39				1	SEE DETAIL ON SHEET 28
F													
P	S-81	216+33.23	RT	DBI, Pipe	1			32				1	SEE DETAIL ON SHEET 28
F													
P	S-82	216+67.50	RT	Mitered End Section						1			
F													
SHEET TOTAL						136	0	255	0	16	0	10	

SUMMARY OF DRAINAGE STRUCTURES:													
QUANTITY	STR. NO.	STATION	SIDE	DESCRIPTION	BARRELS	STORM DRAIN RCP		STORM DRAIN ERCP	SIDE DRAIN MES		MANHOLES	DITCH BOTTOM	REMARKS
						18"	24"	12"X18"	18"	12"X18"	P-8	C	
											< 10'	<10'	
P	S-83	220+06.04	RT	Mitered End Section, Pipe				24		1			
F													
P	S-84	220+32.31	RT	DBI, Pipe				24				1	SEE DETAIL ON THIS SHEET
F													
P	S-85	220+58.62	RT	Mitered End Section						1			
F													
P	S-86	225+66.89	RT	Mitered End Section, Pipe	1			48		1			
F													
P	S-87	226+19.47	RT	Mitered End Section						1			
F													
P	S-88	226+62.79	RT	Mitered End Section, Pipe	1			32		1			
F													
P	S-89	2269+93.33	RT	Mitered End Section						1			
F													
P	S-92	227+24.10	RT	Mitered End Section, Pipe	1			77		1			
F													
P	S-93	228+01.06	RT	DBI, Pipe	1			9				1	SEE DETAIL ON THIS SHEET
F													
P	S-97	228+83.35	RT	DBI, Pipe	1			6				1	SEE DETAIL ON THIS SHEET
F													
P	S-101	229+61.24	RT	Mitered End Section, Pipe	1			78		1			
F													
P	S-102	231+38.62	RT	Mitered End Section, Pipe	1			24		1			
F													
P	S-103	231+67.16	RT	Mitered End Section	1					1			
F													
P	S-104	99+40.01	RT	DBI								1	MILWAUKEE BLVD
F													
P	S-105	99+21.80	RT	DBI, Pipe	1	20						1	MILWAUKEE BLVD
F													
P	FUTURE				1			120		10			COUNTY CONTROLLED ALLOWANCE FOR FUTURE HOME SITES (ASSUMED 5 NEW HOMES)
			SHEET TOTAL			20	0	442	0	20	0	5	
			PROJECT TOTAL			1342	5	1113	1	68	1	33	

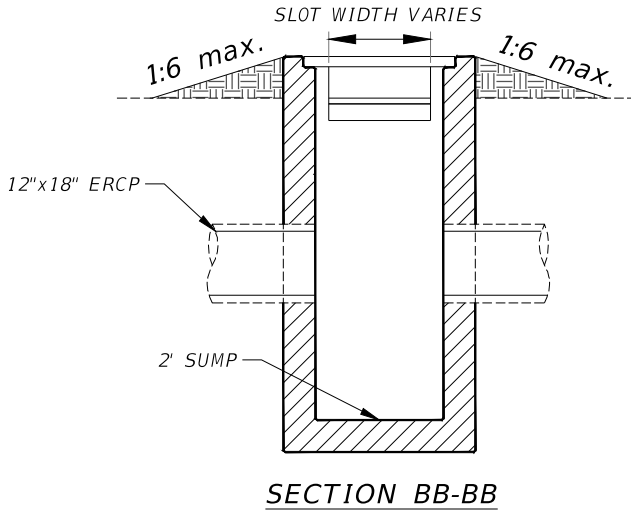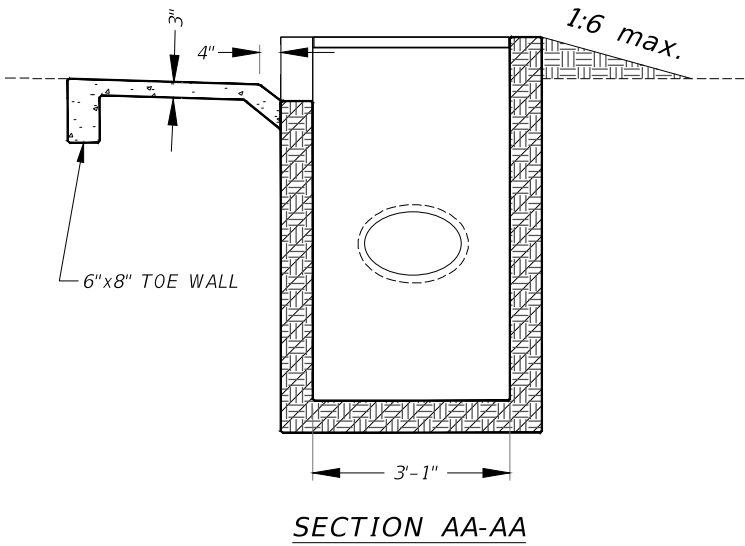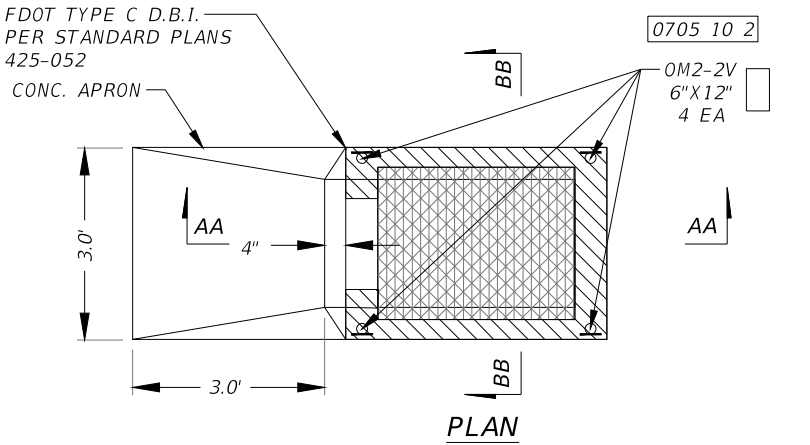


DITCH BOTTOM INLET TYPE 'C'  
CONCRETE APRON DETAIL  
(S-79, S-81, S-84, S-93 & S-97)  
N.T.S.

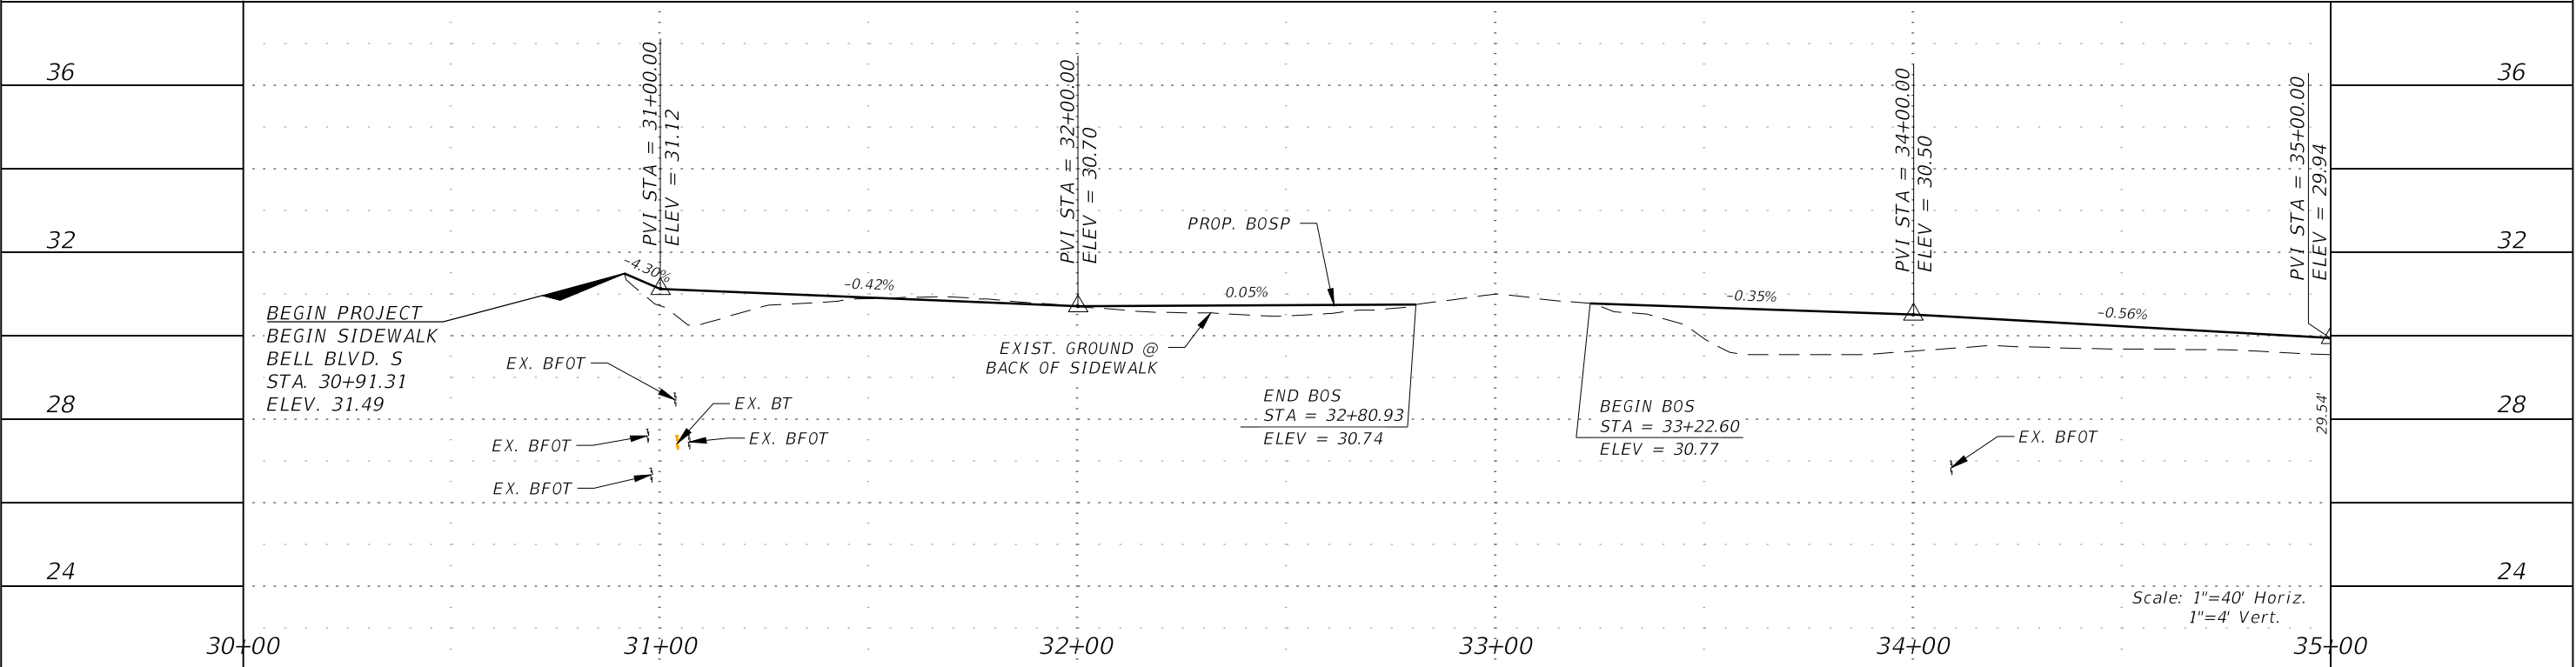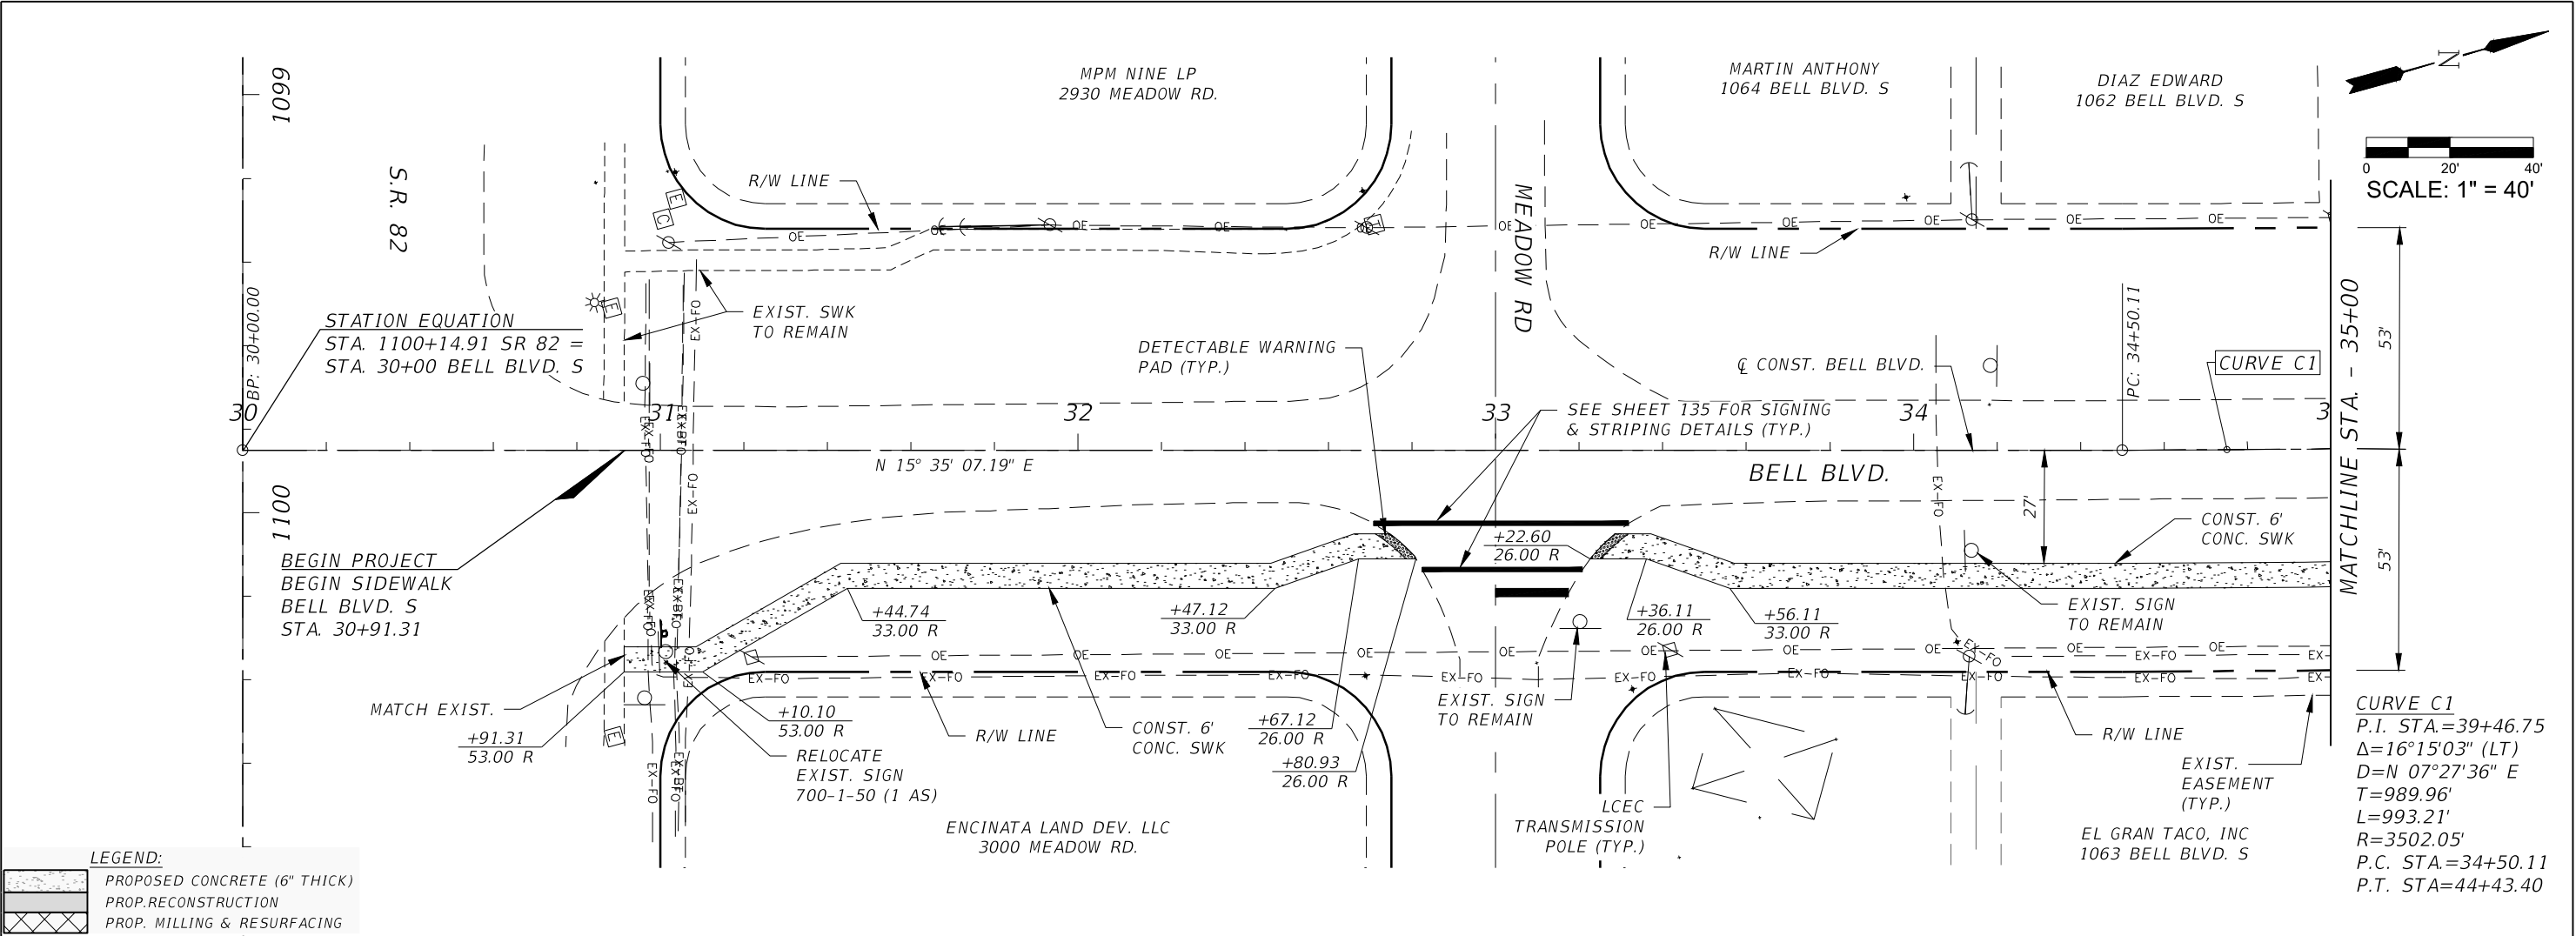


REVISIONS				<div><p>Q. Grady Minor and Associates, P.A. 3800 Via Del Rey Bonita Springs, Florida 34134 Phone: 239.947.1144 R. DANIEL FLYNN, P.E. NO. 76205</p><p><b>GradyMinor</b></p><p>Civil Engineers • Land Surveyors • Planners • Landscape Architects <small>CERT. OF REG. PR 00000111      CERT. OF REG. PR 00000111      REGISTRATION 07-00000000</small></p></div>	LEE COUNTY		ROADWAY PLAN & PROFILE STA. 30+00 TO STA. 35+00	SHEET NO.  30
DATE	DESCRIPTION	DATE	DESCRIPTION					
						ROAD NO. BELL BLVD. SR 82 TO SUNRISE BLVD. SIDEWALK		COUNTY PROJECT NO. 6002




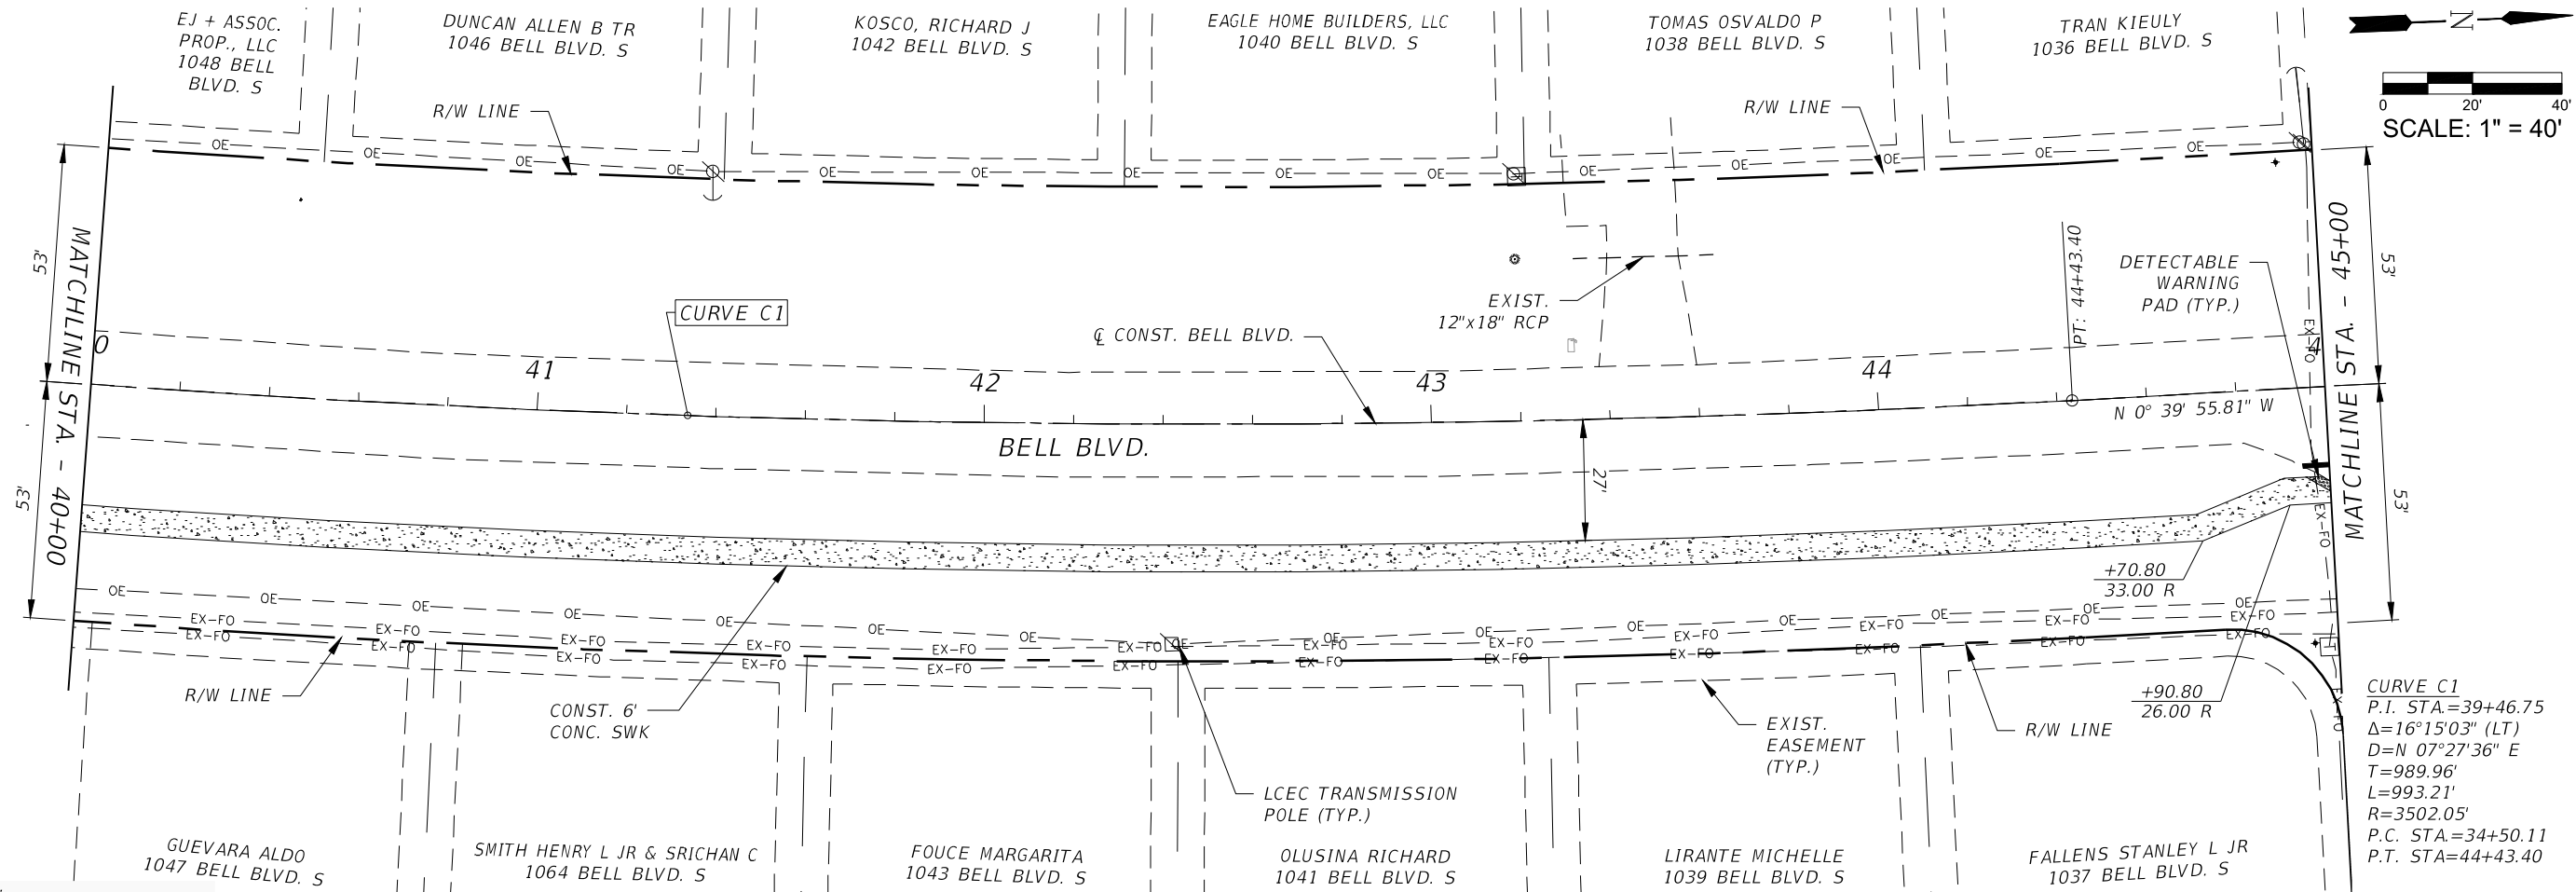


LEGEND:

	PROPOSED CONCRETE (6" THICK)
	PROP. RECONSTRUCTION
	PROP. MILLING & RESURFACING


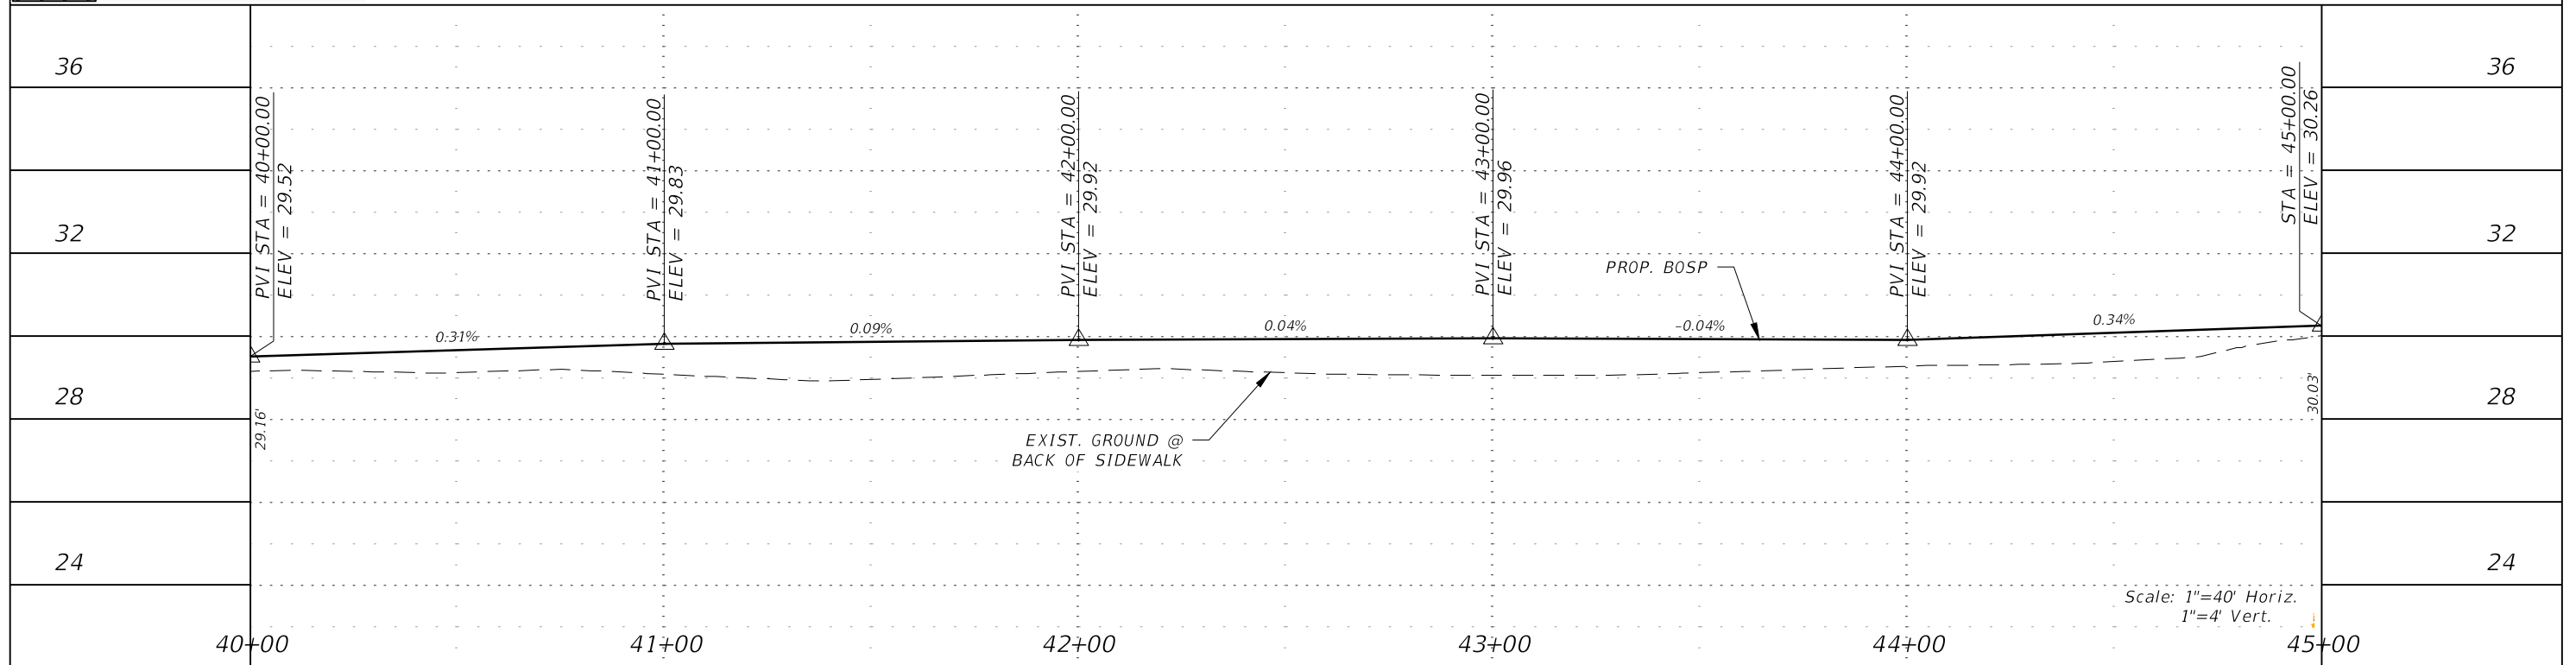


REVISIONS				 Q. Grady Minor and Associates, P.A. 3800 Via Del Rey Bonita Springs, Florida 34134 Phone: 239.947.1144 R. DANIEL FLYNN, P.E. NO. 76205	LEE COUNTY		ROADWAY PLAN & PROFILE STA. 40+00 TO STA. 45+00	SHEET NO.  32
DATE	DESCRIPTION	DATE	DESCRIPTION		ROAD NO.	COUNTY PROJECT NO.		
					BELL BLVD. SR 82 TO SUNRISE BLVD. SIDEWALK	6002		

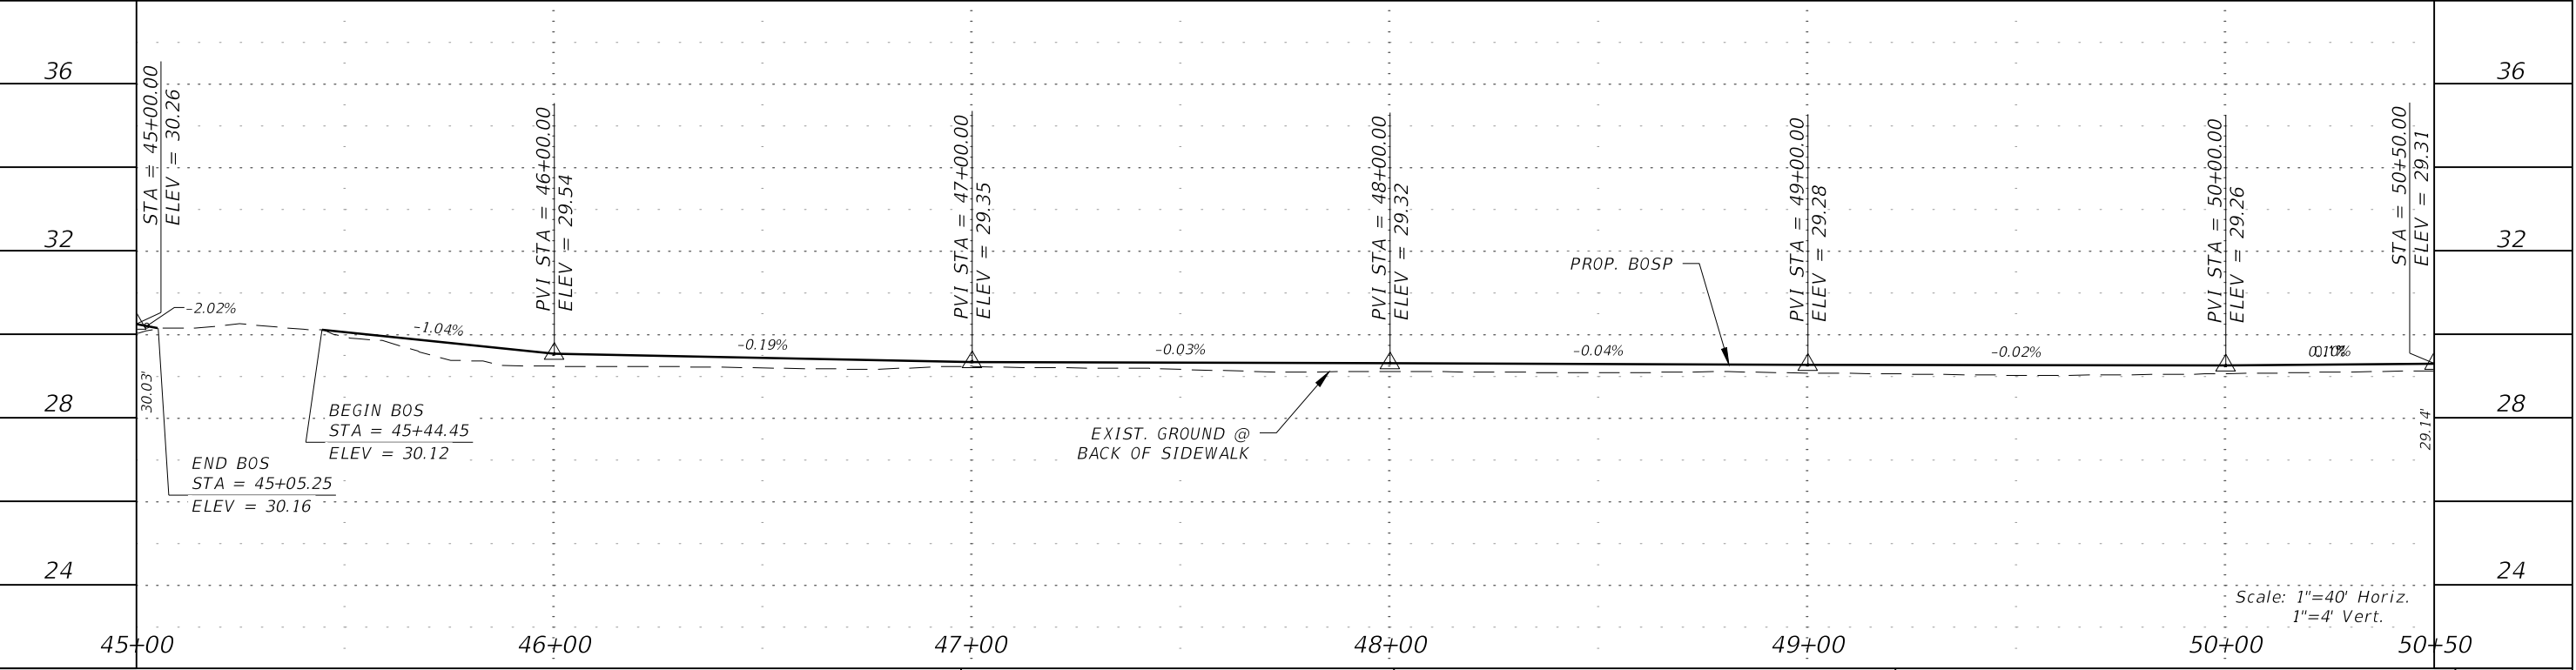
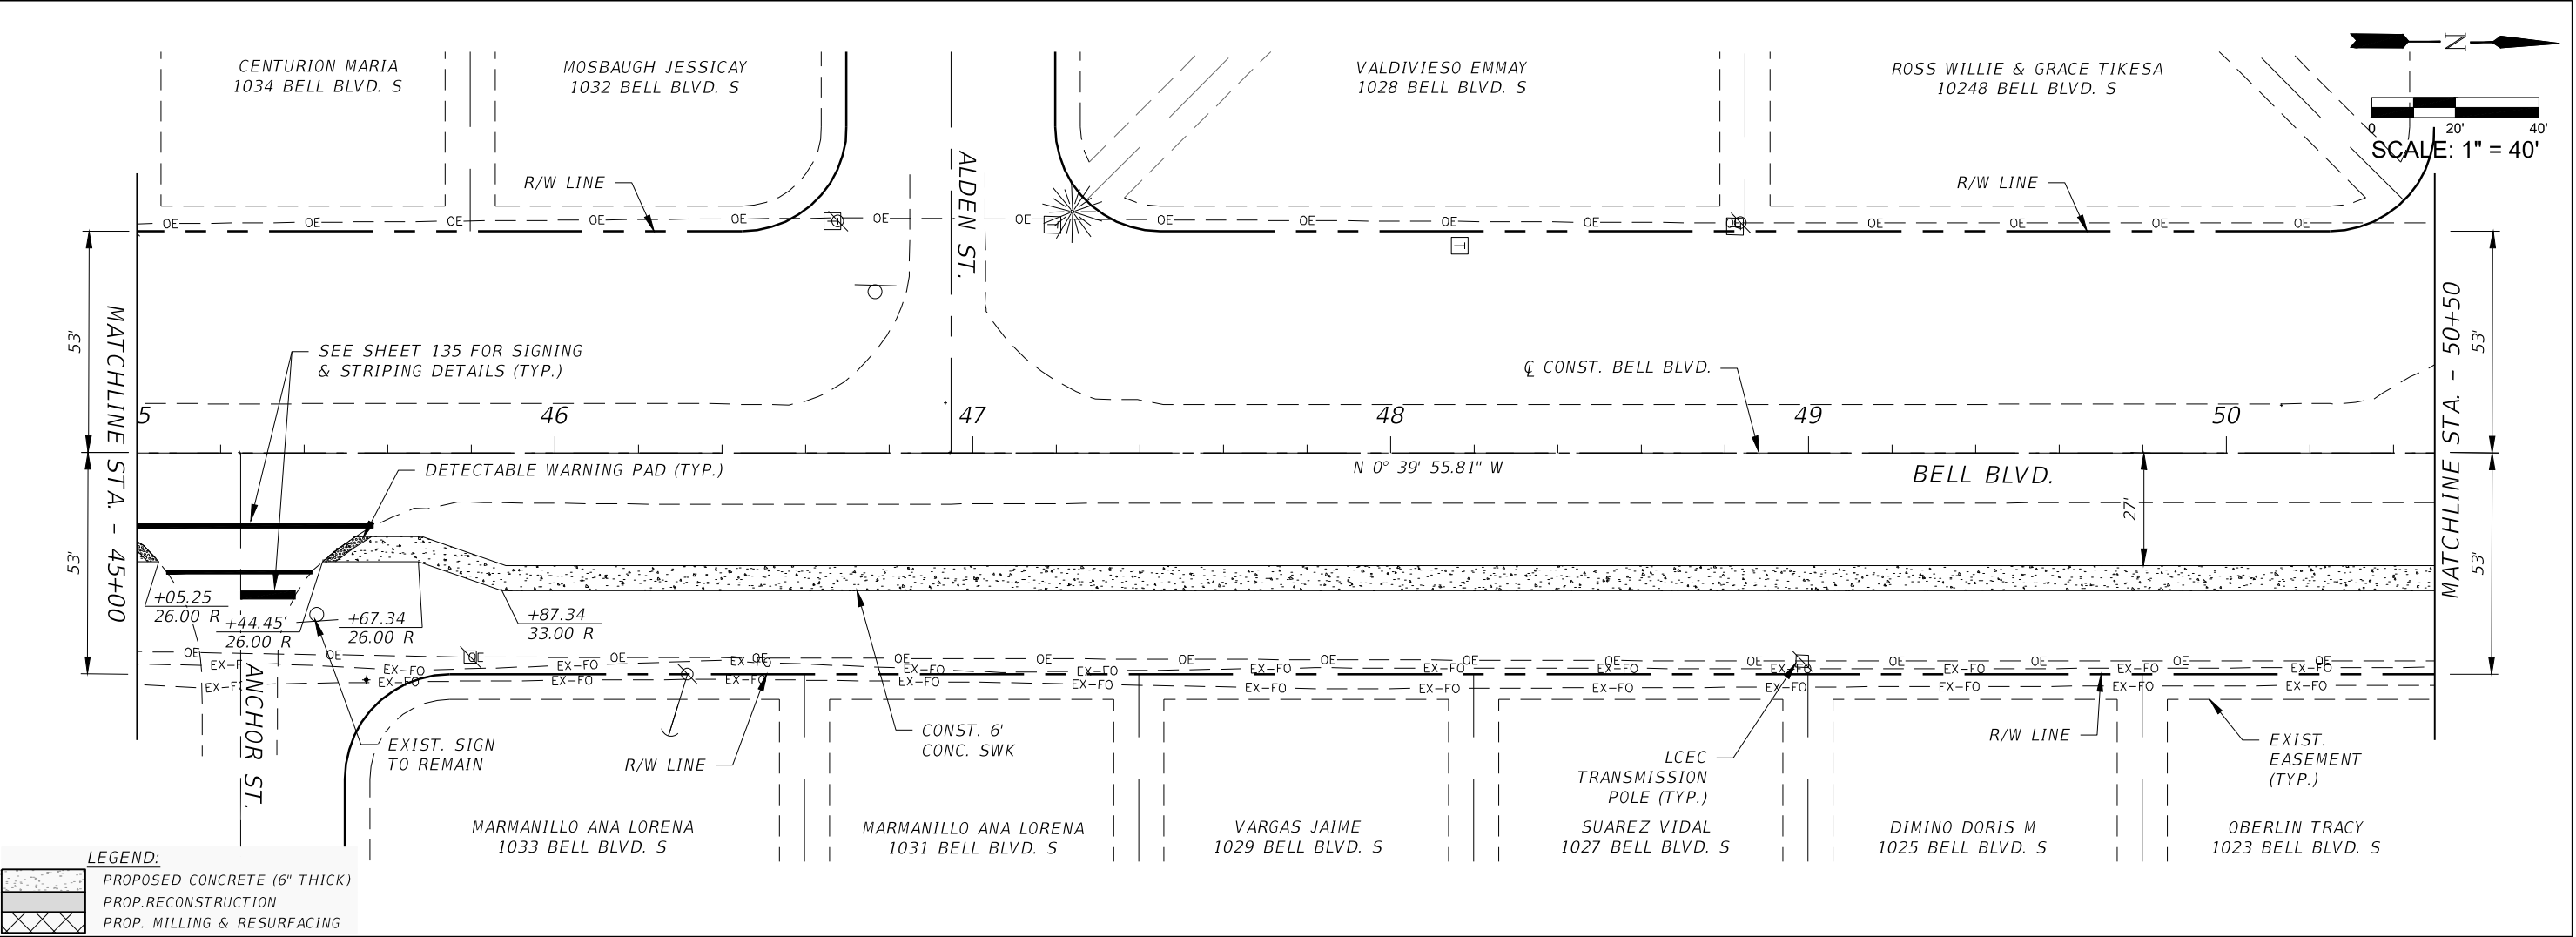


REVISIONS				<div><div></div><div>Q. Grady Minor and Associates, P.A. 3800 Via Del Rey Bonita Springs, Florida 34134 Phone: 239.947.1144 R. DANIEL FLYNN, P.E. NO. 76205</div></div> <div>GradyMinor Civil Engineers • Land Surveyors • Planners • Landscape Architects <small>CERT. OF AUTH. EB 0005151    CERT. OF AUTH. LB 0005151    BUSINESS LC 26000266</small></div>	LEE COUNTY		ROADWAY PLAN & PROFILE STA. 45+00 TO STA. 50+50	SHEET NO.
DATE	DESCRIPTION	DATE	DESCRIPTION		ROAD NO.	COUNTY PROJECT NO.		33
					BELL BLVD. SR 82 TO SUNRISE BLVD. SIDEWALK	6002		



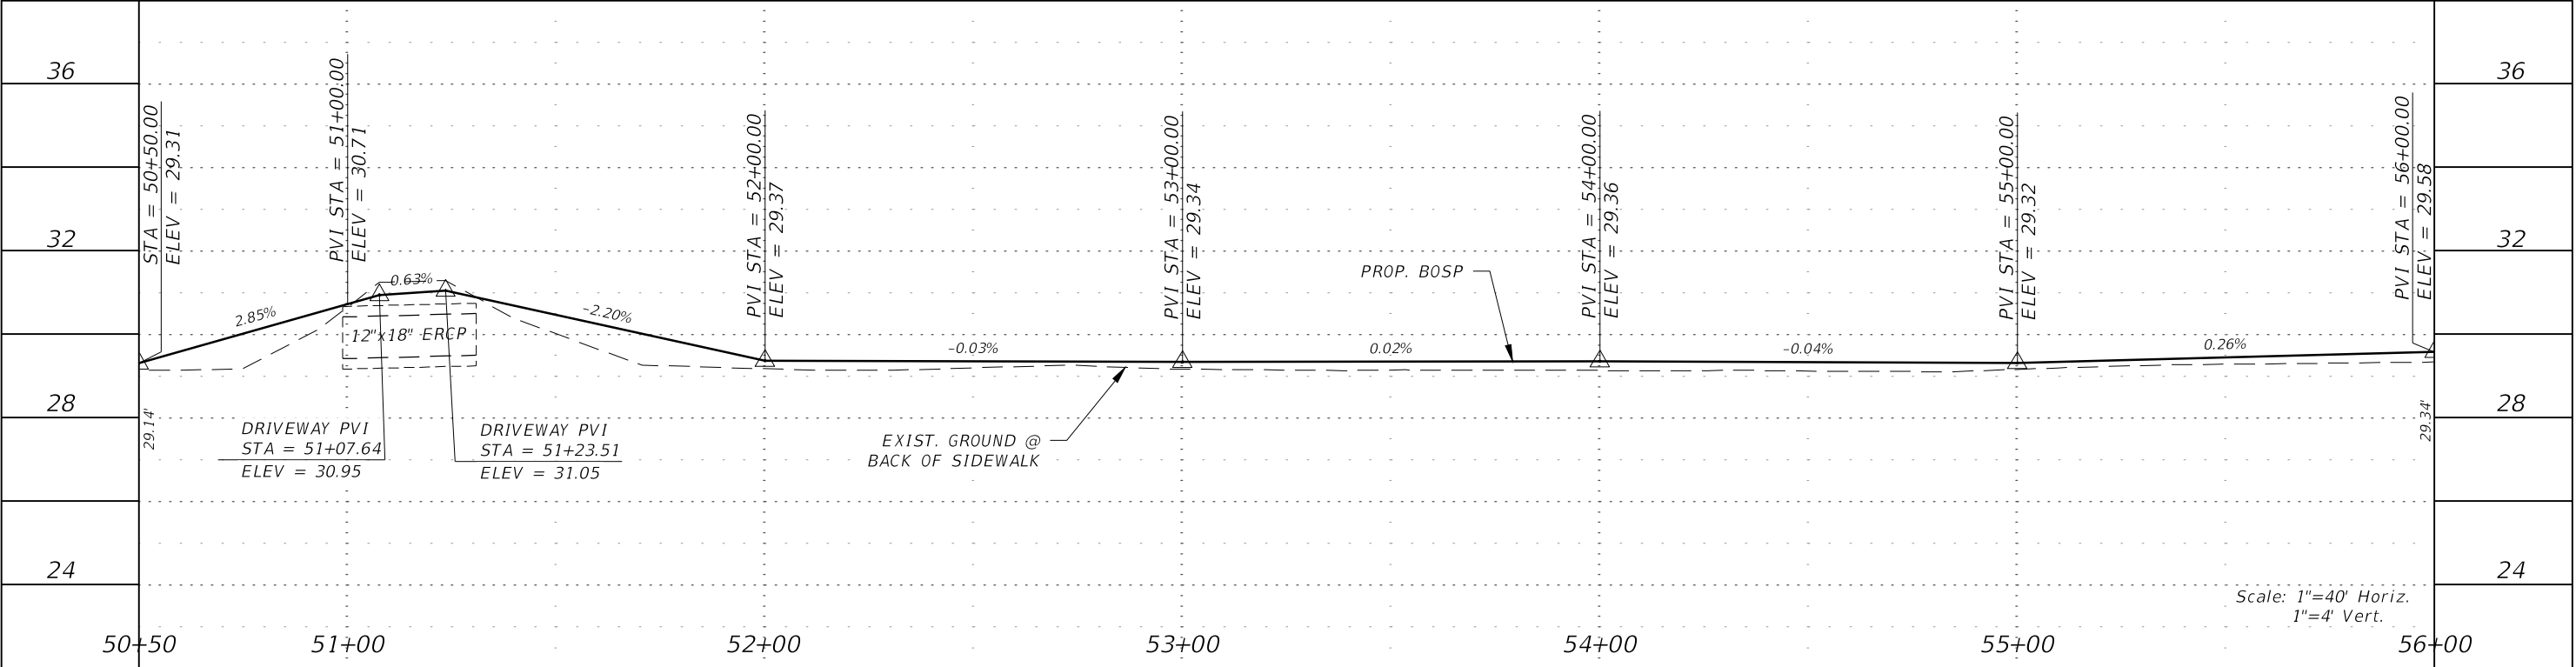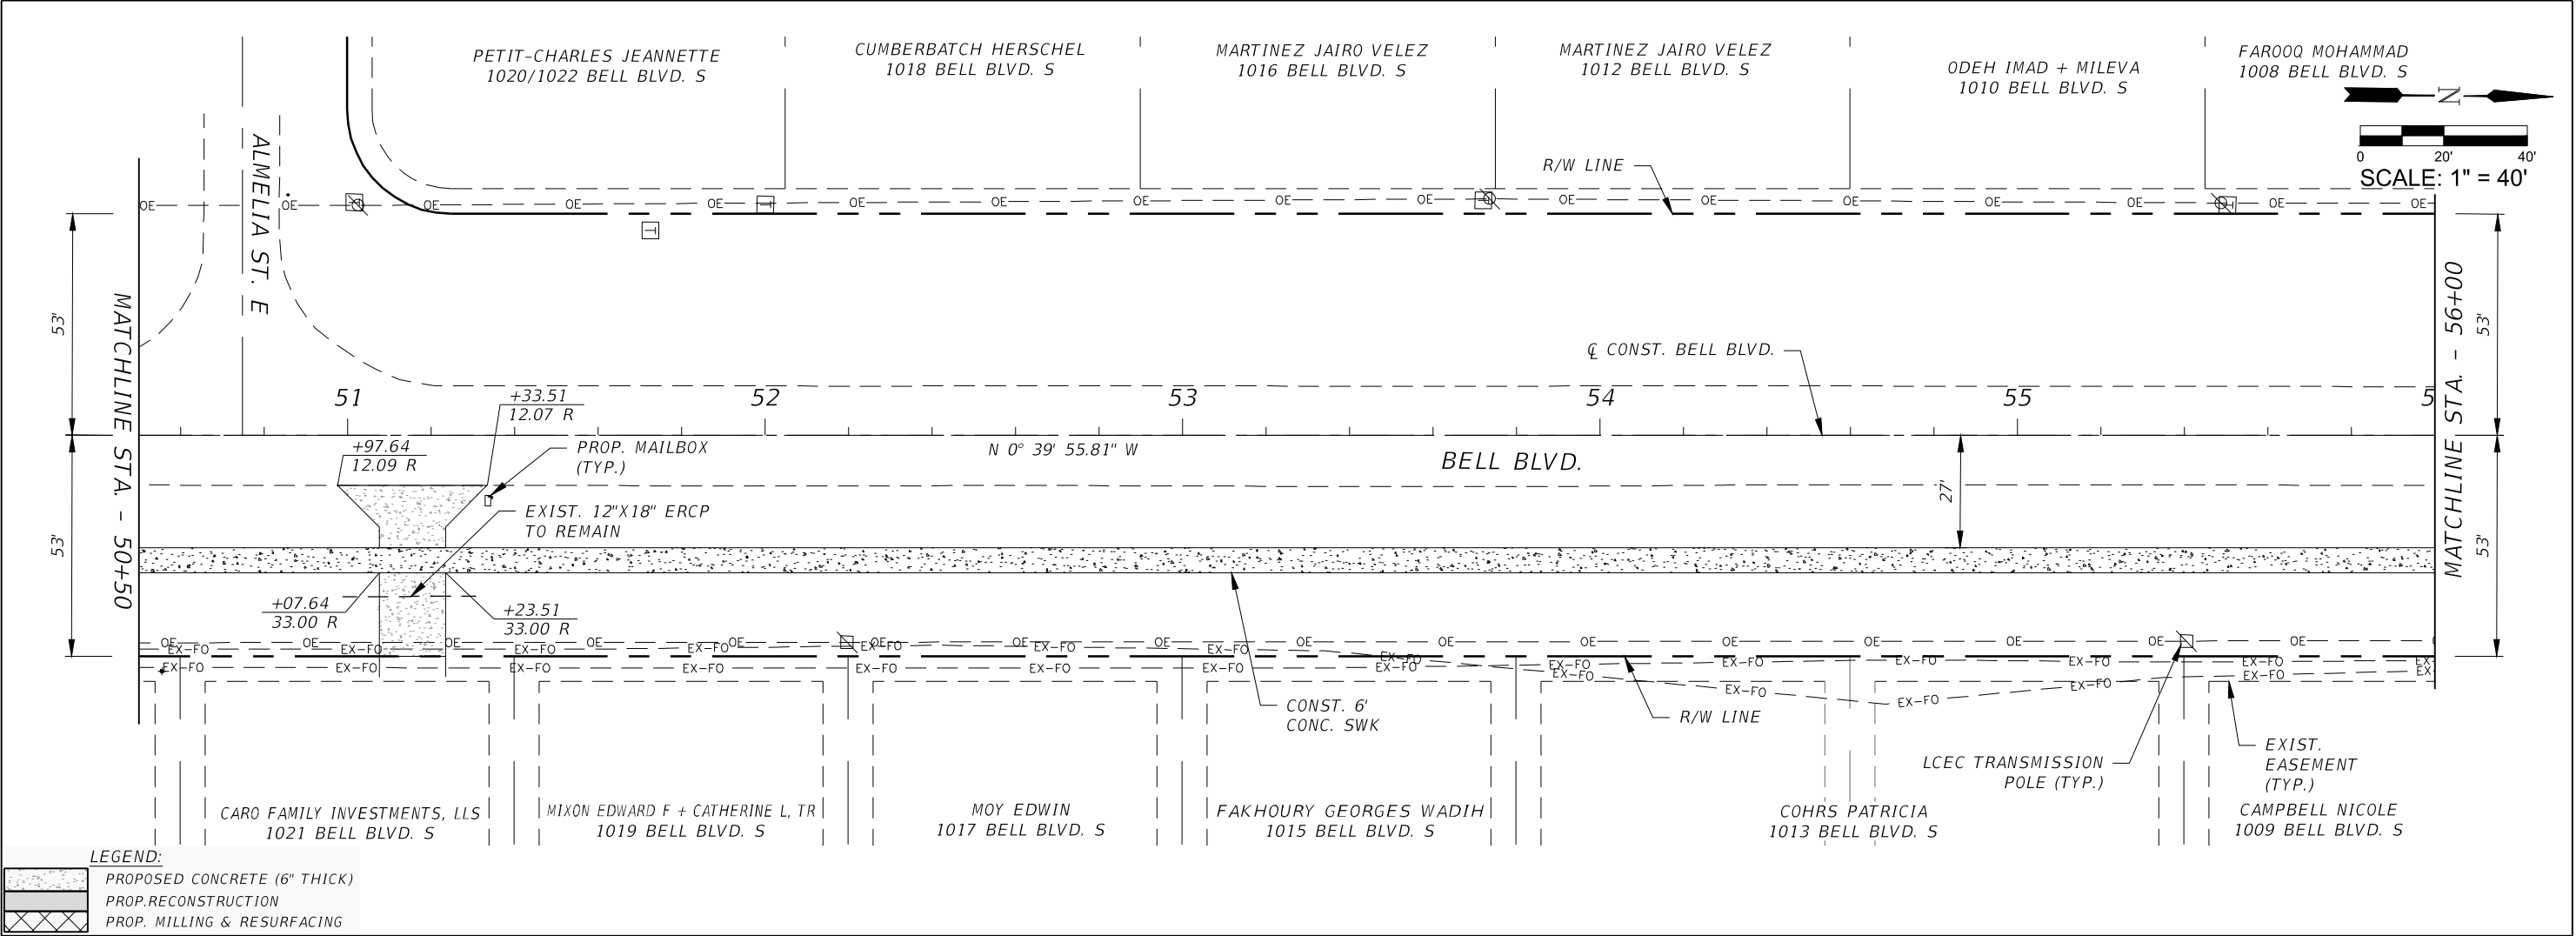


REVISIONS				<div><div></div><div>Q. Grady Minor and Associates, P.A. 3800 Via Del Rey Bonita Springs, Florida 34134 Phone: 239.947.1144 R. DANIEL FLYNN, P.E. NO. 76205</div></div> <div>Civil Engineers • Land Surveyors • Planners • Landscape Architects <small>CERT. OF AUTH. EB 0005151 CERT. OF AUTH. LB 0005151 BUSINESS LC 26000266</small></div>
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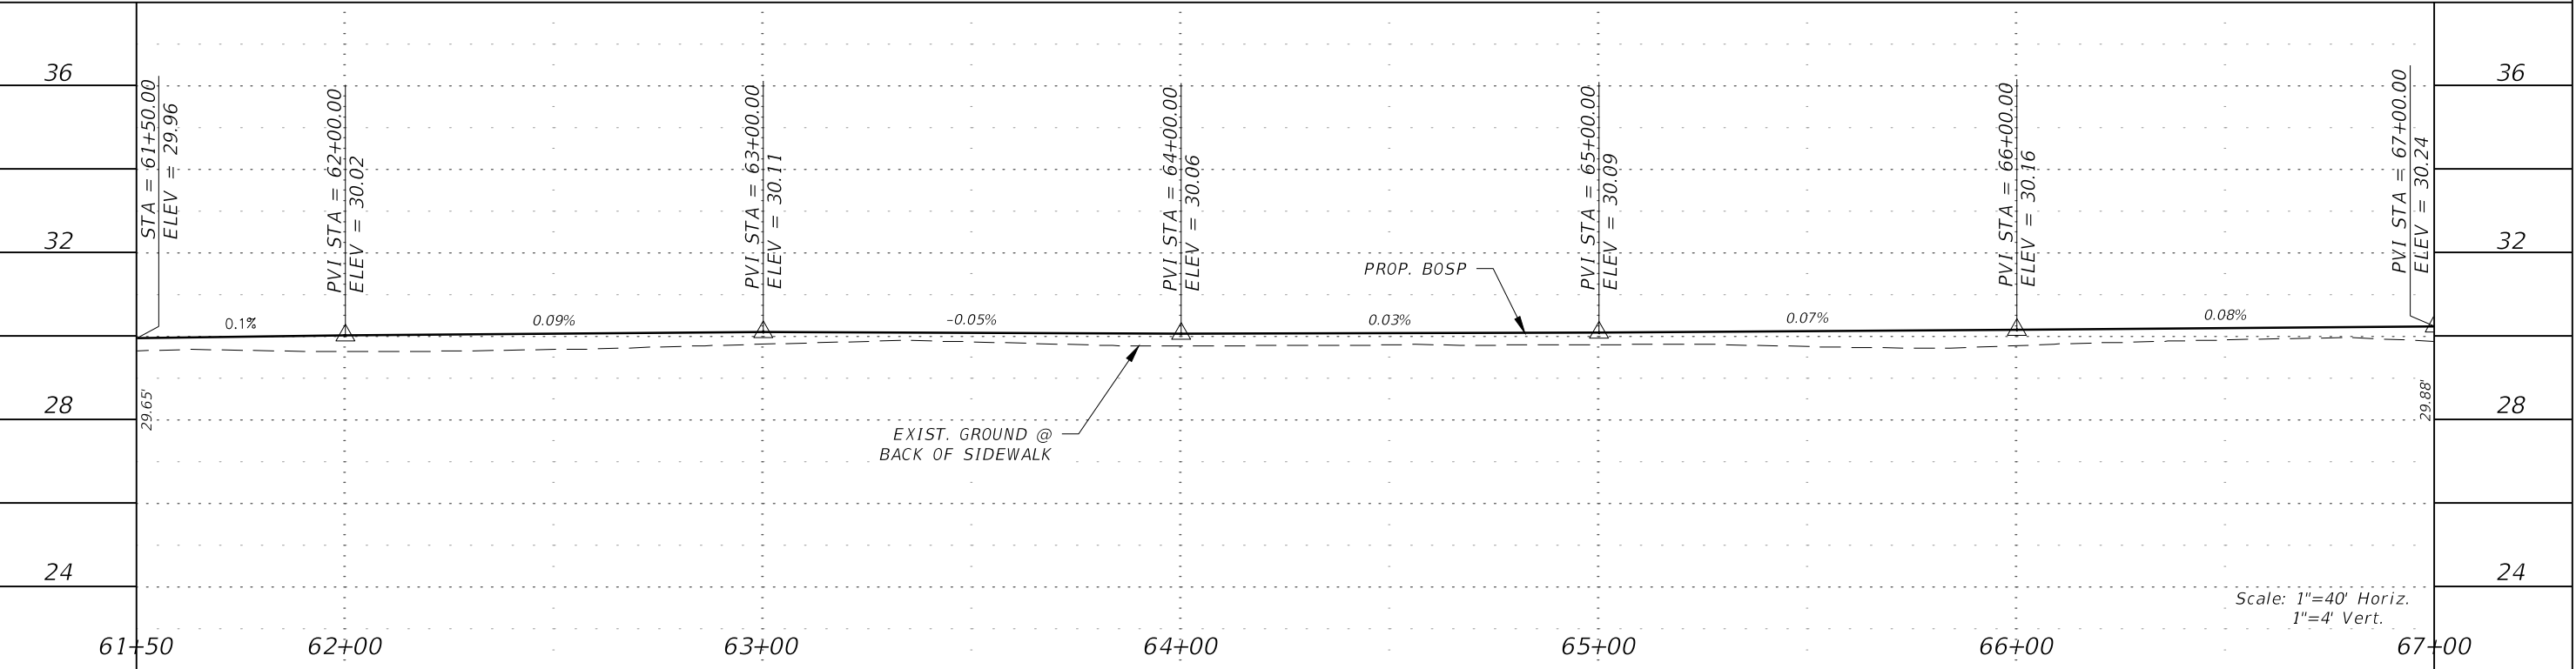

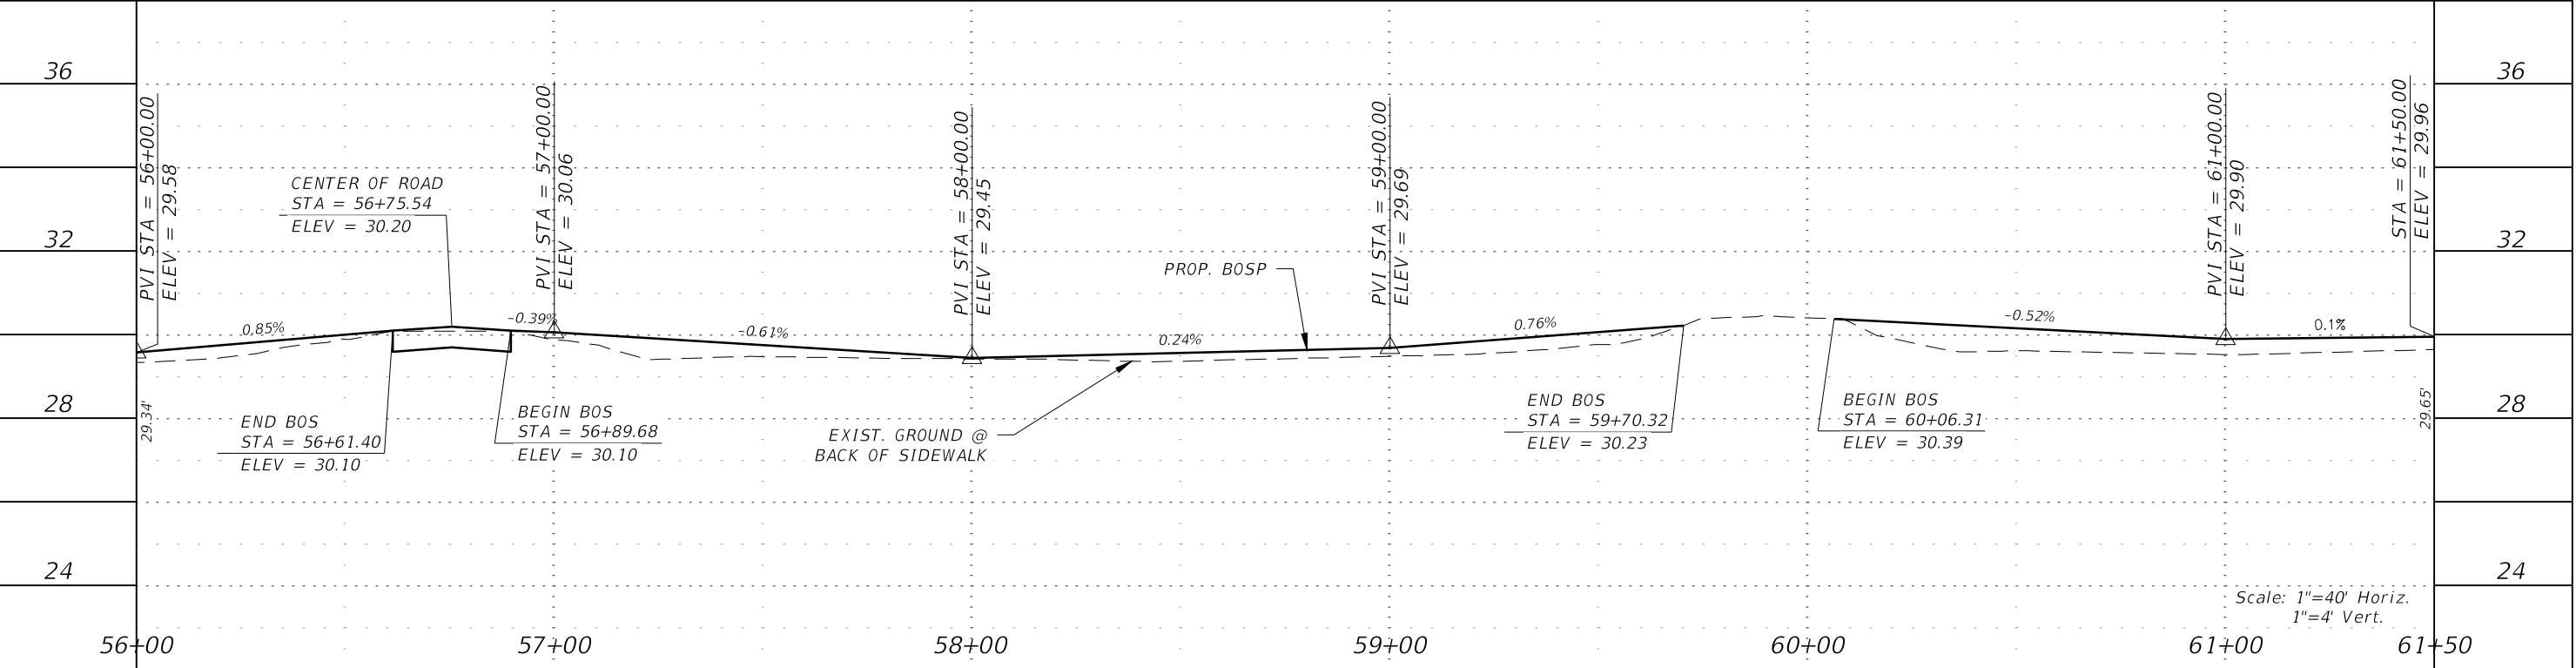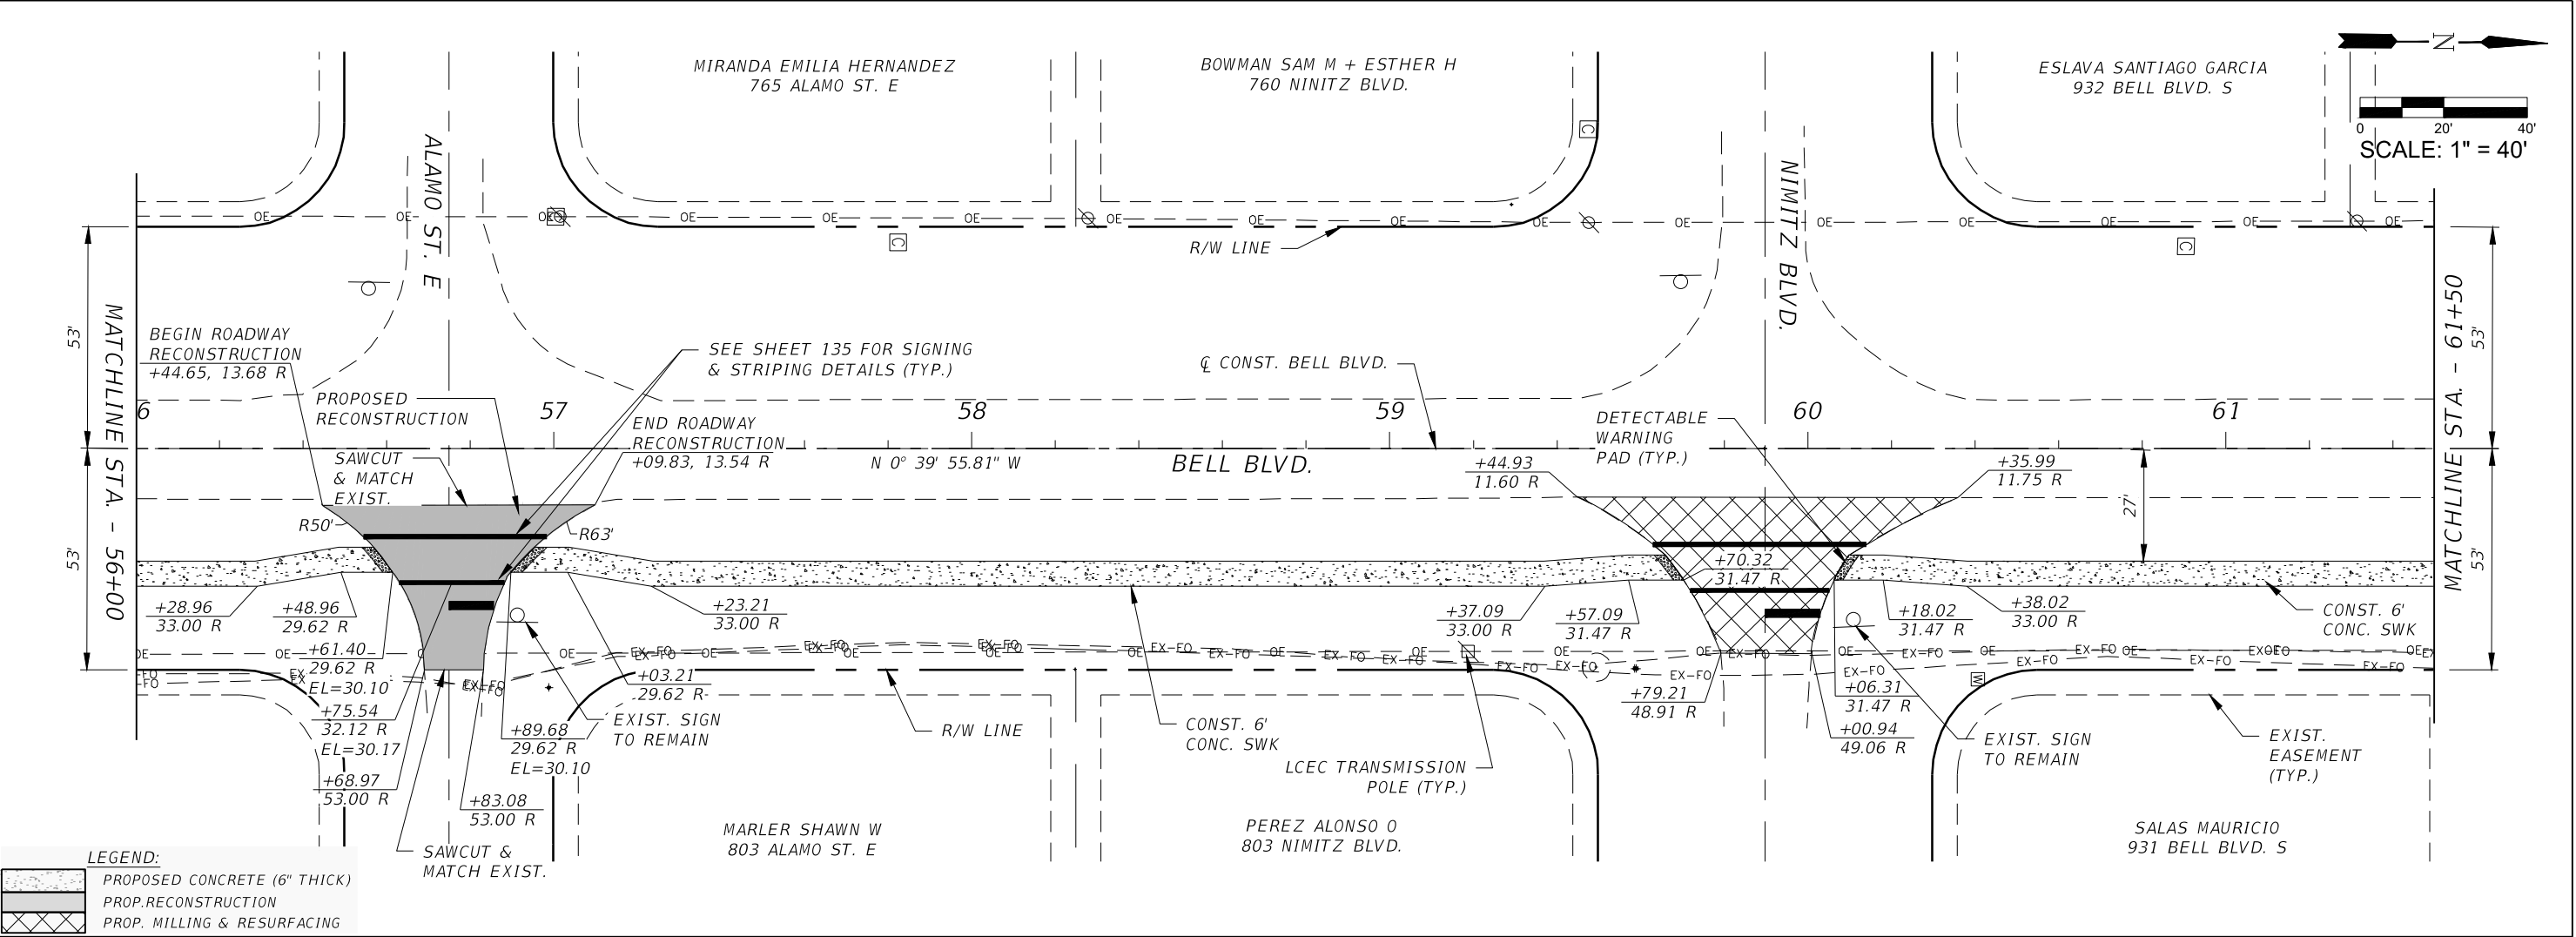
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DATE	DESCRIPTION	DATE	DESCRIPTION		ROAD NO.	COUNTY PROJECT NO.		
					BELL BLVD. SR 82 TO SUNRISE BLVD. SIDEWALK	6002		35





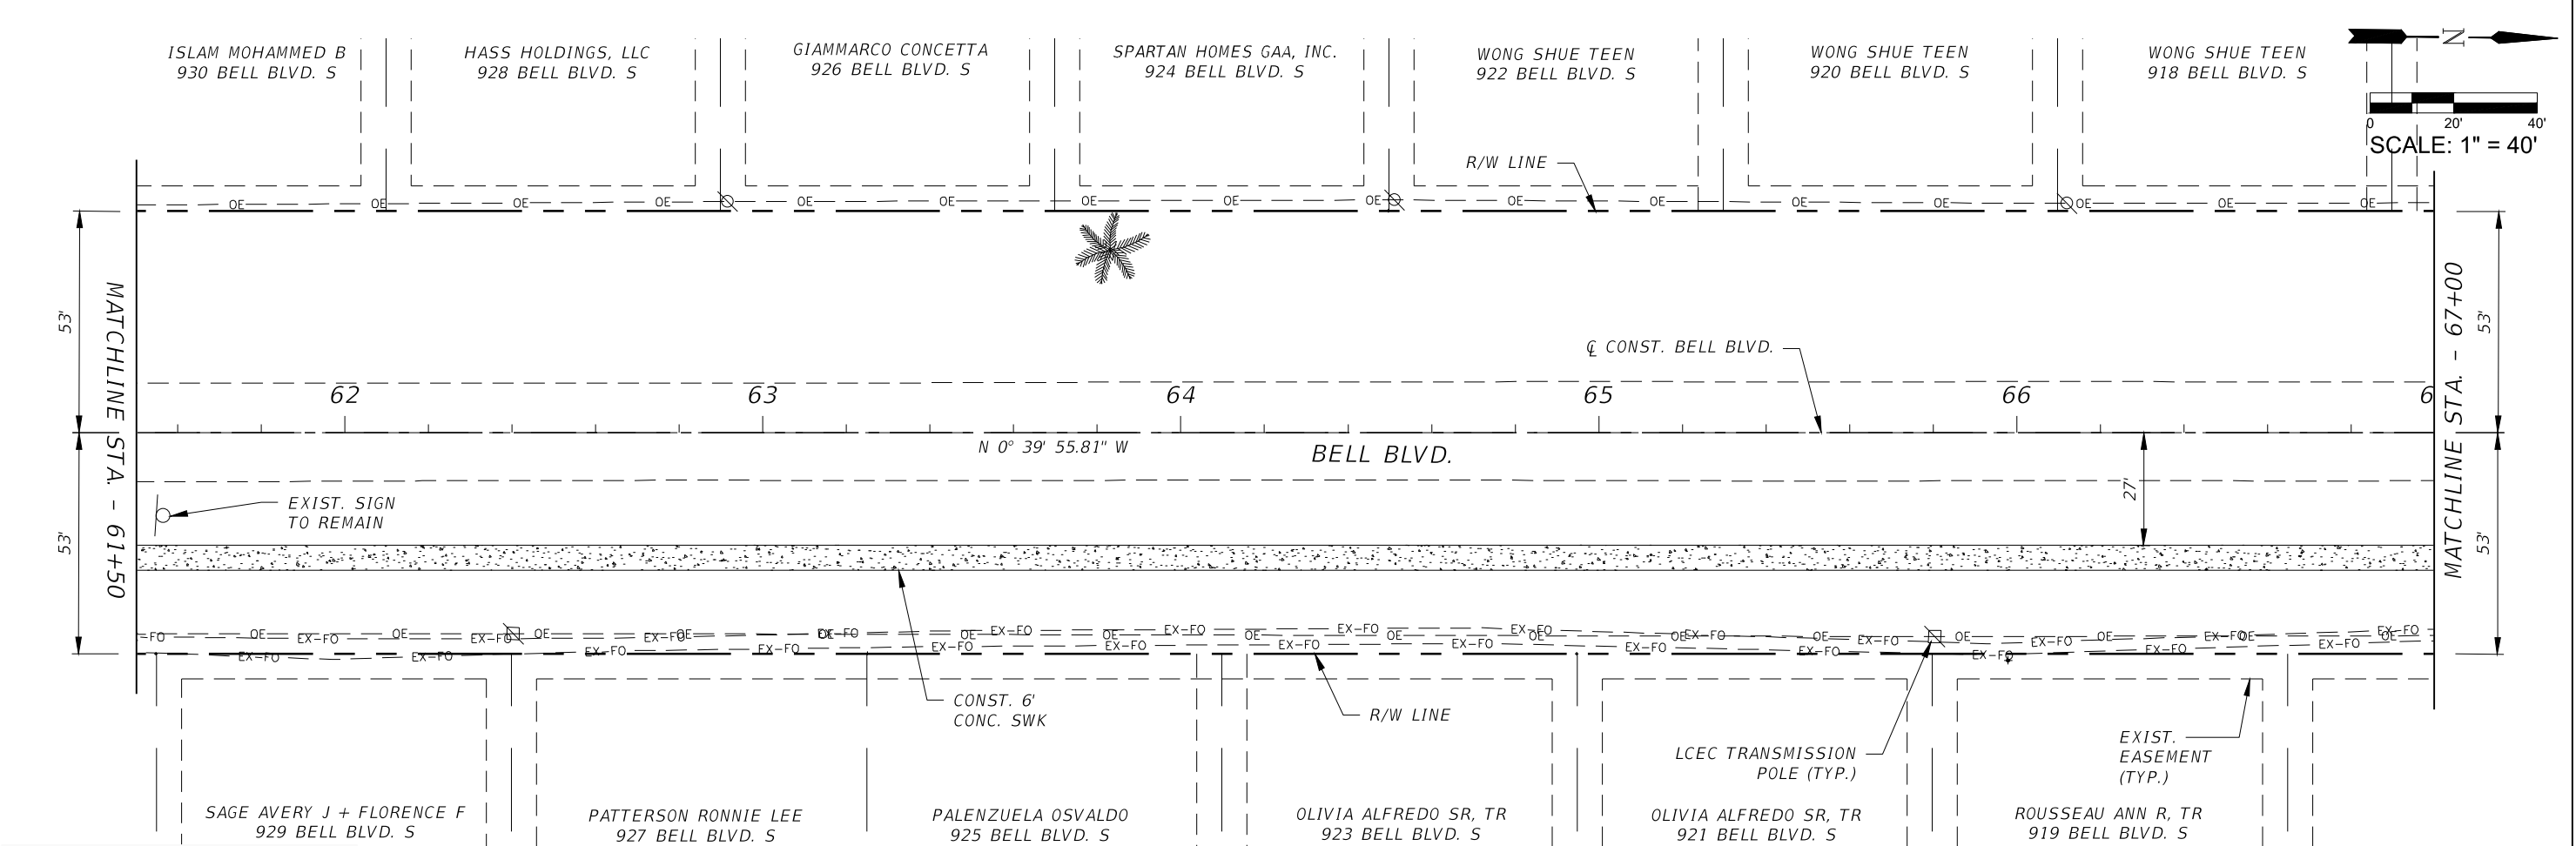

LEGEND:	
	PROPOSED CONCRETE (6" THICK)
	PROP. RECONSTRUCTION
	PROP. MILLING & RESURFACING





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DATE	DESCRIPTION	DATE	DESCRIPTION		ROAD NO.	COUNTY PROJECT NO.		
					BELL BLVD. SR 82 TO SUNRISE BLVD. SIDEWALK	6002		

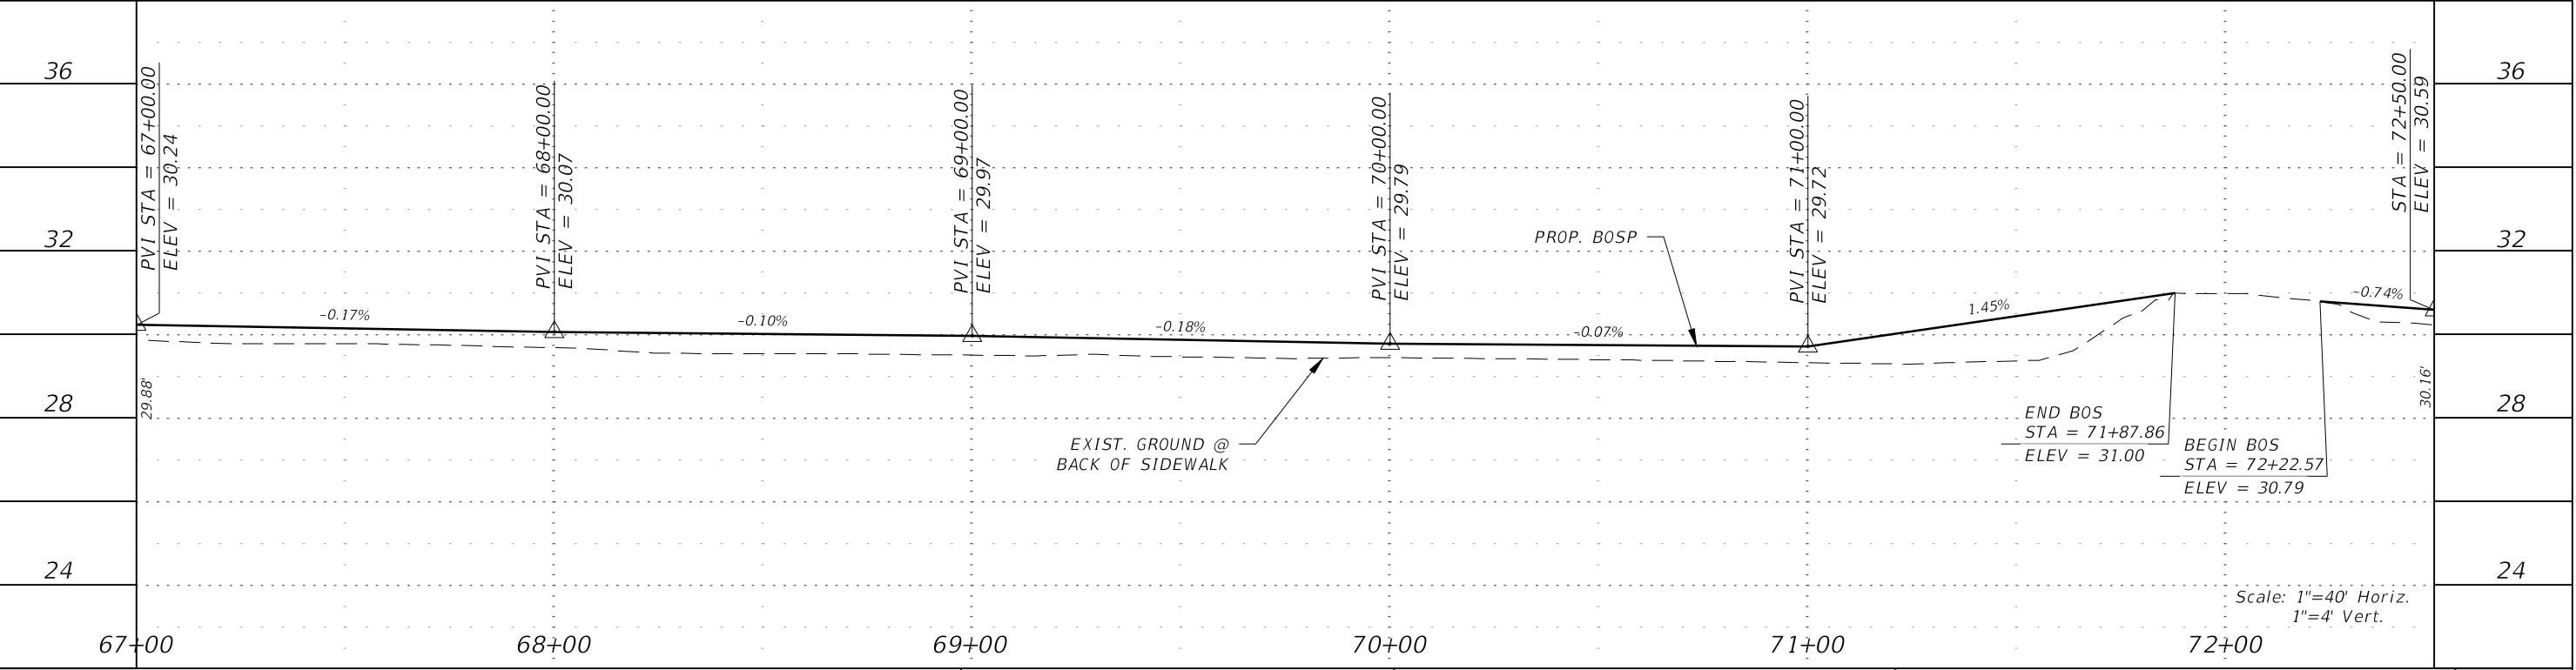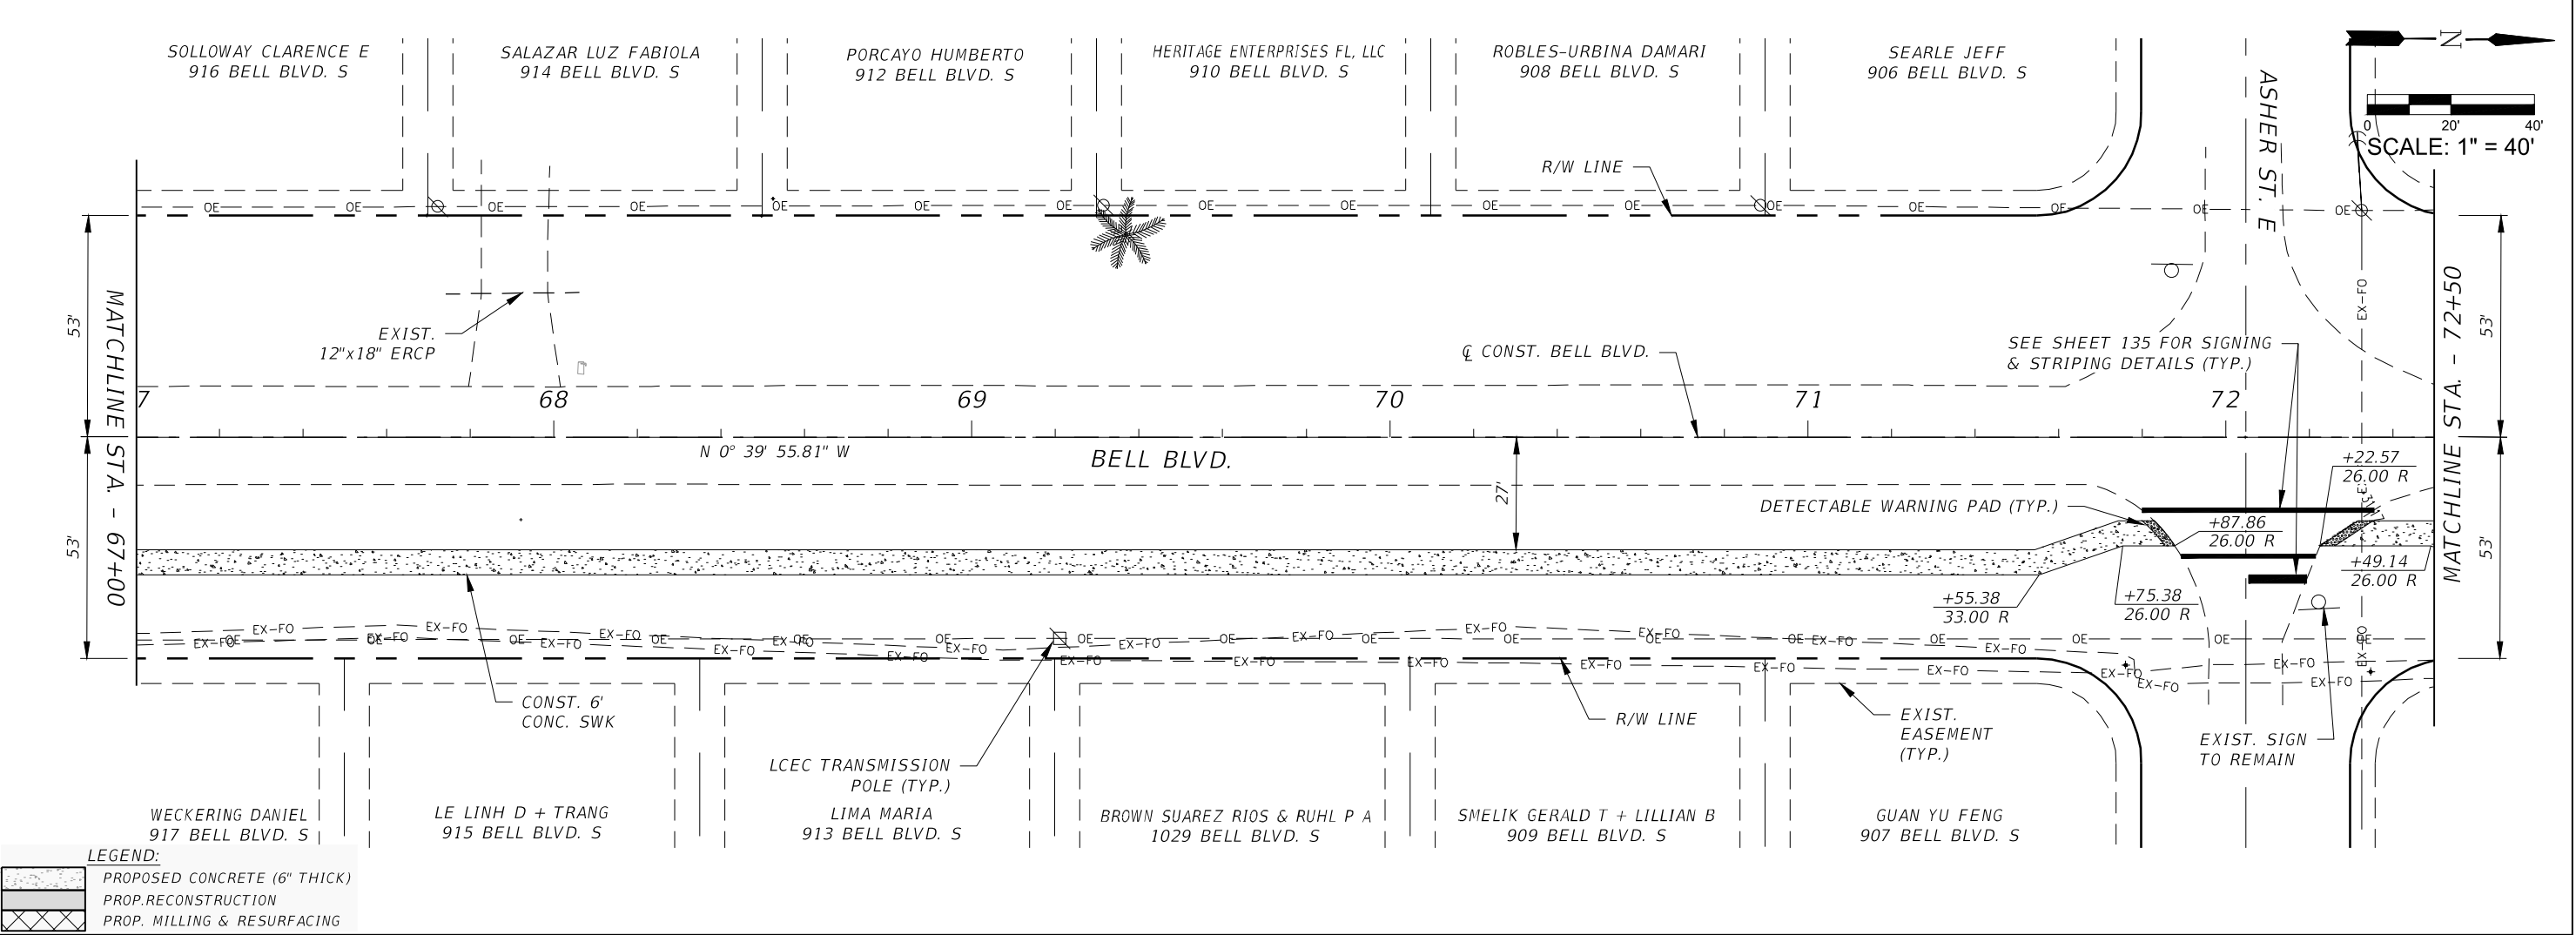


REVISIONS				<div></div> <div>Q. Grady Minor and Associates, P.A. 3800 Via Del Rey Bonita Springs, Florida 34134 Phone: 239.947.1144 R. DANIEL FLYNN, P.E. NO. 76205</div> <div>GradyMinor</div> <div>Civil Engineers • Land Surveyors • Planners • Landscape Architects <small>CERT. OF AUTH. EB 0005151    CERT. OF AUTH. LB 0005151    BUSINESS LIC. 26000266</small></div>	LEE COUNTY		ROADWAY PLAN & PROFILE STA. 67+00 TO STA. 72+50	SHEET NO.
DATE	DESCRIPTION	DATE	DESCRIPTION		ROAD NO.	COUNTY PROJECT NO.		
					BELL BLVD. SR 82 TO SUNRISE BLVD. SIDEWALK	6002		



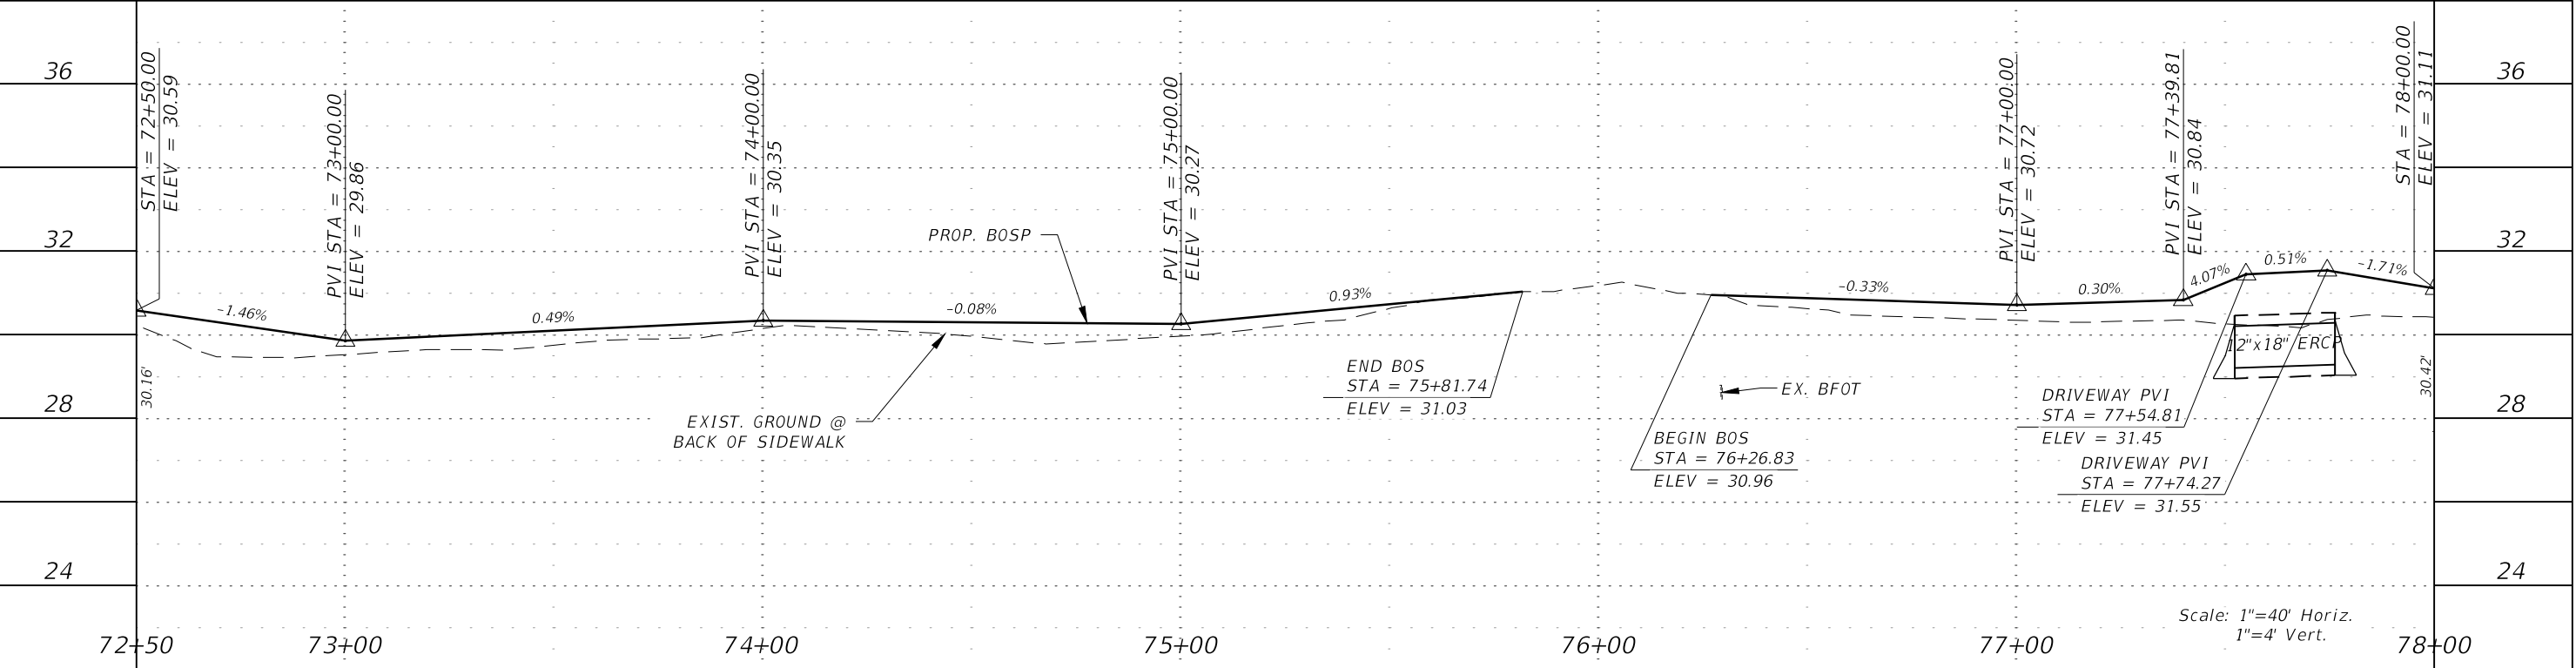
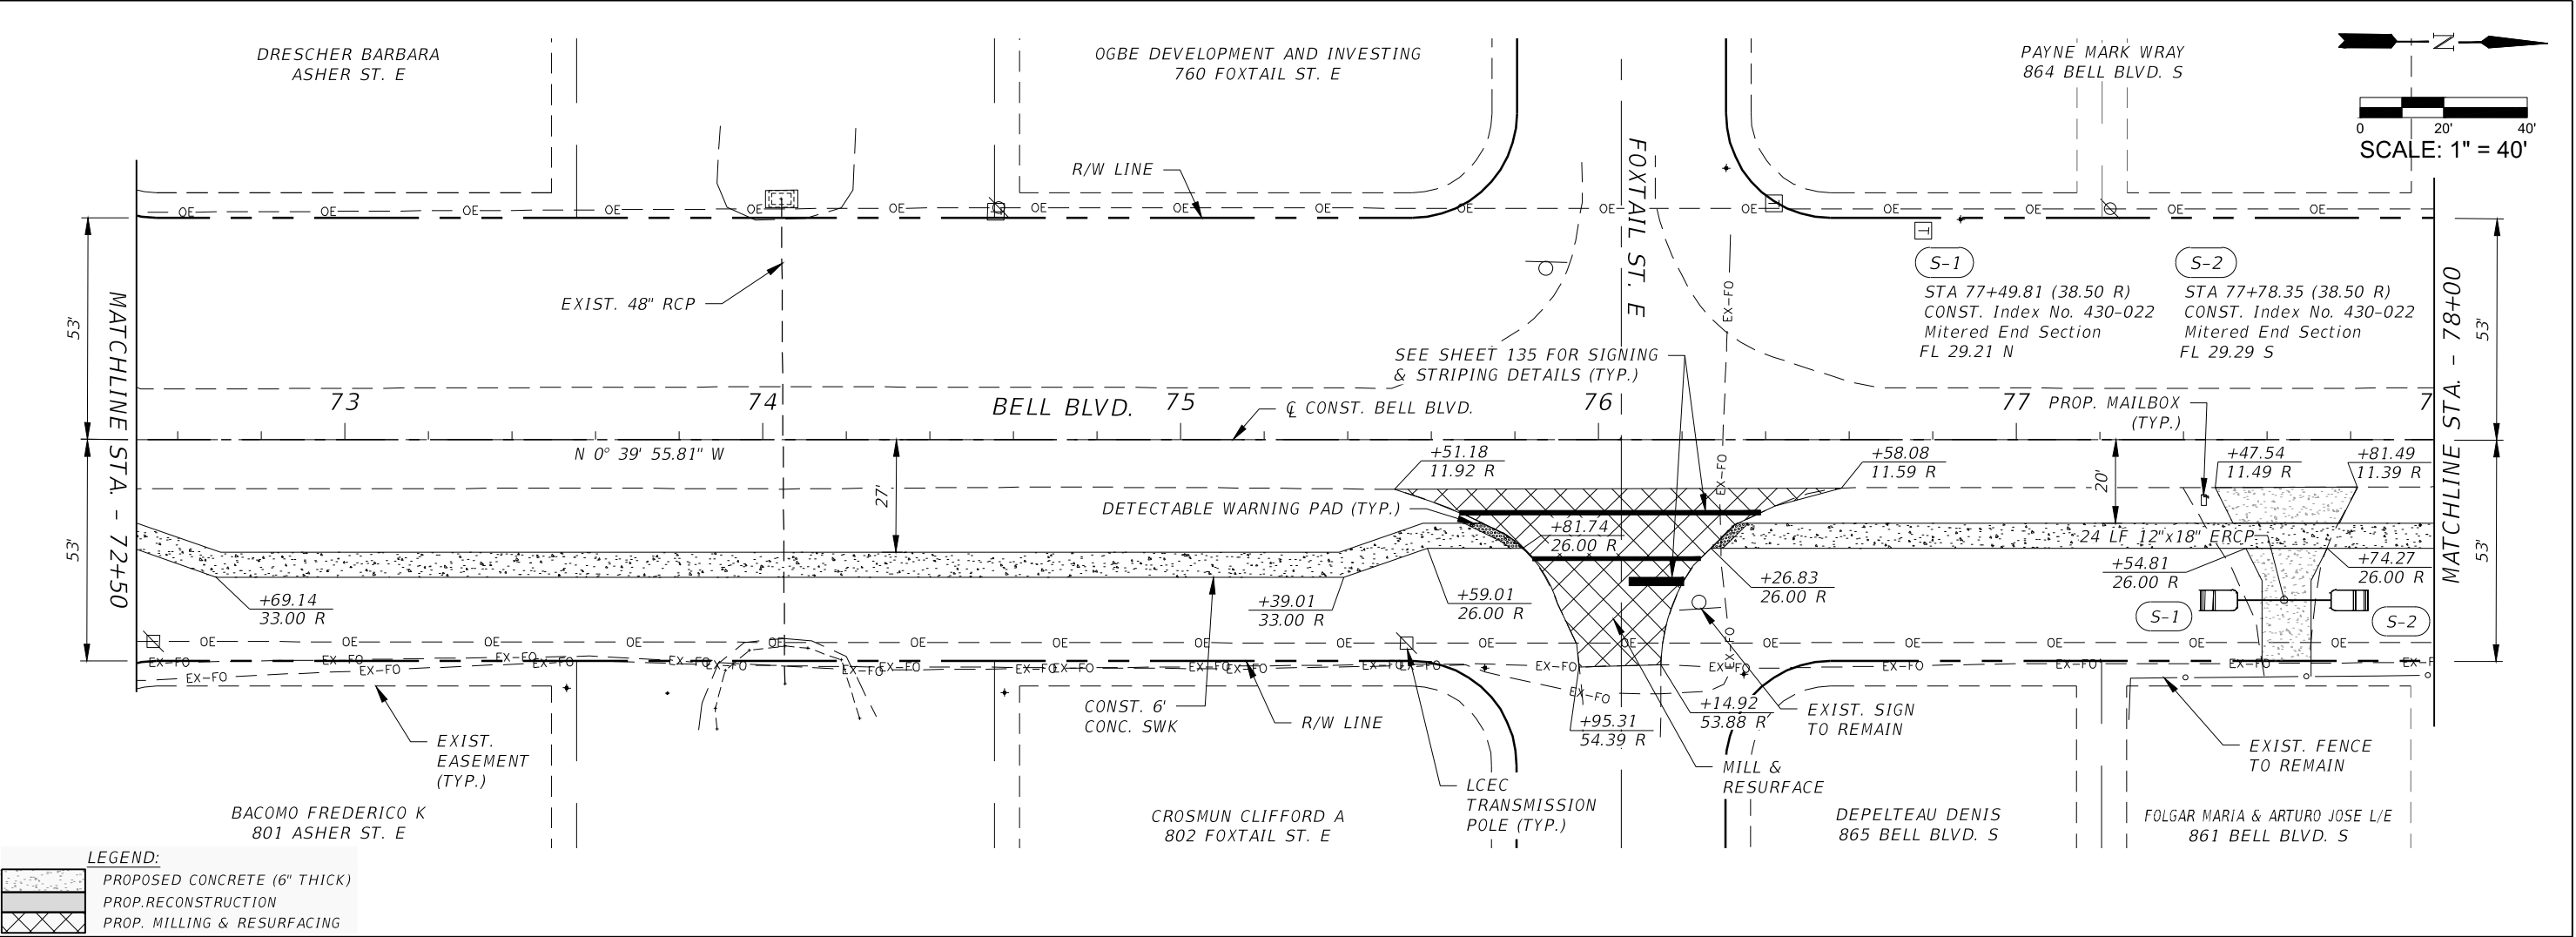


REVISIONS				<div><p>Q. Grady Minor and Associates, P.A. 3800 Via Del Rey Bonita Springs, Florida 34134 Phone: 239.947.1144 R. DANIEL FLYNN, P.E. NO. 76205</p><p><b>GradyMinor</b> Civil Engineers • Land Surveyors • Planners • Landscape Architects <small>Cert. of Auth. EB 0005151    Cert. of Auth. LB 0005151    Business Lic. 26000266</small></p></div>	LEE COUNTY		ROADWAY PLAN & PROFILE STA. 72+50 TO STA. 78+00	SHEET NO.
DATE	DESCRIPTION	DATE	DESCRIPTION		ROAD NO.	COUNTY PROJECT NO.		38
					BELL BLVD. SR 82 TO SUNRISE BLVD. SIDEWALK	6002		


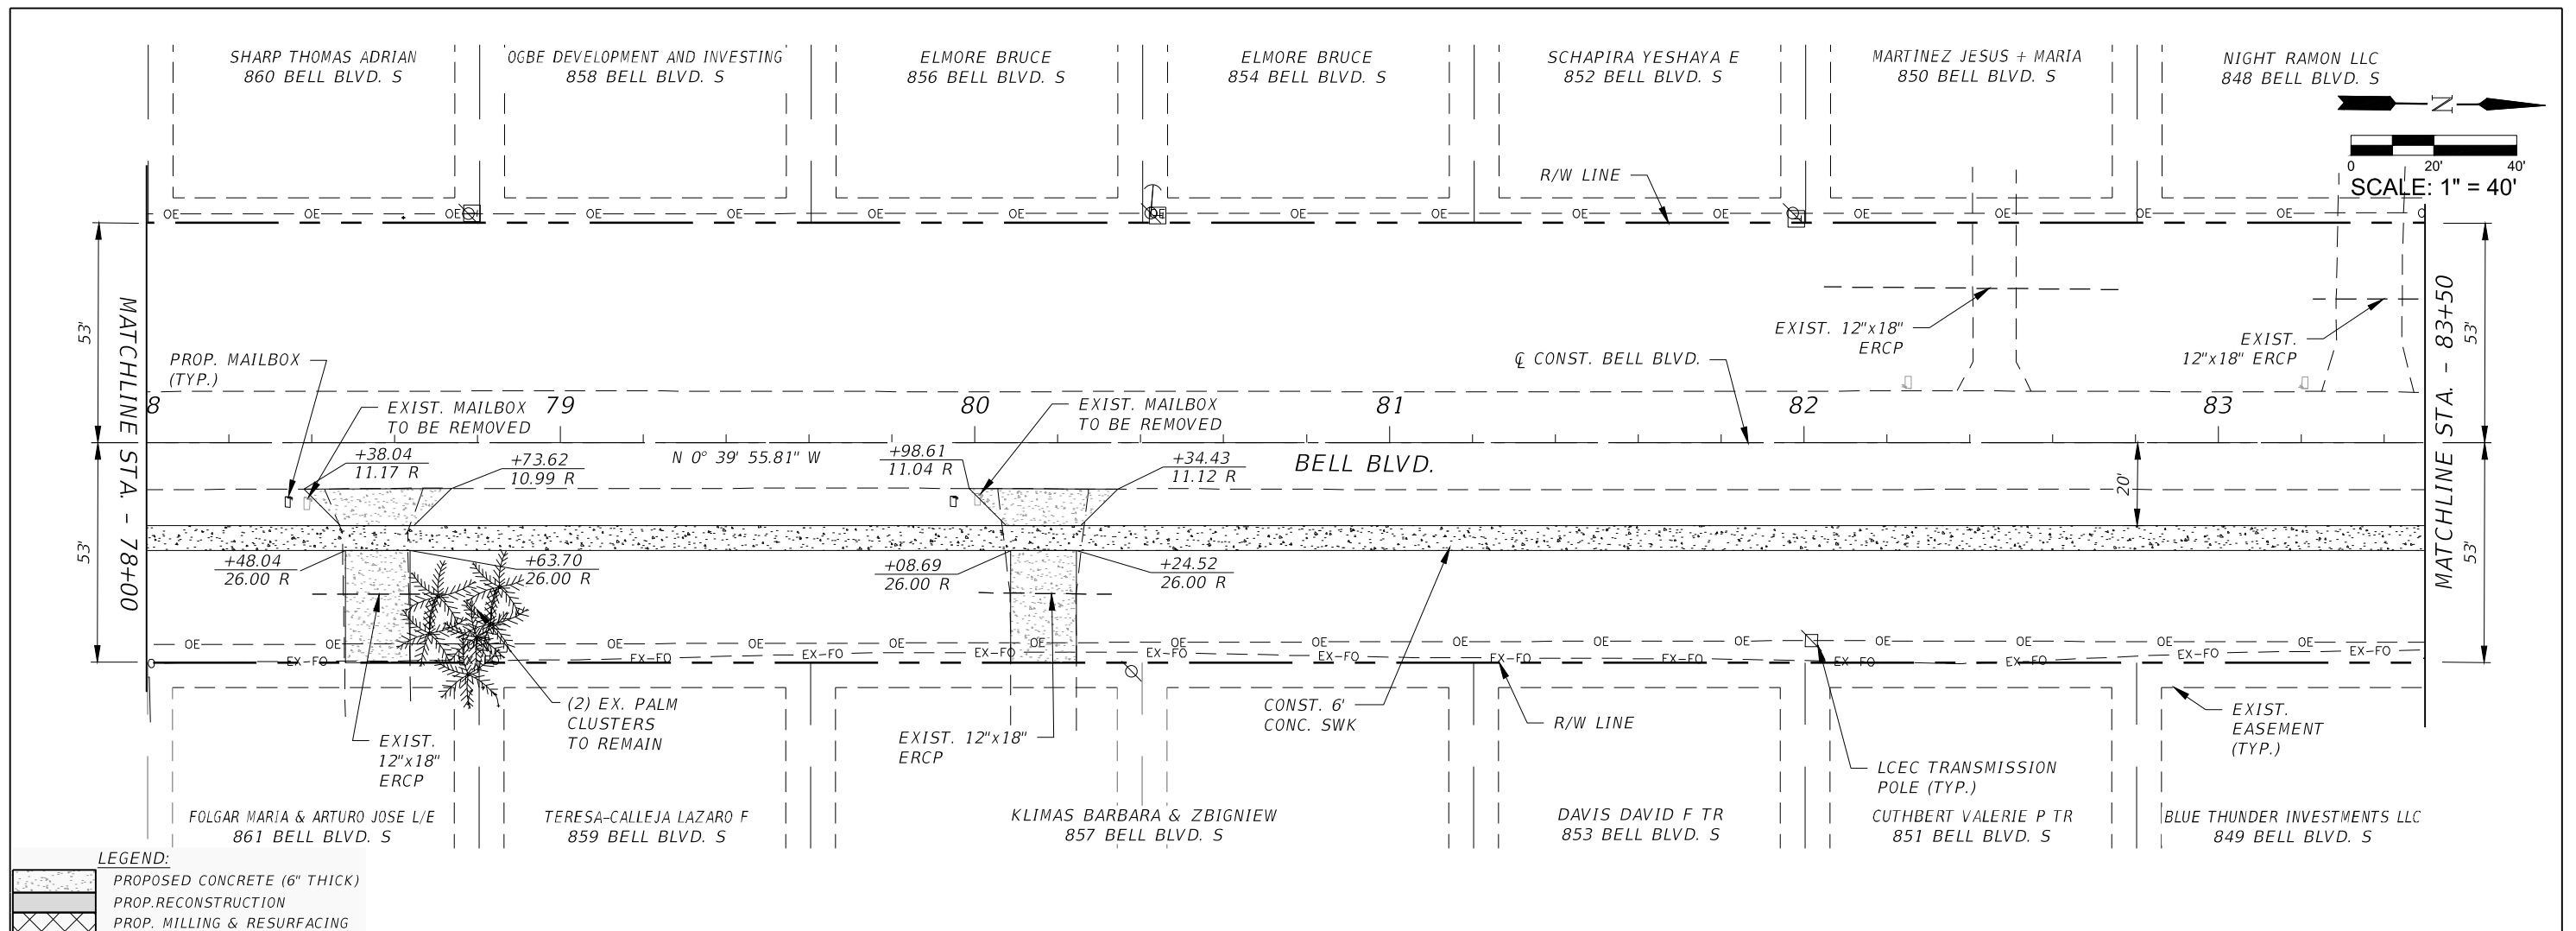


<div style="text-align: center;"> <b>REVISIONS</b> </div>				<div style="text-align: center;">  <p> <b>GradyMinor</b>  <small>Civil Engineers • Land Surveyors • Planners • Landscape Architects</small>  <small>Cert. of Auth. EB 0005151      Cert. of Auth. LB 0005151</small> </p> </div>	<div style="text-align: center;"> <b>LEE COUNTY</b> </div>		<div style="text-align: center;"> <b>ROADWAY PLAN &amp; PROFILE</b>  <b>STA. 78+00 TO STA. 83+50</b> </div>	<div style="text-align: center;"> <b>SHEET NO.</b>   <b>39</b> </div>
<div style="display: flex;"> <div style="flex: 1;"> <div style="text-align: center;"> <b>DATE</b> </div> <div style="text-align: center;"> <b>DESCRIPTION</b> </div> </div> </div>		<div style="display: flex;"> <div style="flex: 1;"> <div style="text-align: center;"> <b>DATE</b> </div> <div style="text-align: center;"> <b>DESCRIPTION</b> </div> </div> </div>			<div style="text-align: center;"> <b>ROAD NO.</b> </div>	<div style="text-align: center;"> <b>COUNTY PROJECT NO.</b> </div>		
					<div style="text-align: center;"> <b>BELL BLVD. SR 82 TO SUNRISE BLVD. SIDEWALK</b> </div>	<div style="text-align: center;"> <b>6002</b> </div>		



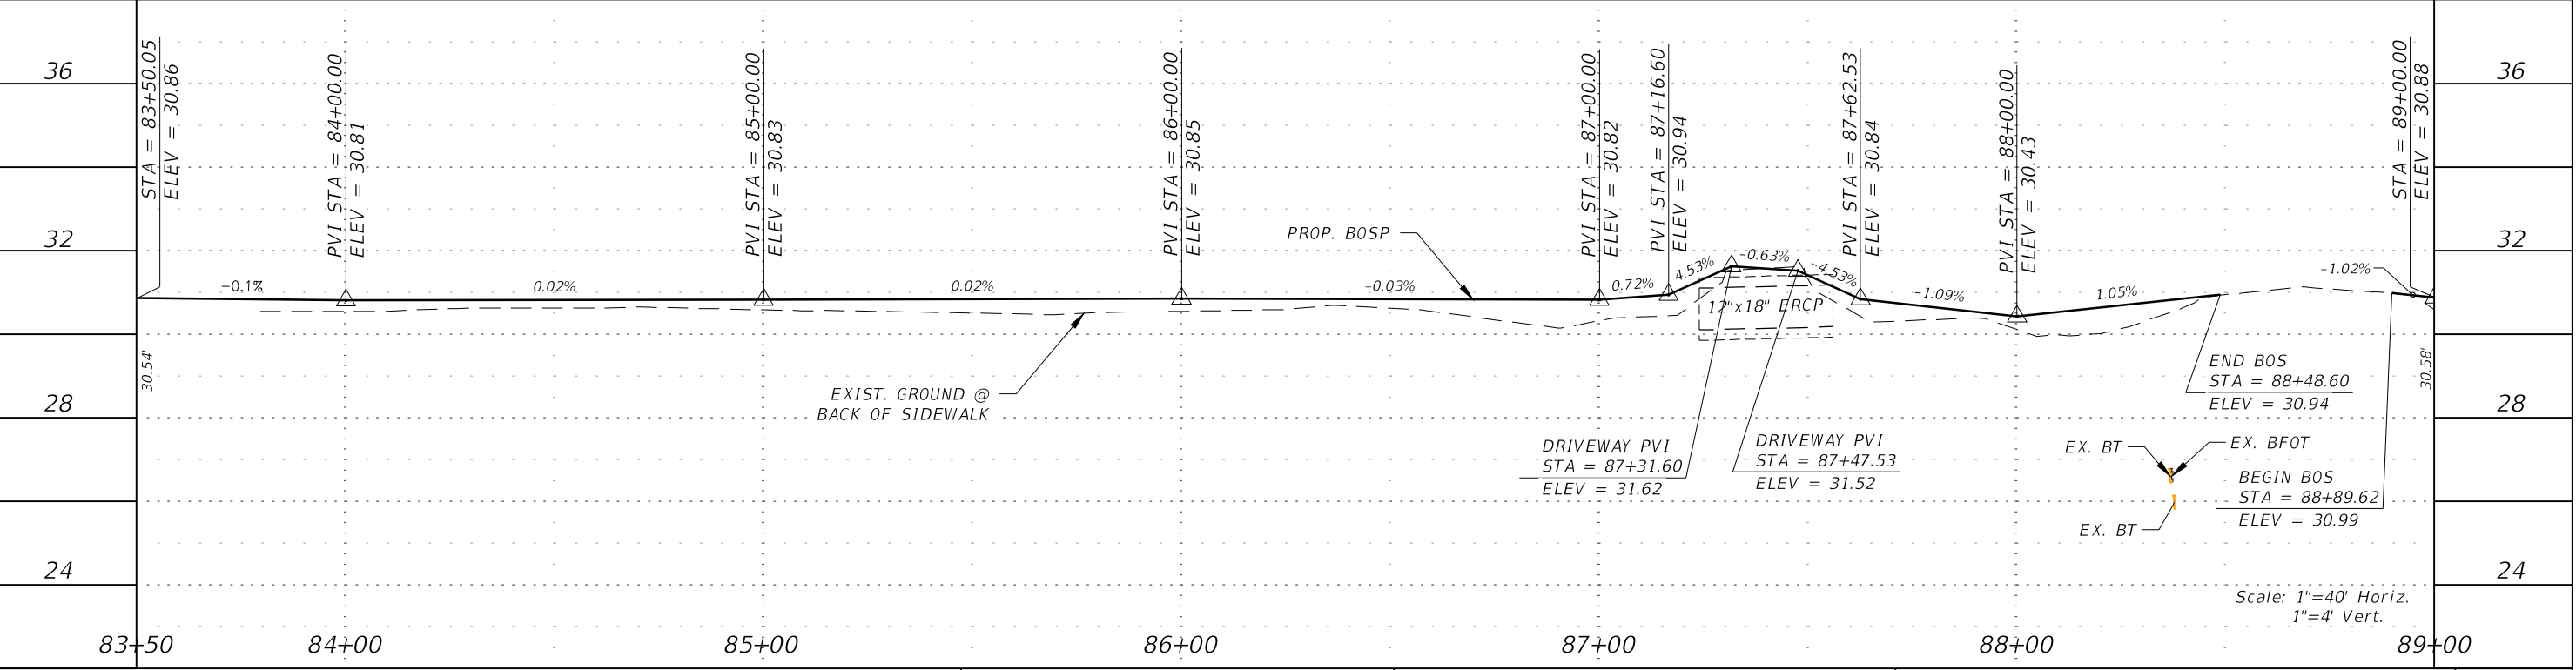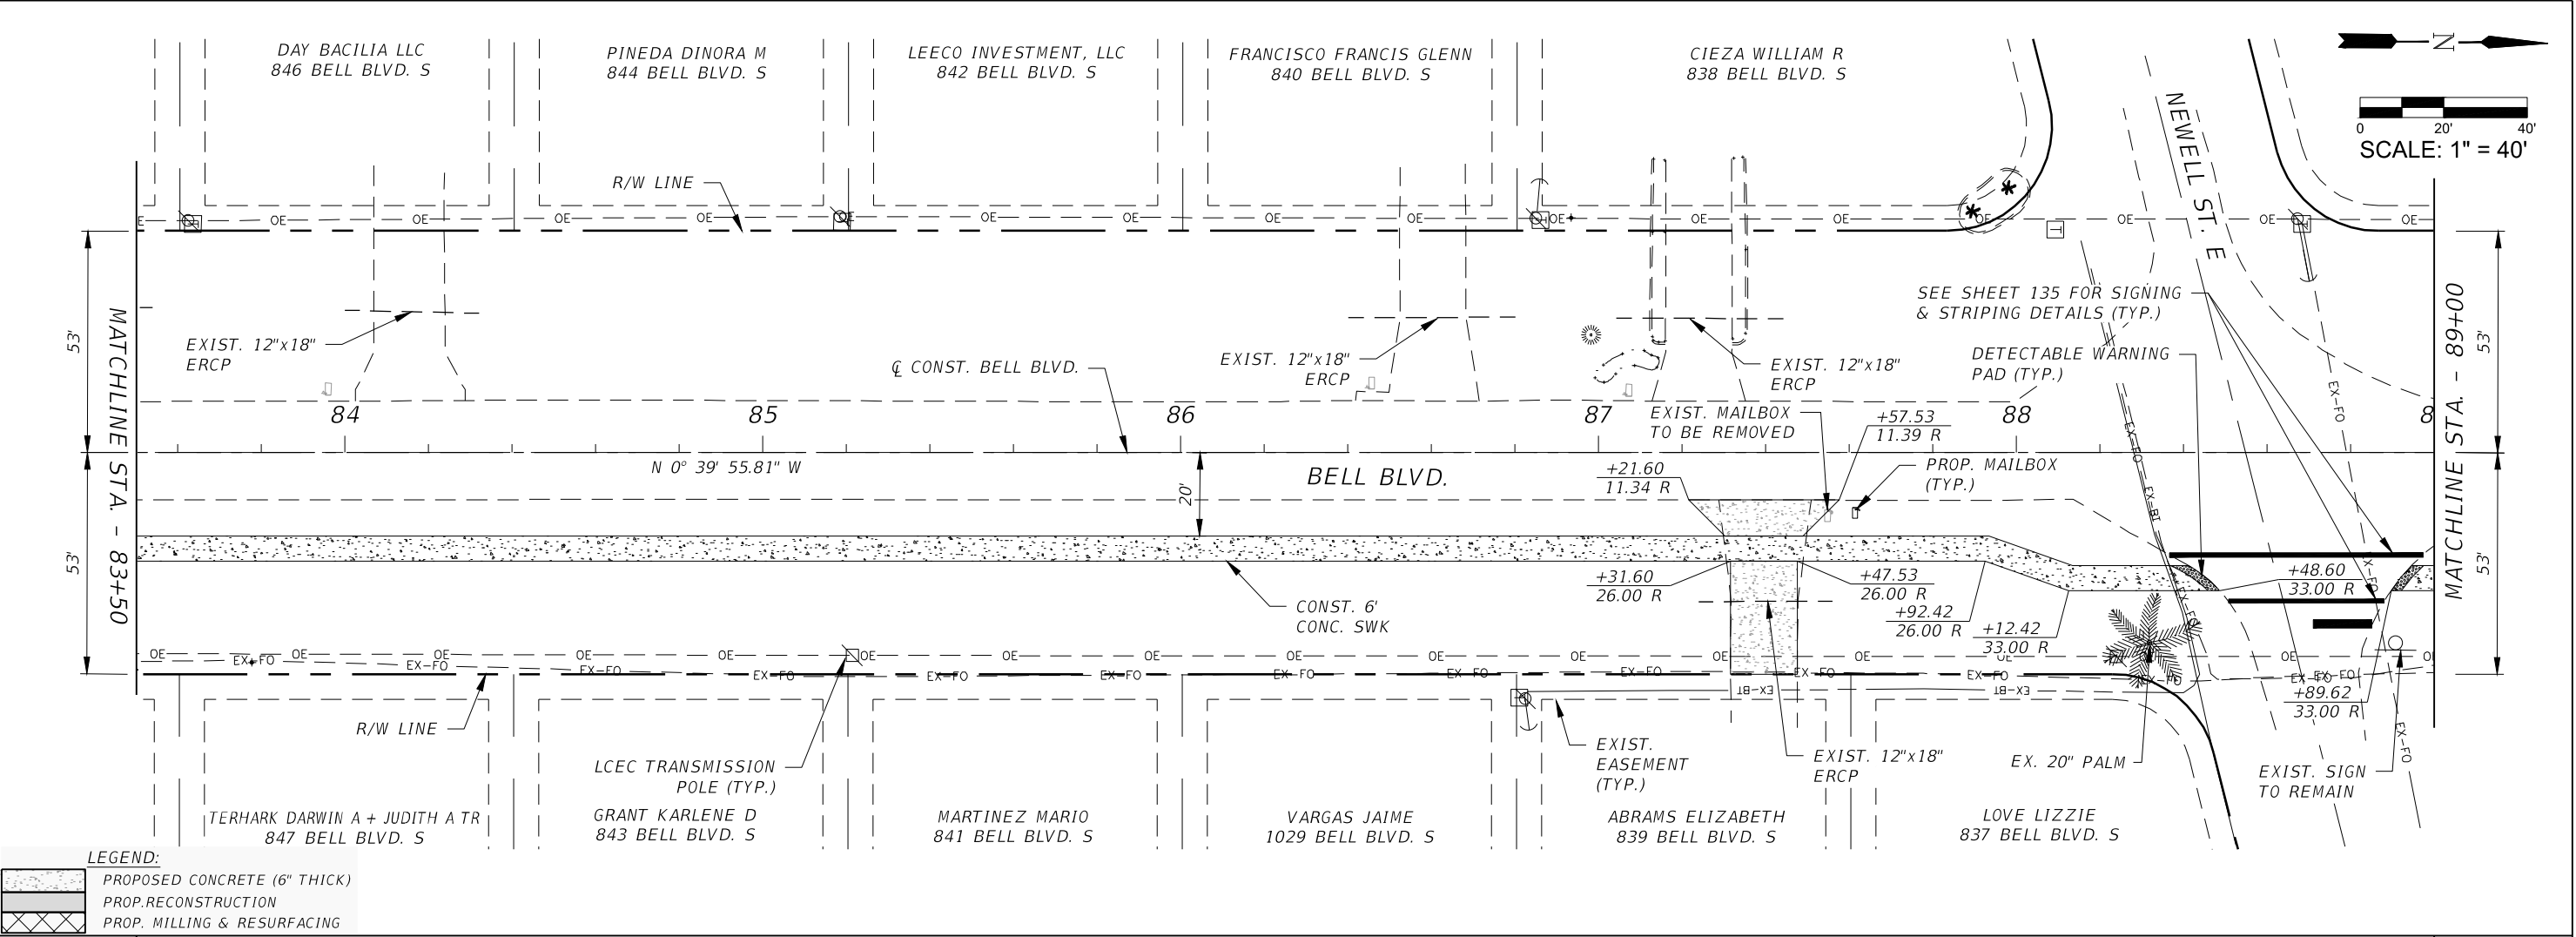



REVISIONS				<div> <b>GradyMinor</b> Civil Engineers • Land Surveyors • Planners • Landscape Architects <small>Cert. of Auth. EB 0005131    Cert. of Auth. LB 0005131    Business LC 26000266</small></div> <div><b>Q. Grady Minor and Associates, P.A.</b> 3800 Via Del Rey Bonita Springs, Florida 34134 Phone: 239.947.1144 <b>R. DANIEL FLYNN, P.E. NO. 76205</b></div>	<b>LEE COUNTY</b>		<b>ROADWAY PLAN &amp; PROFILE</b> <b>STA. 83+50 TO STA. 89+00</b>	<div>SHEET NO.  <b>40</b></div>
DATE	DESCRIPTION	DATE	DESCRIPTION		ROAD NO.	COUNTY PROJECT NO.		
					BELL BLVD. SR 82 TO SUNRISE BLVD. SIDEWALK	6002		

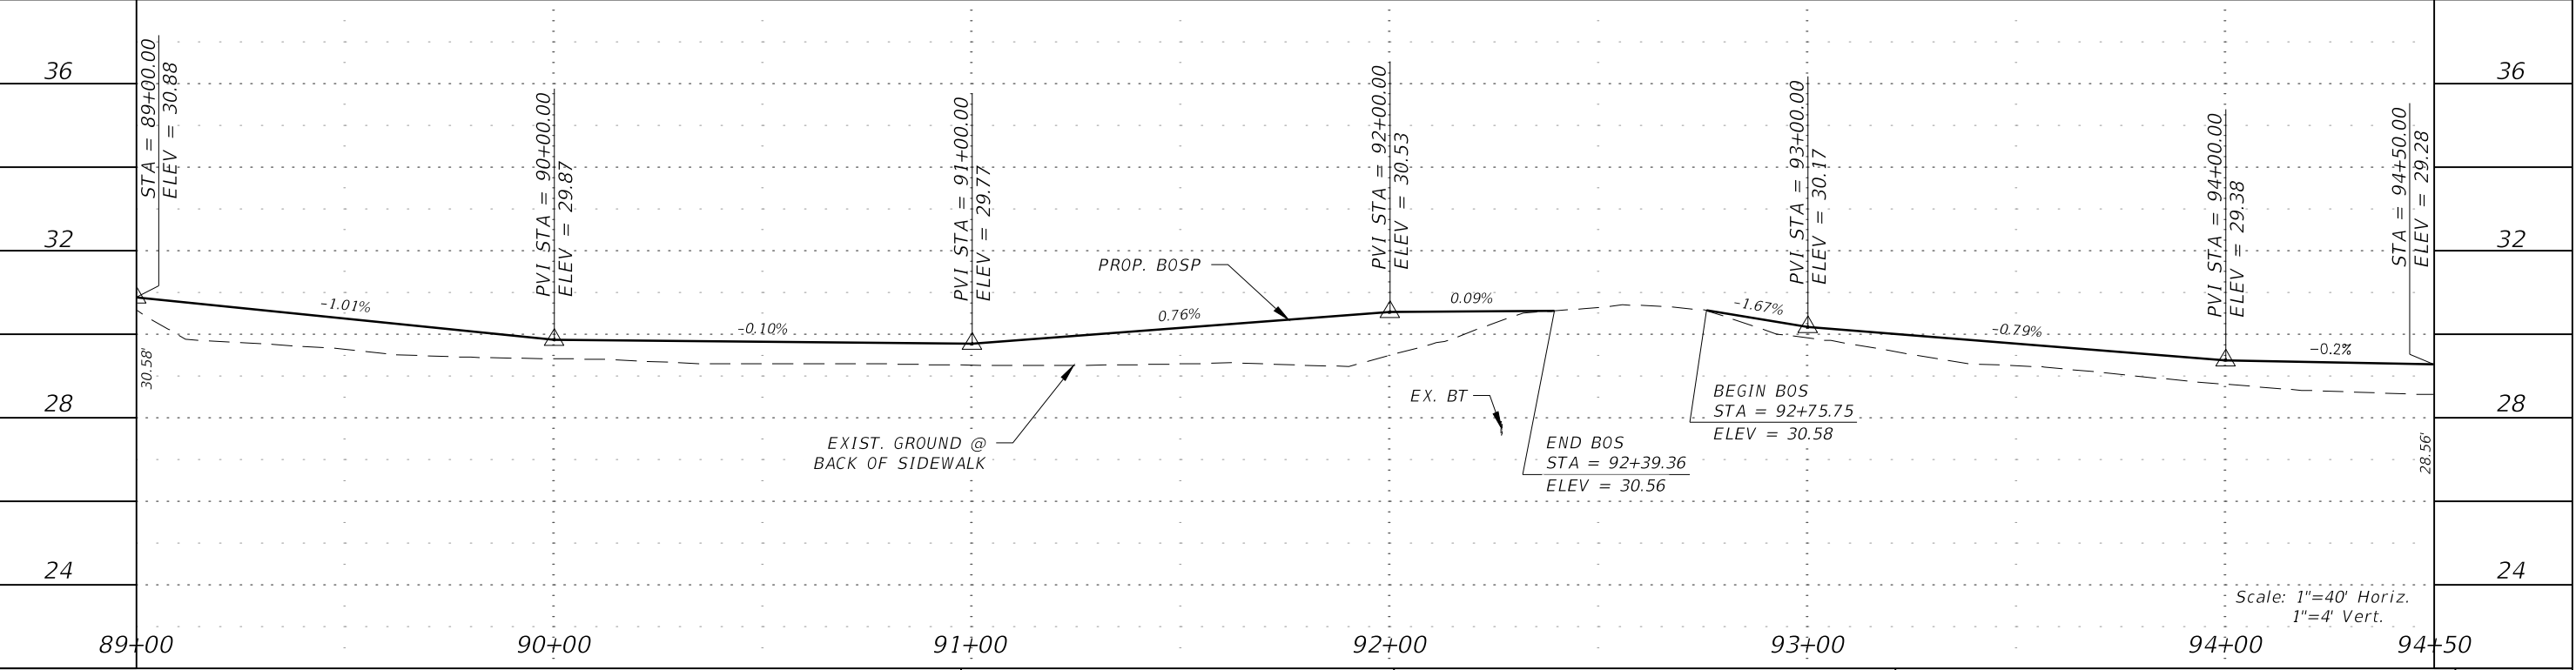
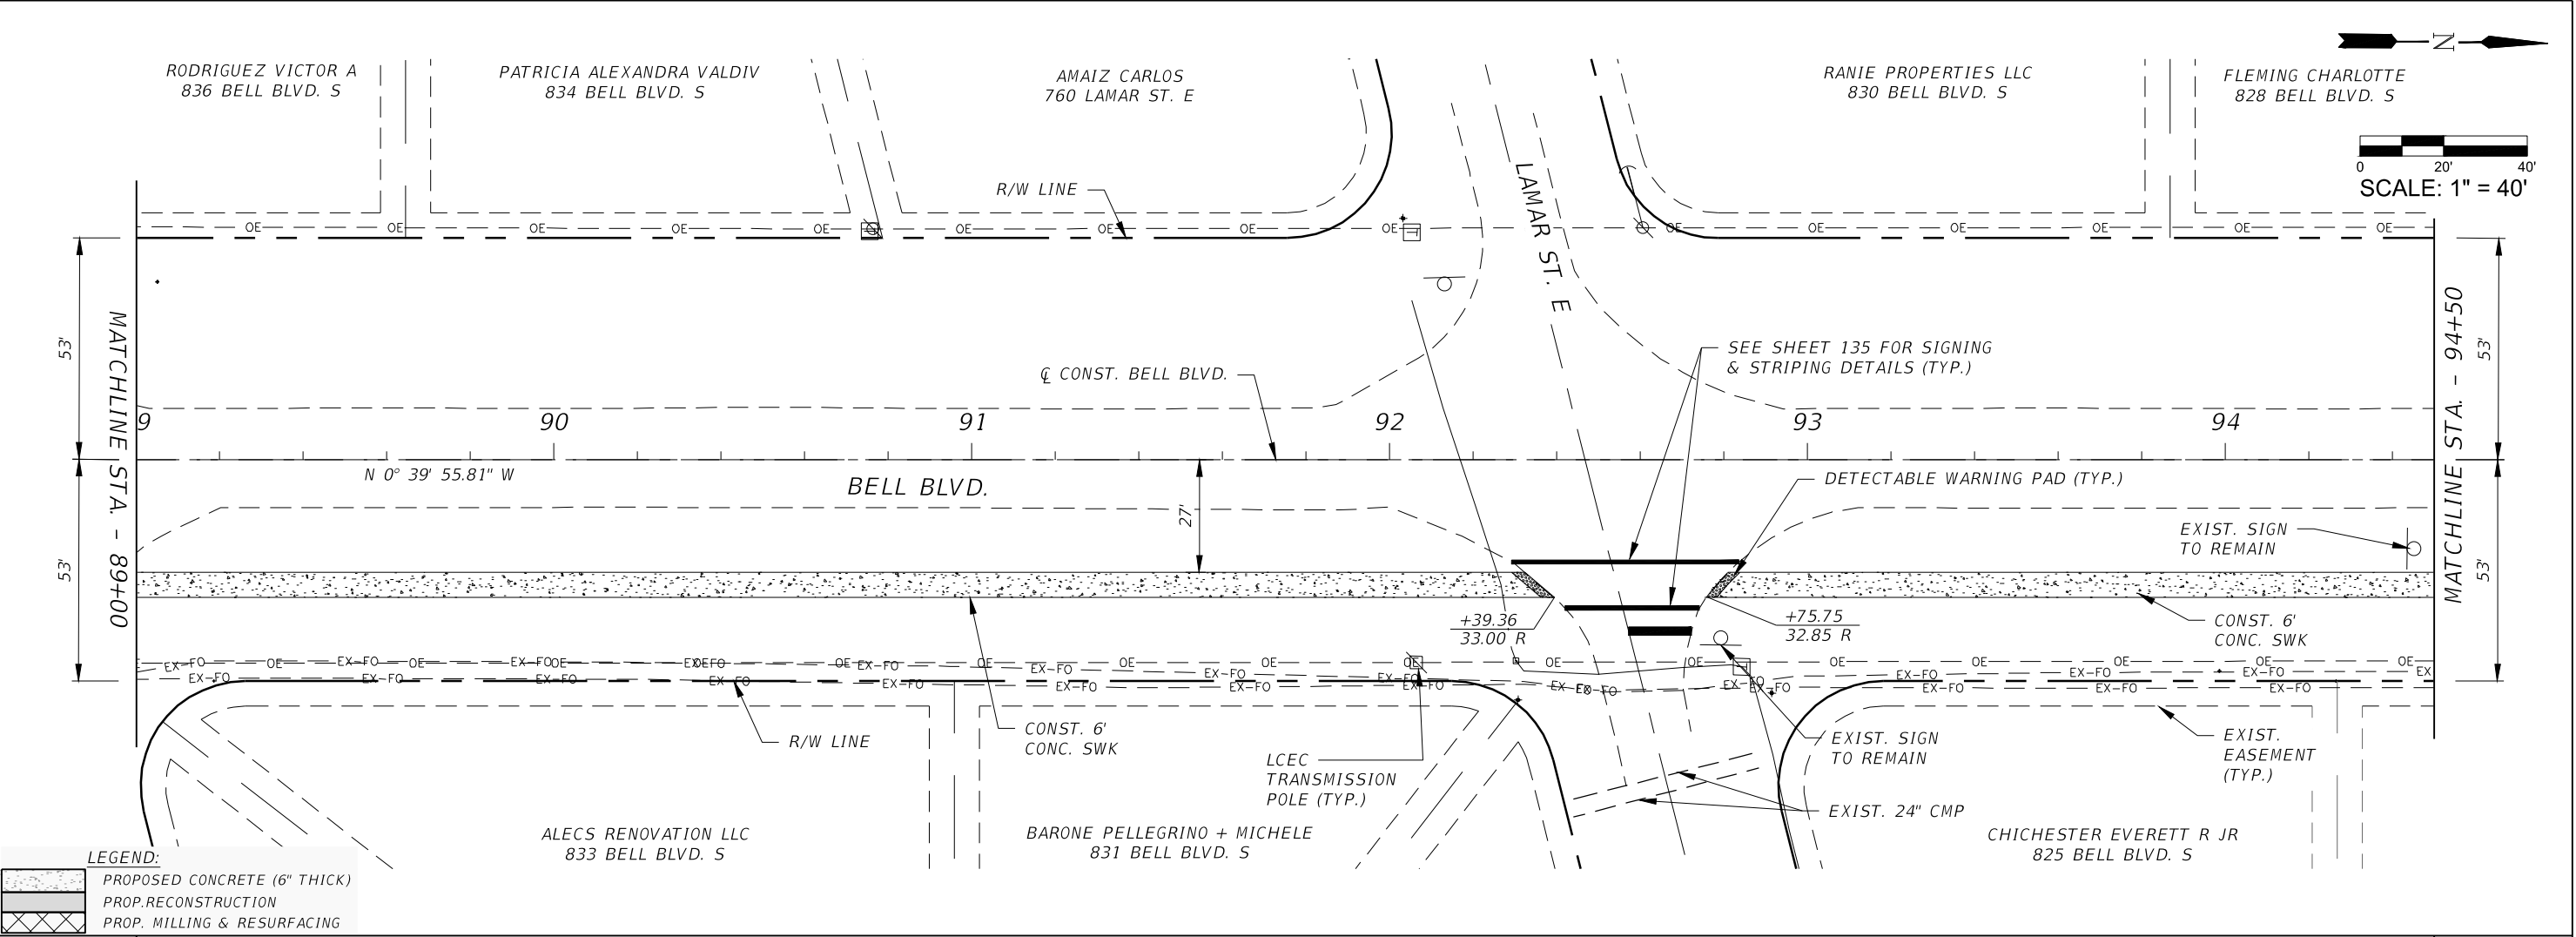


REVISIONS				<div><p>Q. Grady Minor and Associates, P.A. 3800 Via Del Rey Bonita Springs, Florida 34134 Phone: 239.947.1144 R. DANIEL FLYNN, P.E. NO. 76205</p><p><b>GradyMinor</b> Civil Engineers • Land Surveyors • Planners • Landscape Architects <small>CERT. OF AUTH. EB 0005151    CERT. OF AUTH. LB 0005151    BUSINESS LC 26000266</small></p></div>	<b>LEE COUNTY</b>		<b>ROADWAY PLAN &amp; PROFILE</b> <b>STA. 89+00 TO STA. 94+50</b>	<div>SHEET NO.  <b>41</b></div>
DATE	DESCRIPTION	DATE	DESCRIPTION		ROAD NO.	COUNTY PROJECT NO.		
					BELL BLVD. SR 82 TO SUNRISE BLVD. SIDEWALK	6002		




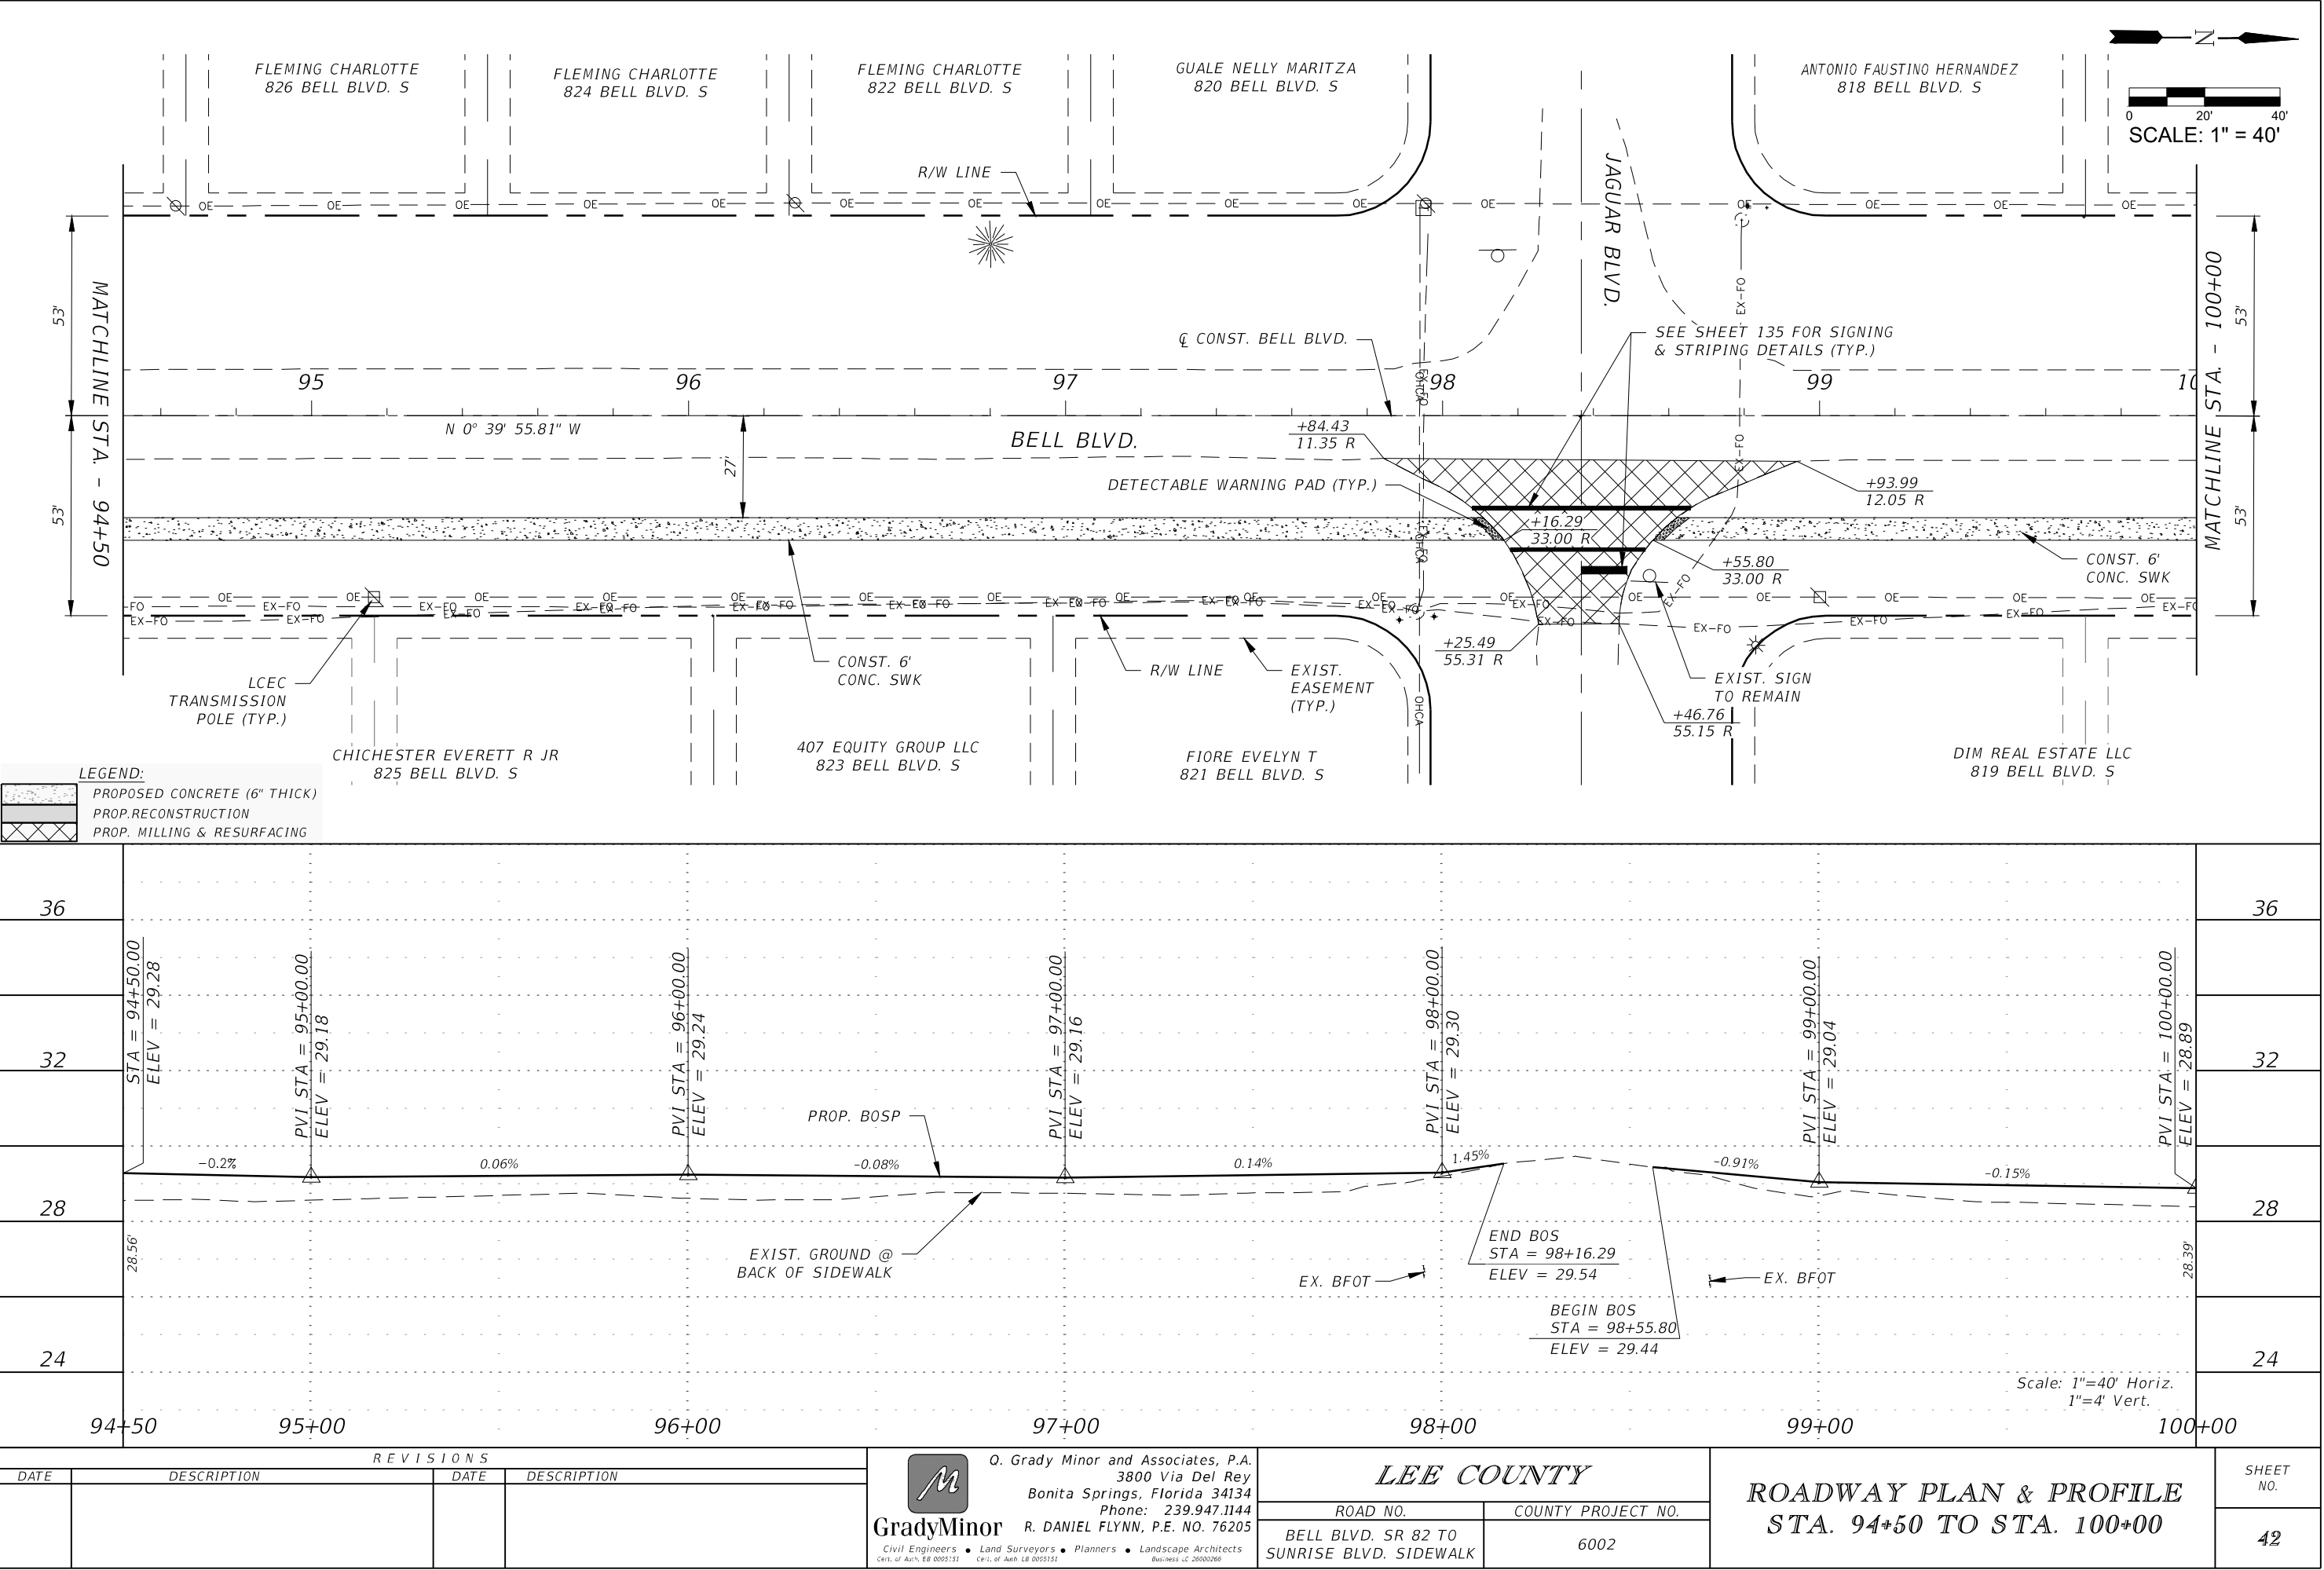


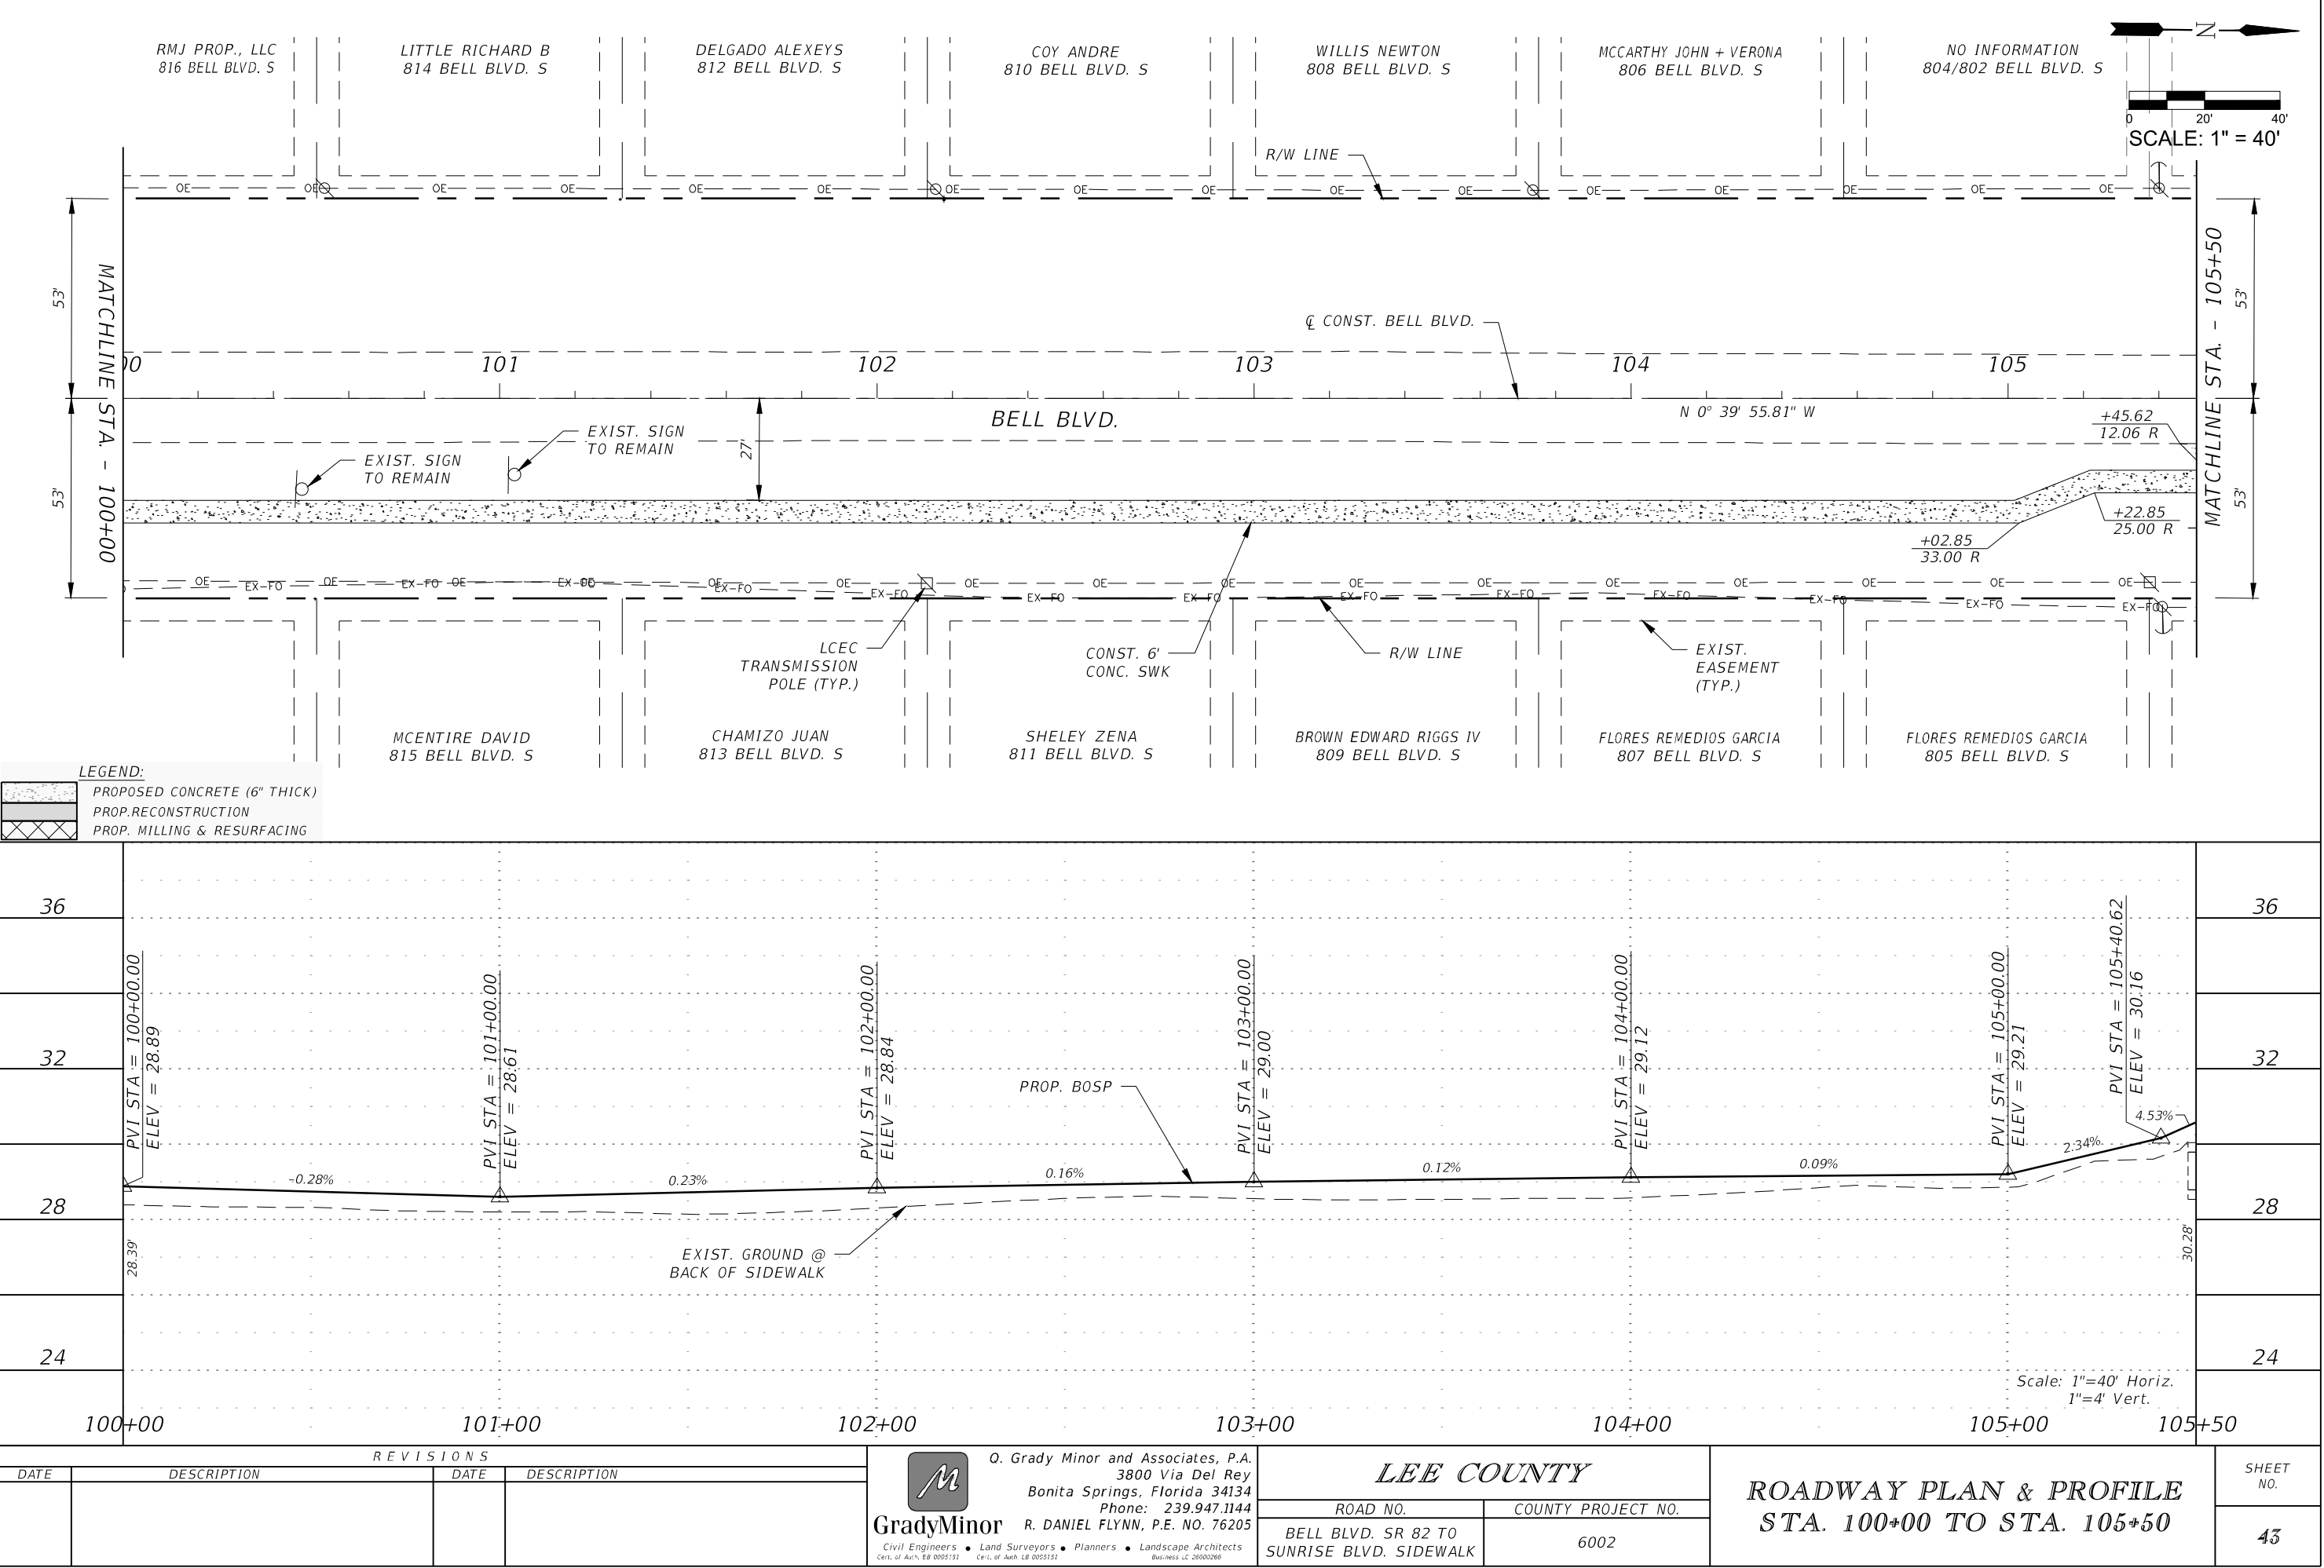

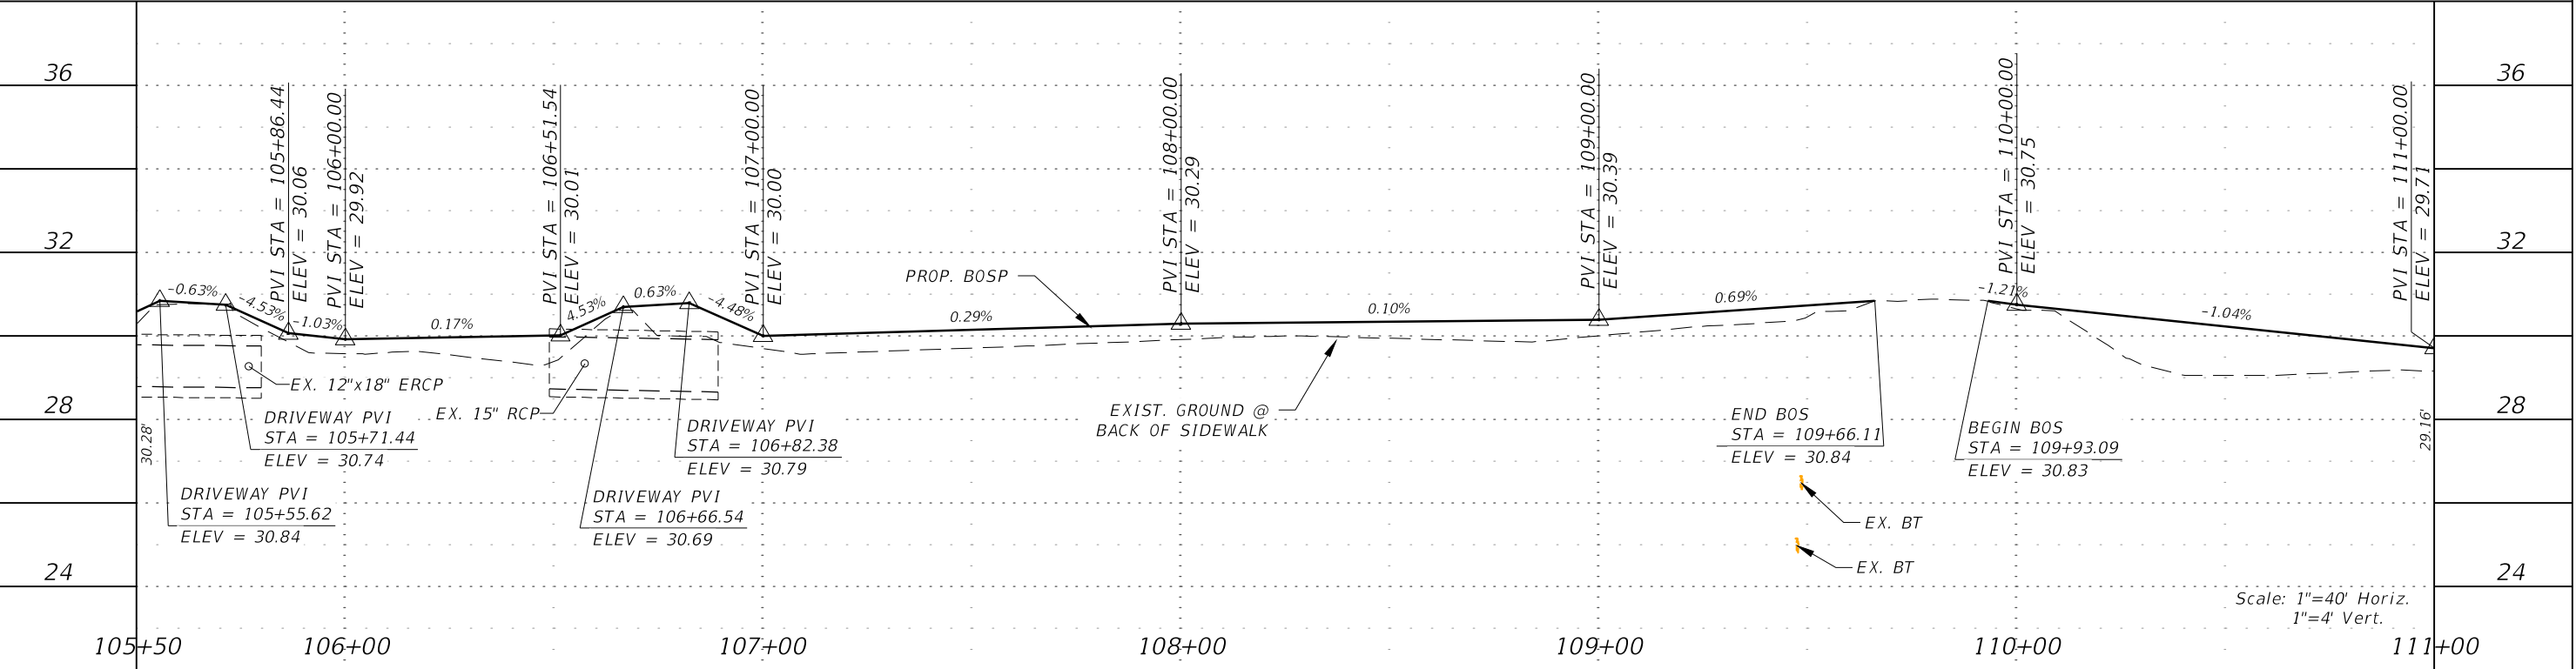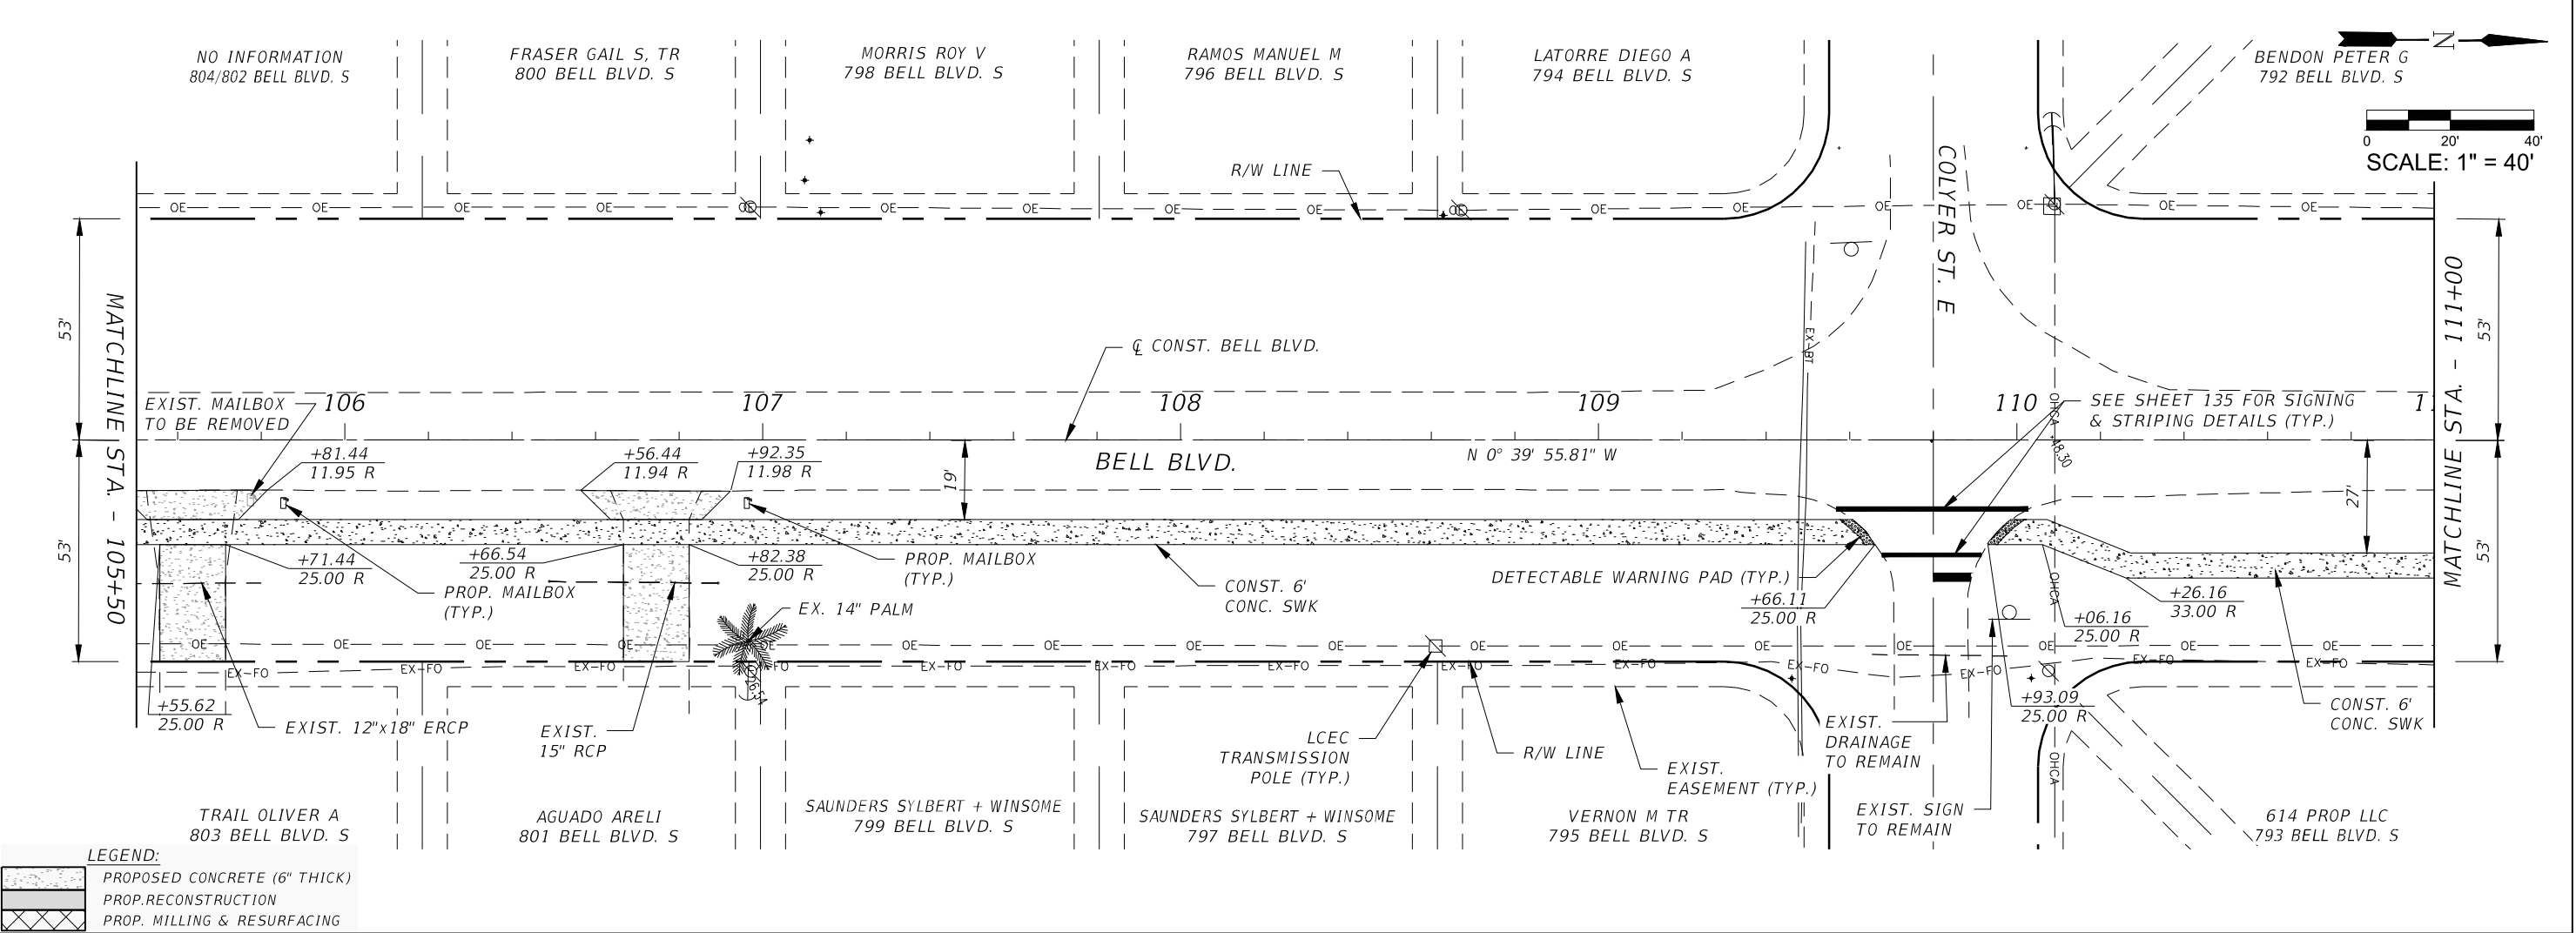




REVISIONS				 <div>Q. Grady Minor and Associates, P.A. 3800 Via Del Rey Bonita Springs, Florida 34134 Phone: 239.947.1144 R. DANIEL FLYNN, P.E. NO. 76205</div>	LEE COUNTY		ROADWAY PLAN & PROFILE STA. 105+50 TO STA. 111+00	SHEET NO.  44
DATE	DESCRIPTION	DATE	DESCRIPTION		ROAD NO.	COUNTY PROJECT NO.		
					BELL BLVD. SR 82 TO SUNRISE BLVD. SIDEWALK	6002		



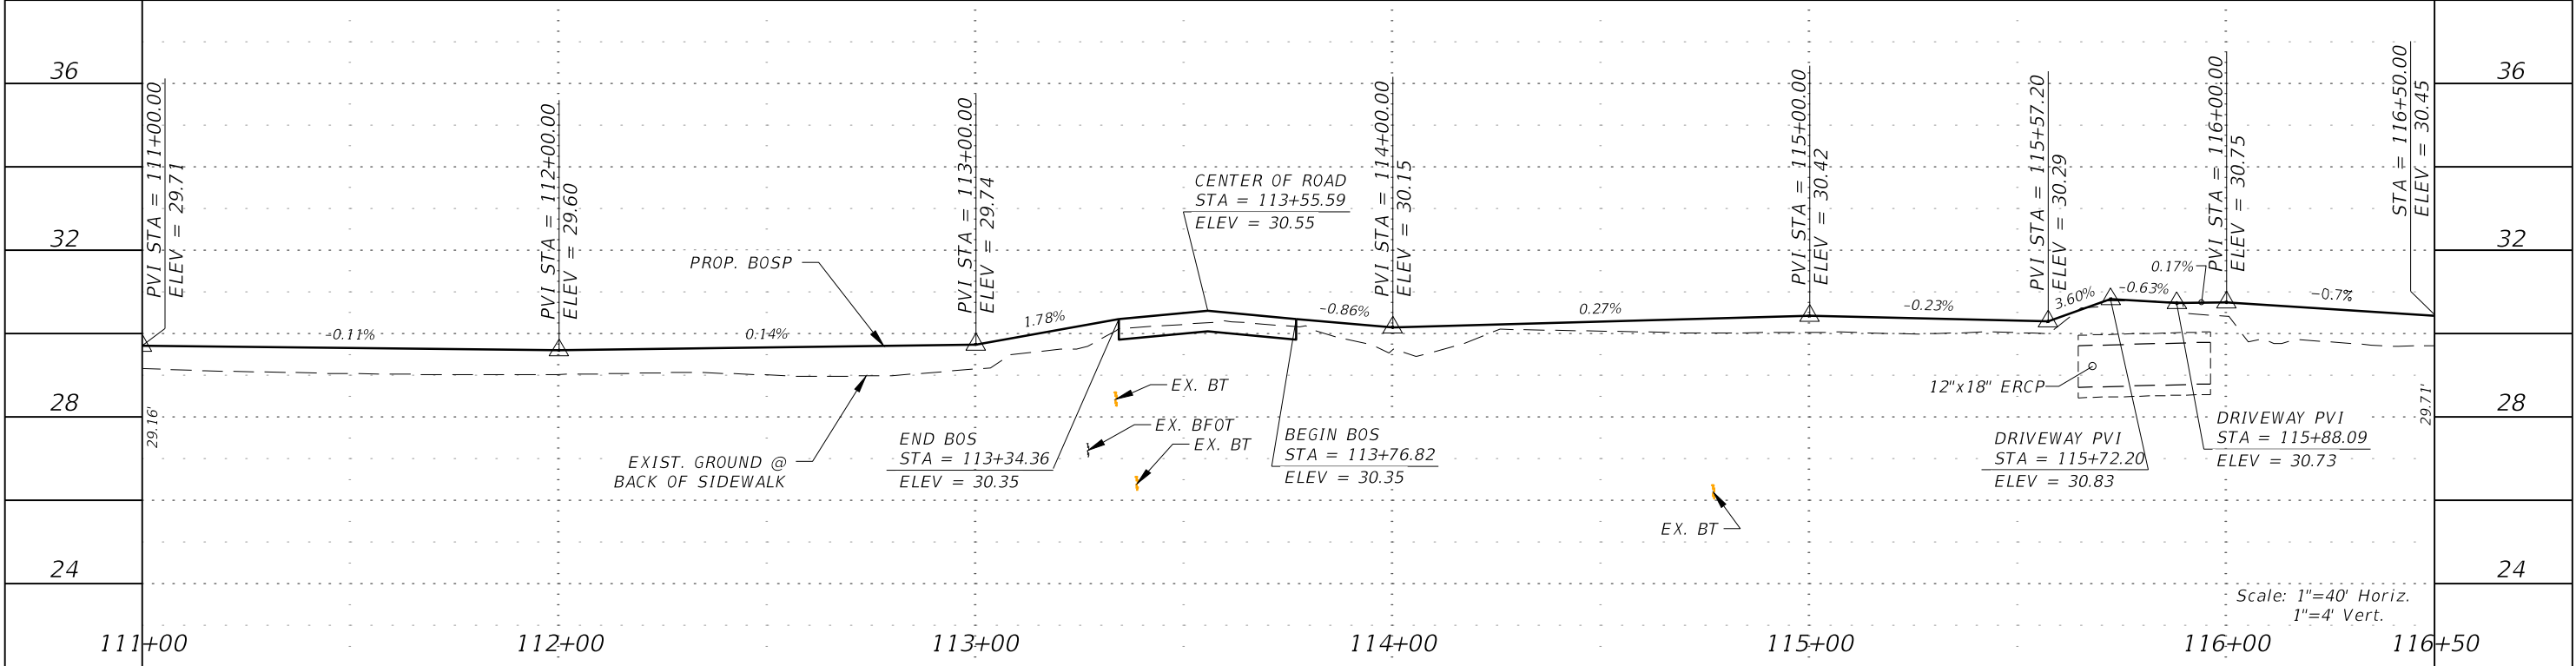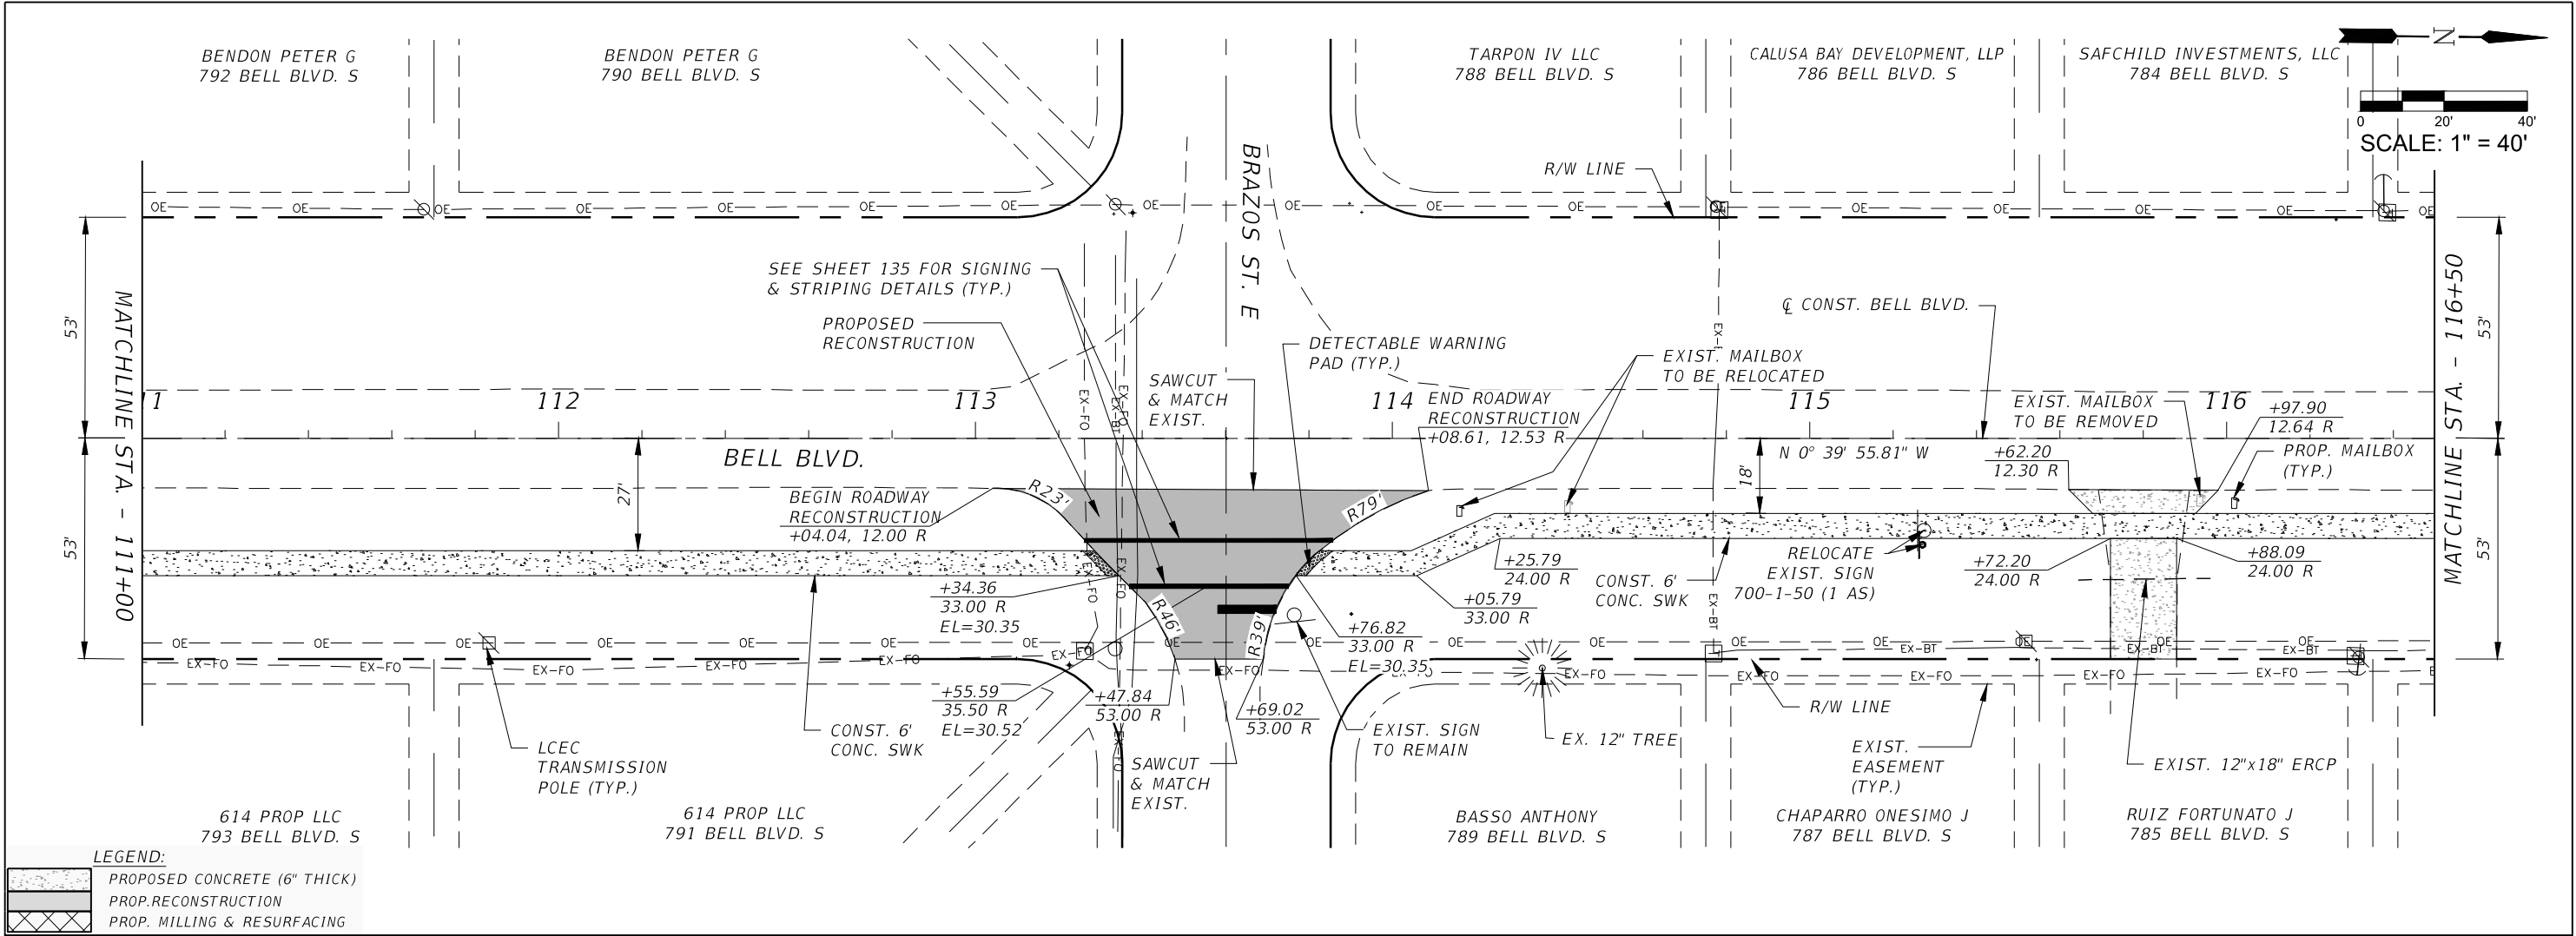



REVISIONS				<div>Q. Grady Minor and Associates, P.A. 3800 Via Del Rey Bonita Springs, Florida 34134 Phone: 239.947.1144 R. DANIEL FLYNN, P.E. NO. 76205</div>	LEE COUNTY		ROADWAY PLAN & PROFILE STA. 111+00 TO STA. 116+50	SHEET NO.  45
DATE	DESCRIPTION	DATE	DESCRIPTION		ROAD NO.	COUNTY PROJECT NO.		
					BELL BLVD. SR 82 TO SUNRISE BLVD. SIDEWALK	6002		

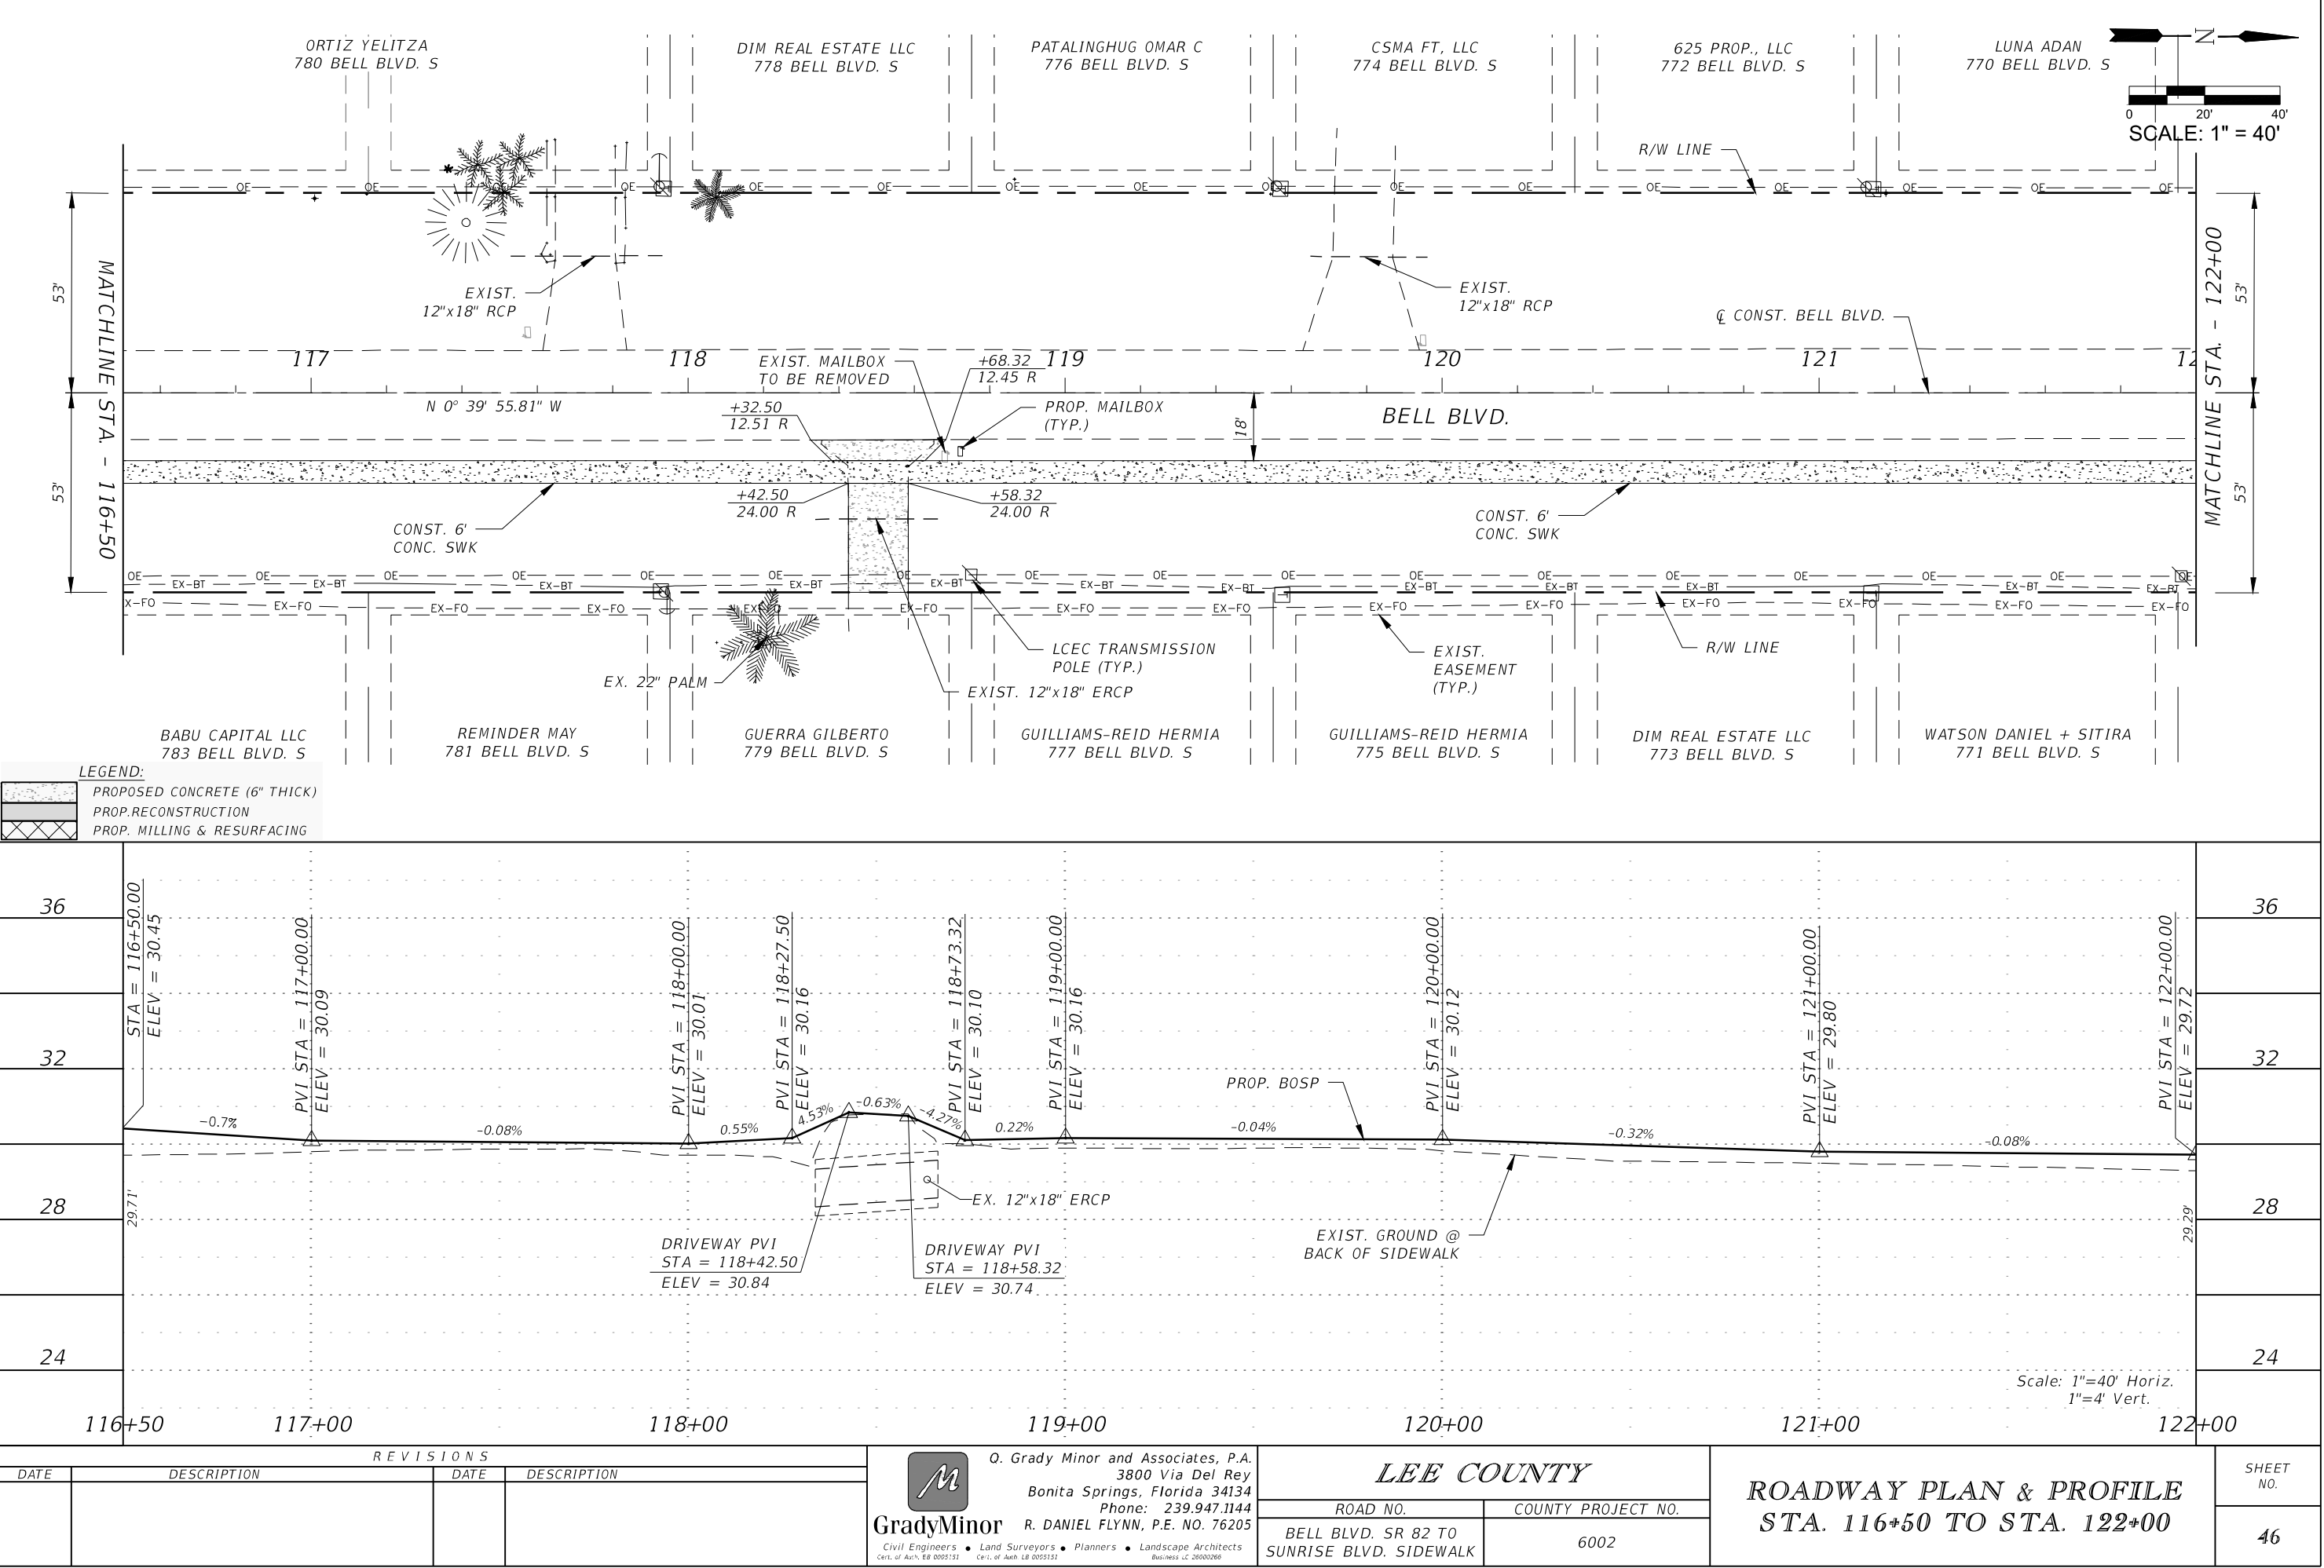

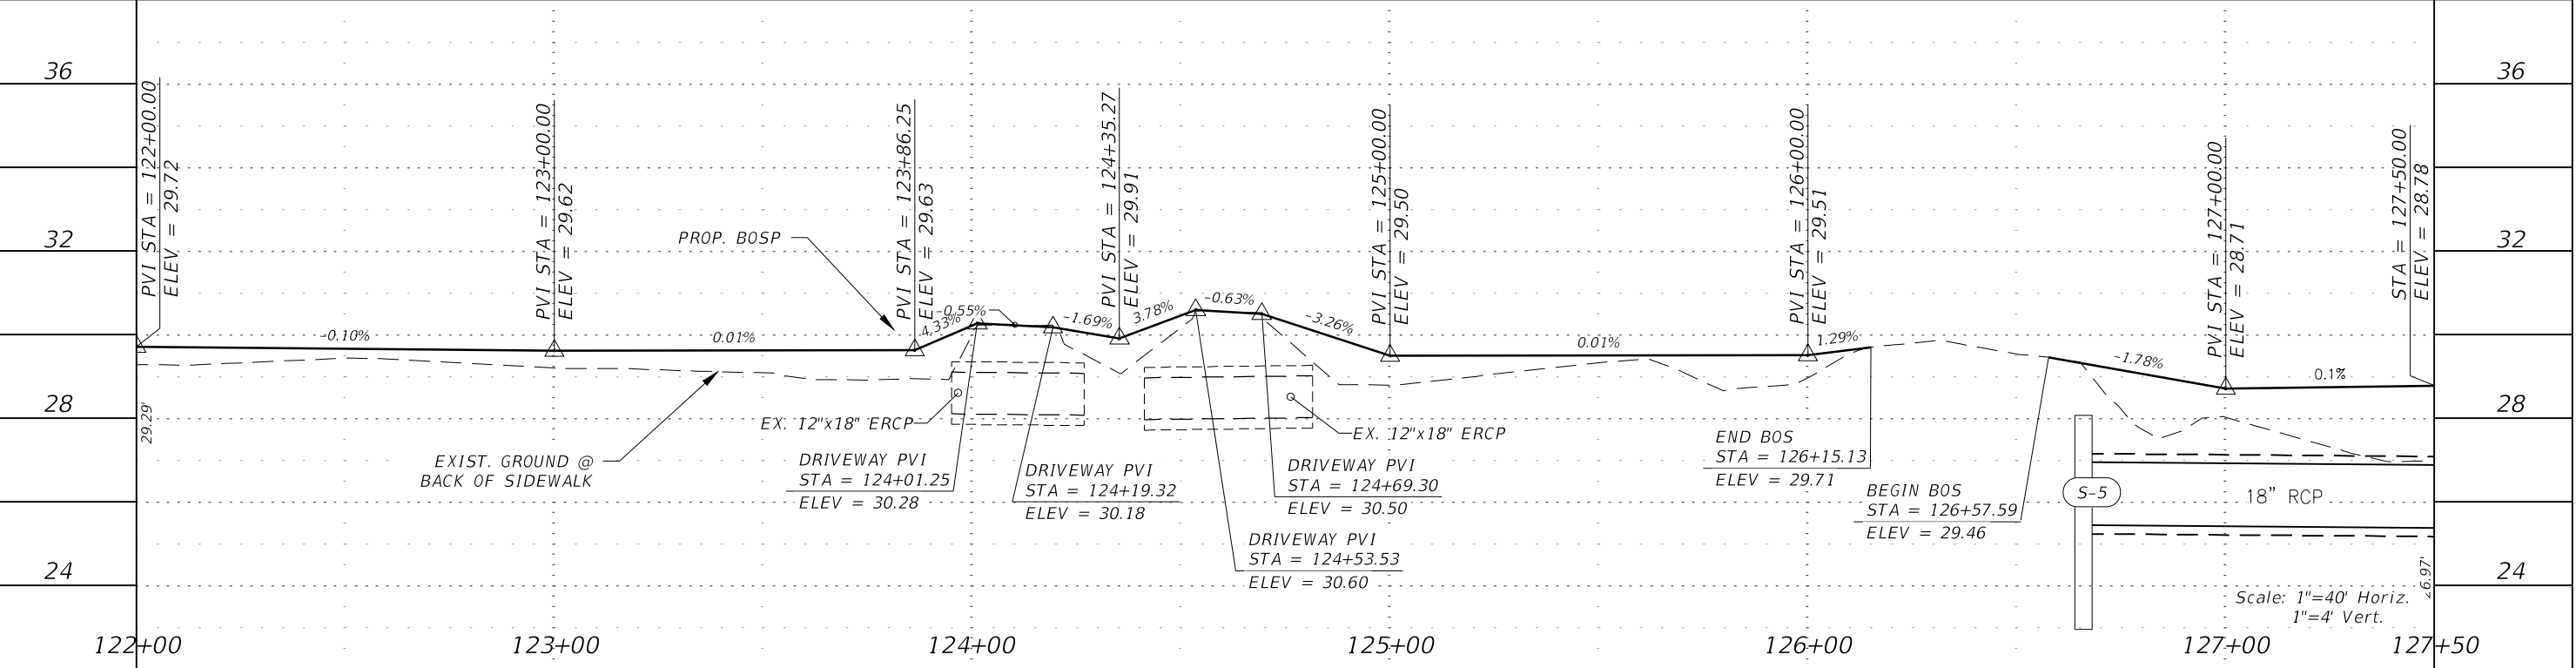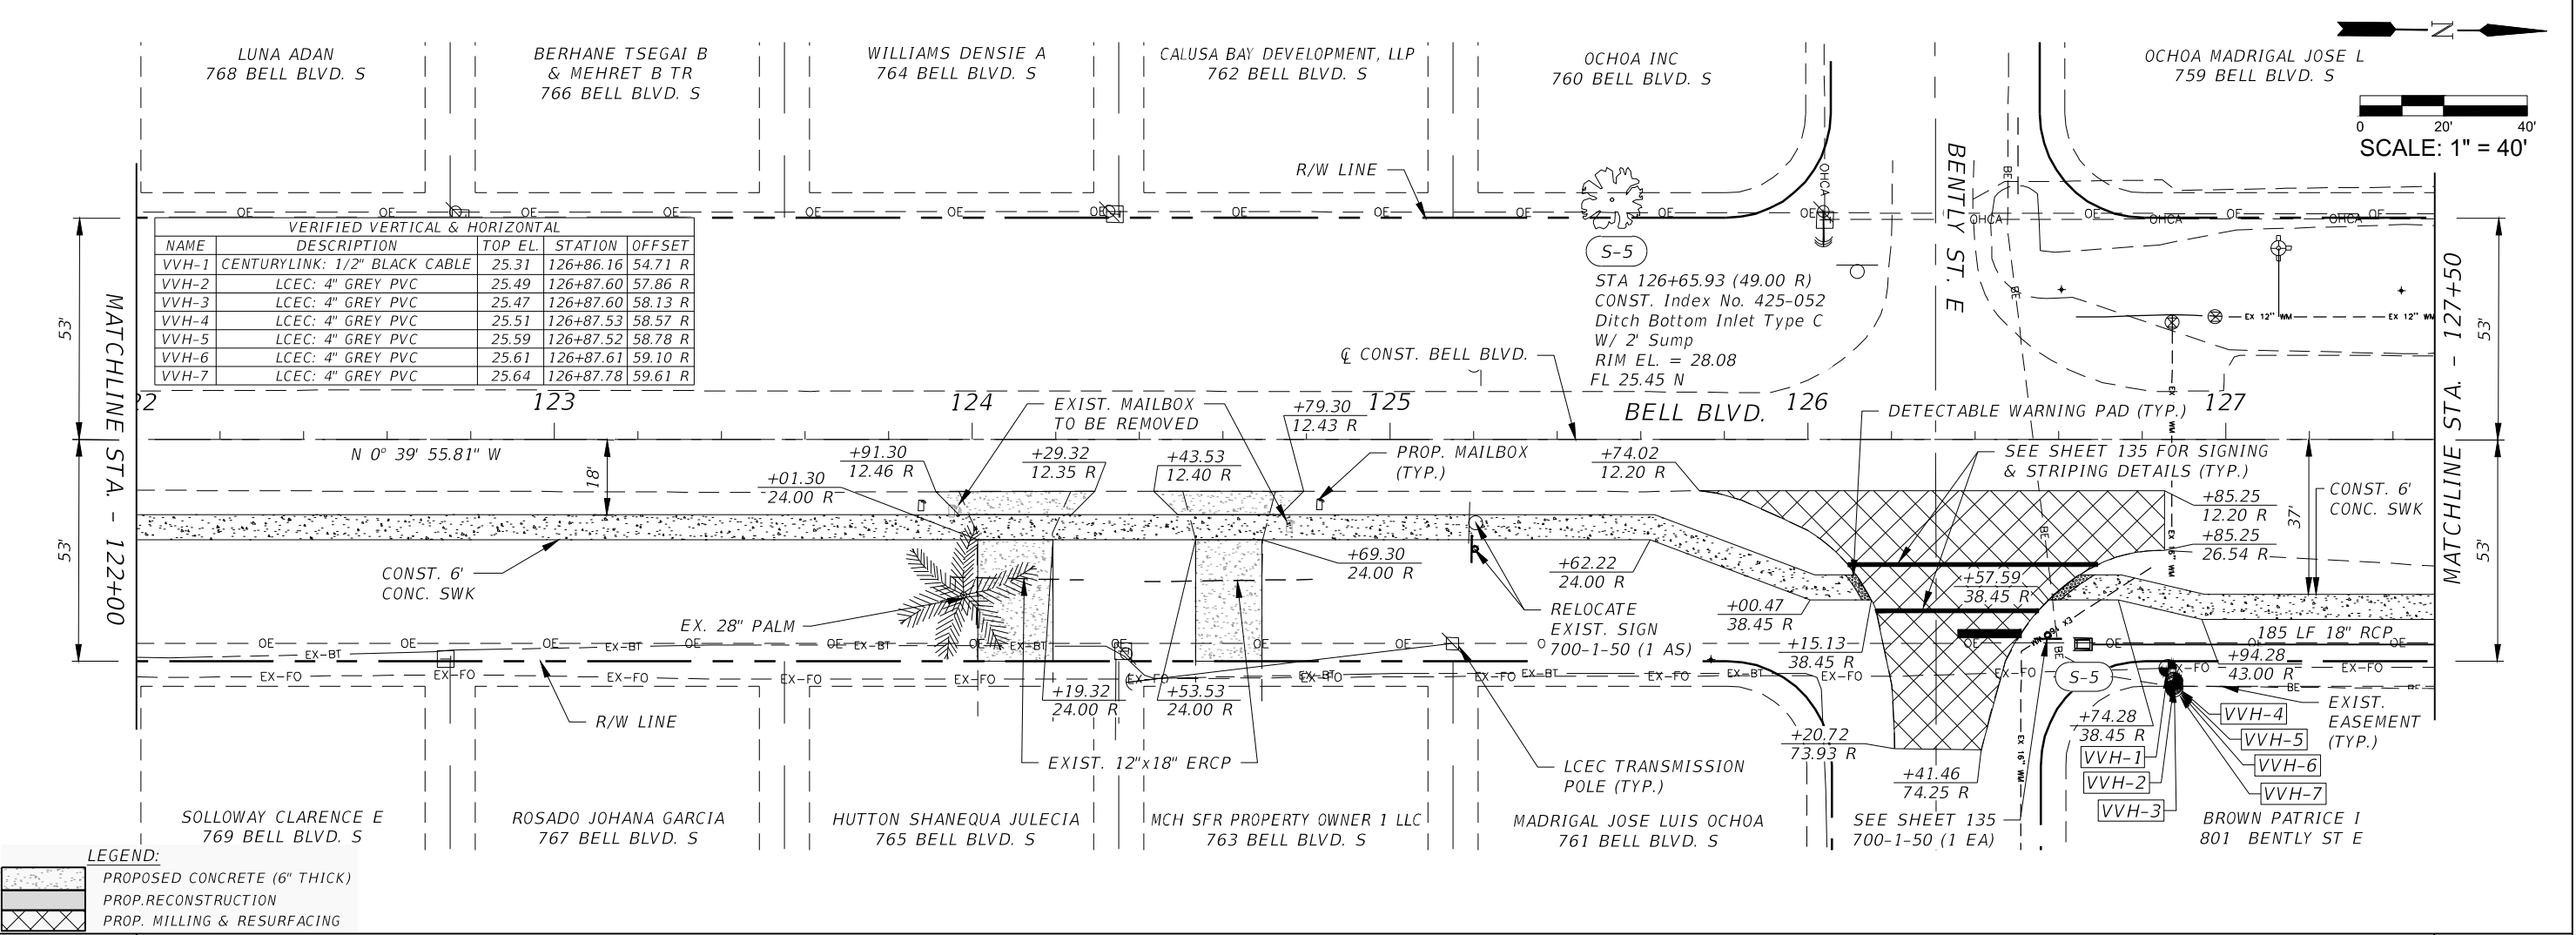




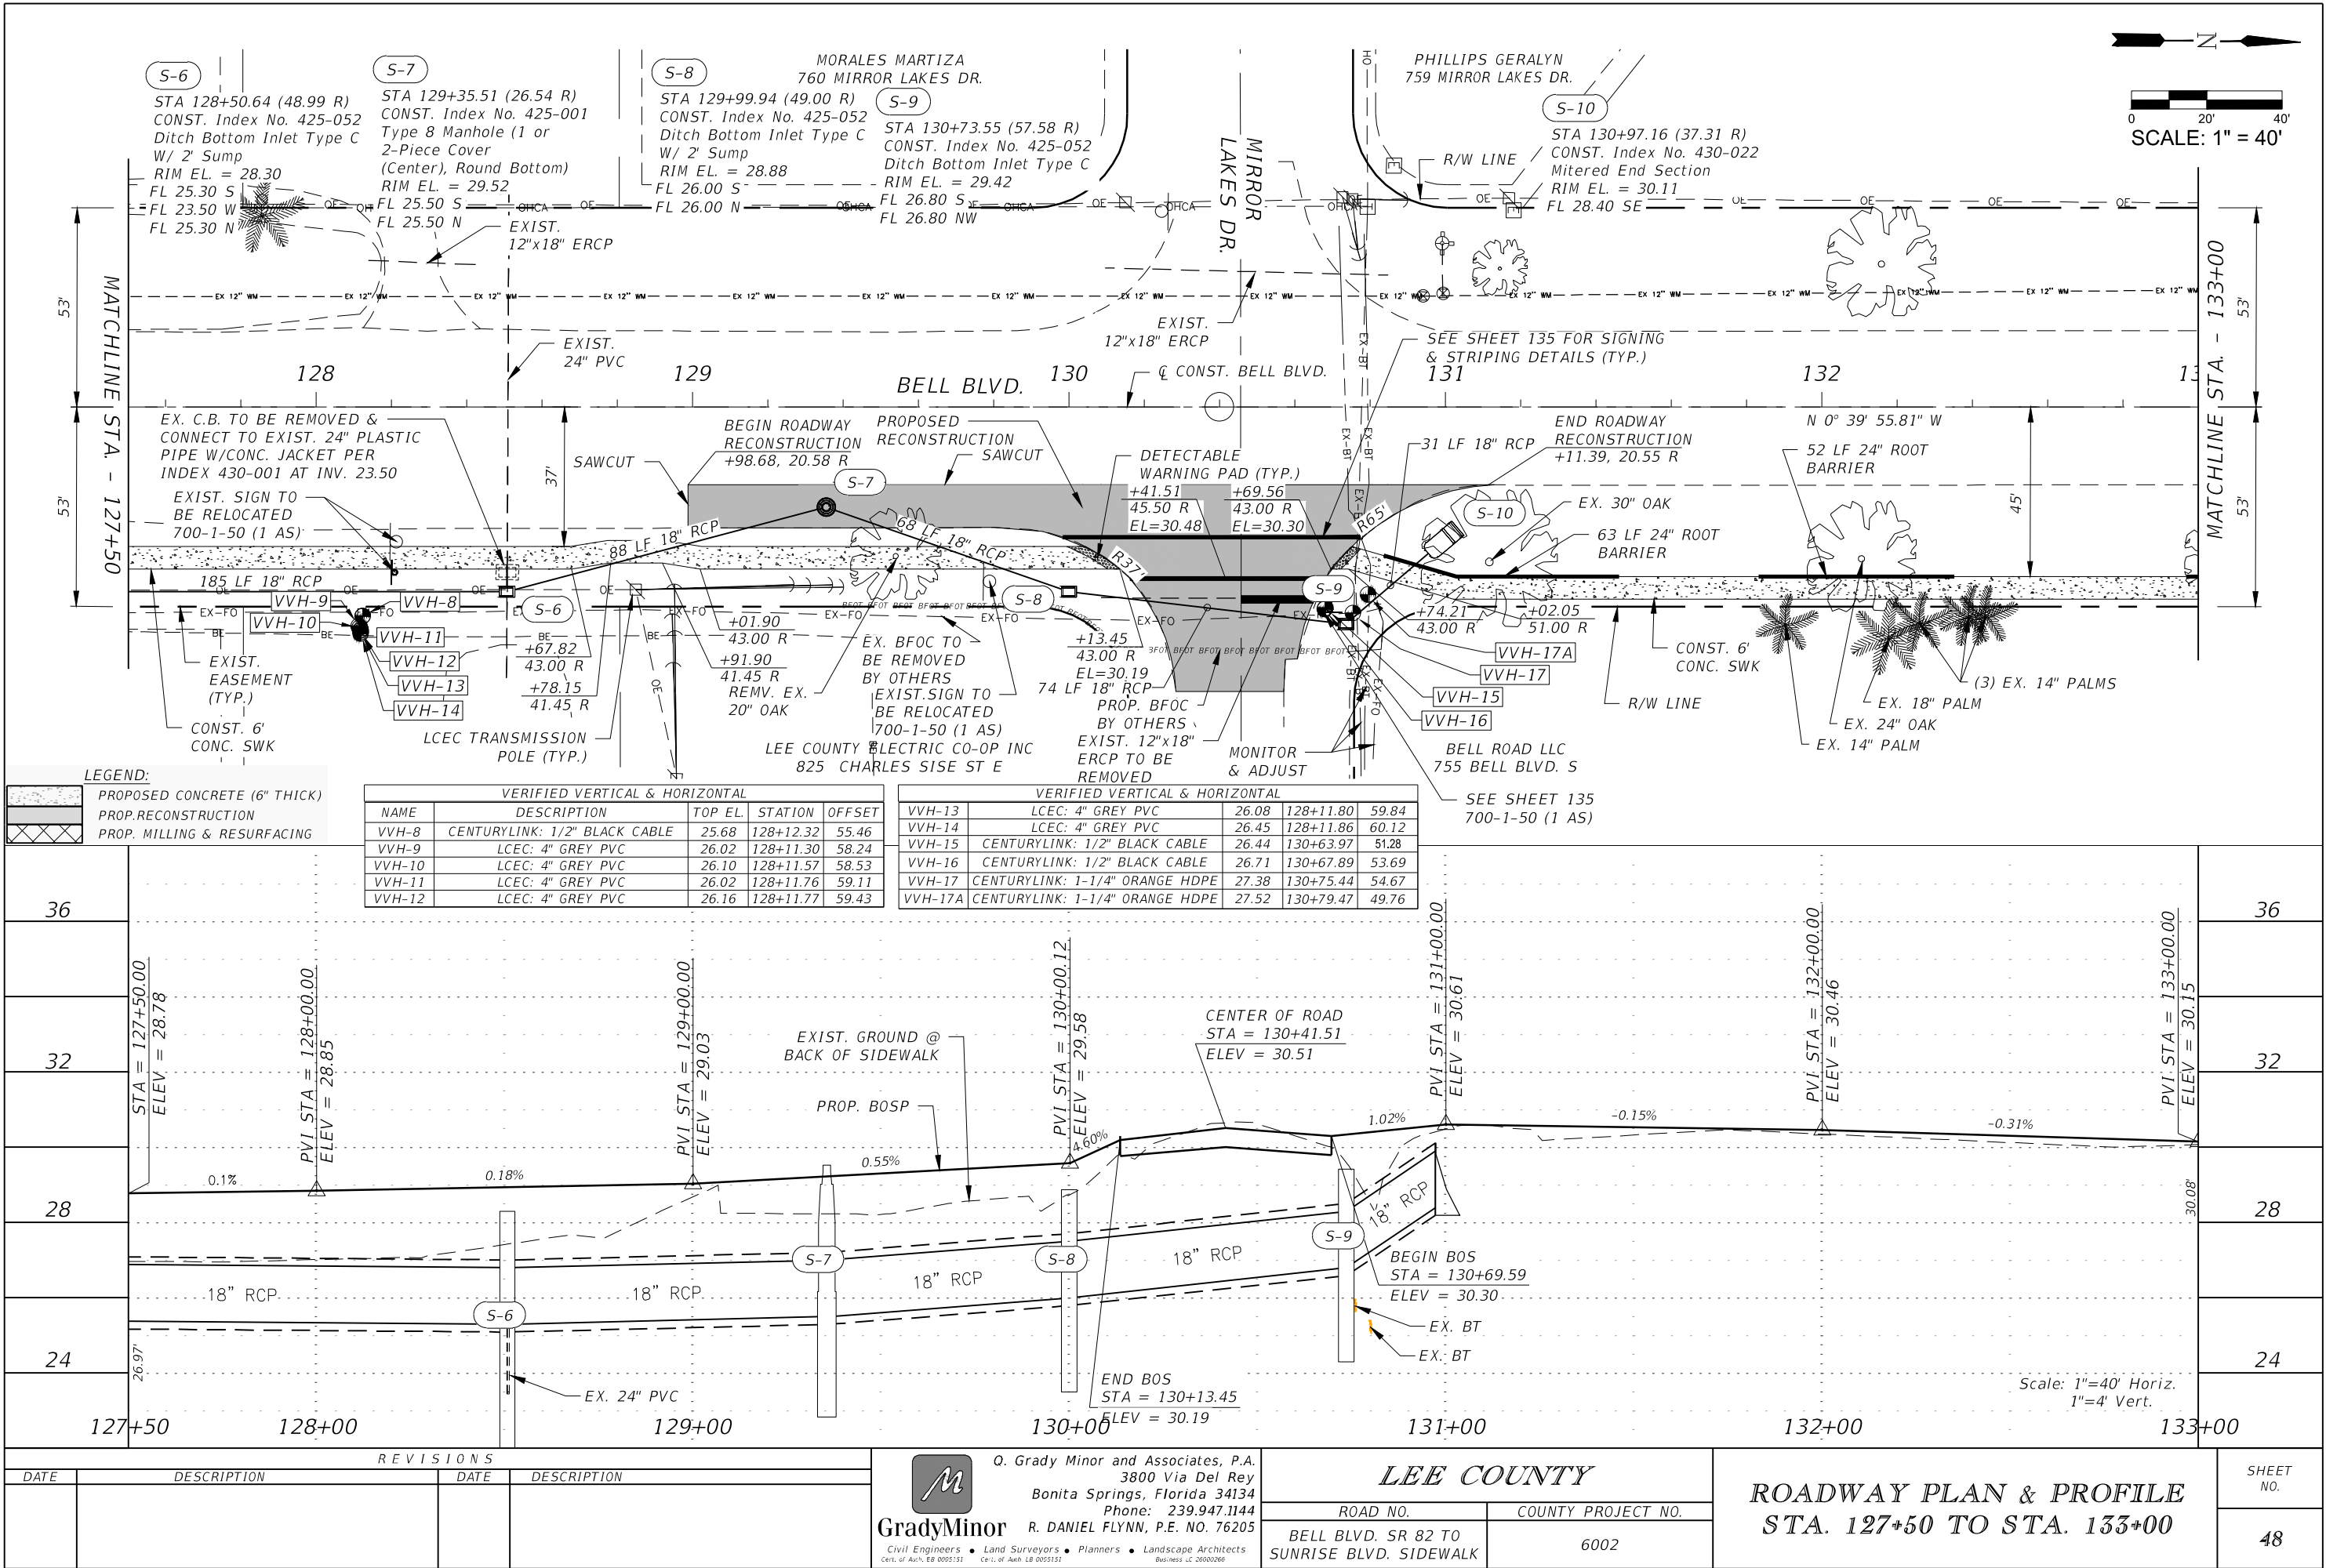


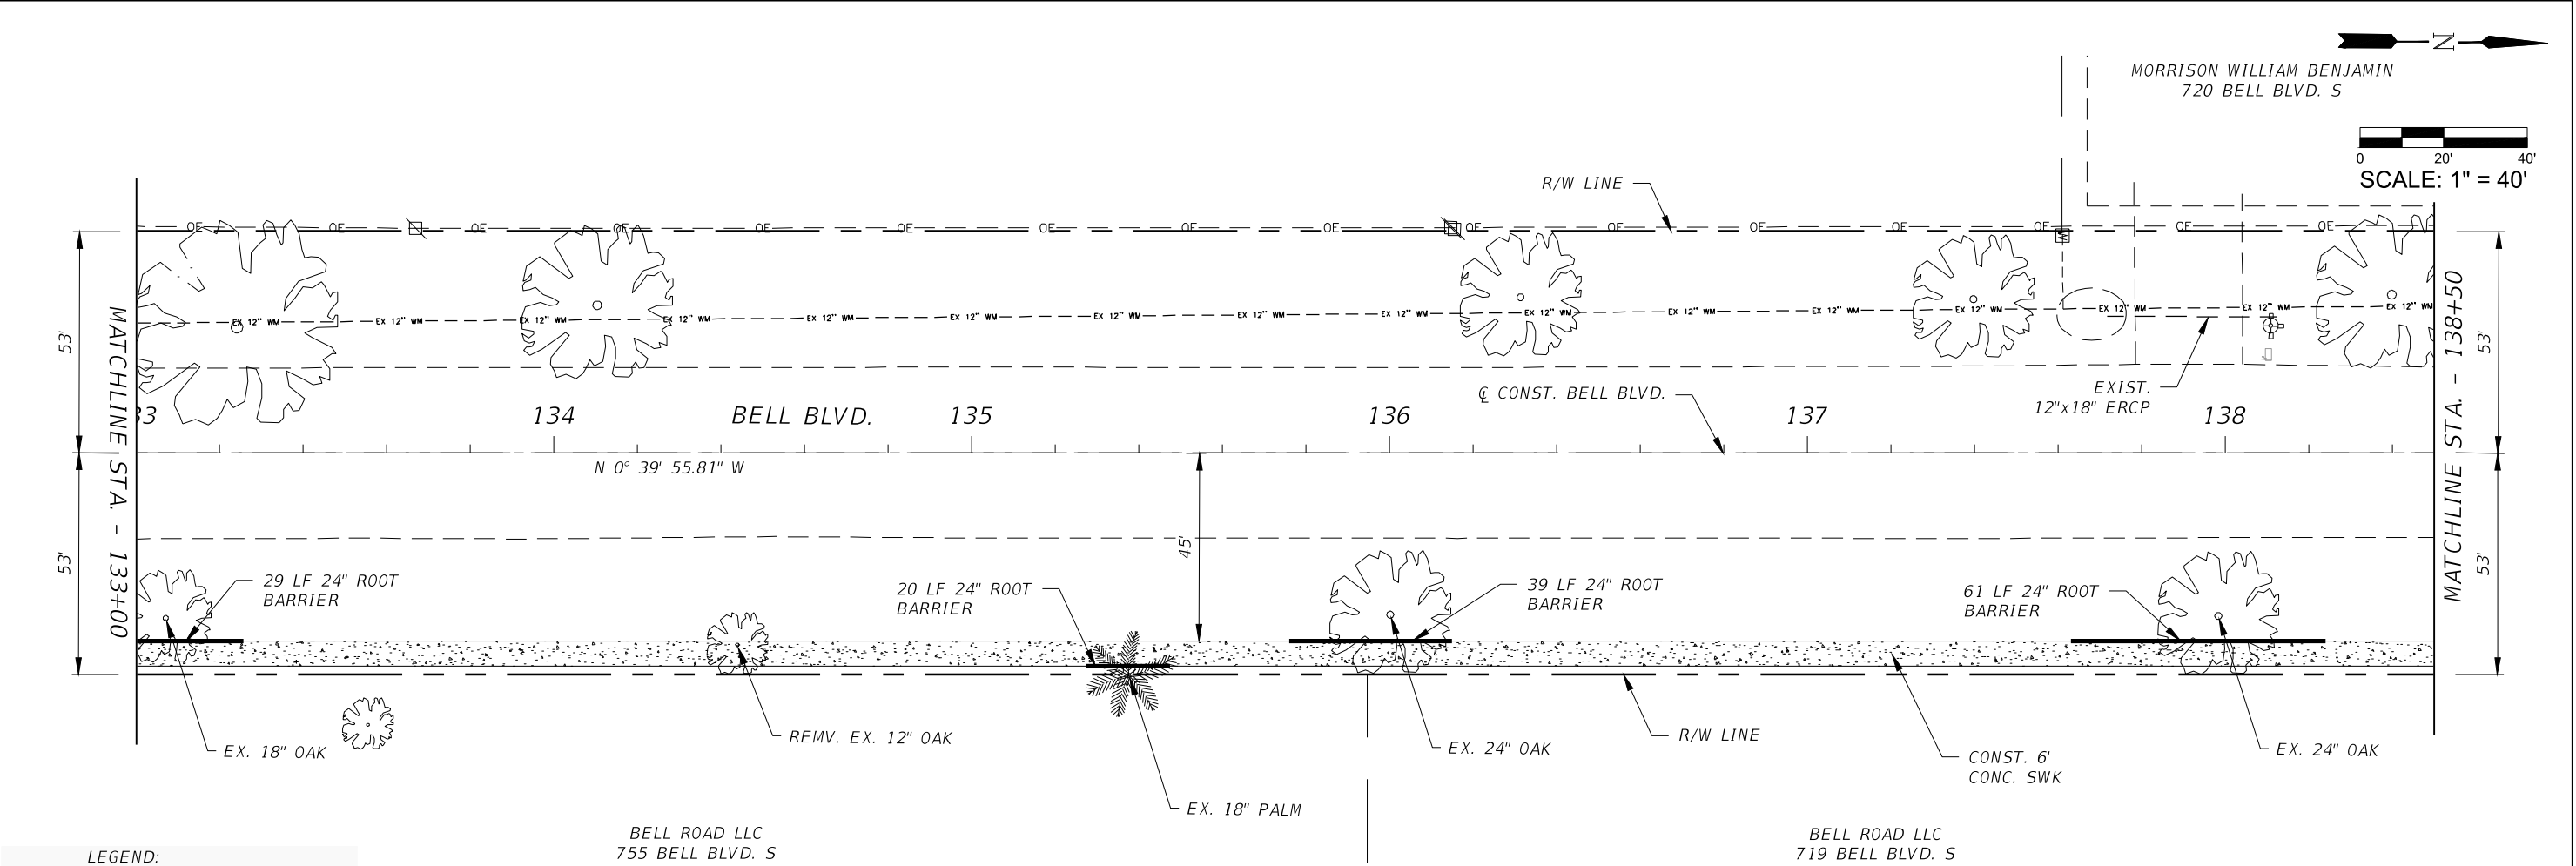


LEGEND:

	PROPOSED CONCRETE (6\"/>
	PROP. RECONSTRUCTION
	PROP. MILLING & RESURFACING


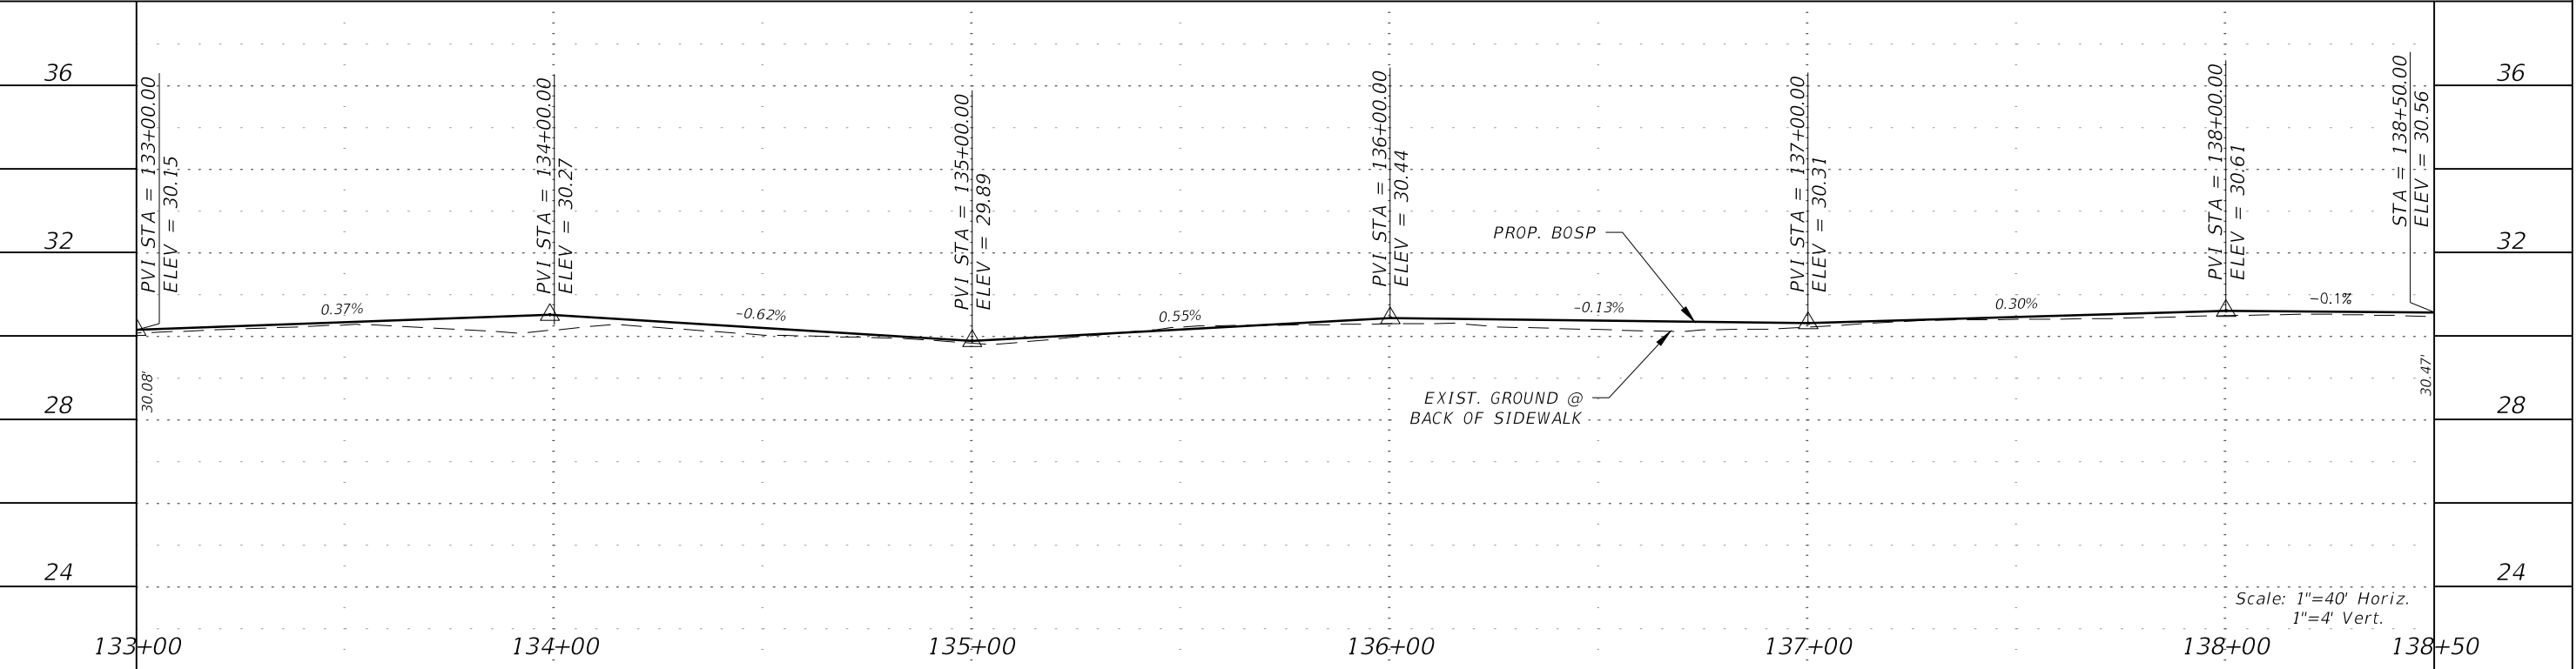


REVISIONS				<div></div> <div>Q. Grady Minor and Associates, P.A. 3800 Via Del Rey Bonita Springs, Florida 34134 Phone: 239.947.1144 R. DANIEL FLYNN, P.E. NO. 76205</div> <div>GradyMinor</div> <div>Civil Engineers • Land Surveyors • Planners • Landscape Architects <small>Cert. of Auth. EB 0005151    Cert. of Auth. LB 0005151    Business Lic. 26000266</small></div>	LEE COUNTY		ROADWAY PLAN & PROFILE STA. 133+00 TO STA. 138+50	SHEET NO.
DATE	DESCRIPTION	DATE	DESCRIPTION		ROAD NO.	COUNTY PROJECT NO.		
					BELL BLVD. SR 82 TO SUNRISE BLVD. SIDEWALK	6002		49

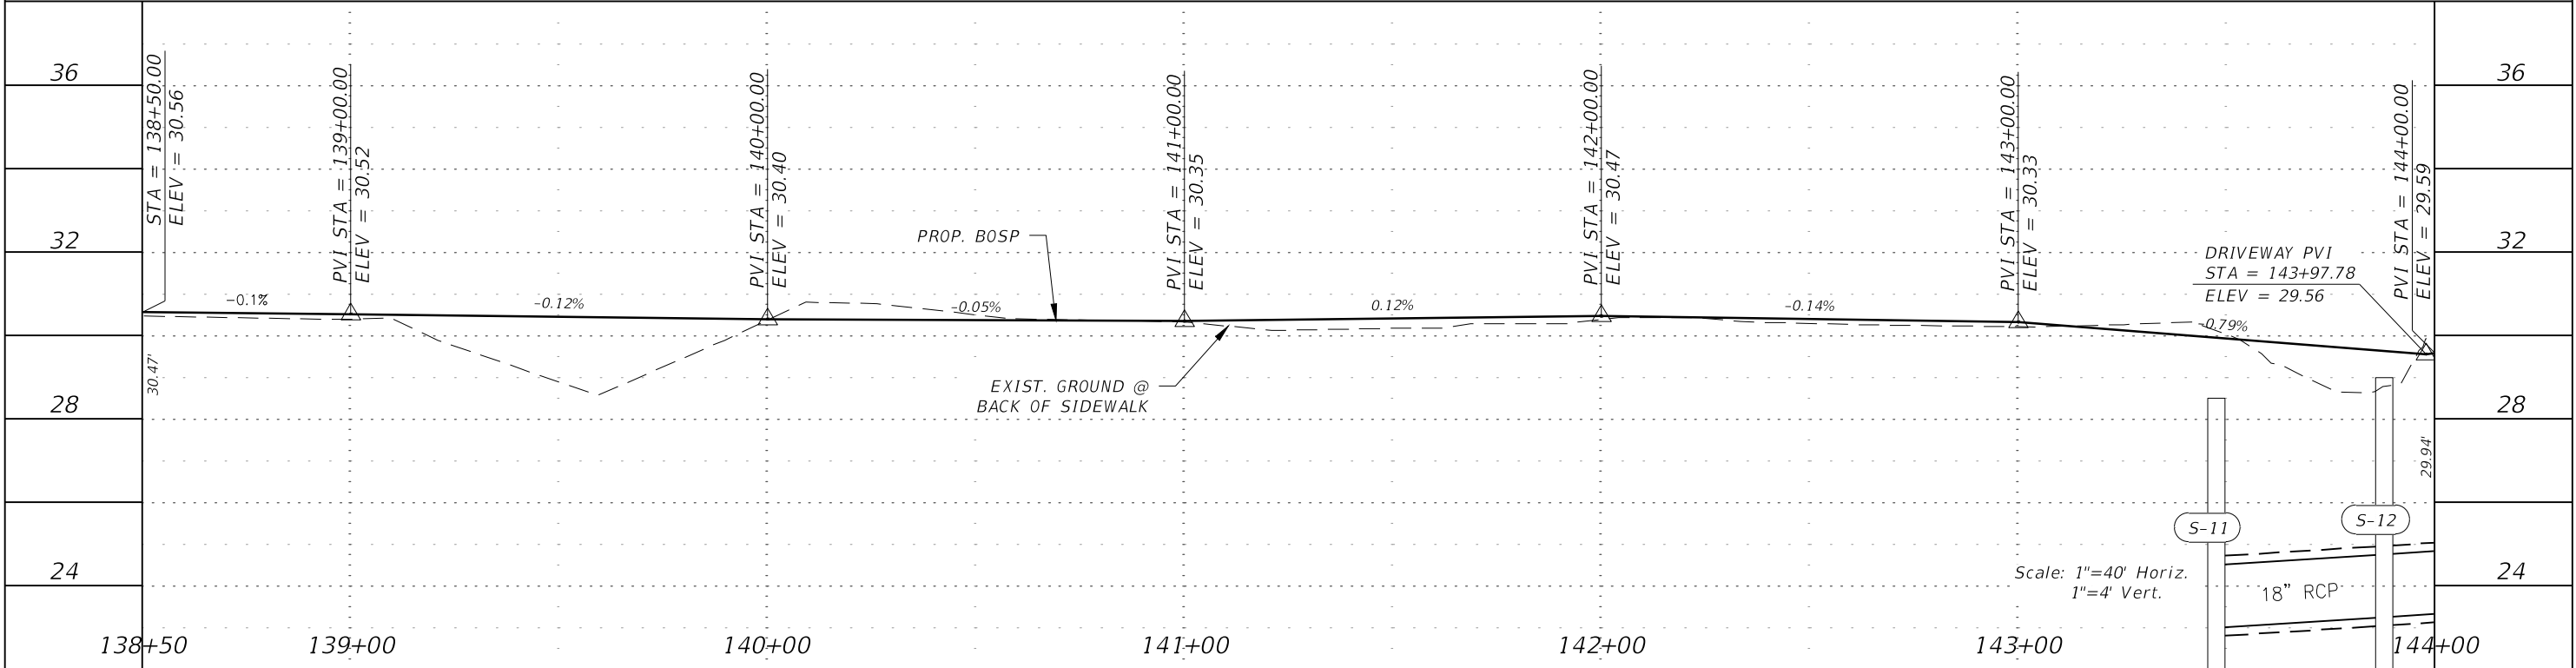
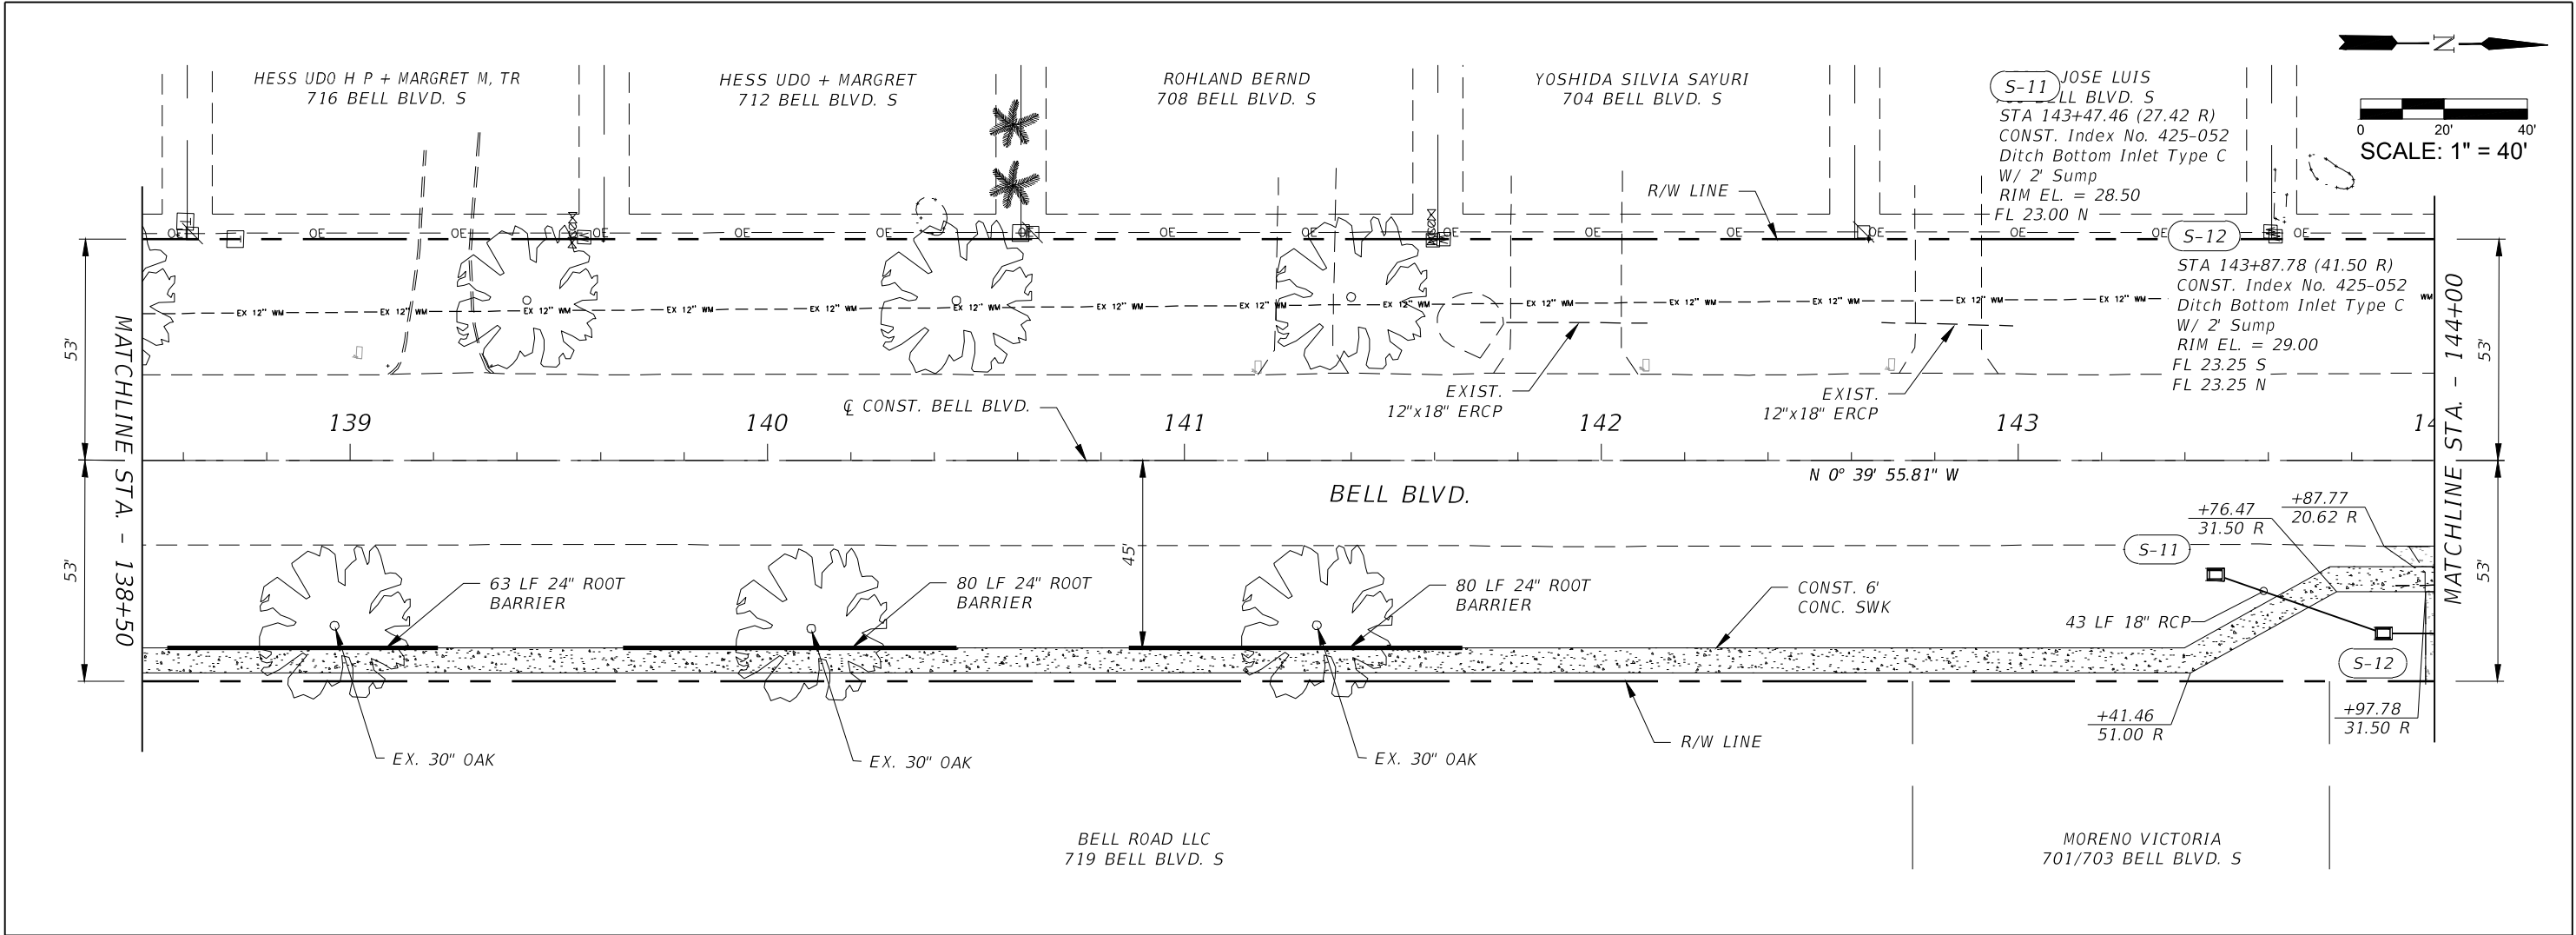


REVISIONS				<div><p>Q. Grady Minor and Associates, P.A. 3800 Via Del Rey Bonita Springs, Florida 34134 Phone: 239.947.1144 R. DANIEL FLYNN, P.E. NO. 76205</p><p><b>GradyMinor</b></p><p>Civil Engineers • Land Surveyors • Planners • Landscape Architects <small>Cert. of Auth. EB 0005151    Cert. of Auth. LB 0005151    Business LC 26000266</small></p></div>	<b>LEE COUNTY</b>		<b>ROADWAY PLAN &amp; PROFILE</b> <b>STA. 138+50 TO STA. 144+00</b>	SHEET NO.
DATE	DESCRIPTION	DATE	DESCRIPTION		ROAD NO.	COUNTY PROJECT NO.		
					BELL BLVD. SR 82 TO SUNRISE BLVD. SIDEWALK	6002		




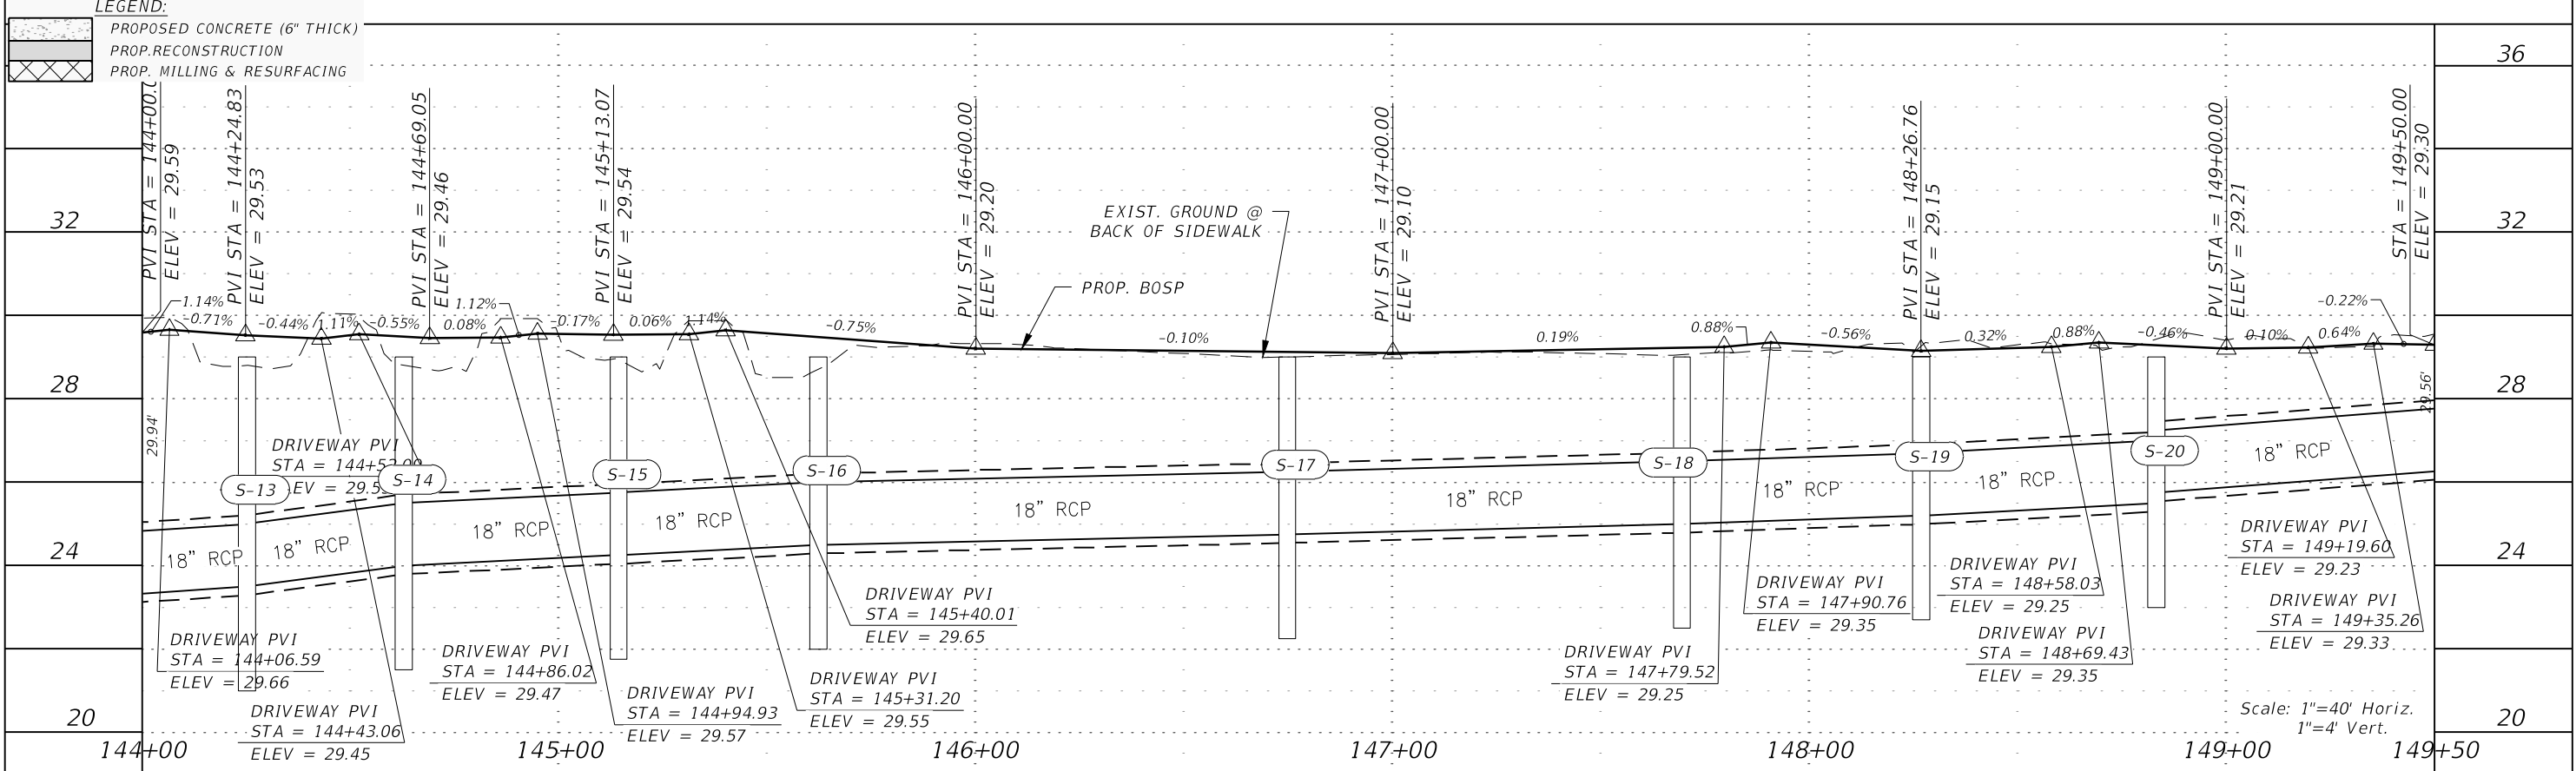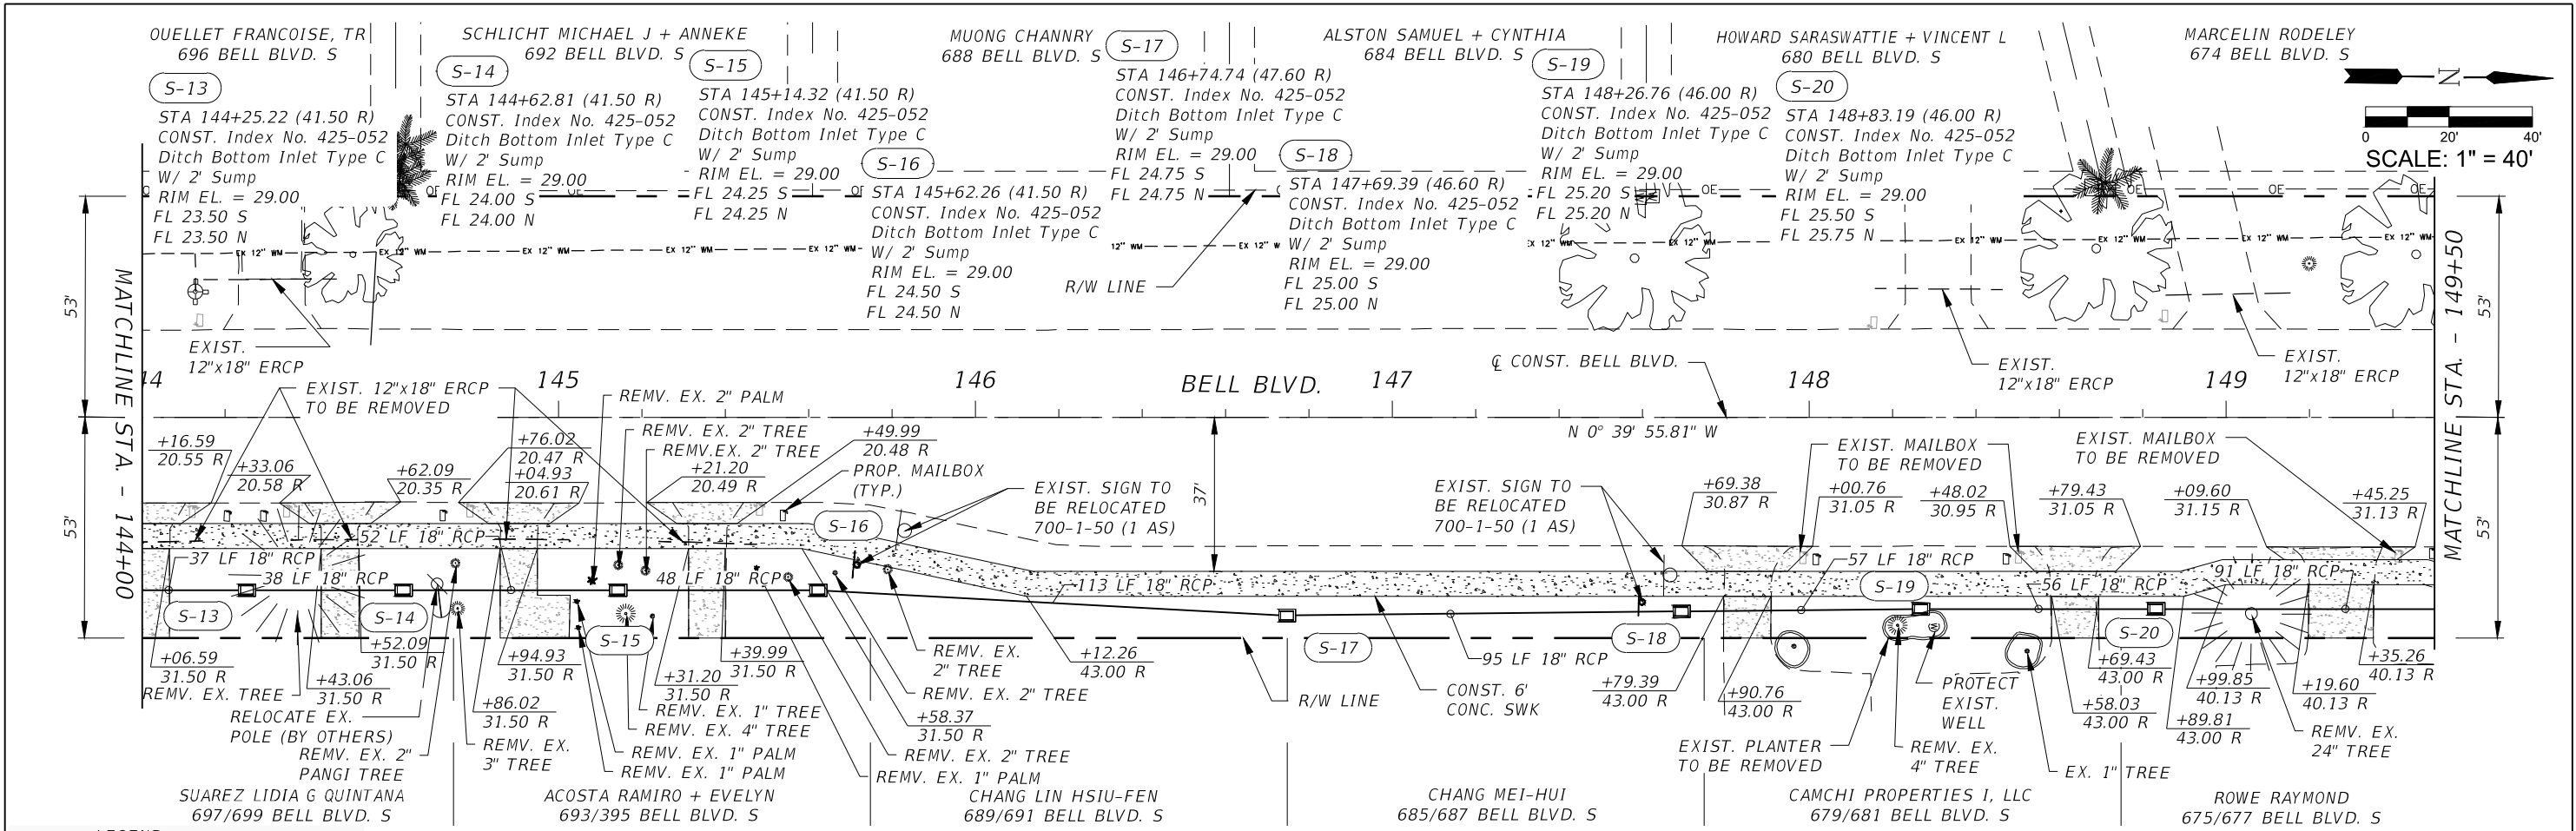

R E V I S I O N S				<div></div> <div>Q. Grady Minor and Associates, P.A. 3800 Via Del Rey Bonita Springs, Florida 34134 Phone: 239.947.1144 R. DANIEL FLYNN, P.E. NO. 76205</div> <div>GradyMinor</div> <div><div>Civil Engineers</div><div>• Land Surveyors • Planners • Landscape Architects</div><div><small>Cert. of Auth. EB 0005151      Cert. of Auth. LB 0005151      Business Lic. 26000266</small></div></div>	LEE COUNTY		ROADWAY PLAN & PROFILE STA. 144+00 TO STA. 149+50	SHEET NO.
DATE	DESCRIPTION	DATE	DESCRIPTION		ROAD NO.	COUNTY PROJECT NO.		51
					BELL BLVD. SR 82 TO SUNRISE BLVD. SIDEWALK	6002		

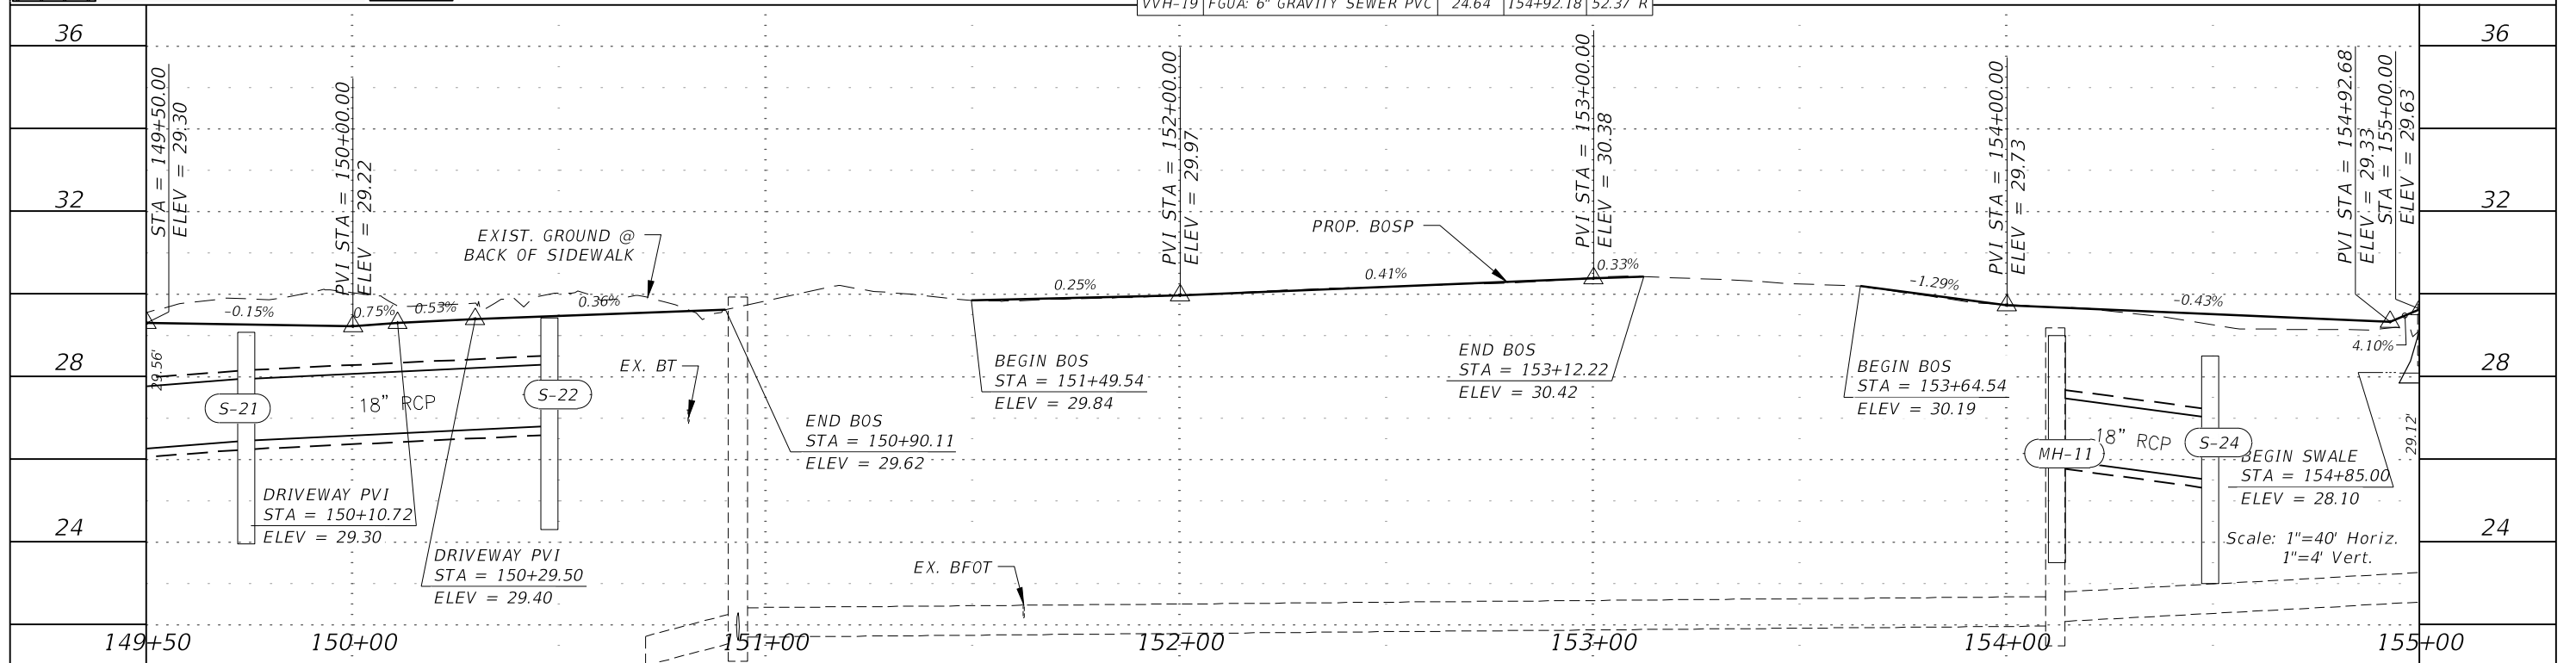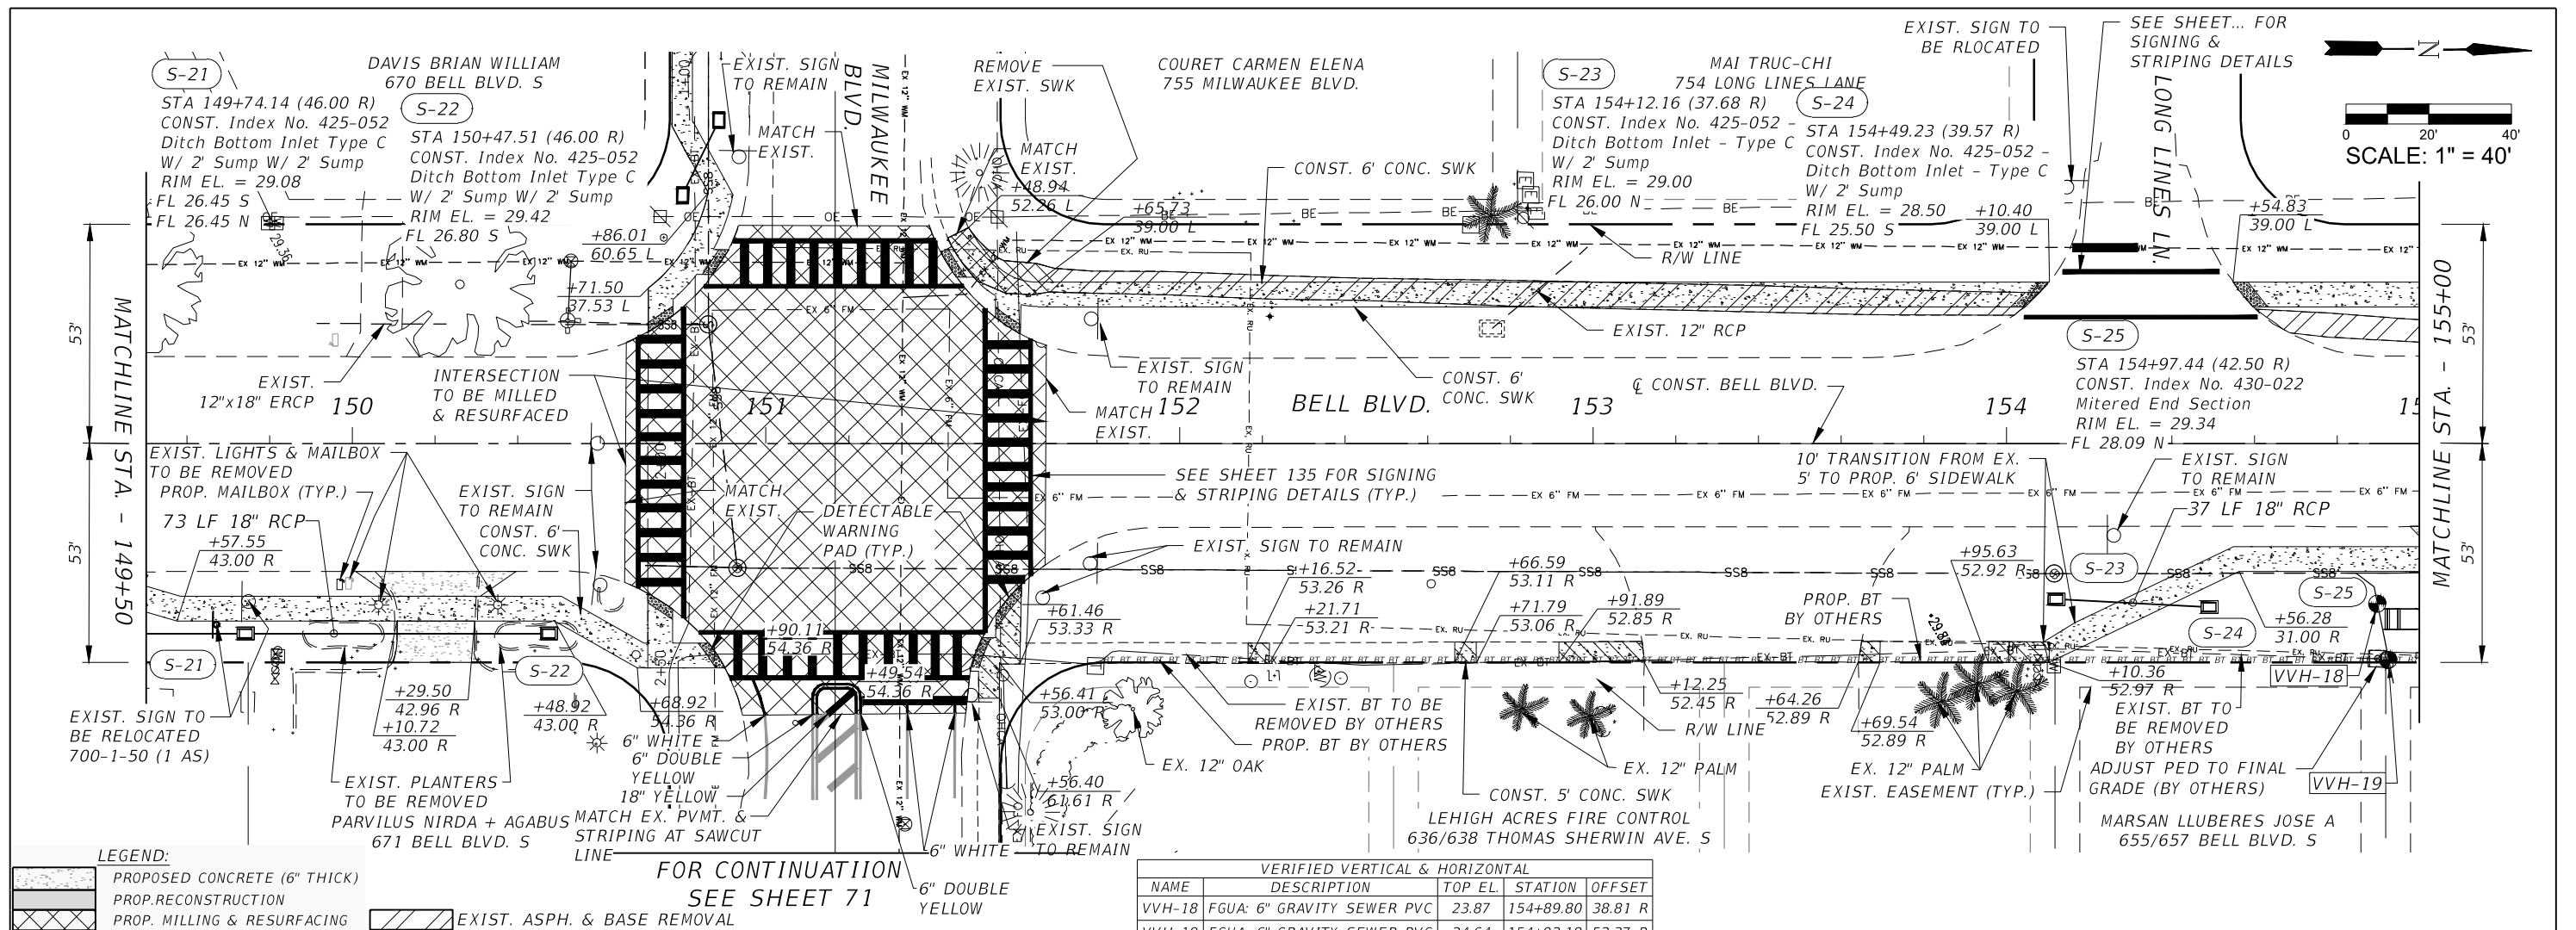



REVISIONS				 <div>Q. Grady Minor and Associates, P.A. 3800 Via Del Rey Bonita Springs, Florida 34134 Phone: 239.947.1144 R. DANIEL FLYNN, P.E. NO. 76205</div> <div>GradyMinor Civil Engineers • Land Surveyors • Planners • Landscape Architects <small>CERT. OF AUTH. EB 0005151    CERT. OF AUTH. LB 0005151    BUSINESS LC 26000266</small></div>	LEE COUNTY		ROADWAY PLAN & PROFILE STA. 149+50 TO STA. 155+00	SHEET NO.  52
DATE	DESCRIPTION	DATE	DESCRIPTION		ROAD NO.	COUNTY PROJECT NO.		
				BELL BLVD. SR 82 TO SUNRISE BLVD. SIDEWALK	6002			

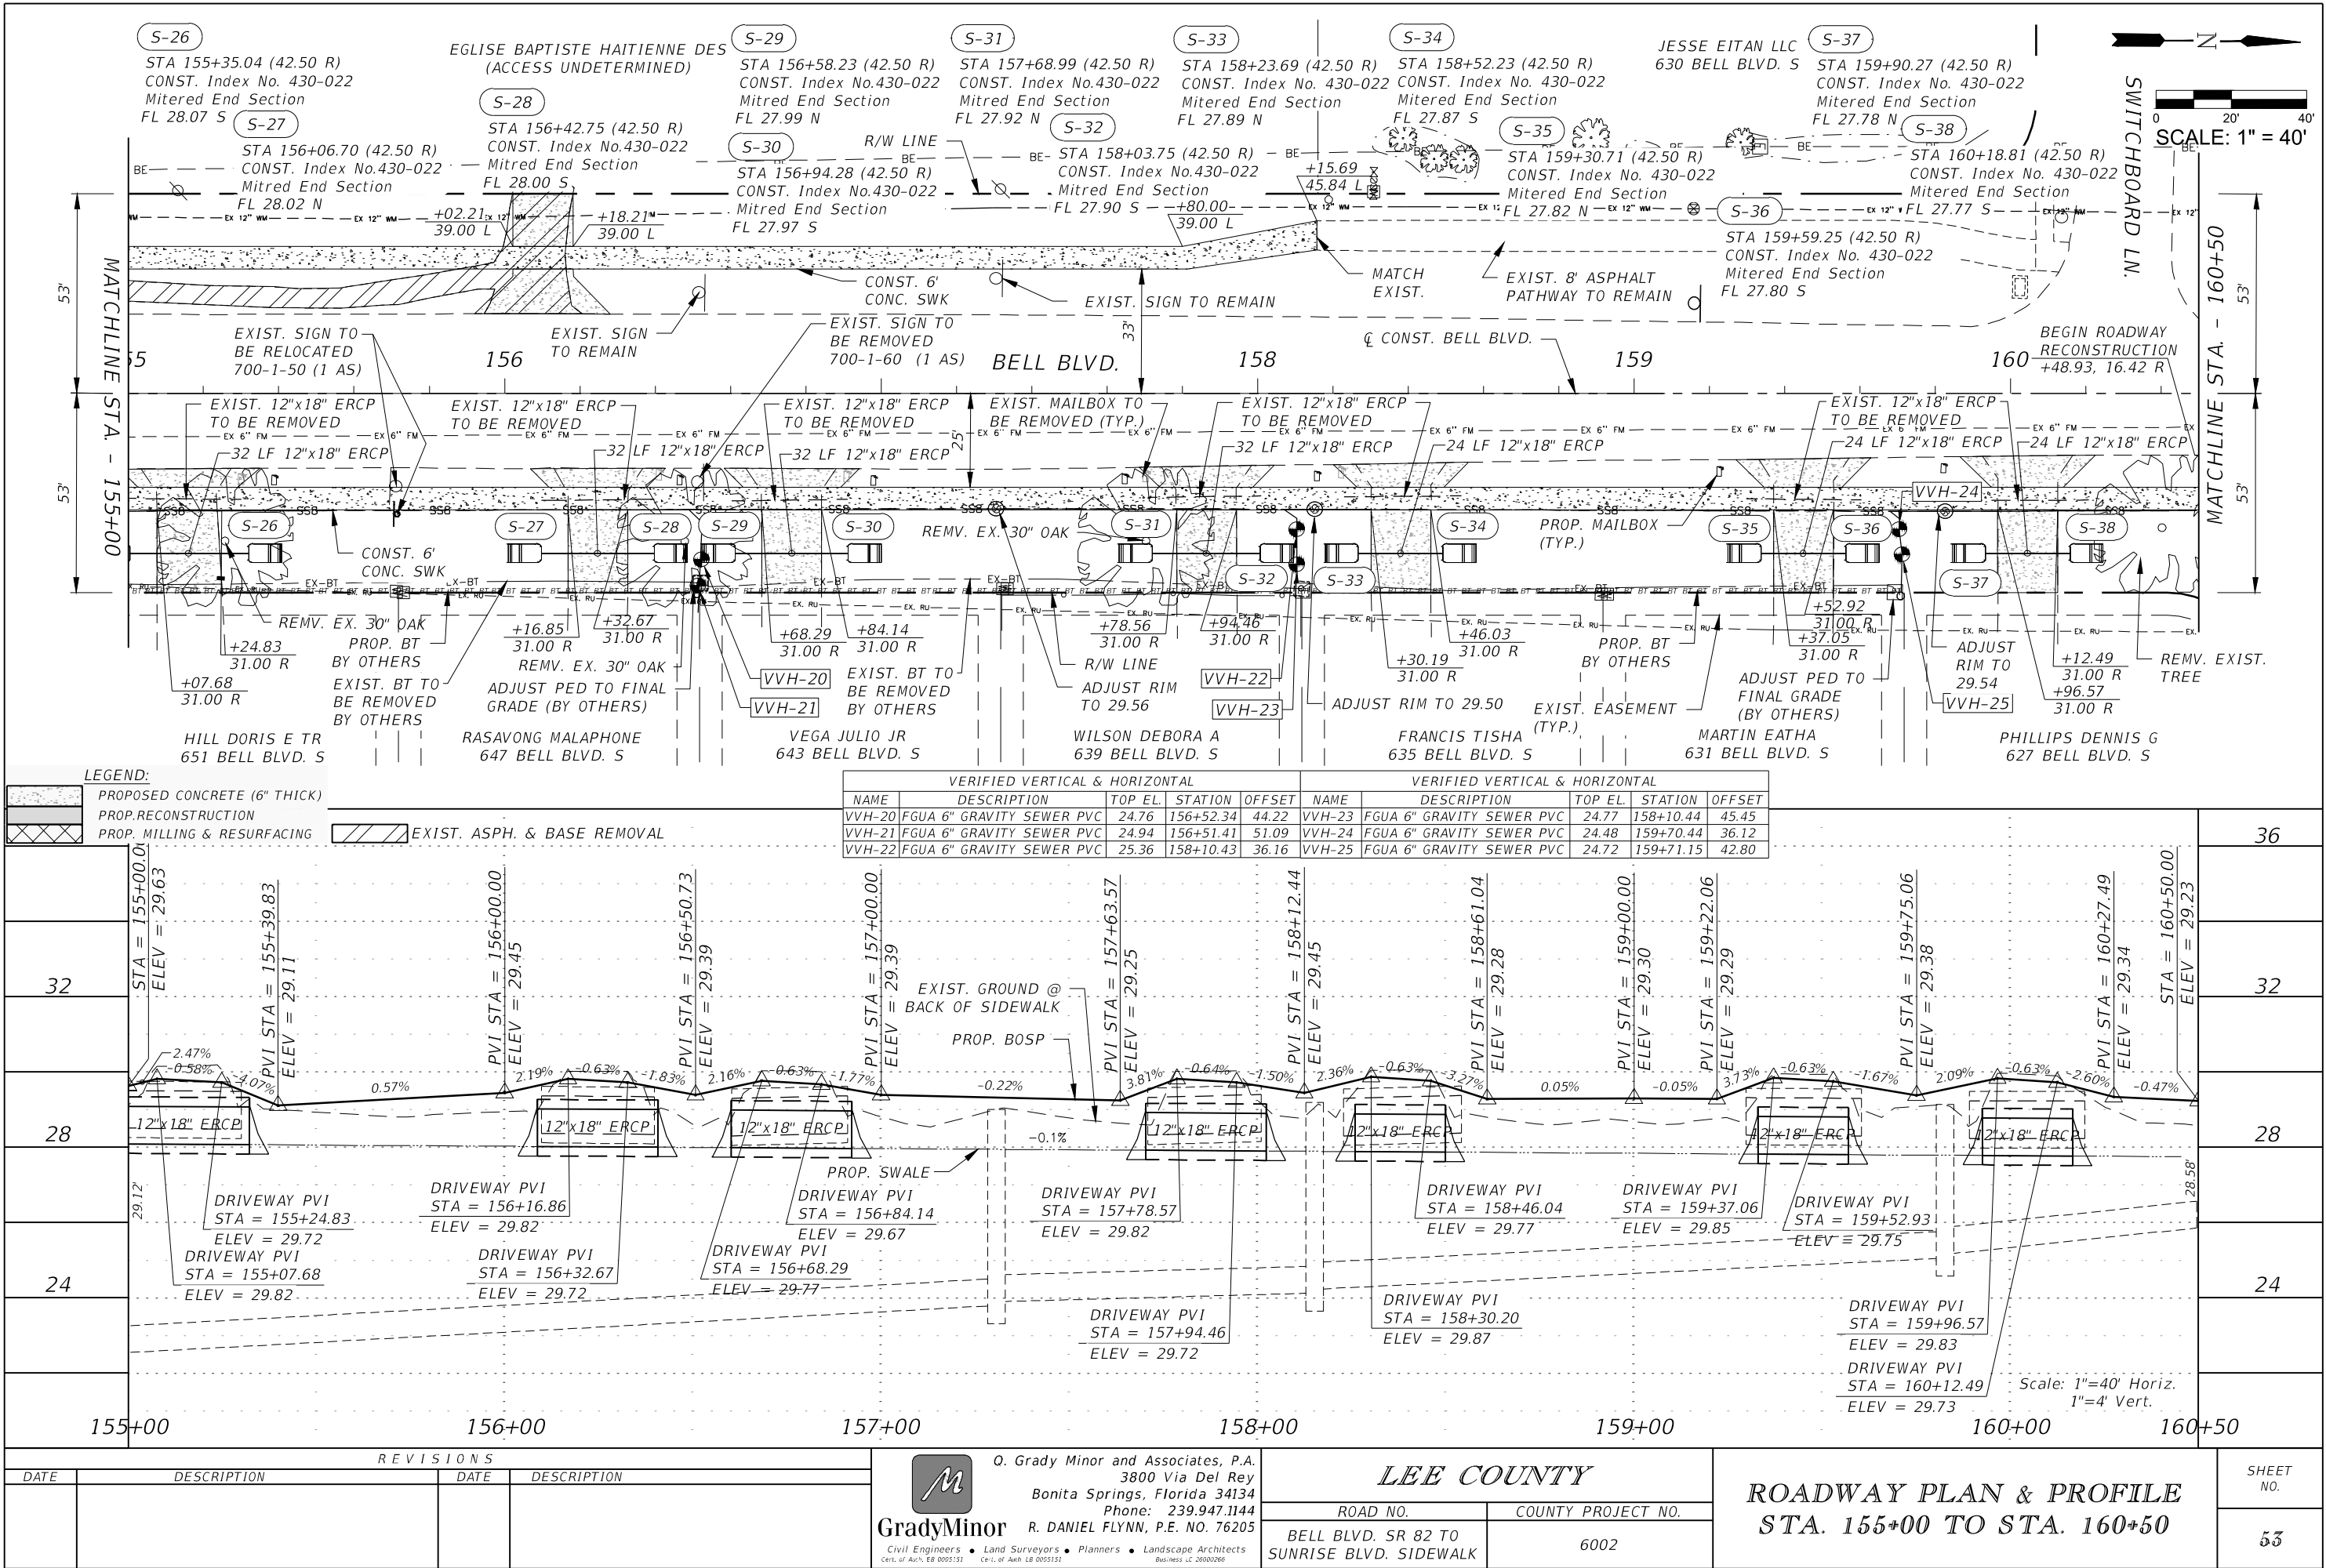





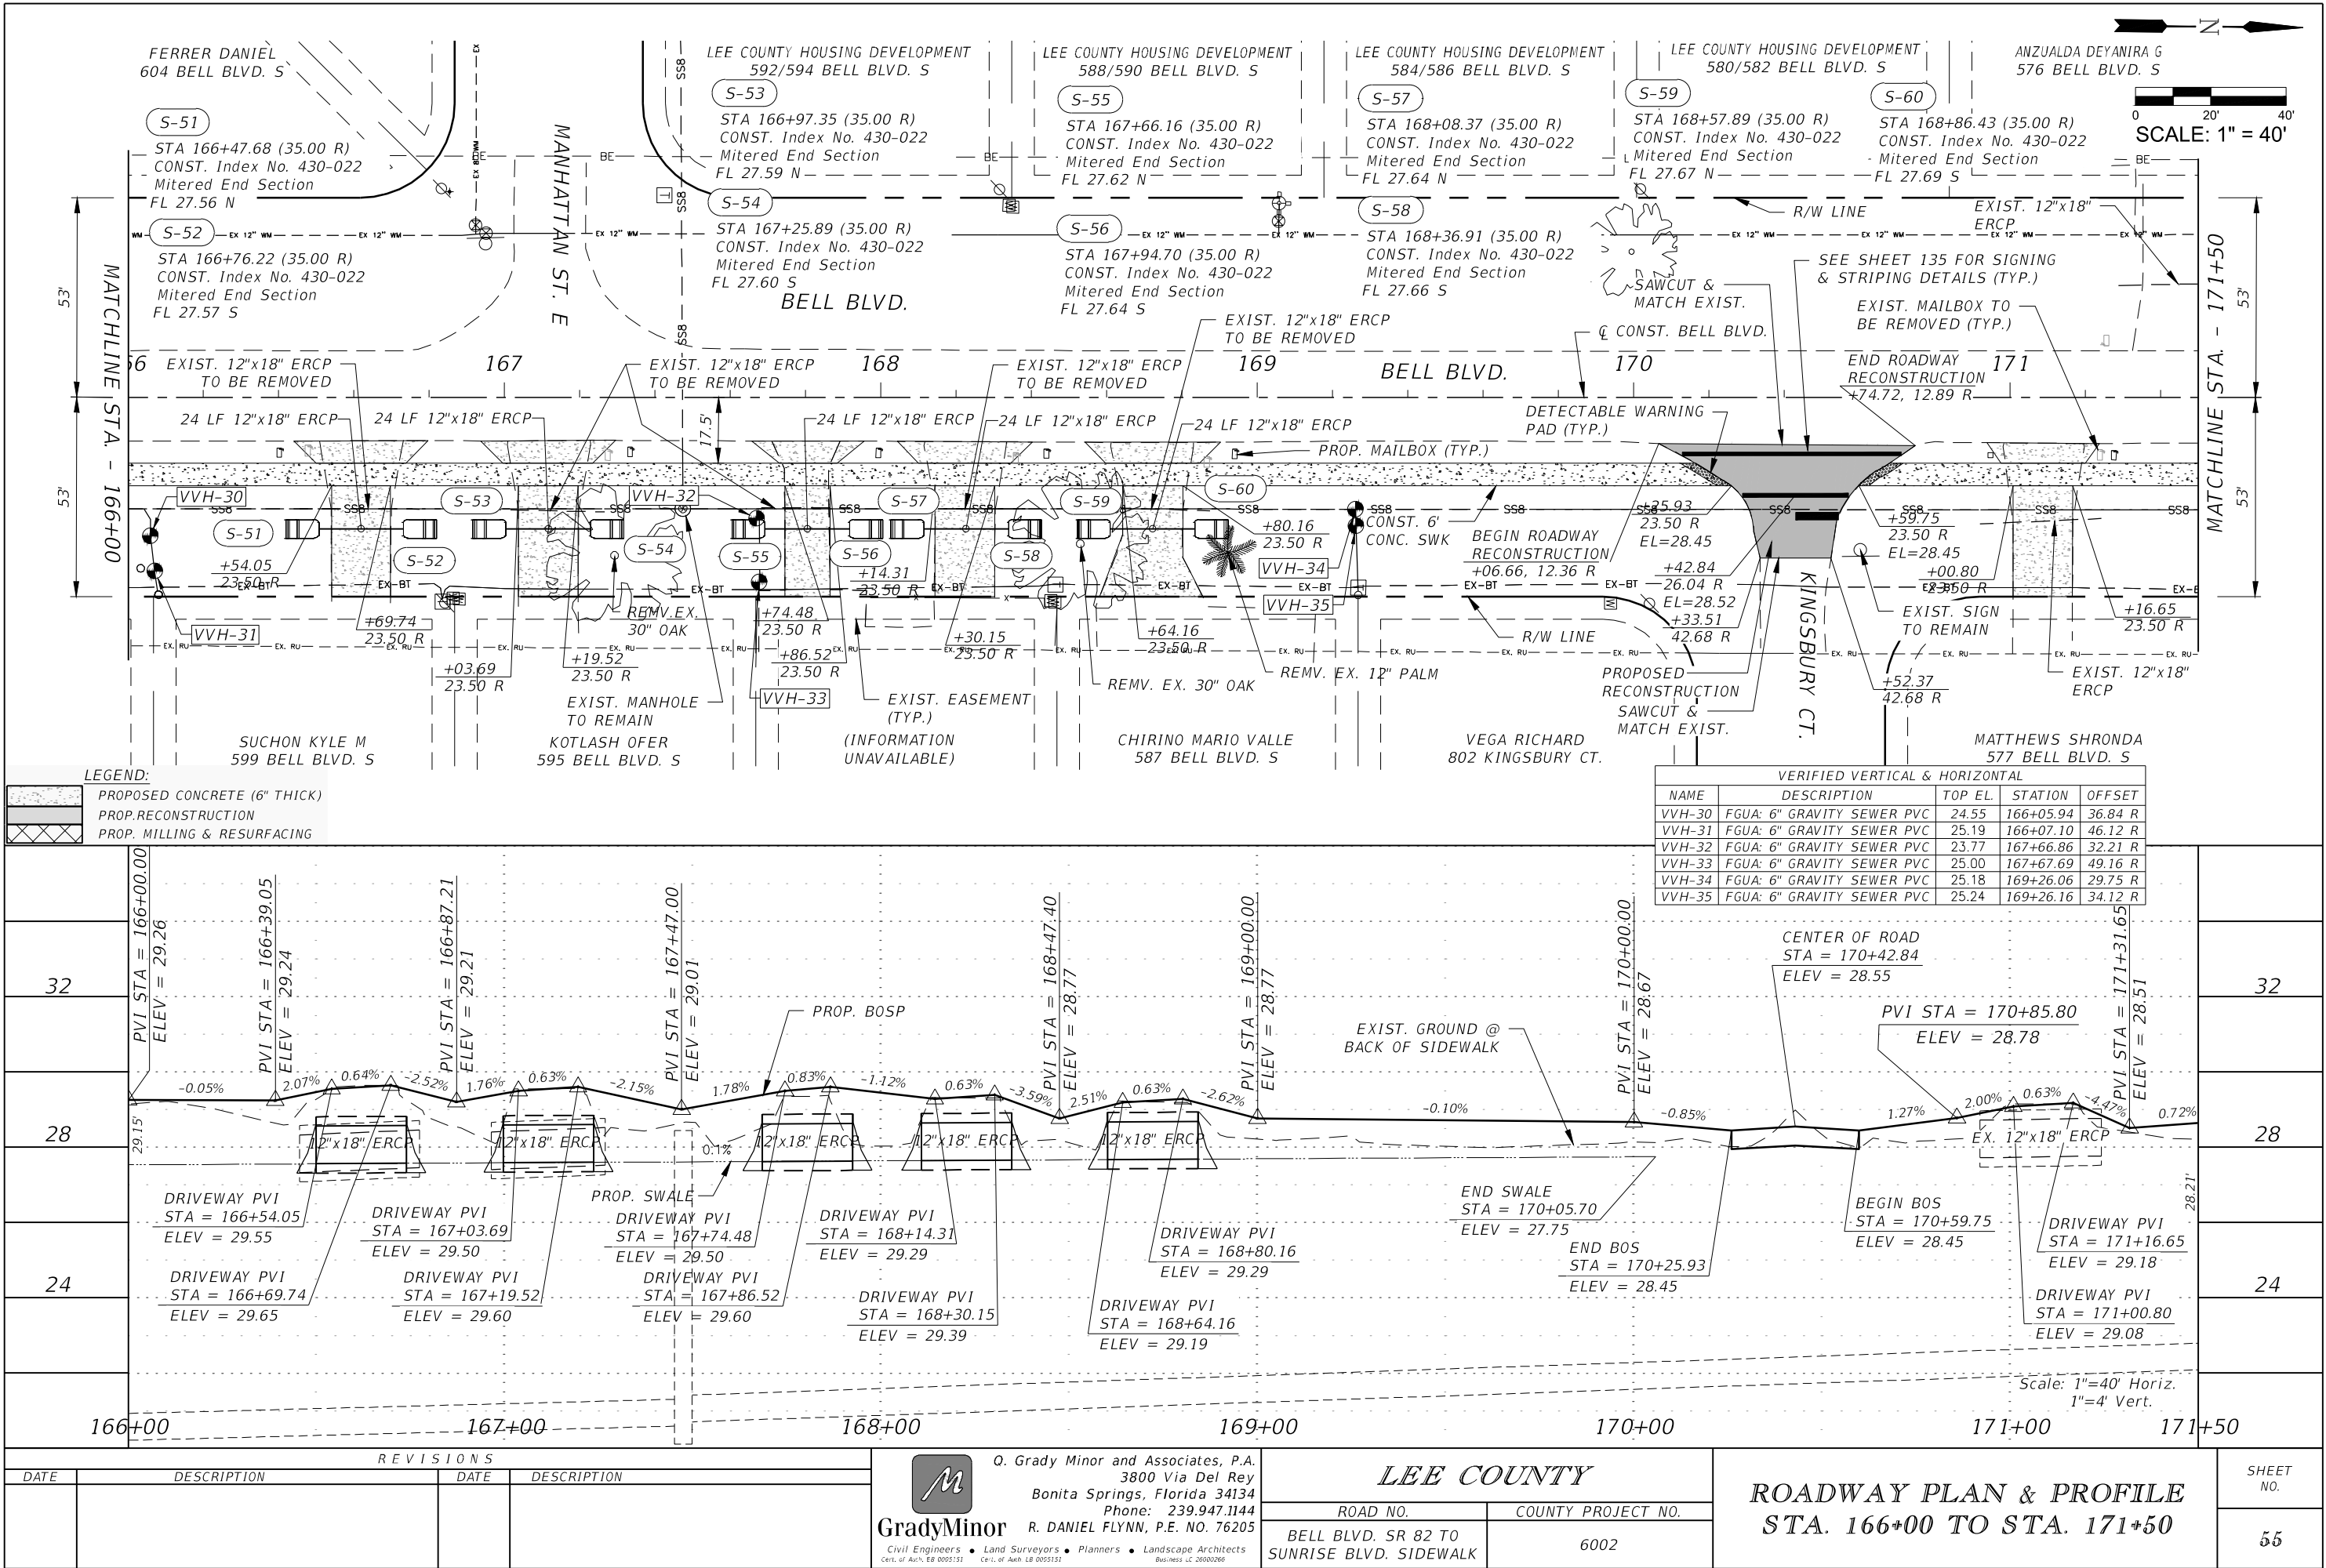

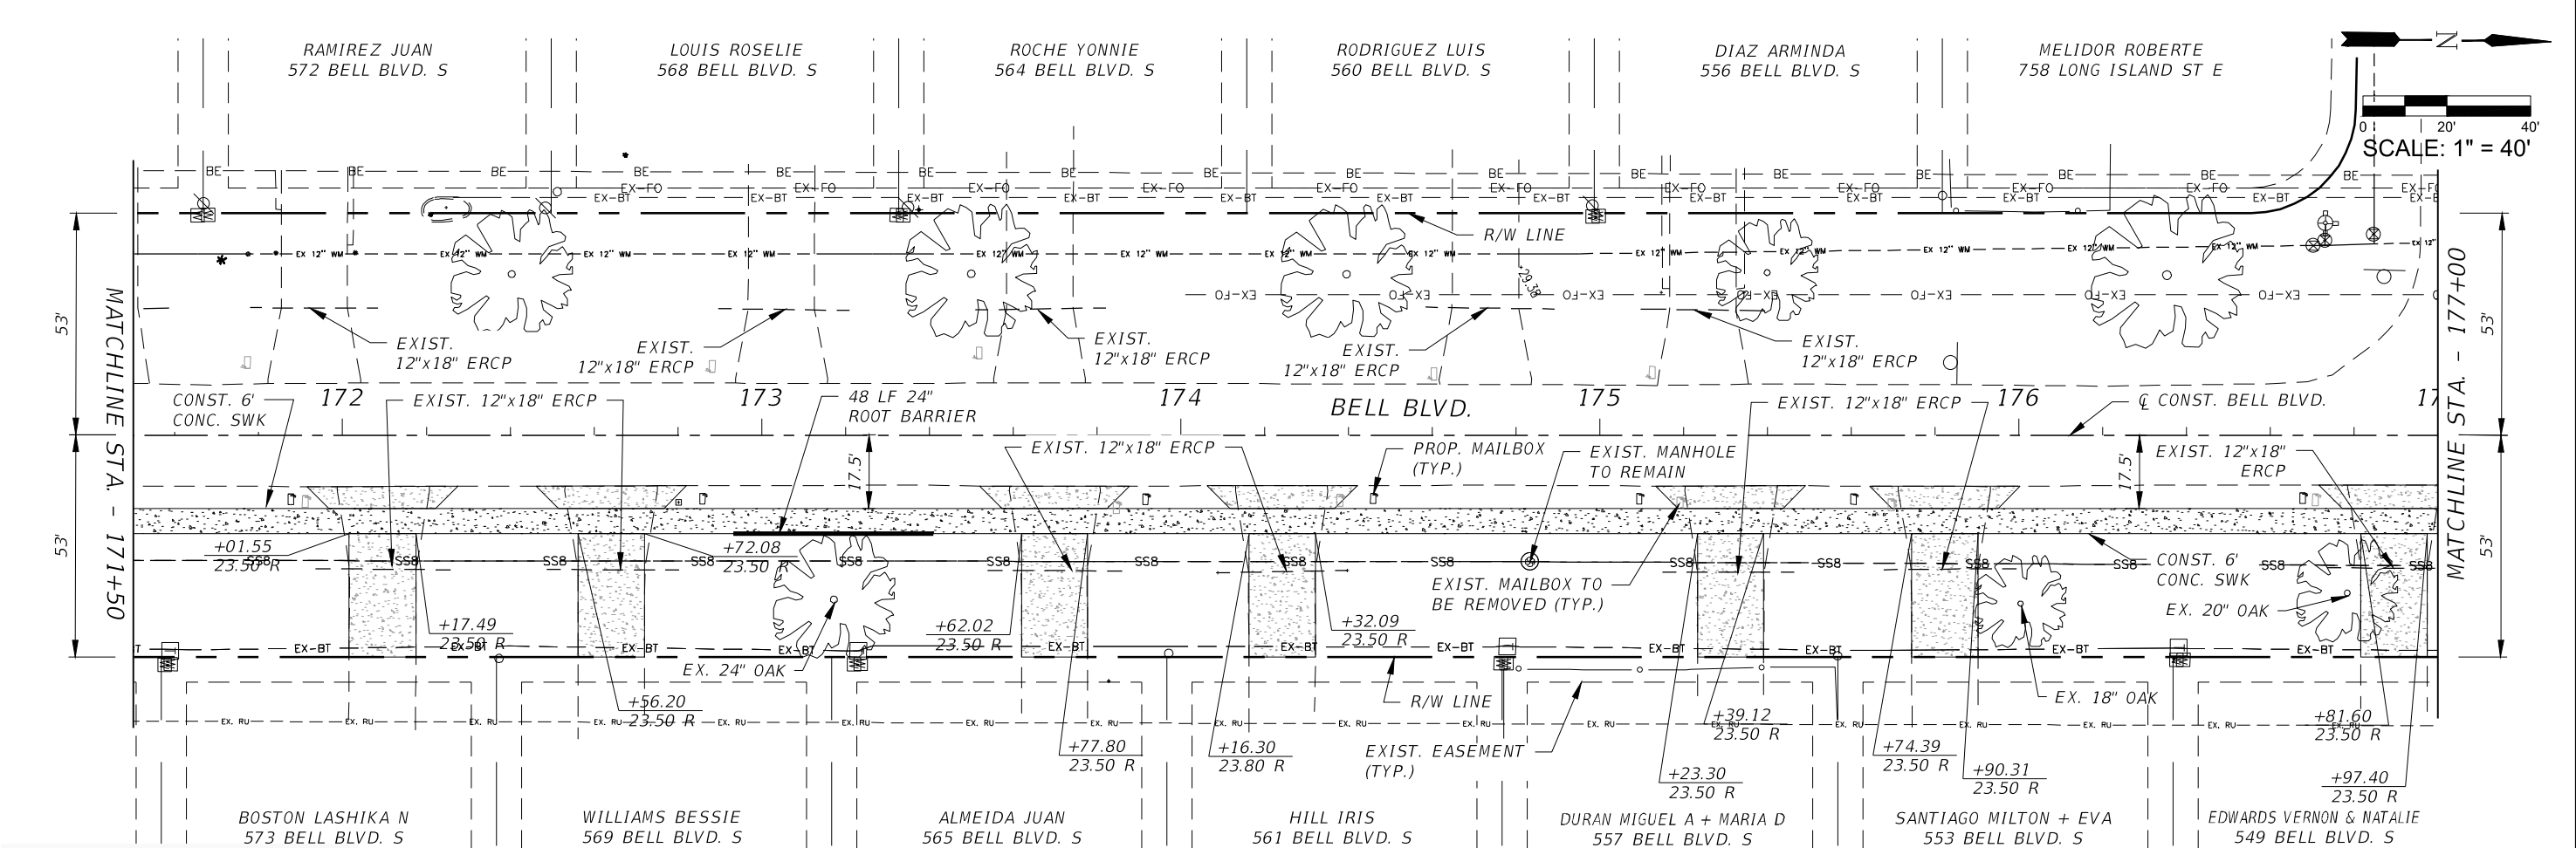


LEGEND:

PROPOSED CONCRETE (6" THICK)


PROP. RECONSTRUCTION

PROP. MILLING & RESURFACING

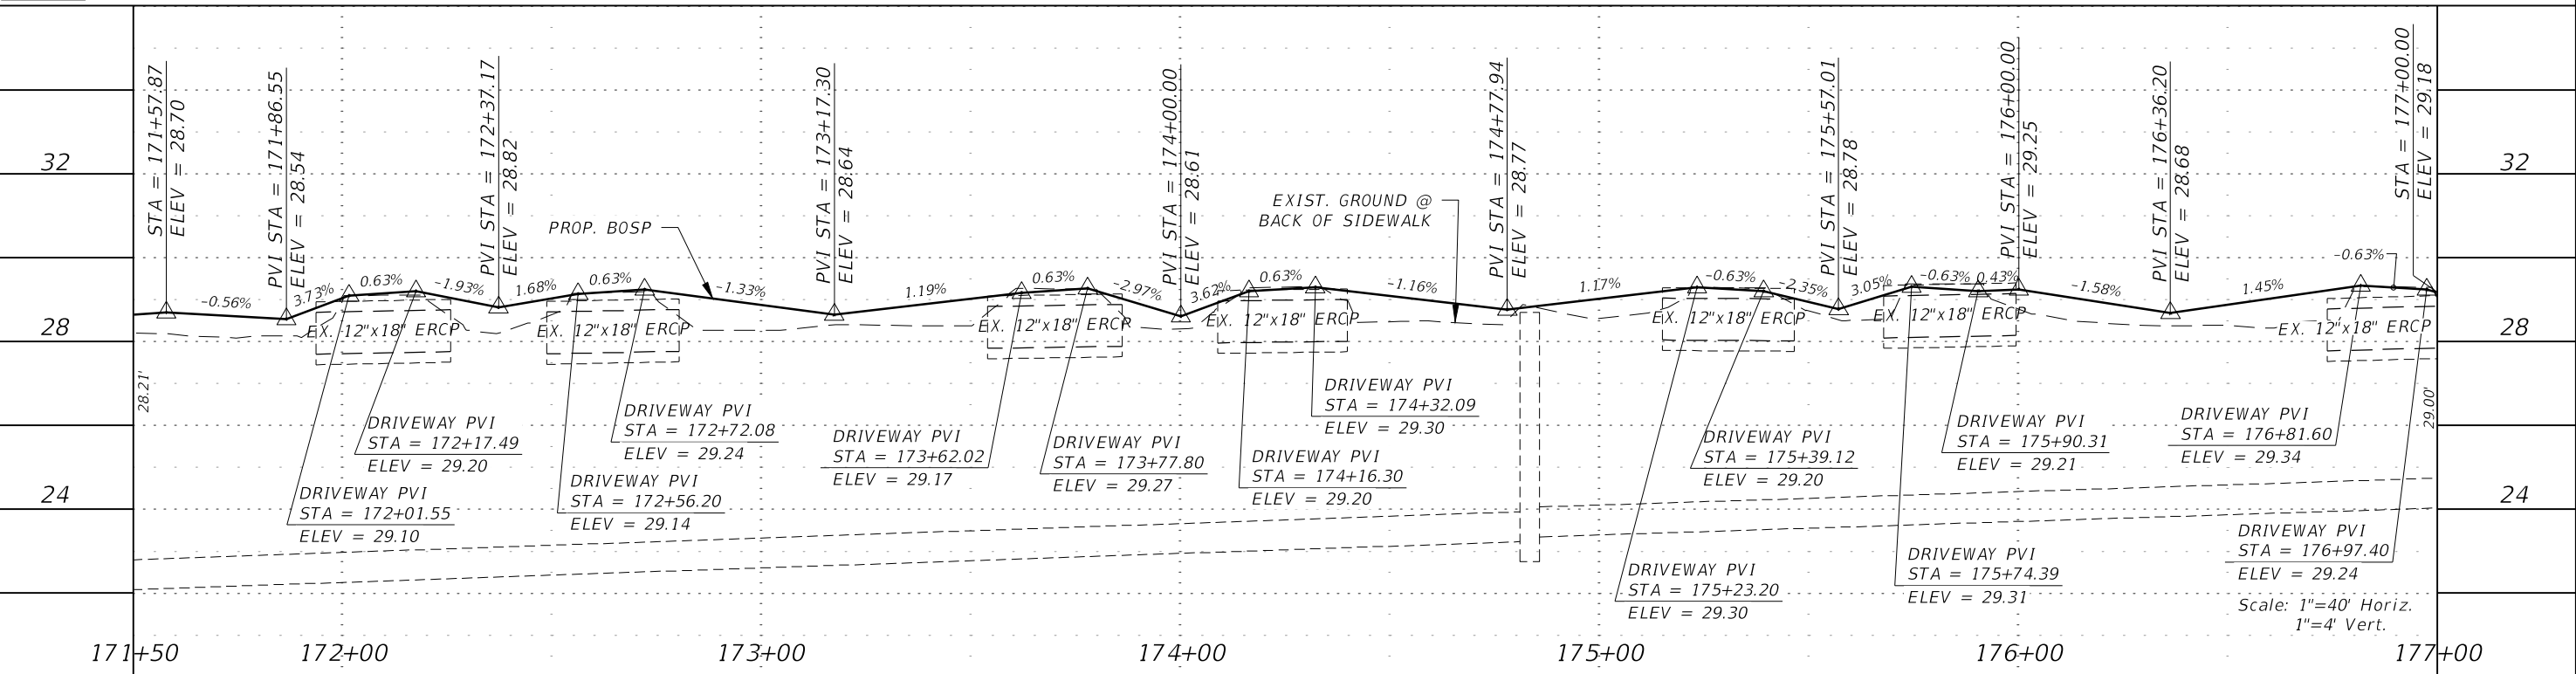


REVISIONS				<div><p>Q. Grady Minor and Associates, P.A. 3800 Via Del Rey Bonita Springs, Florida 34134 Phone: 239.947.1144 R. DANIEL FLYNN, P.E. NO. 76205</p><p><b>GradyMinor</b> Civil Engineers • Land Surveyors • Planners • Landscape Architects <small>CERT. OF AUTH. EB 0005131    CERT. OF AUTH. LB 0005131    BUSINESS LIC. 26000266</small></p></div>	LEE COUNTY		ROADWAY PLAN & PROFILE STA. 171+50 TO STA. 177+00	SHEET NO.
DATE	DESCRIPTION	DATE	DESCRIPTION		ROAD NO.	COUNTY PROJECT NO.		
					BELL BLVD. SR 82 TO SUNRISE BLVD. SIDEWALK	6002		56




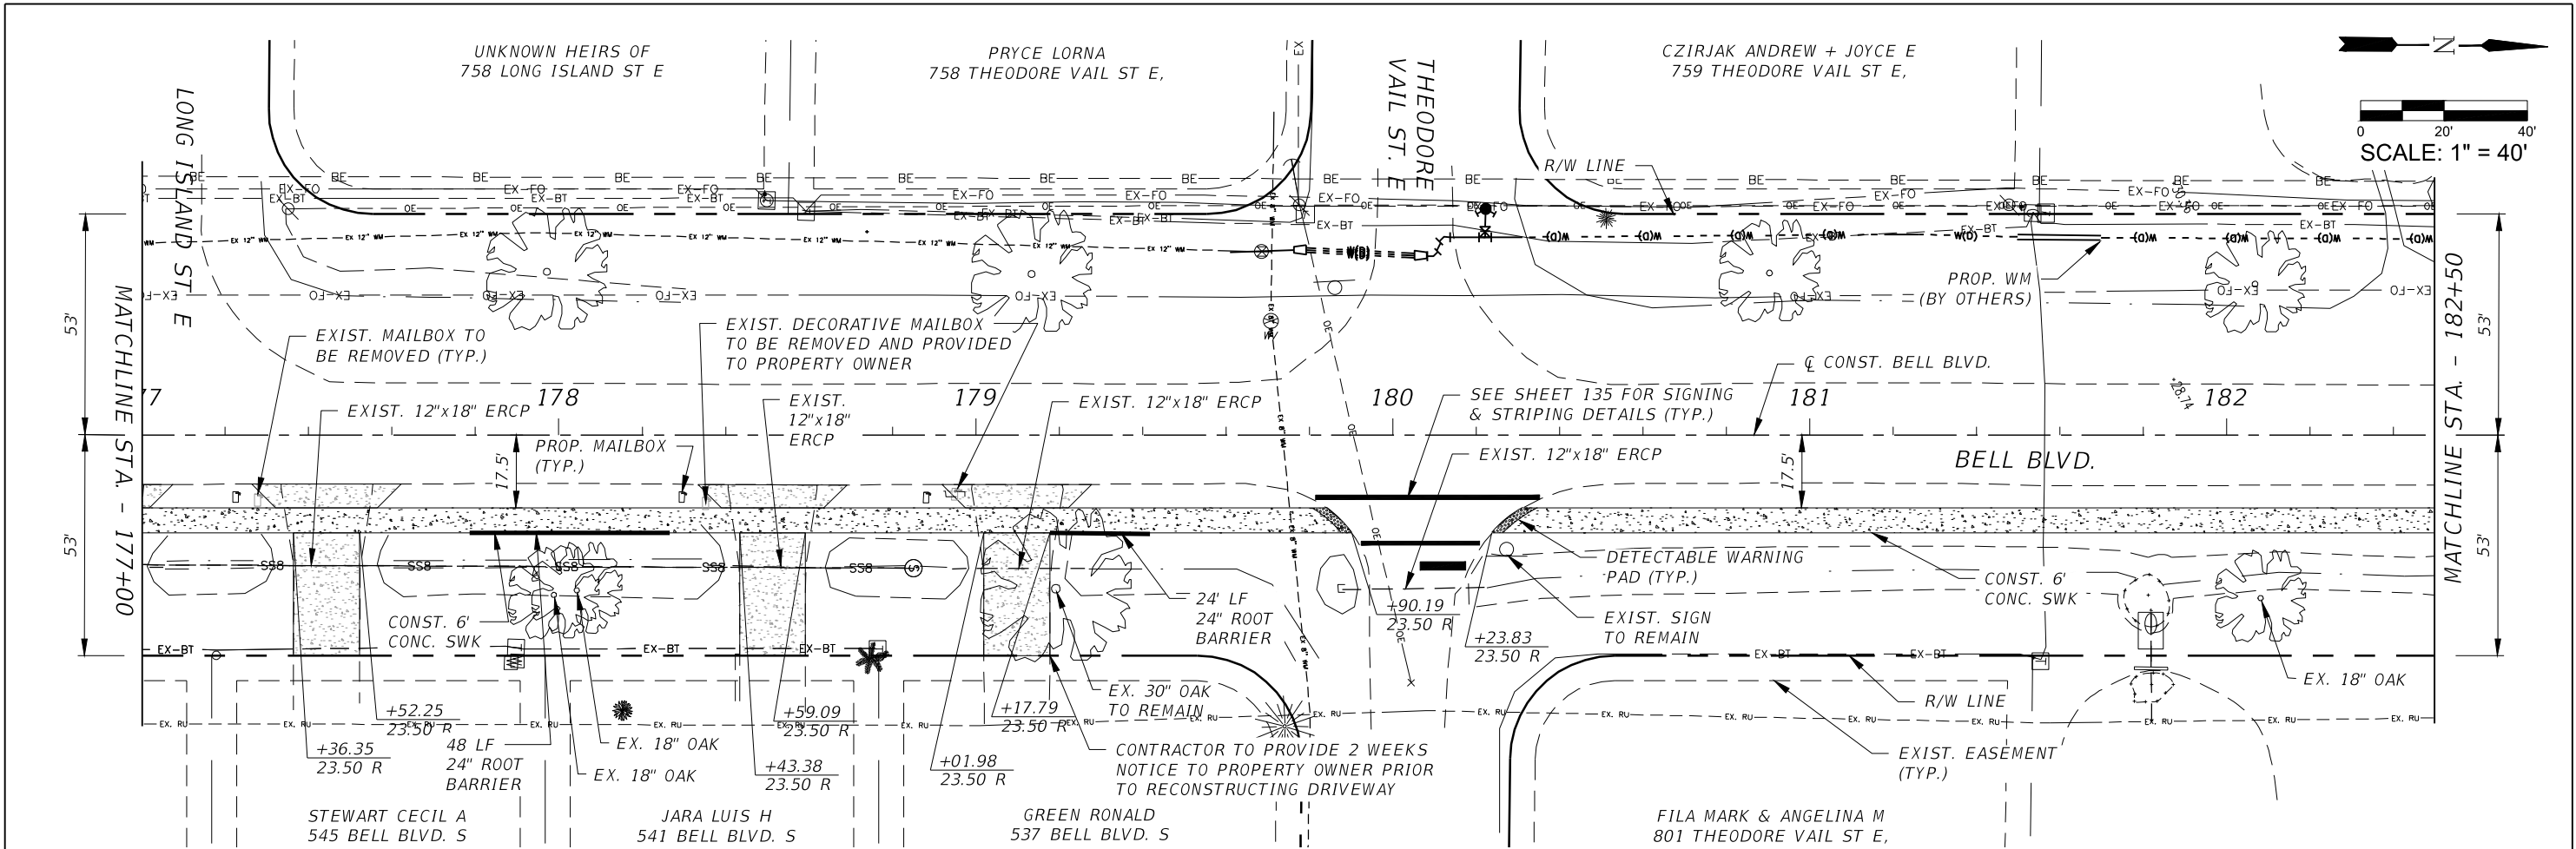


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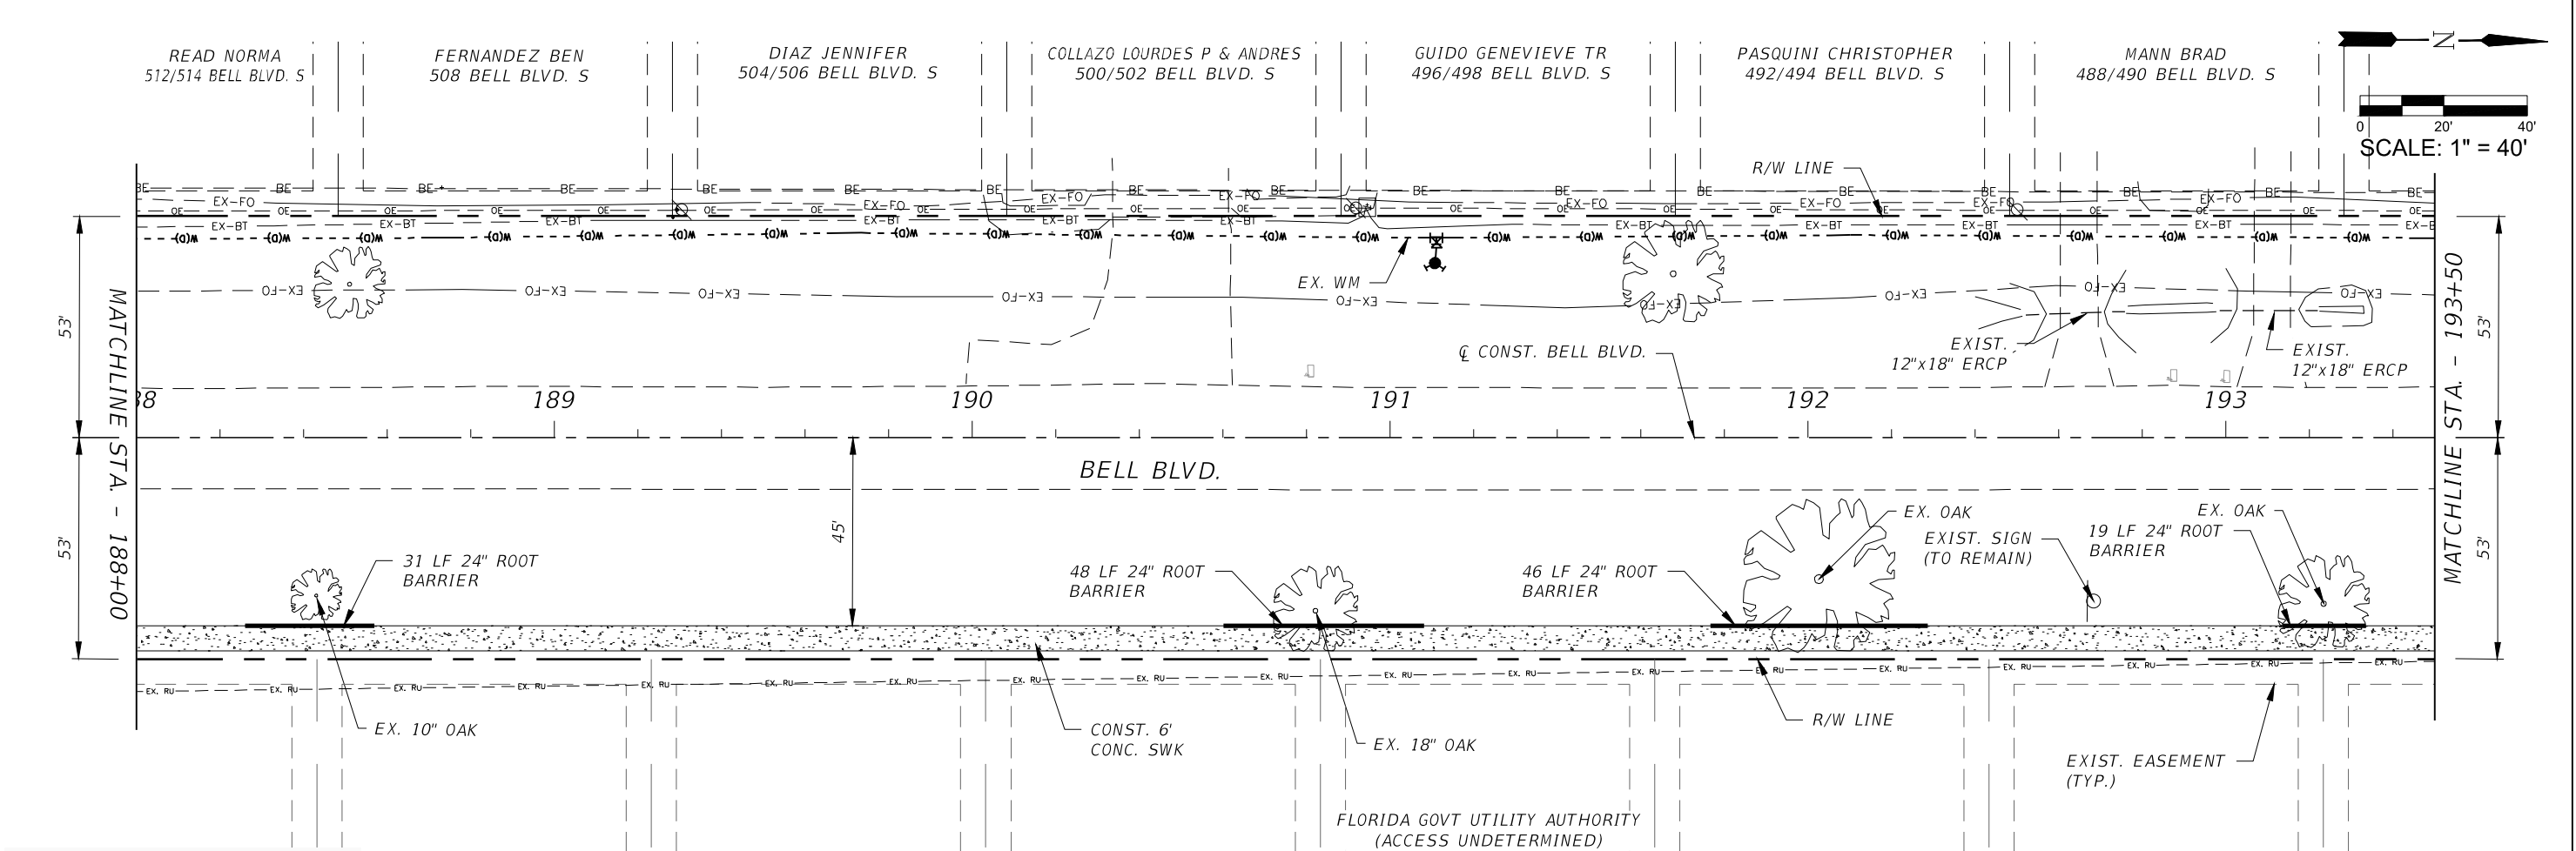
	PROPOSED CONCRETE (6' THICK)
	PROP. RECONSTRUCTION
	PROP. MILLING & RESURFACING

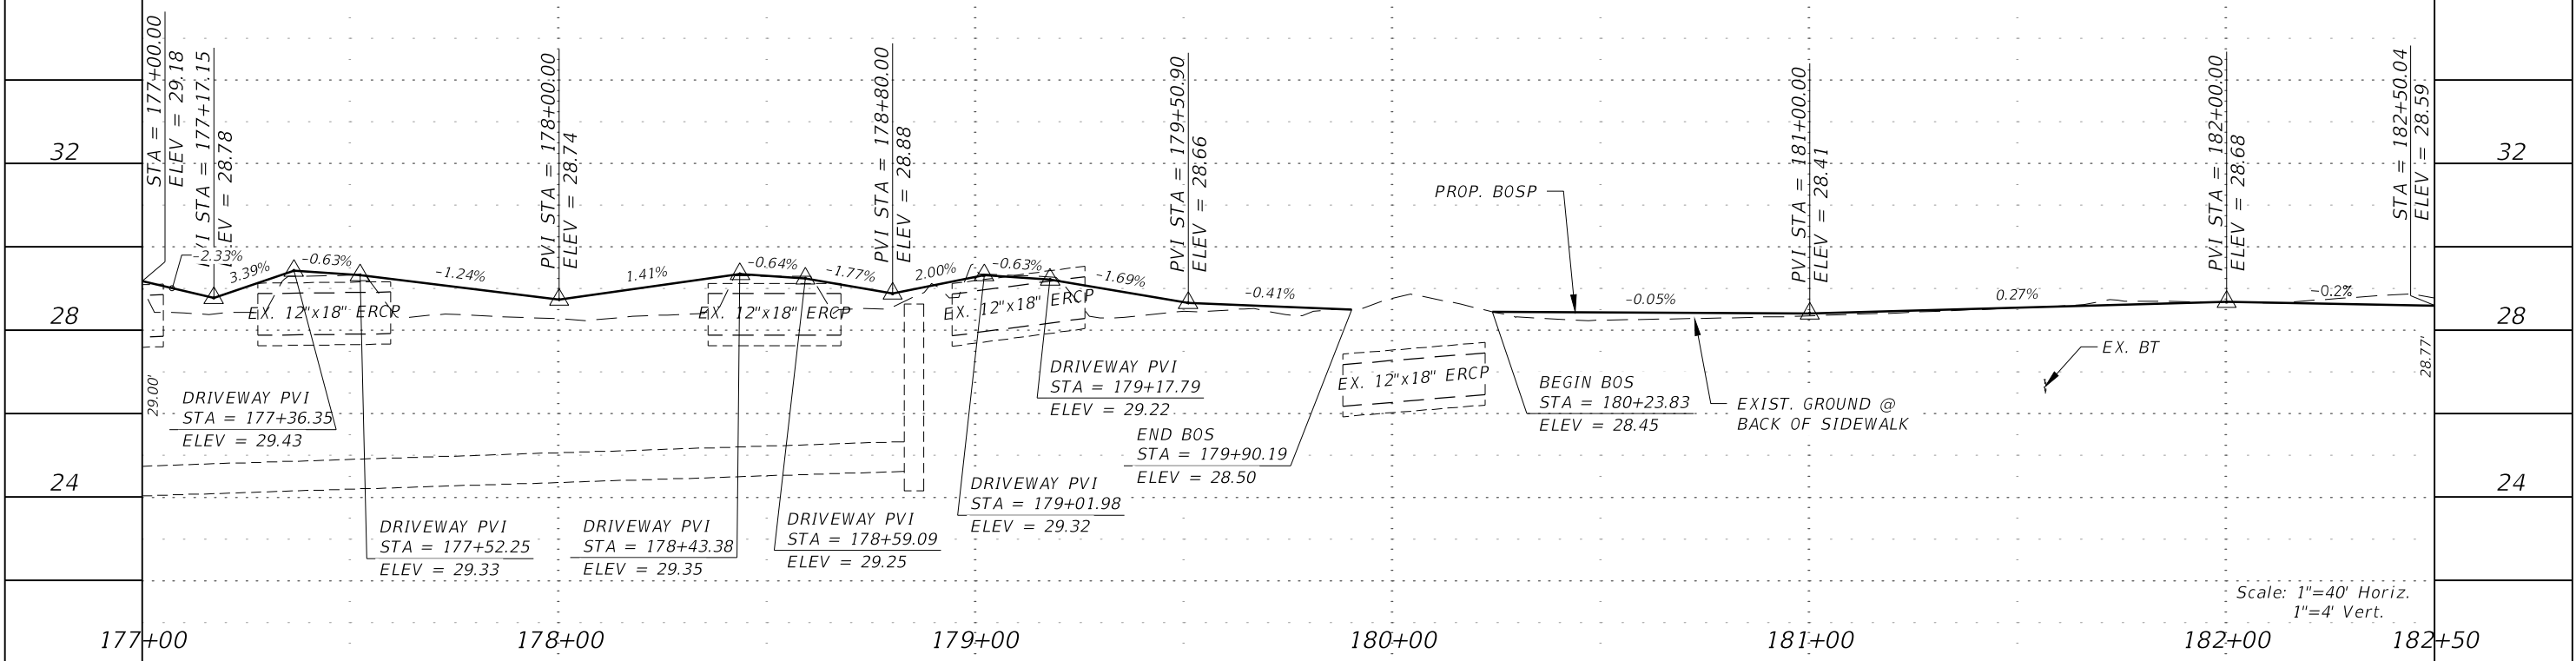

REVISIONS				 <div>Q. Grady Minor and Associates, P.A. 3800 Via Del Rey Bonita Springs, Florida 34134 Phone: 239.947.1144 R. DANIEL FLYNN, P.E. NO. 76205</div>	LEE COUNTY		ROADWAY PLAN & PROFILE STA. 177+00 TO STA. 182+50	SHEET NO.  57
DATE	DESCRIPTION	DATE	DESCRIPTION		ROAD NO.	COUNTY PROJECT NO.		
					BELL BLVD. SR 82 TO SUNRISE BLVD. SIDEWALK	6002		

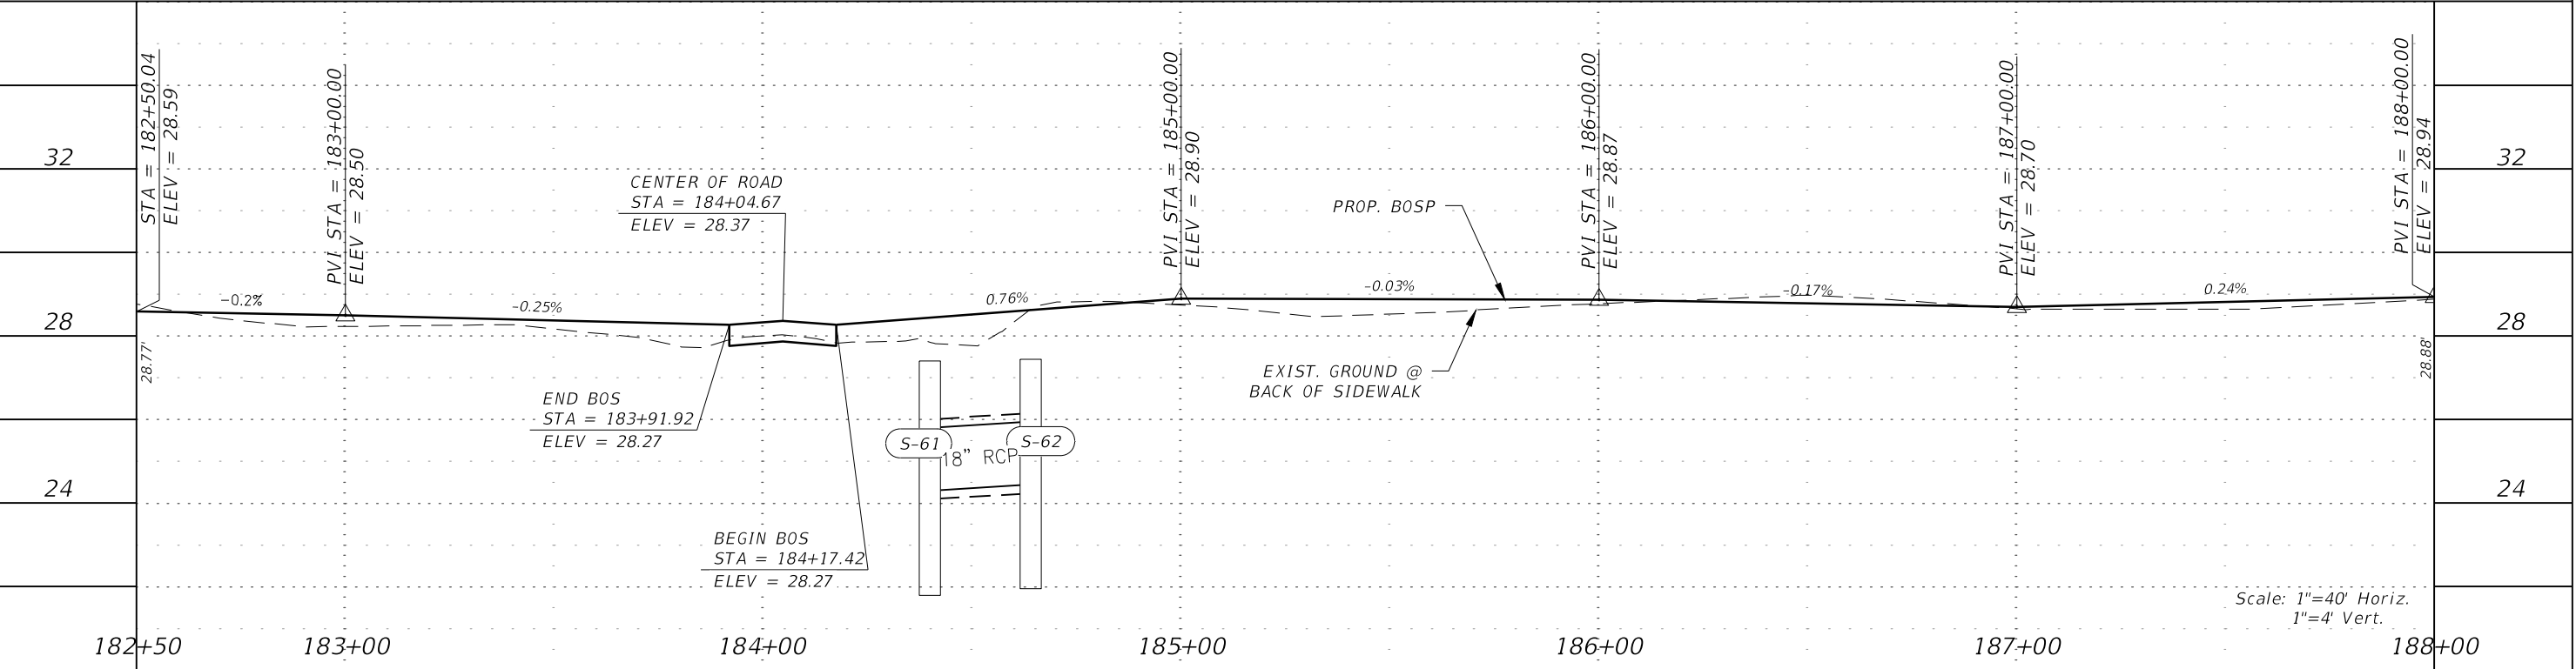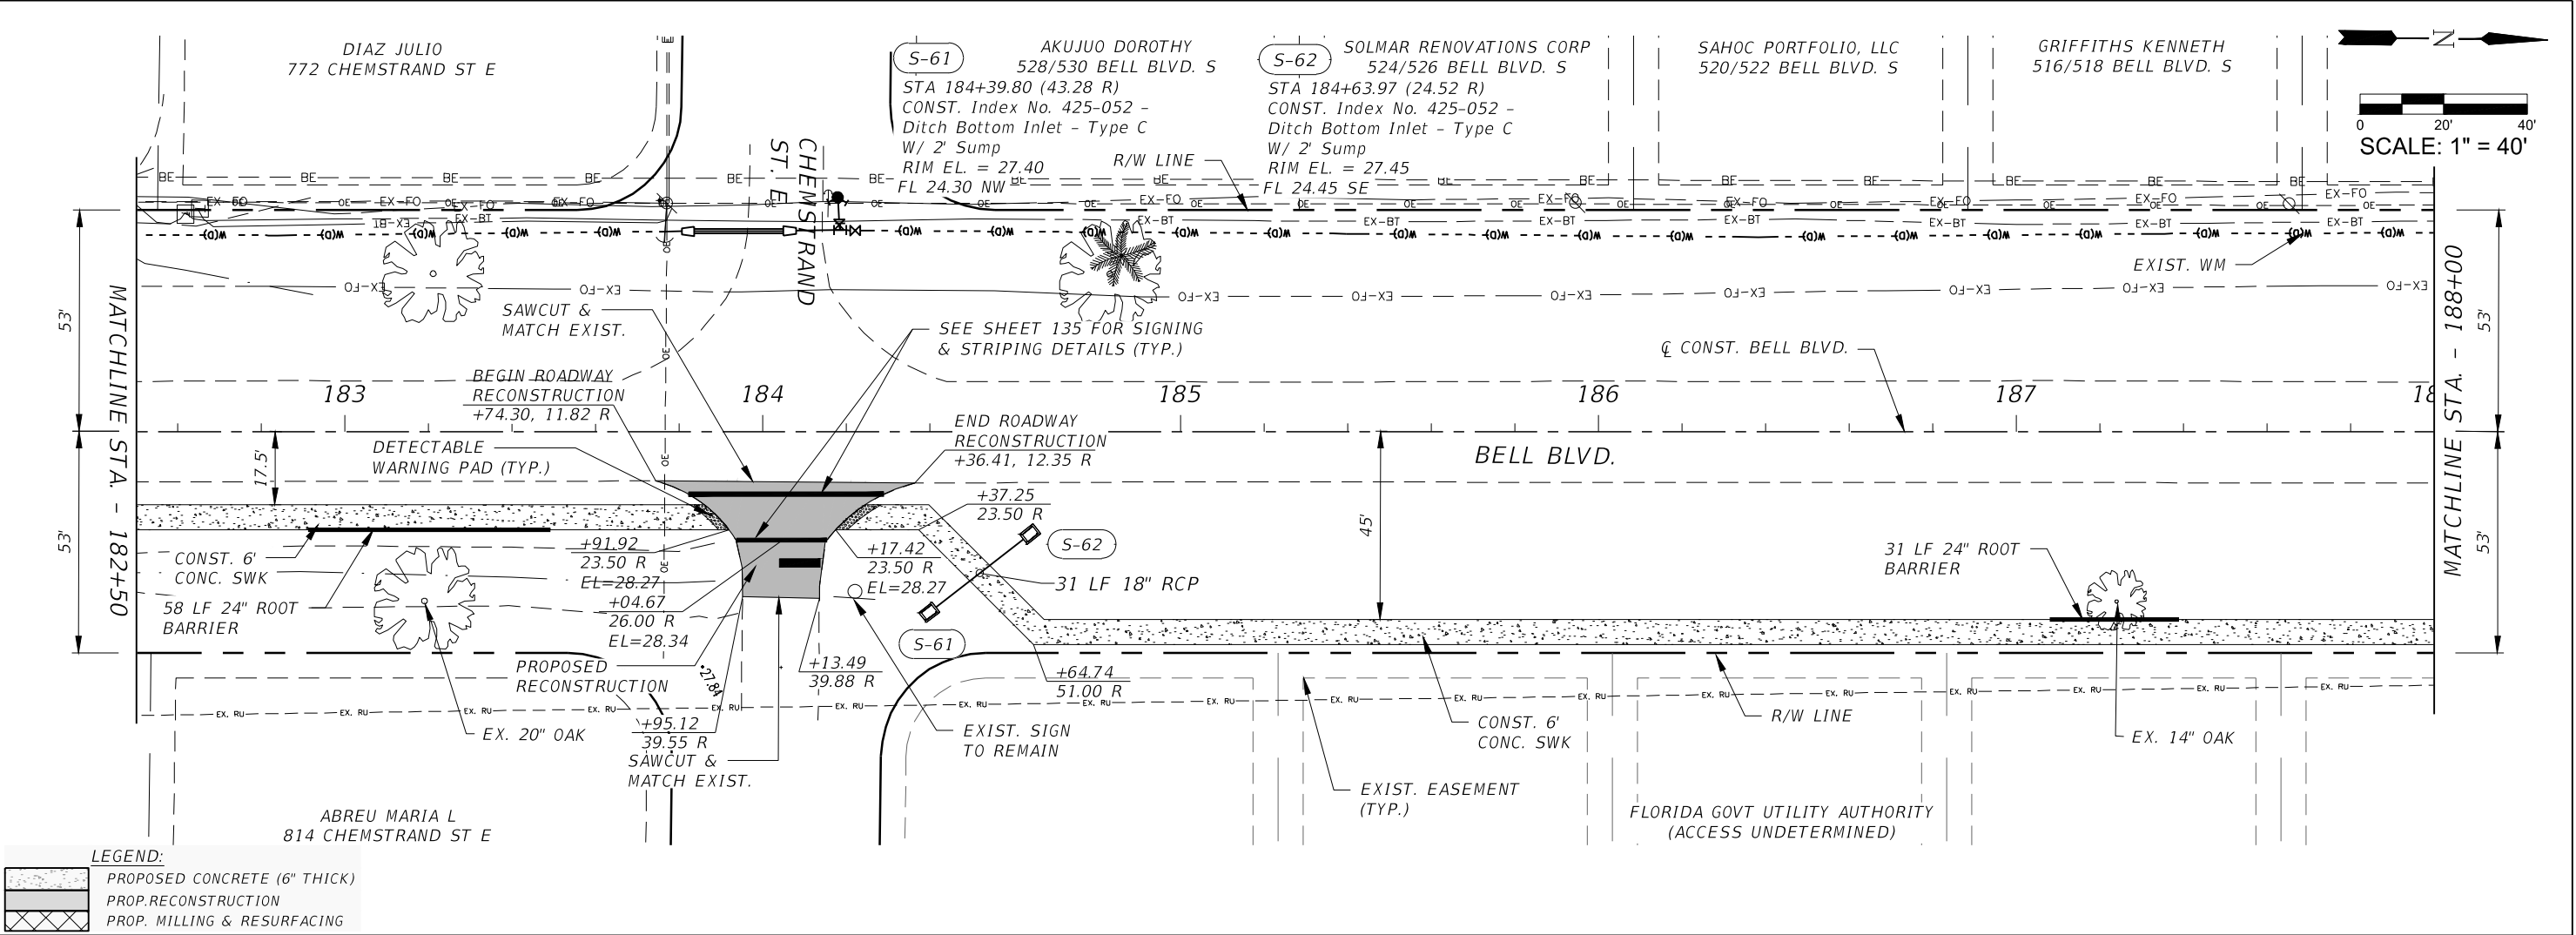


REVISIONS				<div></div> <div>Q. Grady Minor and Associates, P.A. 3800 Via Del Rey Bonita Springs, Florida 34134 Phone: 239.947.1144 R. DANIEL FLYNN, P.E. NO. 76205</div> <div>GradyMinor</div> <div>Civil Engineers • Land Surveyors • Planners • Landscape Architects <small>CERT. OF AUTH. EB 0005131    CERT. OF AUTH. LB 0005131    BUSINESS LC 26000266</small></div>	LEE COUNTY		ROADWAY PLAN & PROFILE STA. 182+50 TO STA. 188+00	SHEET NO.
DATE	DESCRIPTION	DATE	DESCRIPTION		ROAD NO.	COUNTY PROJECT NO.		58
					BELL BLVD. SR 82 TO SUNRISE BLVD. SIDEWALK	6002		




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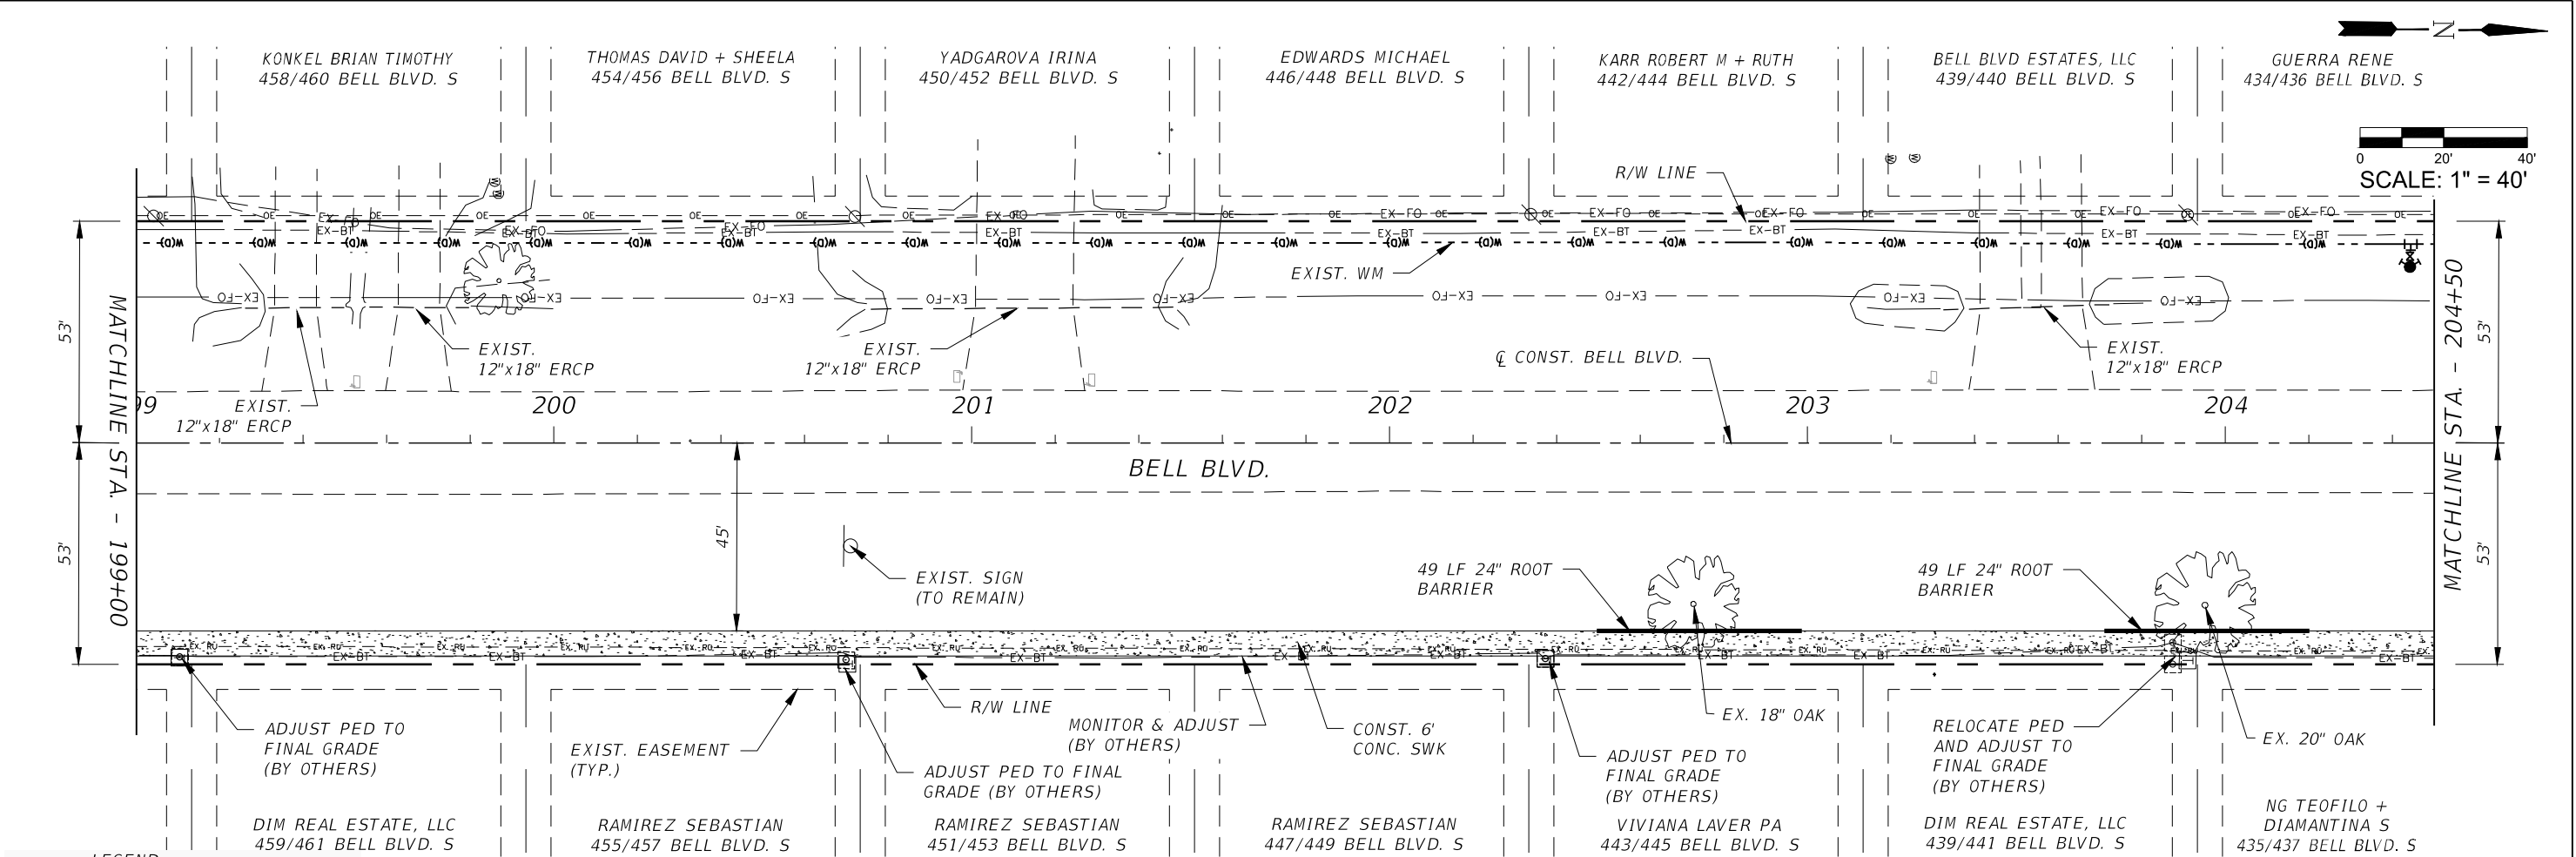
	PROPOSED CONCRETE (6' THICK)
	PROP. RECONSTRUCTION
	PROP. MILLING & RESURFACING

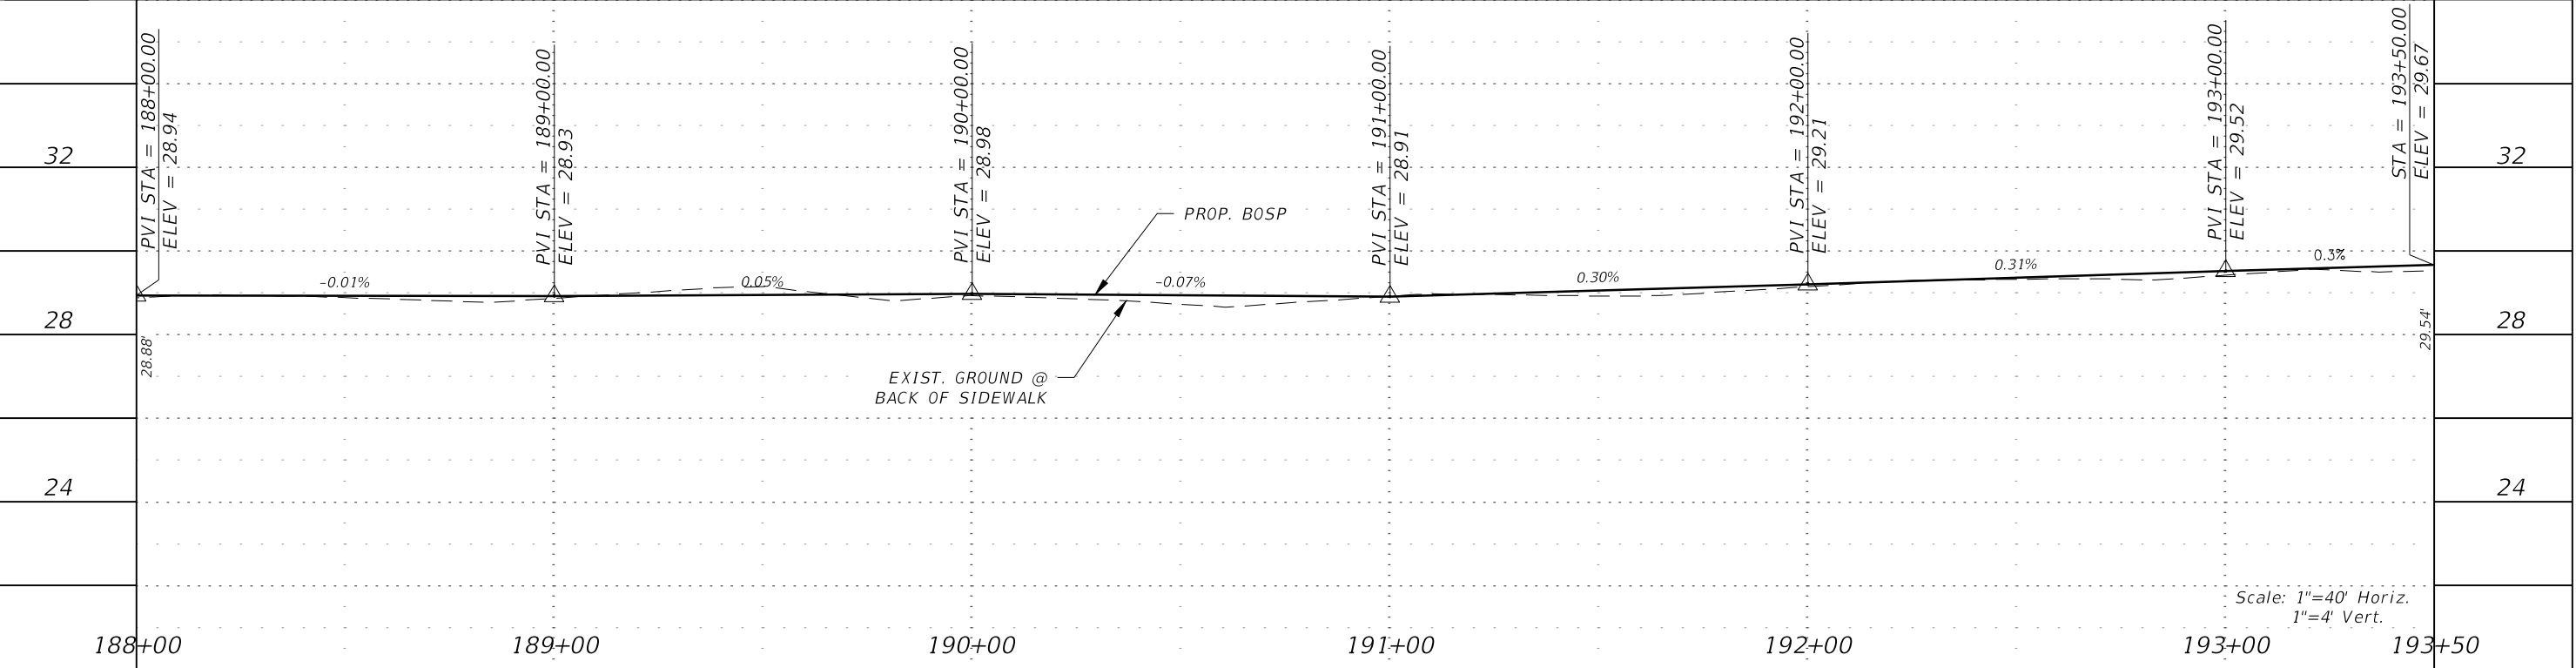

REVISIONS				<div><p>Q. Grady Minor and Associates, P.A. 3800 Via Del Rey Bonita Springs, Florida 34134 Phone: 239.947.1144 R. DANIEL FLYNN, P.E. NO. 76205</p><p><b>GradyMinor</b> Civil Engineers • Land Surveyors • Planners • Landscape Architects <small>Cert. of Auth. EB 0005151    Cert. of Auth. LB 0005151    Business Lic. 26000266</small></p></div>	LEE COUNTY		ROADWAY PLAN & PROFILE STA. 188+00 TO STA. 193+50	SHEET NO.
DATE	DESCRIPTION	DATE	DESCRIPTION		ROAD NO.	COUNTY PROJECT NO.		59
					BELL BLVD. SR 82 TO SUNRISE BLVD. SIDEWALK	6002		




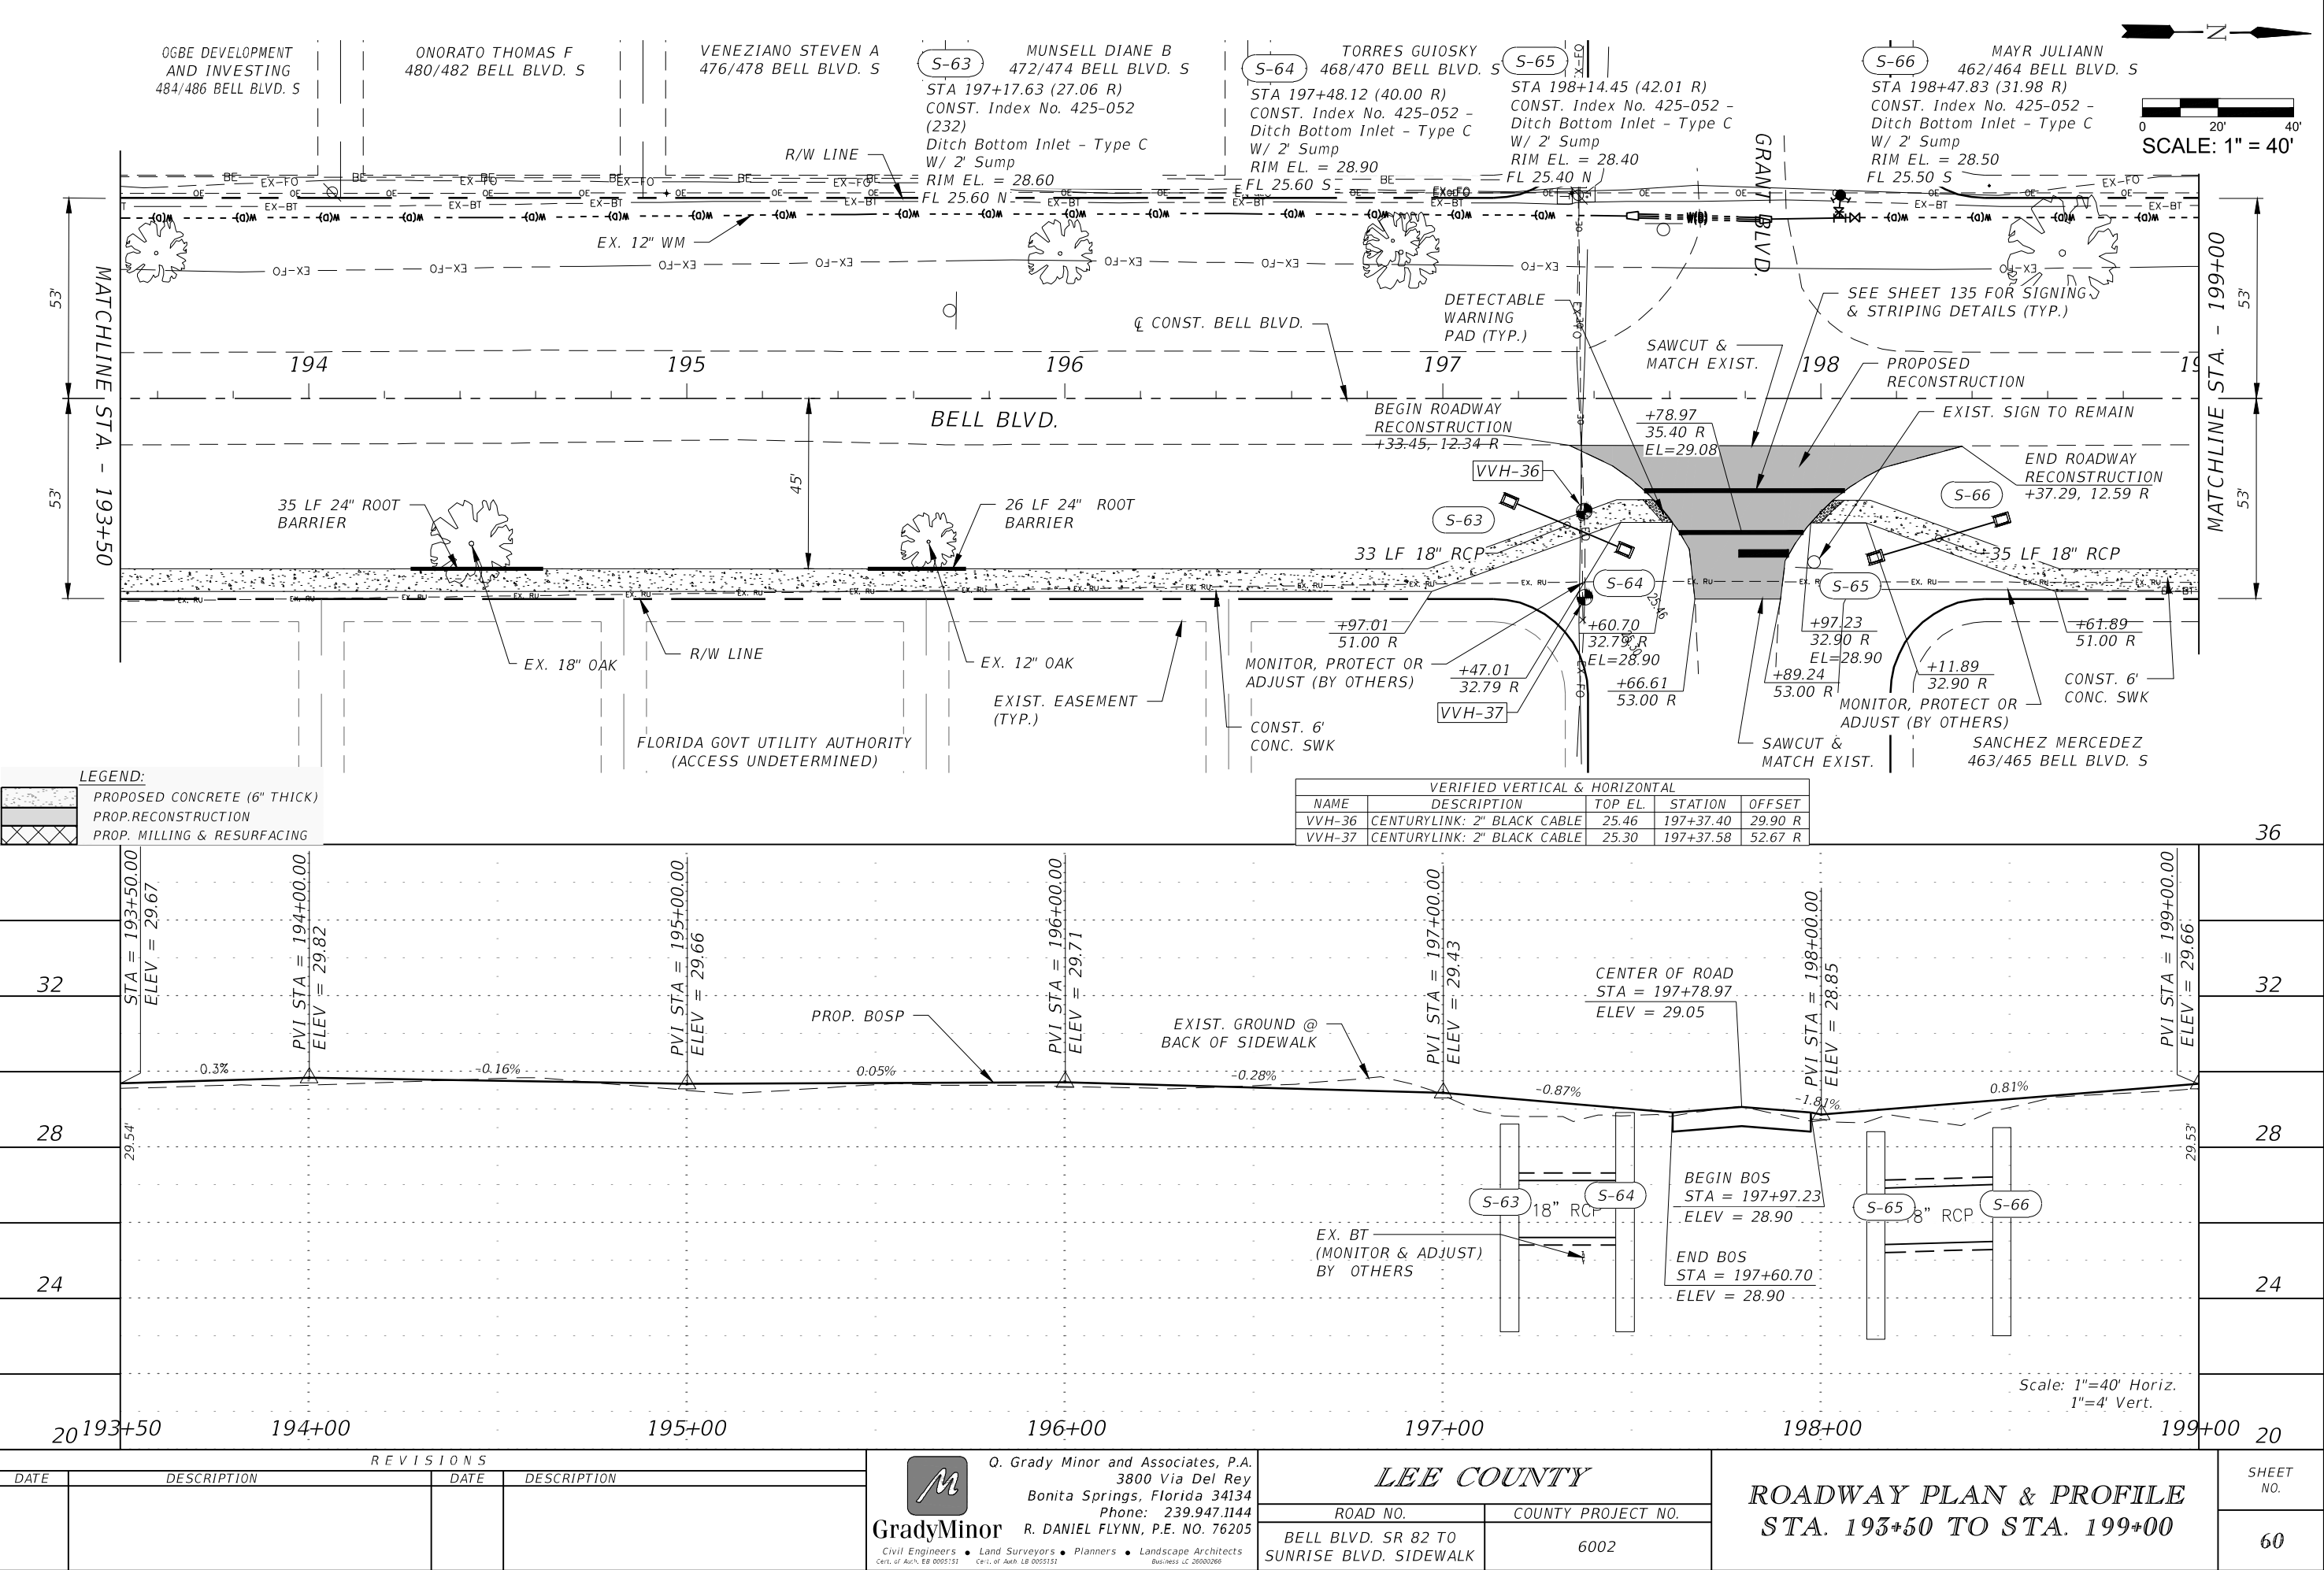





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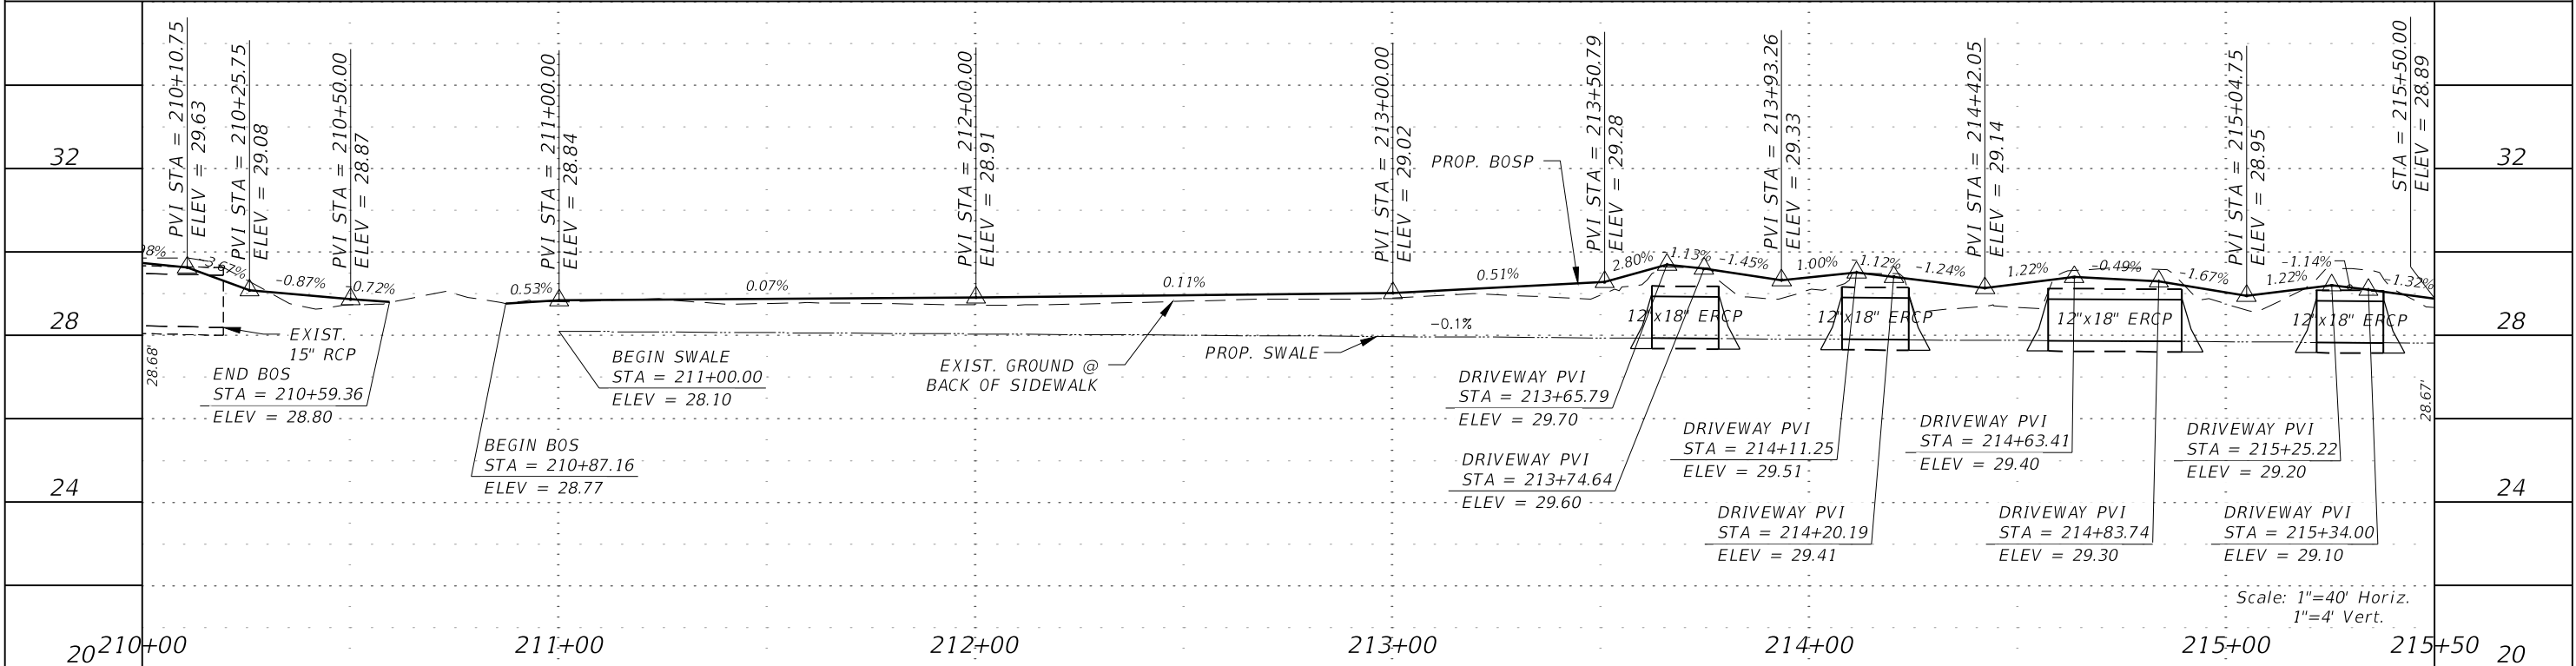
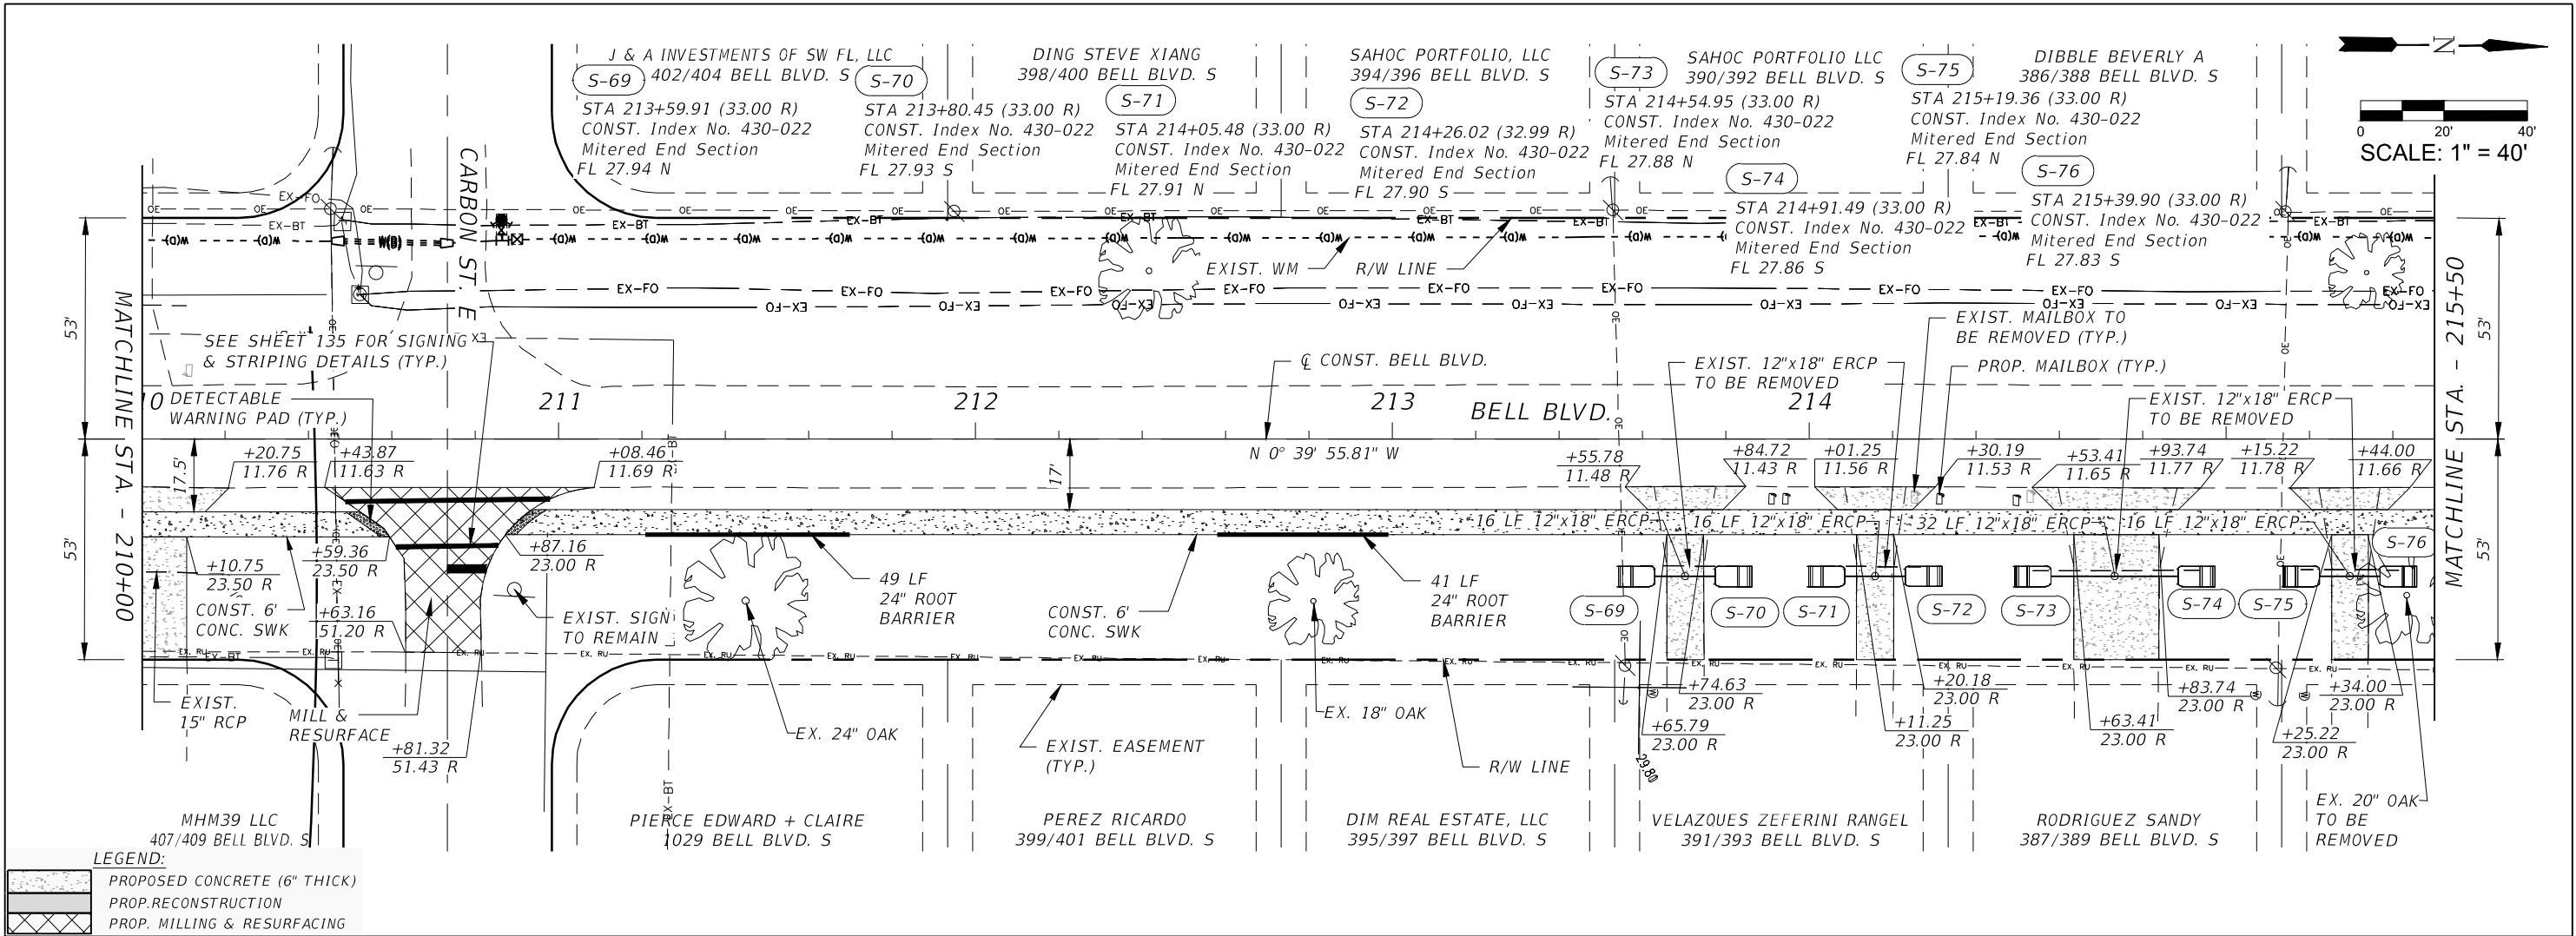
PROPOSED CONCRETE (6" THICK)

PROP. RECONSTRUCTION

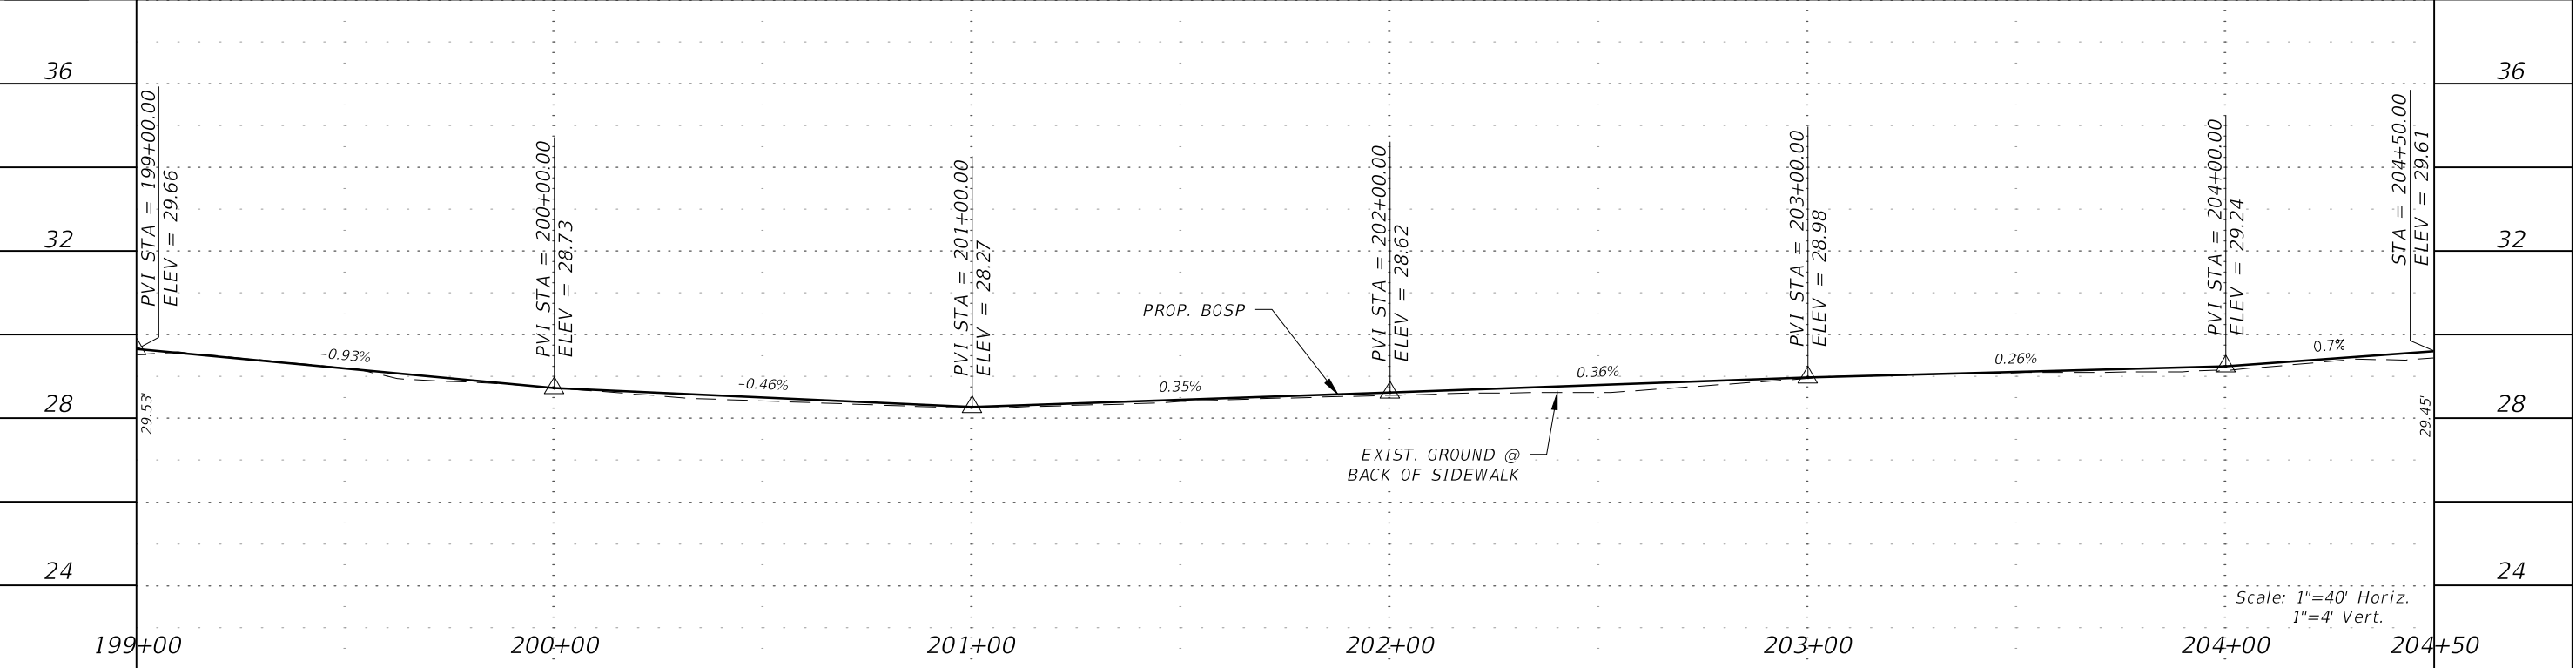
REVISIONS				<div><div></div><div>Q. Grady Minor and Associates, P.A. 3800 Via Del Rey Bonita Springs, Florida 34134 Phone: 239.947.1144 R. DANIEL FLYNN, P.E. NO. 76205</div></div> <div>GradyMinor <small>Civil Engineers • Land Surveyors • Planners • Landscape Architects Cert. of Auth. EB 0005151    Cert. of Auth. LB 0005151    Business Lic. 26000266</small></div>	LEE COUNTY		ROADWAY PLAN & PROFILE STA. 199+00 TO STA. 204+50	SHEET NO.  61
DATE	DESCRIPTION	DATE	DESCRIPTION					
				BELL BLVD. SR 82 TO SUNRISE BLVD. SIDEWALK	COUNTY PROJECT NO. 6002			

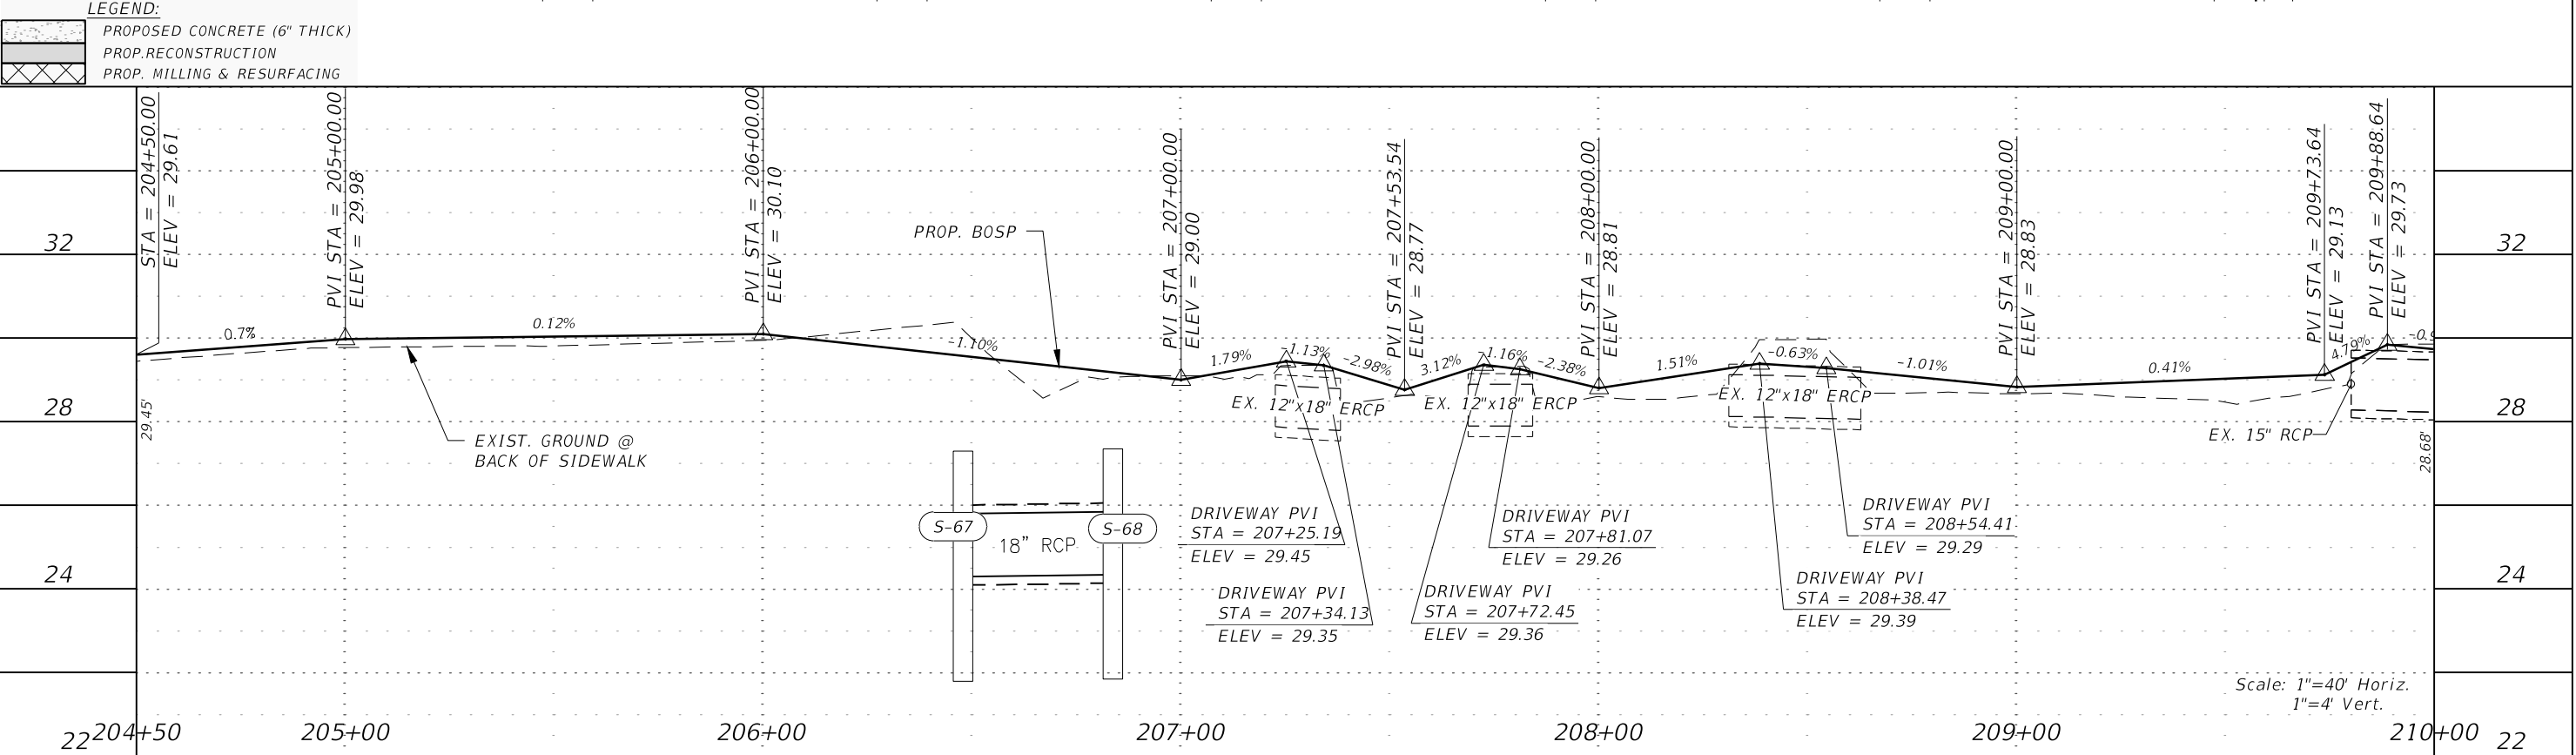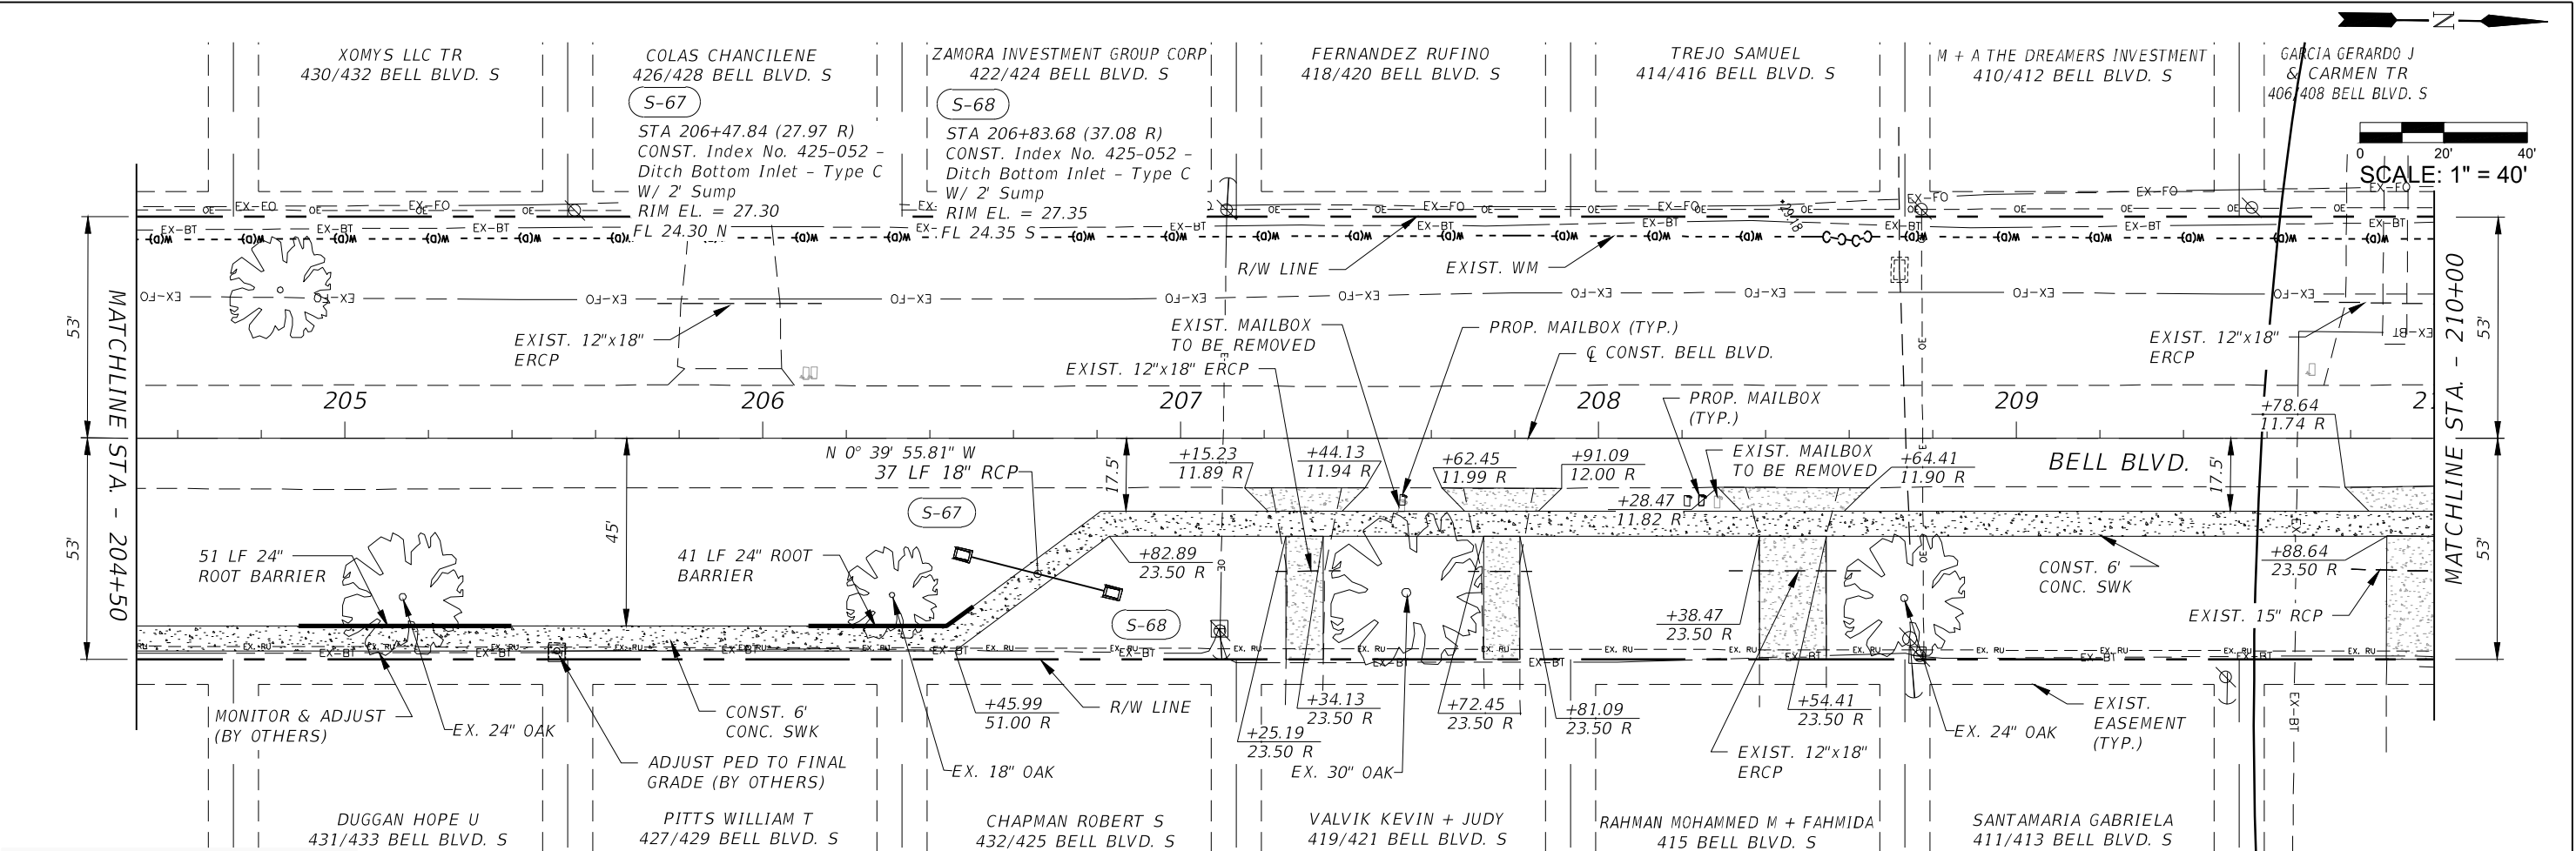



REVISIONS				<div><p>Q. Grady Minor and Associates, P.A. 3800 Via Del Rey Bonita Springs, Florida 34134 Phone: 239.947.1144 R. DANIEL FLYNN, P.E. NO. 76205</p><p><b>GradyMinor</b> Civil Engineers • Land Surveyors • Planners • Landscape Architects <small>Cert. of Auth. EB 0005151    Cert. of Auth. LB 0005151    Business Lic. 26000266</small></p></div>	LEE COUNTY		PLAN & PROFILE STA. 204+50 TO STA. 210+00	SHEET NO.
DATE	DESCRIPTION	DATE	DESCRIPTION		ROAD NO.	COUNTY PROJECT NO.		62
					BELL BLVD. SR 82 TO SUNRISE BLVD. SIDEWALK	6002		



REVISIONS				<div>Q. Grady Minor and Associates, P.A. 3800 Via Del Rey Bonita Springs, Florida 34134 Phone: 239.947.1144 R. DANIEL FLYNN, P.E. NO. 76205</div>	LEE COUNTY		ROADWAY PLAN & PROFILE STA. 210+00 TO STA. 215+50	SHEET NO.  63
DATE	DESCRIPTION	DATE	DESCRIPTION		ROAD NO.	COUNTY PROJECT NO.		
					BELL BLVD. SR 82 TO SUNRISE BLVD. SIDEWALK	6002		

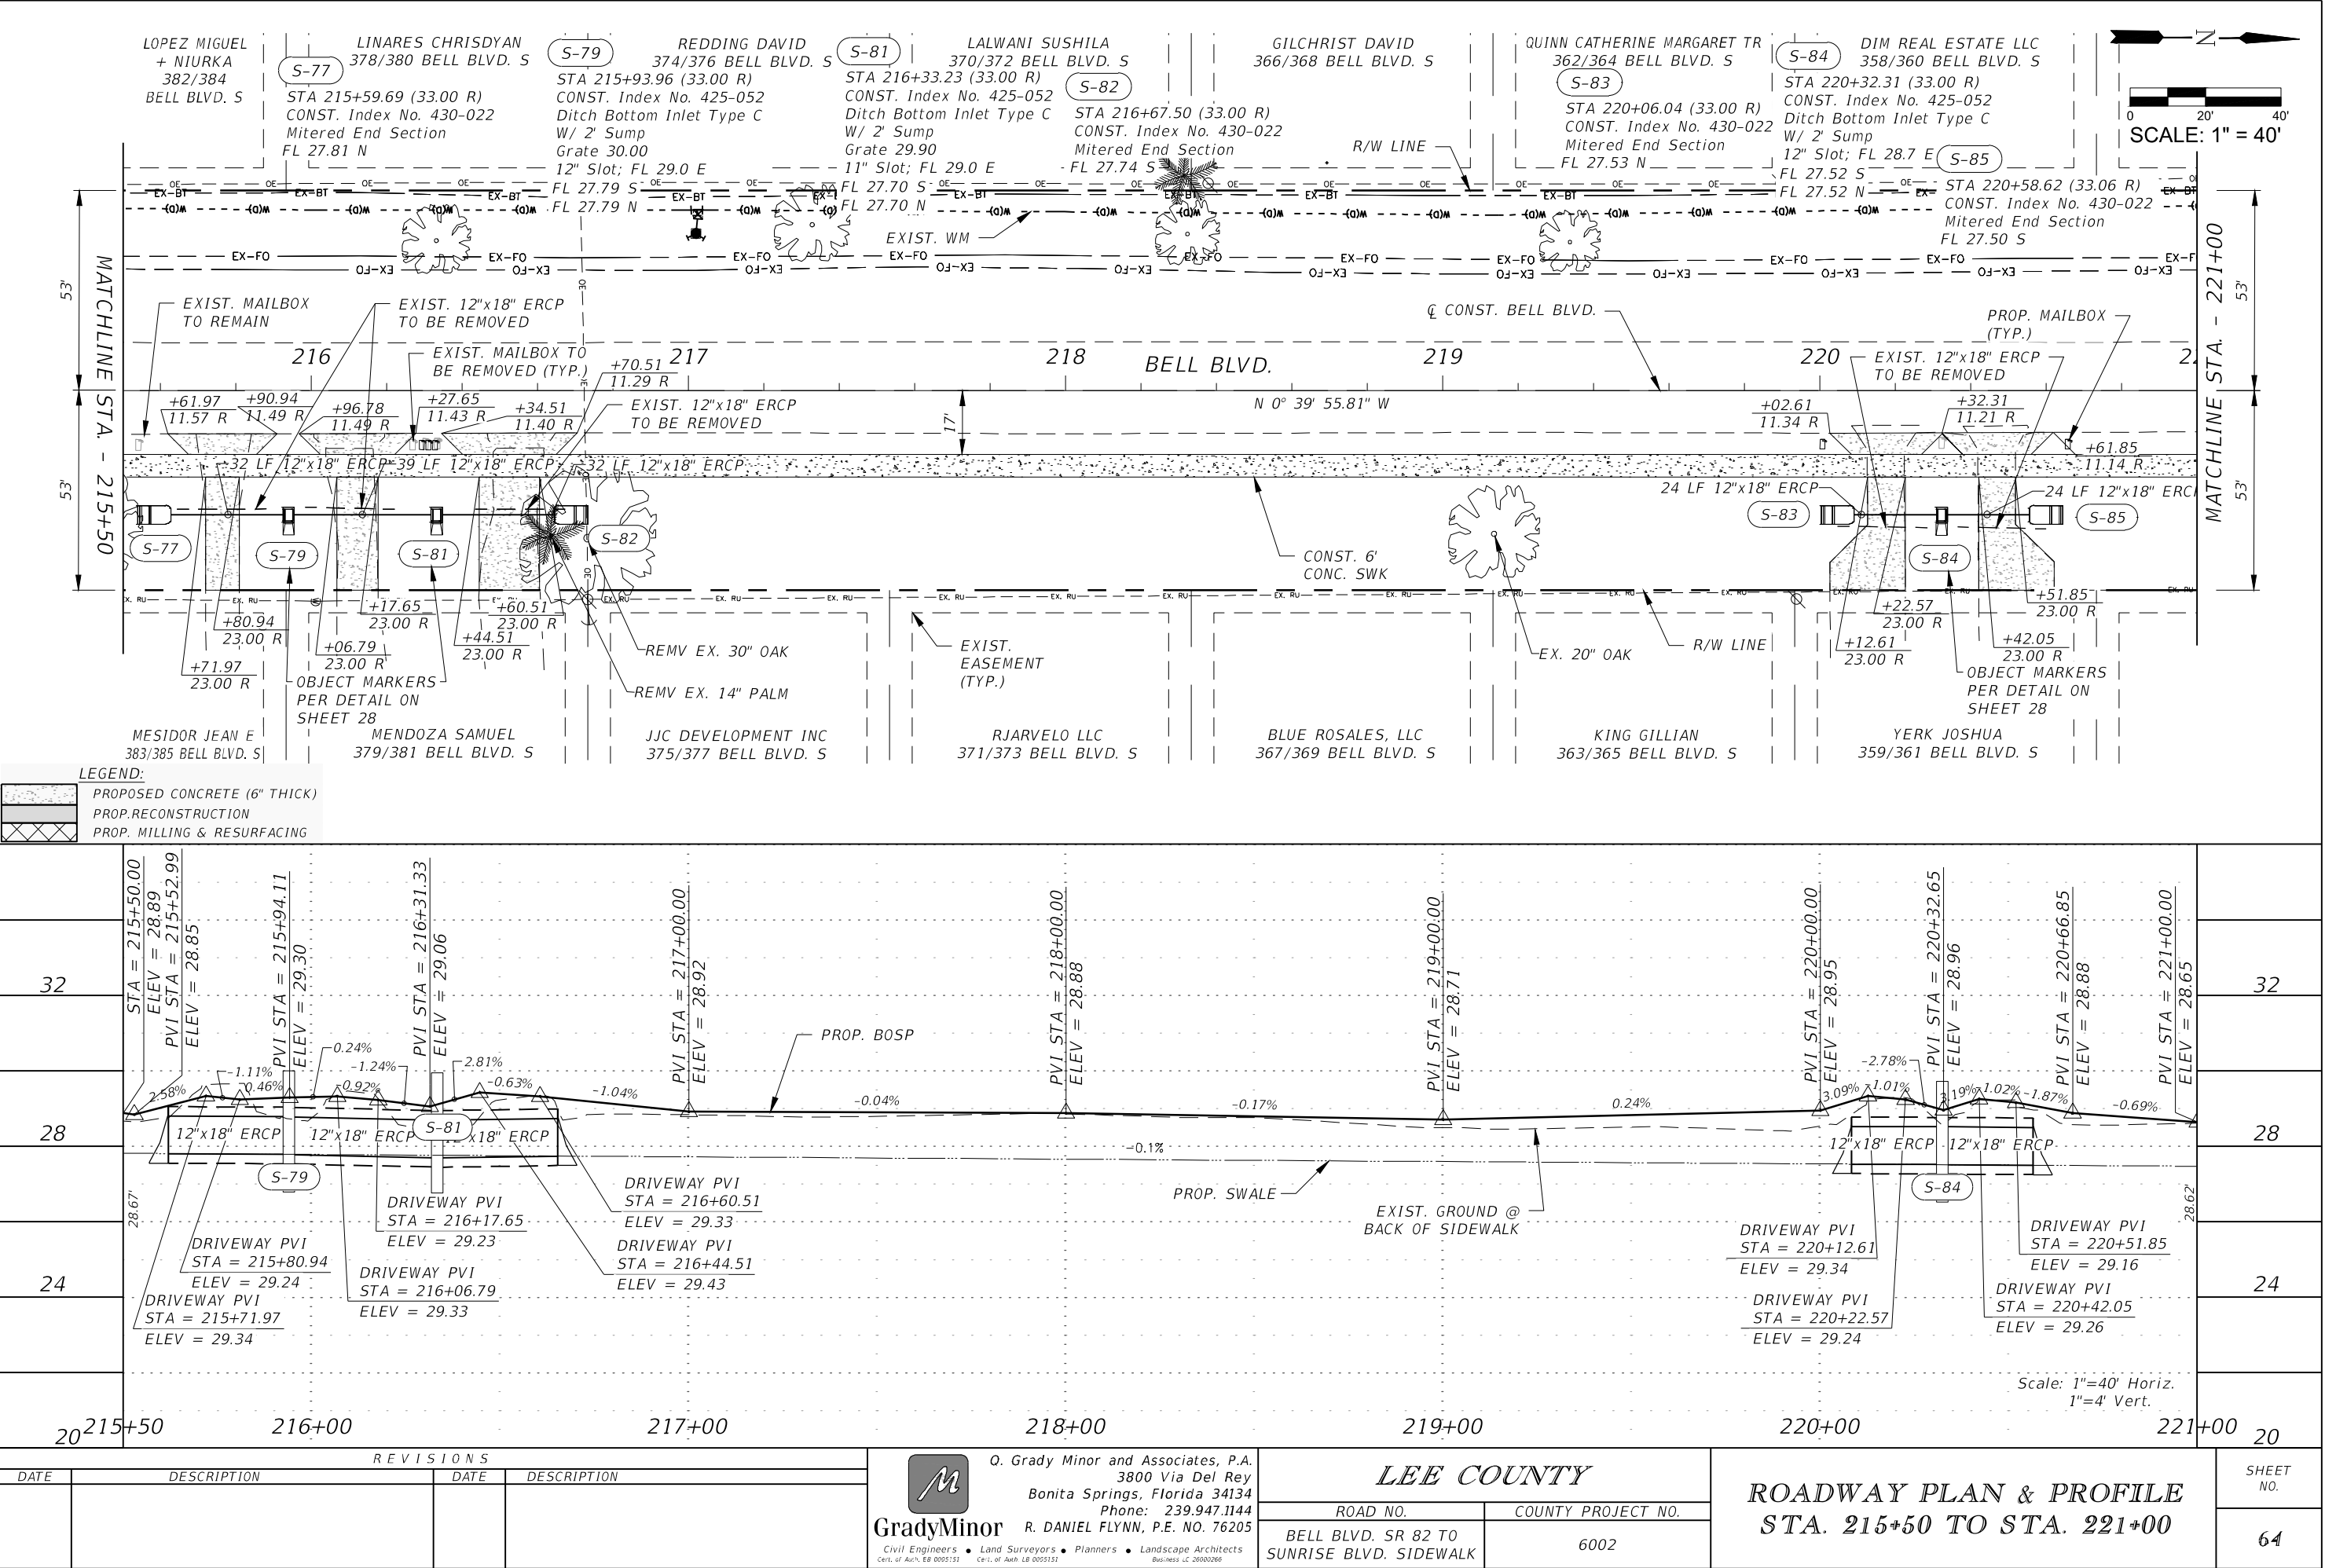




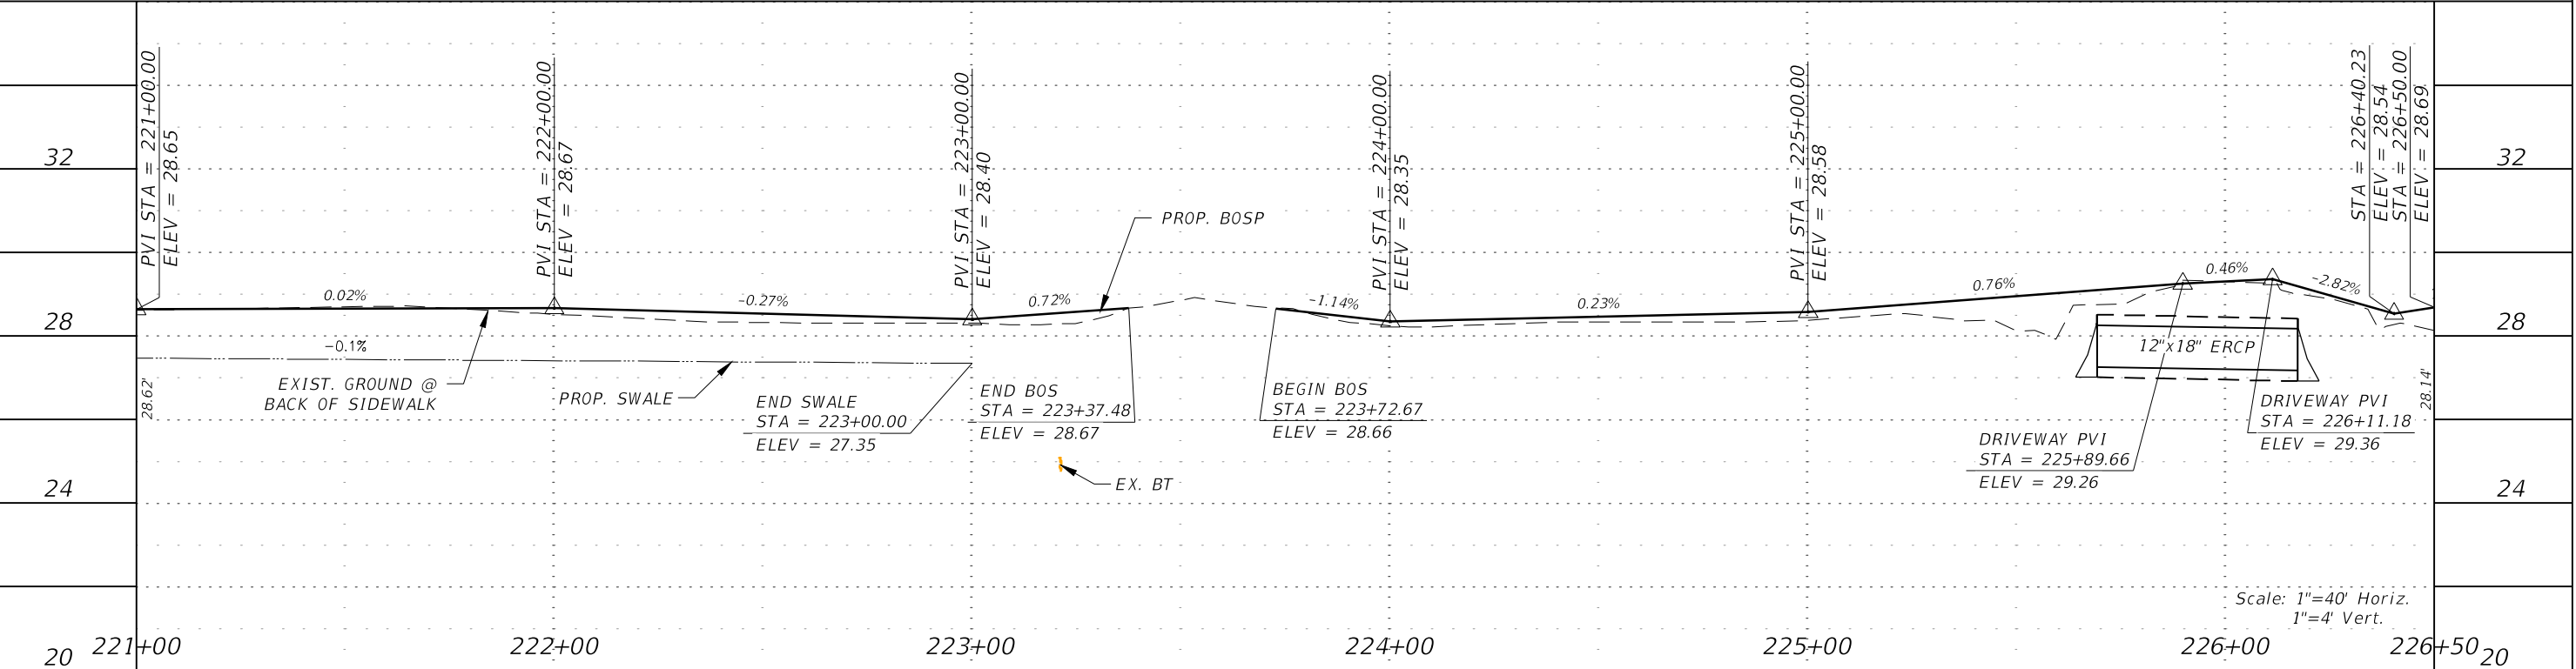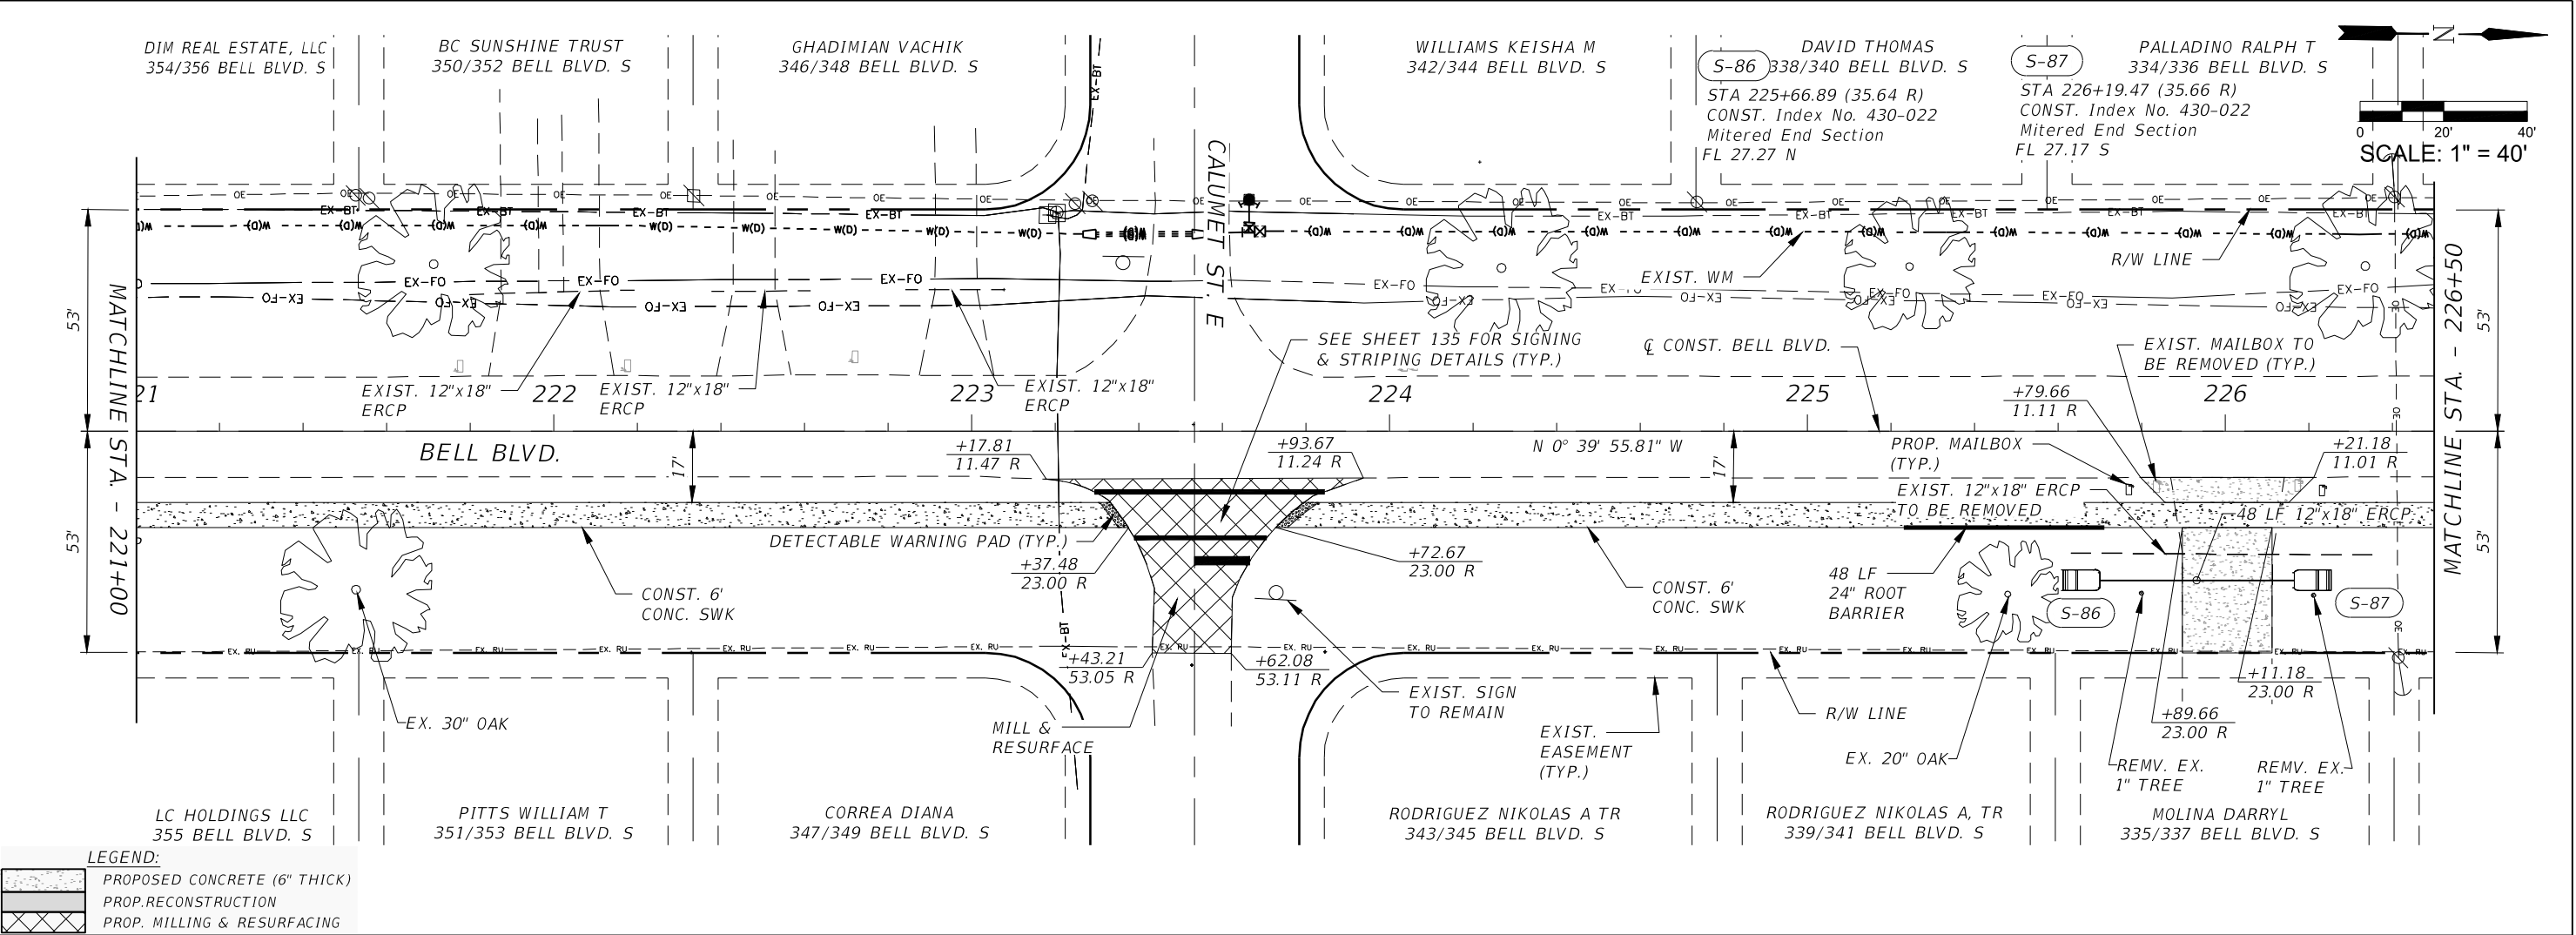


REVISIONS				 <div>Q. Grady Minor and Associates, P.A. 3800 Via Del Rey Bonita Springs, Florida 34134 Phone: 239.947.1144 R. DANIEL FLYNN, P.E. NO. 76205</div>	LEE COUNTY		ROADWAY PLAN & PROFILE STA. 204+50 TO STA. 226+50	SHEET NO.  65
DATE	DESCRIPTION	DATE	DESCRIPTION		ROAD NO.	COUNTY PROJECT NO.		
					BELL BLVD. SR 82 TO SUNRISE BLVD. SIDEWALK	6002		




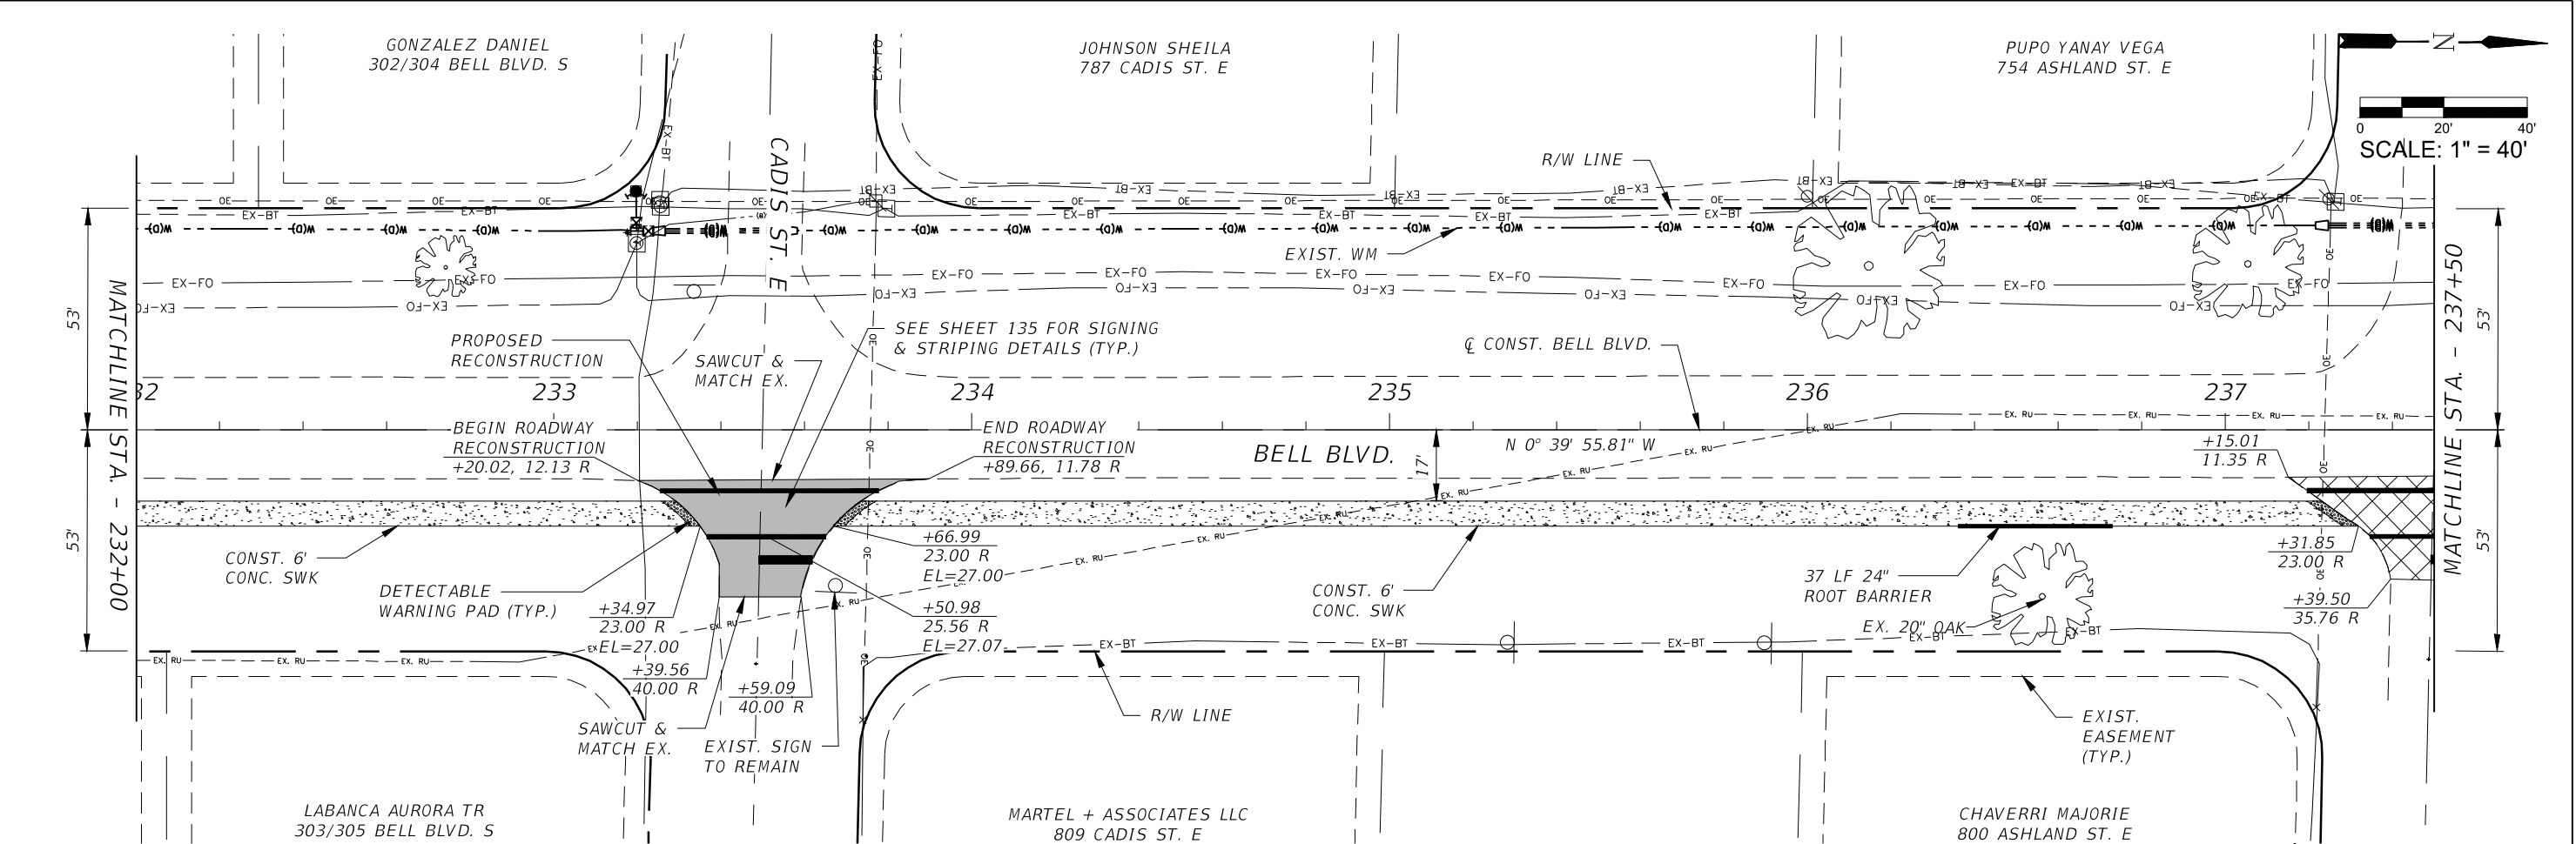


LEGEND:

	PROPOSED CONCRETE (6" THICK)
	PROP. RECONSTRUCTION
	PROP. MILLING & RESURFACING


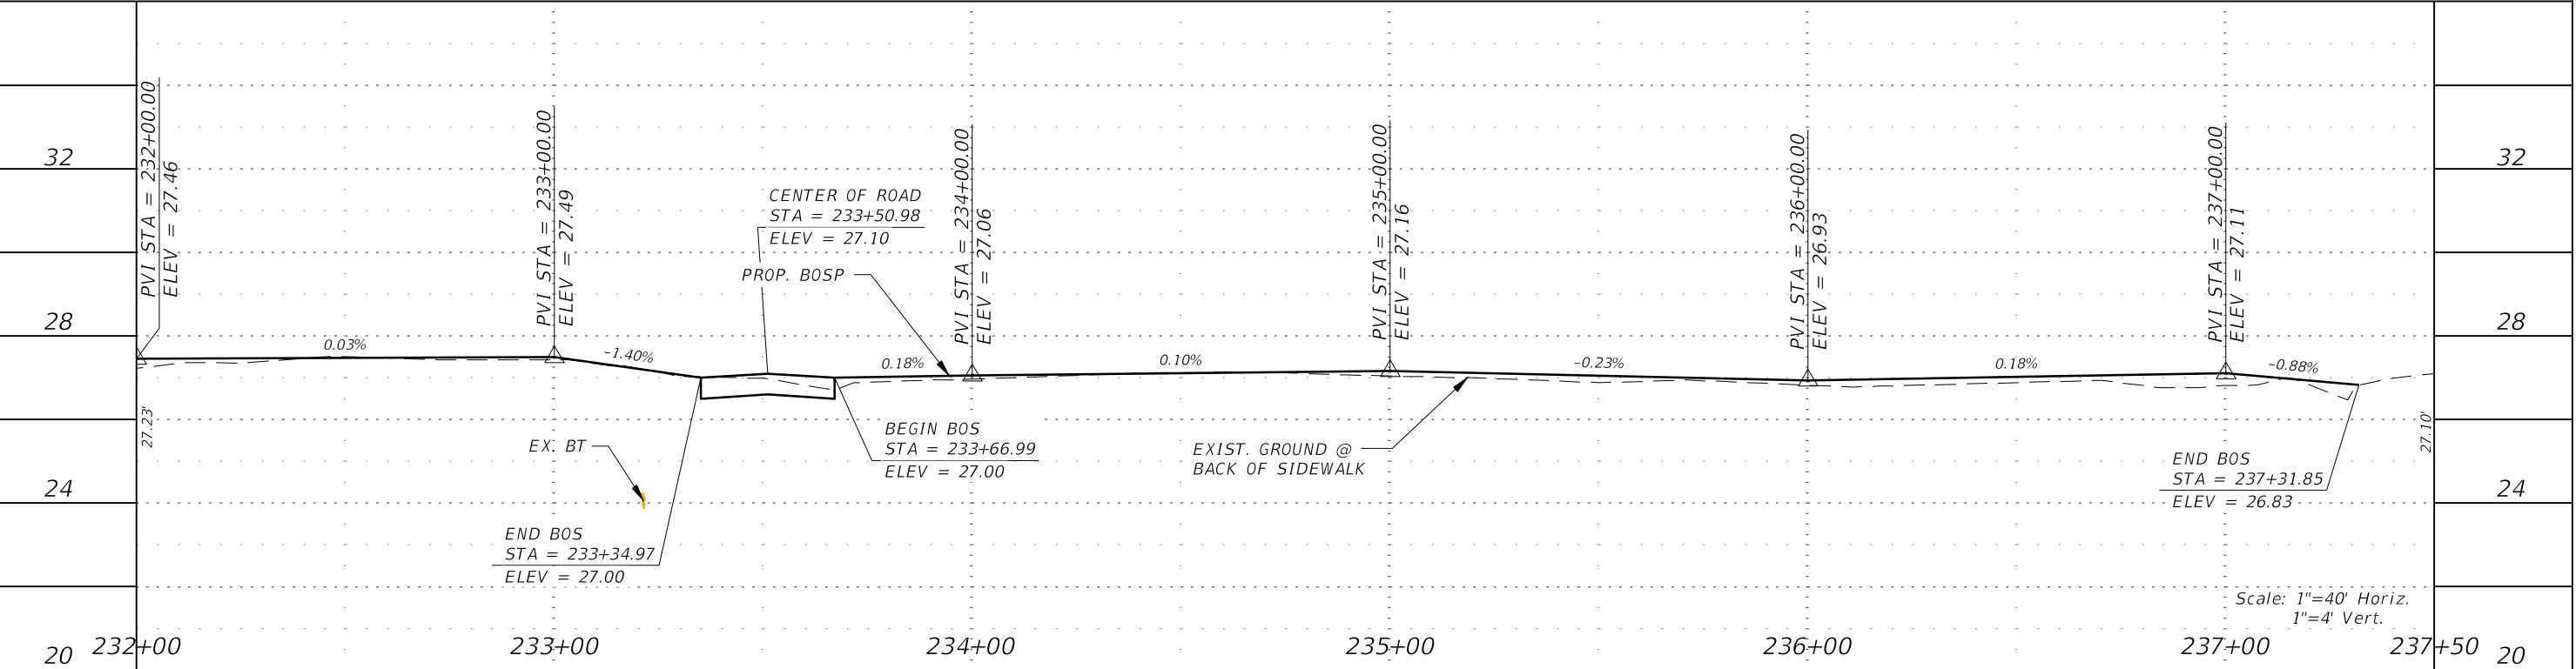


REVISIONS				<div>Q. Grady Minor and Associates, P.A. 3800 Via Del Rey Bonita Springs, Florida 34134 Phone: 239.947.1144 R. DANIEL FLYNN, P.E. NO. 76205</div>	LEE COUNTY		ROADWAY PLAN & PROFILE STA. 232+00 TO STA. 237+50	SHEET NO.  67
DATE	DESCRIPTION	DATE	DESCRIPTION		ROAD NO.	COUNTY PROJECT NO.		
					BELL BLVD. SR 82 TO SUNRISE BLVD. SIDEWALK	6002		

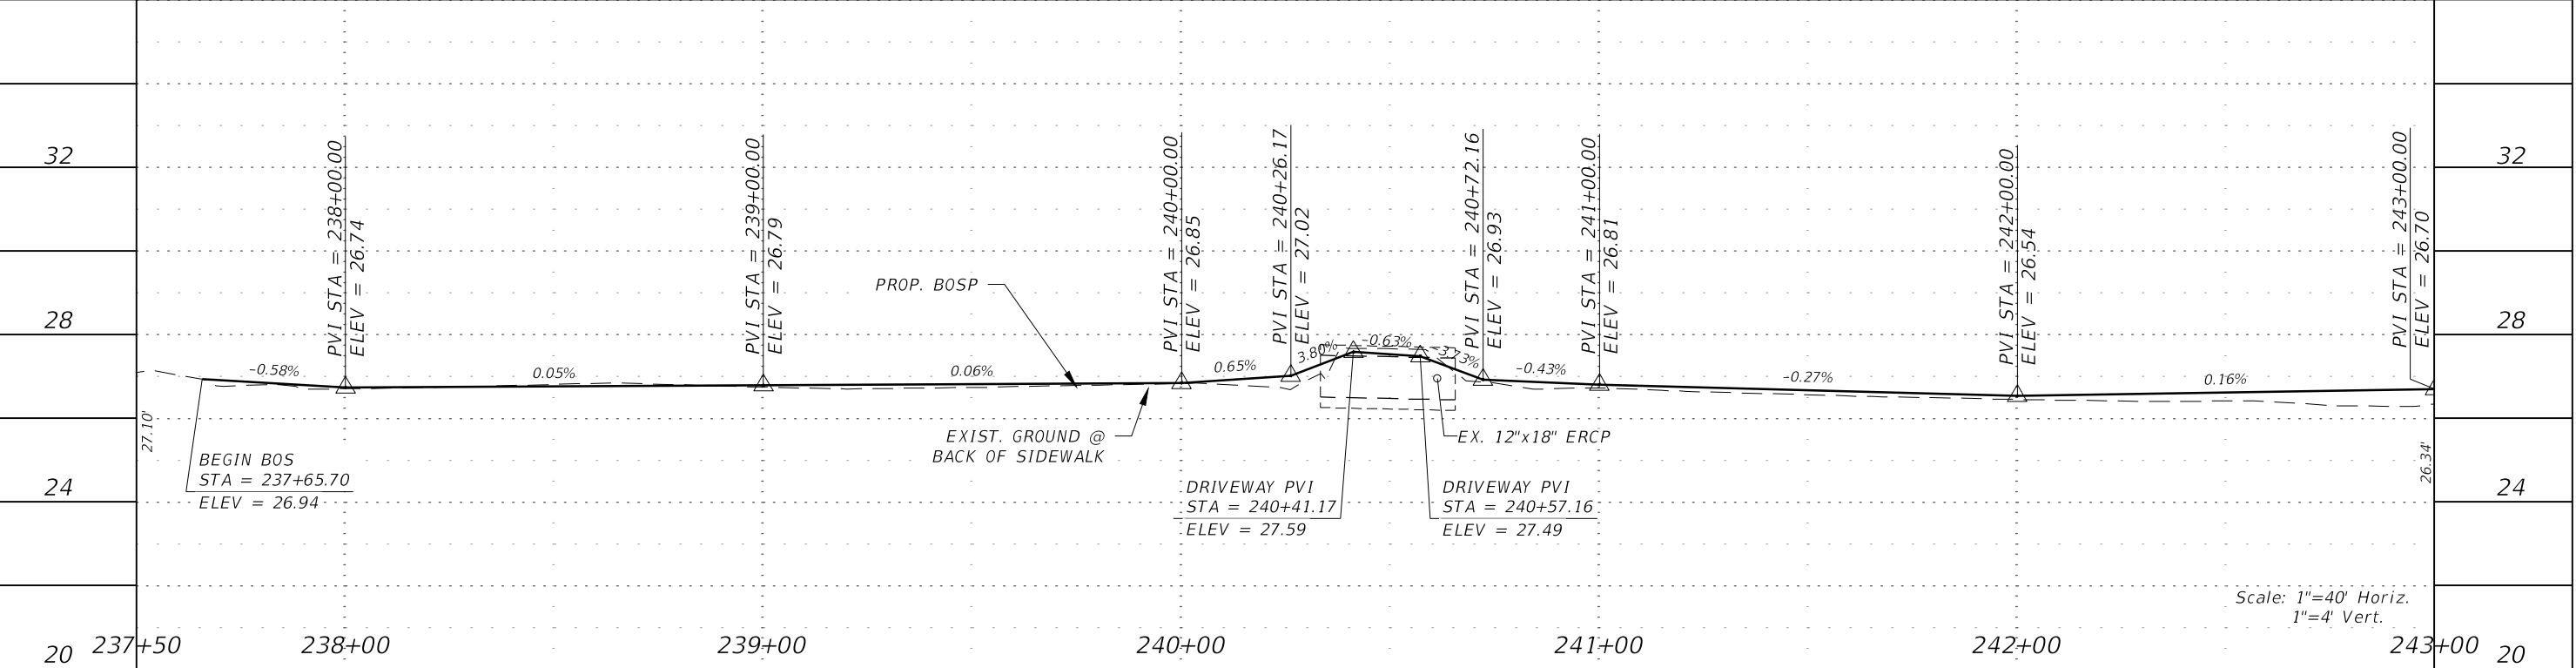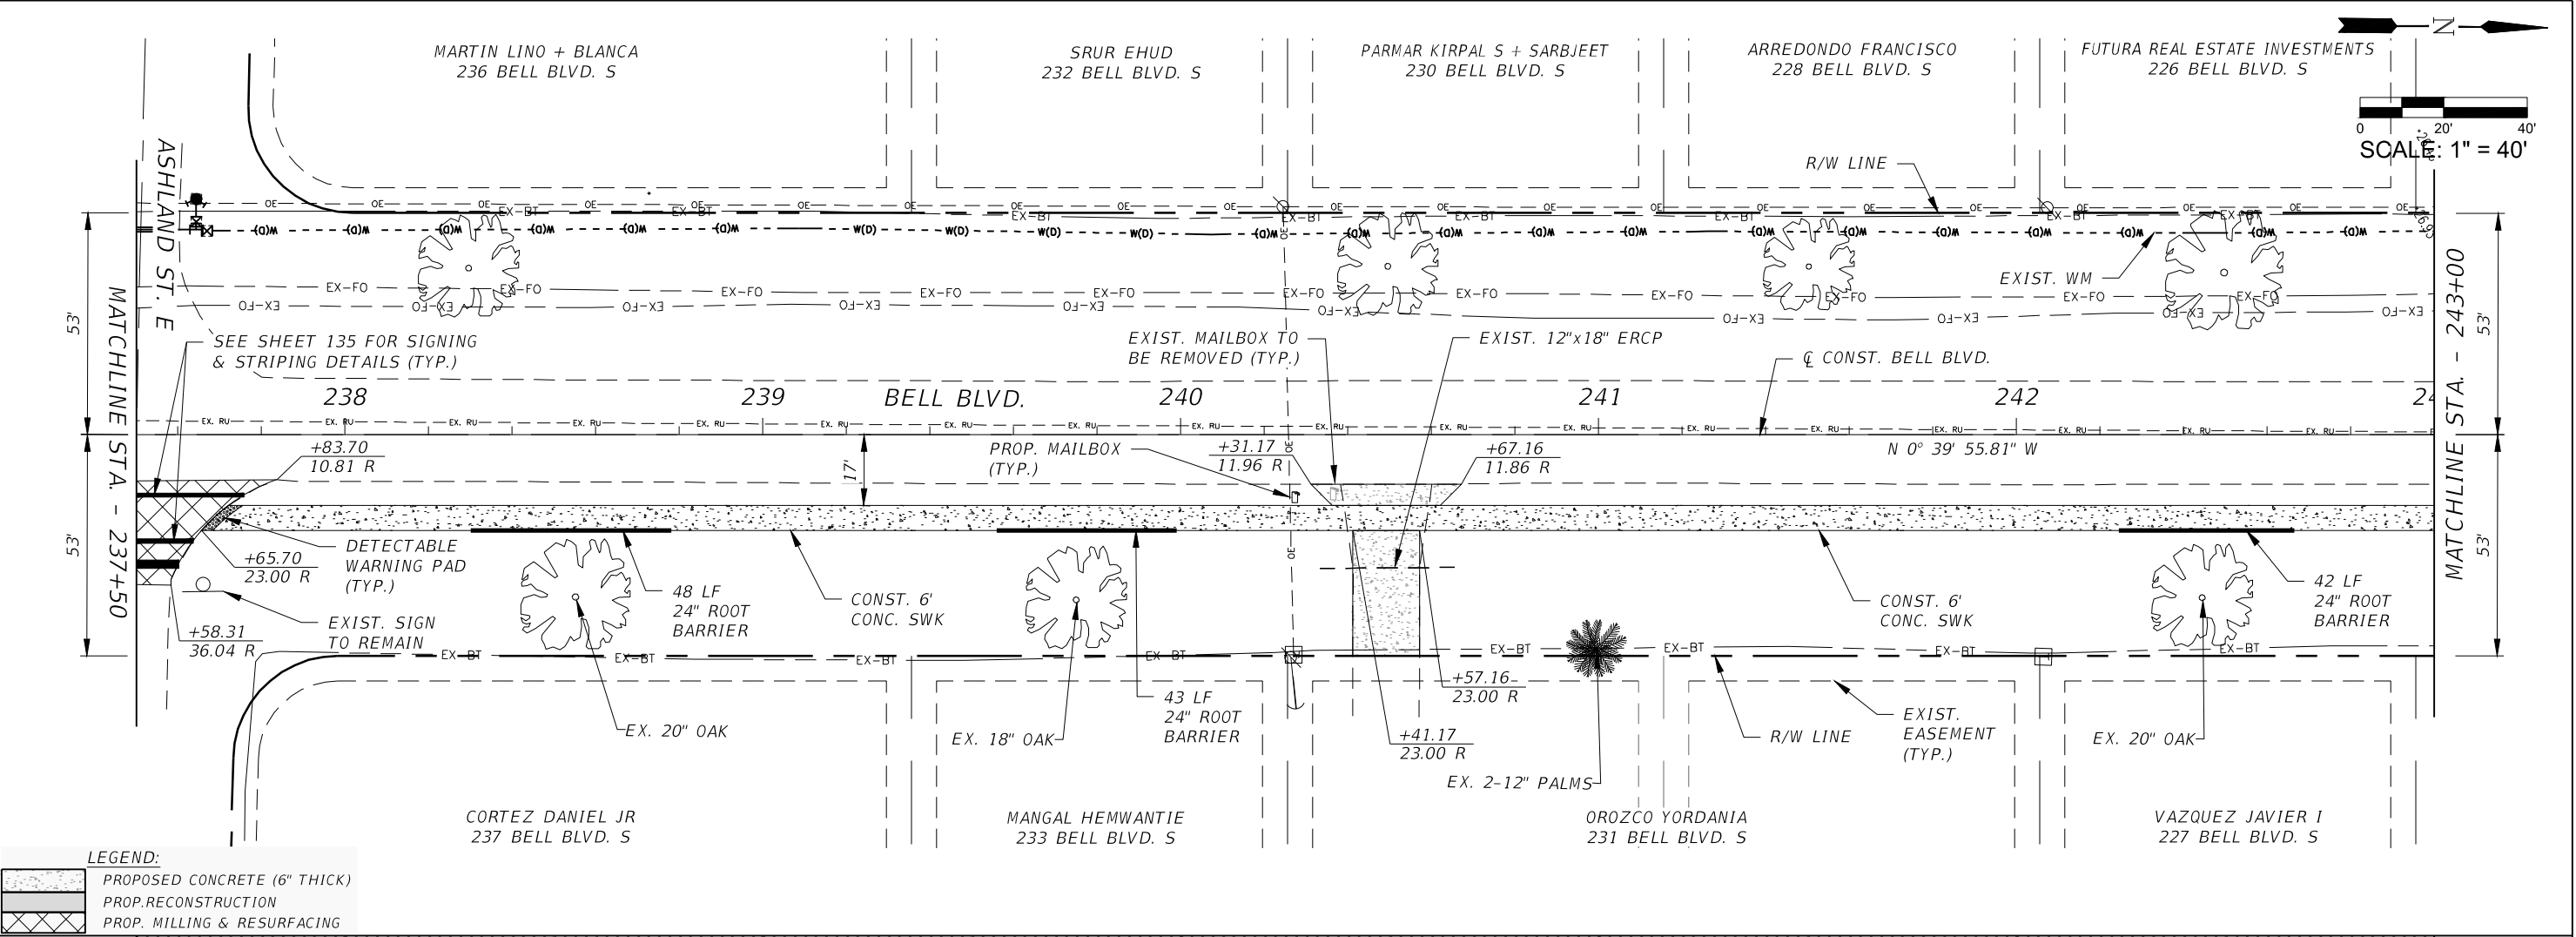


REVISIONS				<div><p>Q. Grady Minor and Associates, P.A. 3800 Via Del Rey Bonita Springs, Florida 34134 Phone: 239.947.1144 R. DANIEL FLYNN, P.E. NO. 76205</p><p><b>GradyMinor</b> Civil Engineers • Land Surveyors • Planners • Landscape Architects <small>CERT. OF AUTH. EB 0005151    CERT. OF AUTH. LB 0005151    BUSINESS LC 26000266</small></p></div>	LEE COUNTY		ROADWAY PLAN & PROFILE STA. 237+50 TO STA. 243+00	SHEET NO.
DATE	DESCRIPTION	DATE	DESCRIPTION		ROAD NO.	COUNTY PROJECT NO.		68
					BELL BLVD. SR 82 TO SUNRISE BLVD. SIDEWALK	6002		



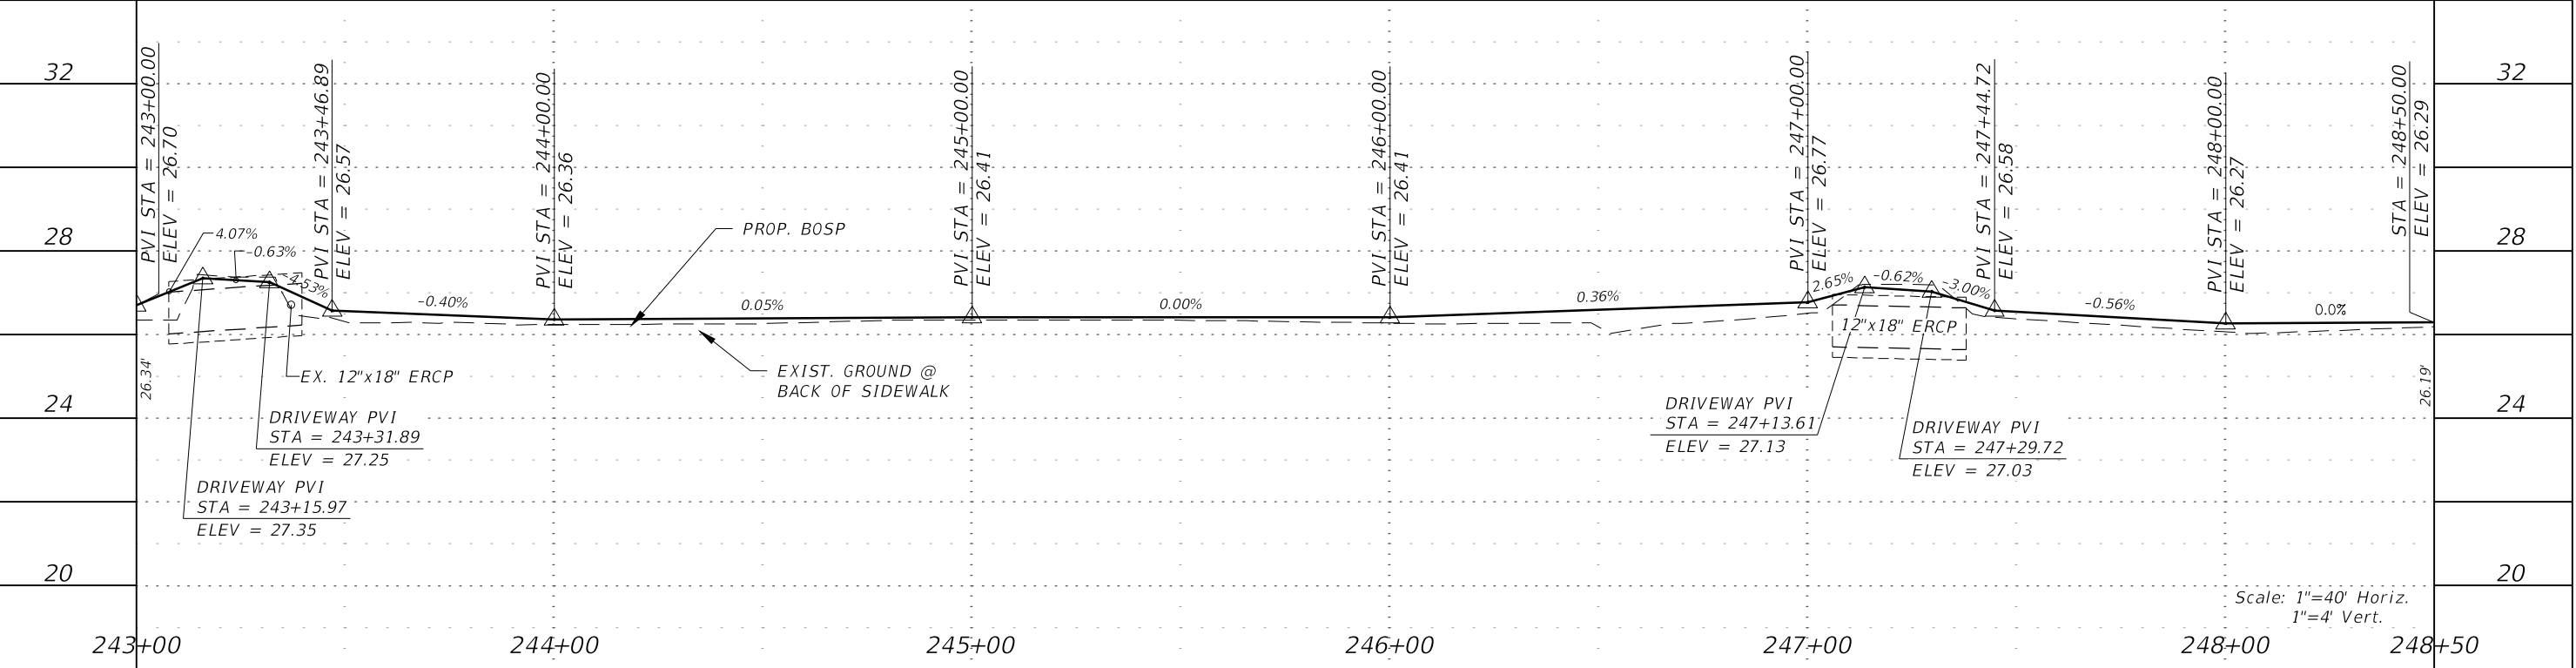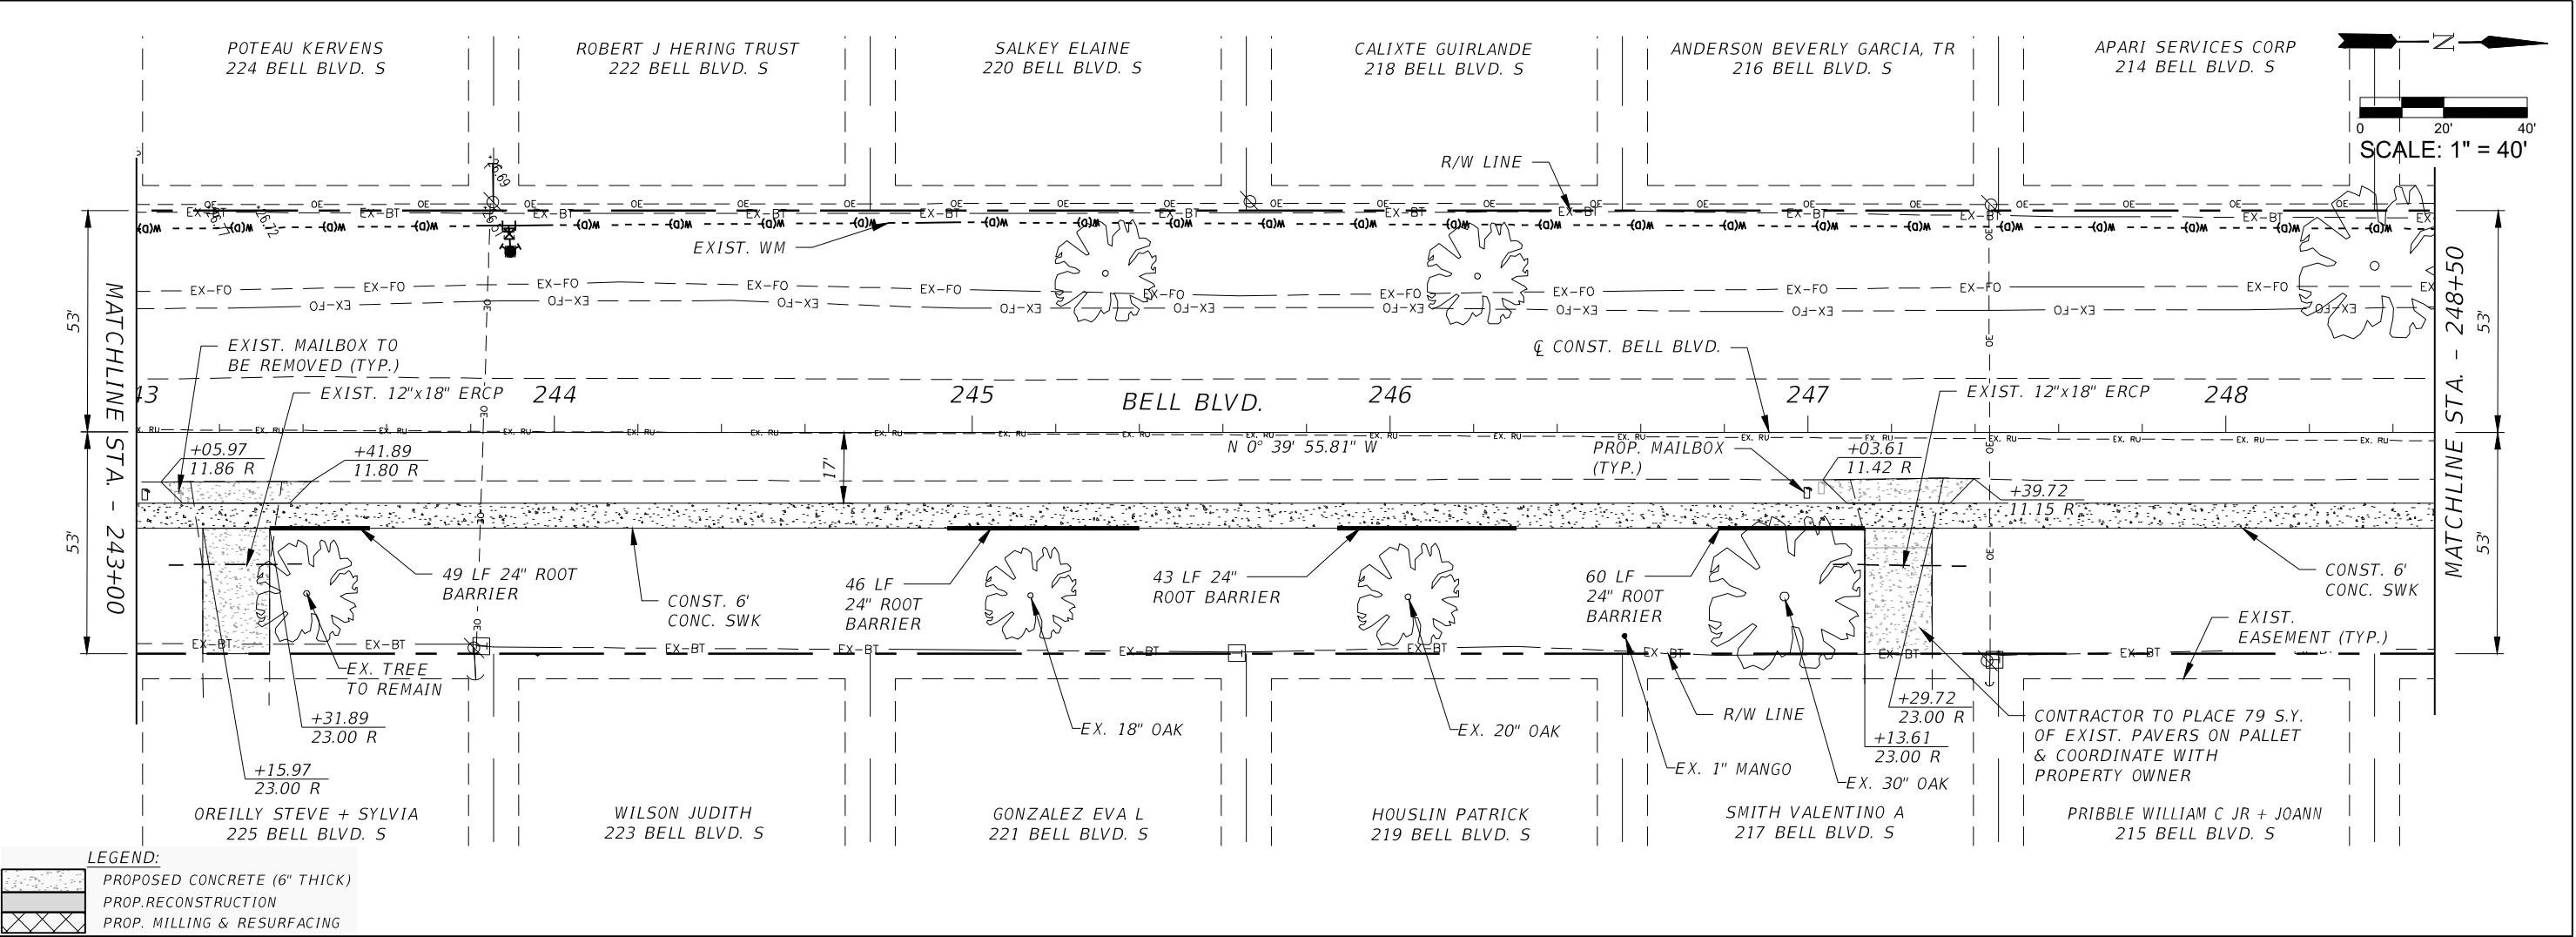

REVISIONS				<div><p><b>GradyMinor</b> Civil Engineers • Land Surveyors • Planners • Landscape Architects <small>CERT. OF AUTH. EB 0005151      CERT. OF AUTH. LB 0005151      BUSINESS LC 26000266</small></p></div>	<div><b>LEE COUNTY</b></div> <div><div>ROAD NO.</div><div>COUNTY PROJECT NO.</div></div>		<div>ROADWAY PLAN &amp; PROFILE</div> <div>STA. 243+00 TO STA. 248+50</div>		SHEET NO.
DATE	DESCRIPTION	DATE	DESCRIPTION						69

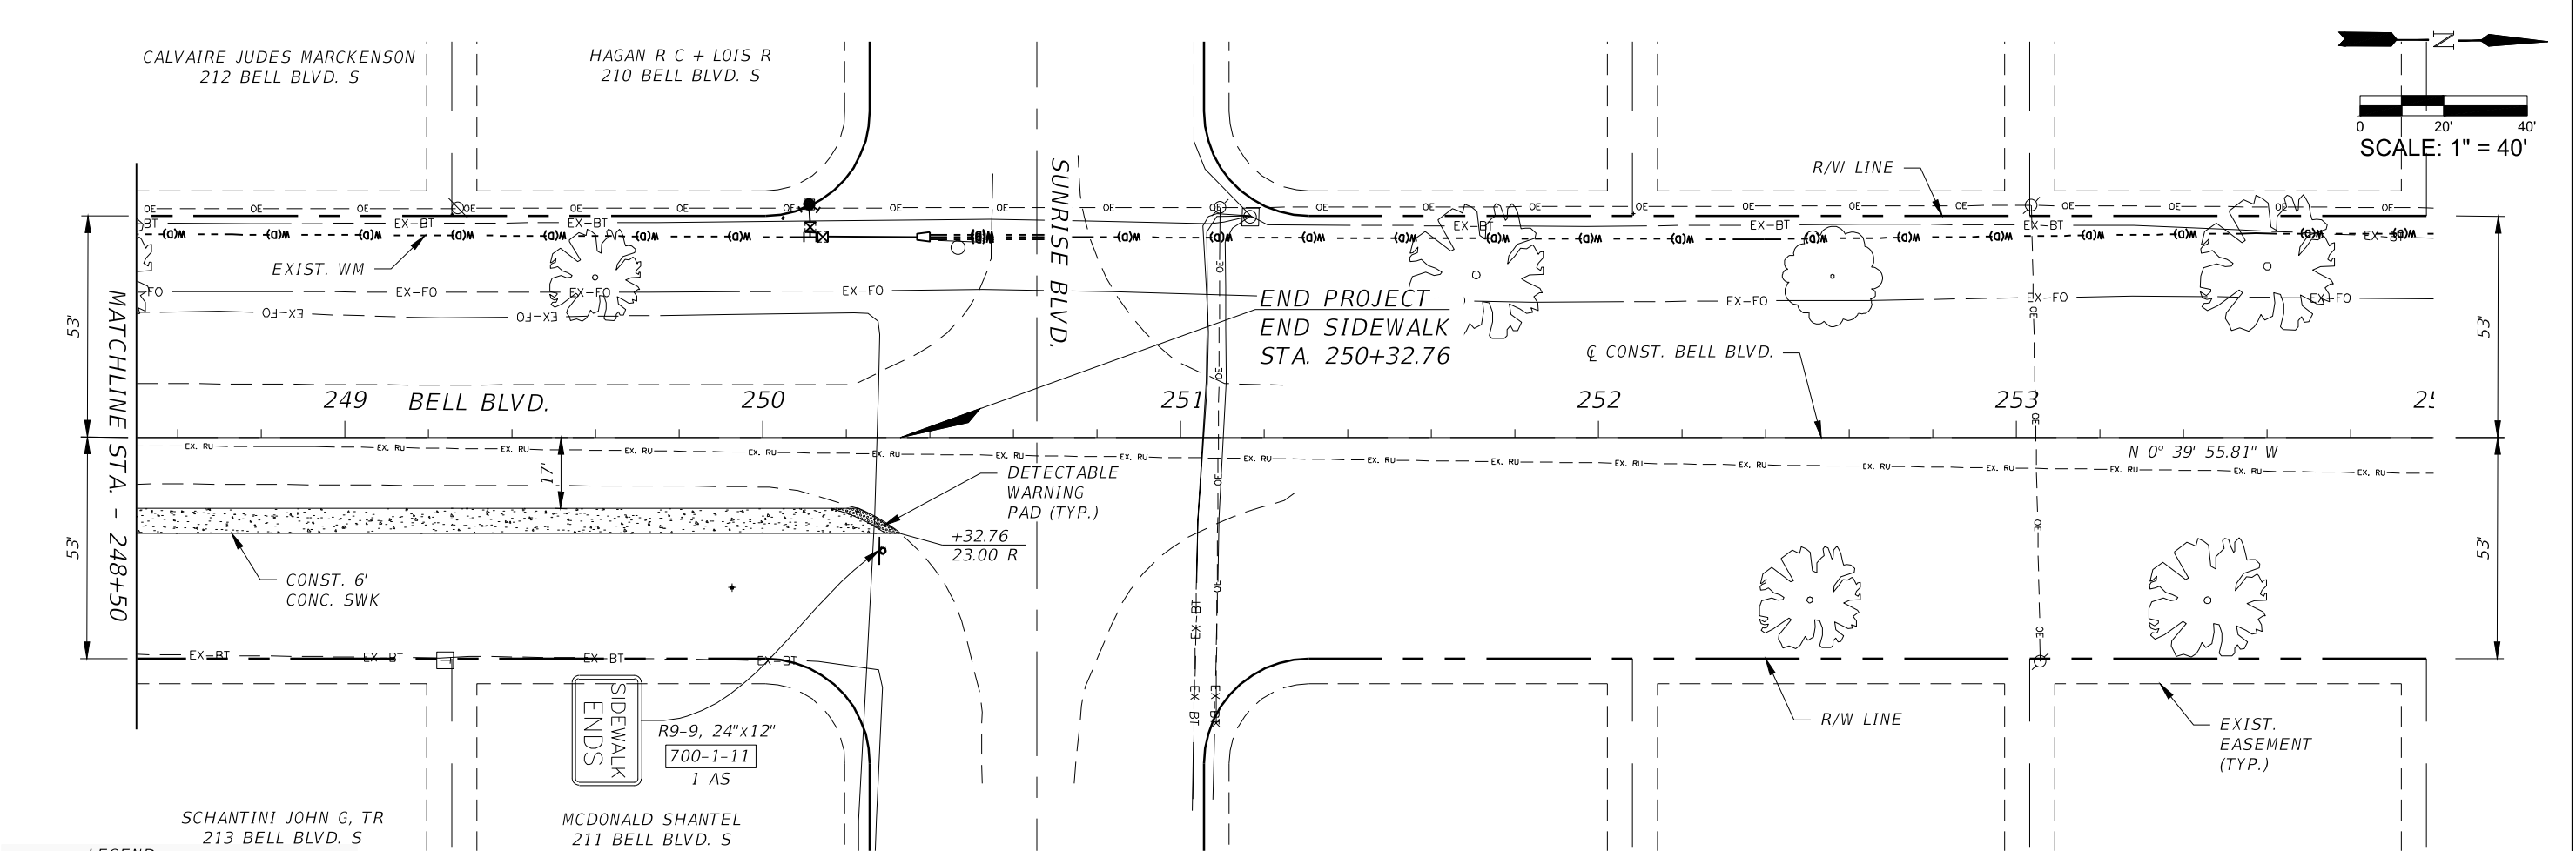


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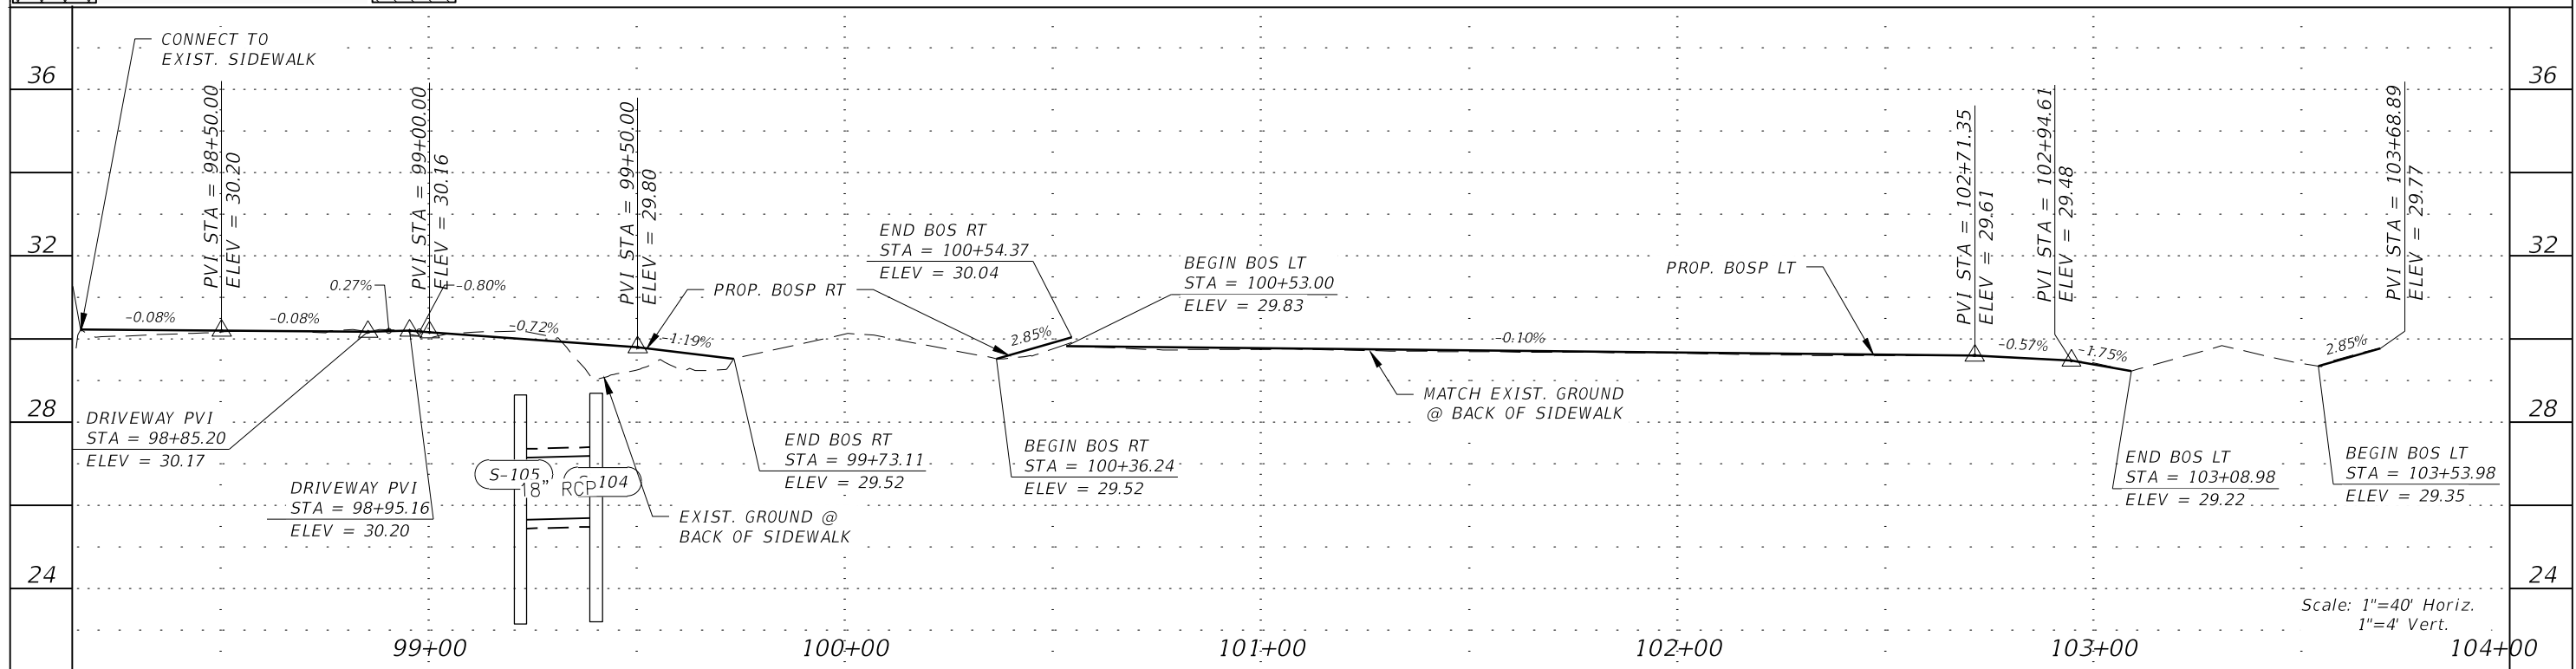
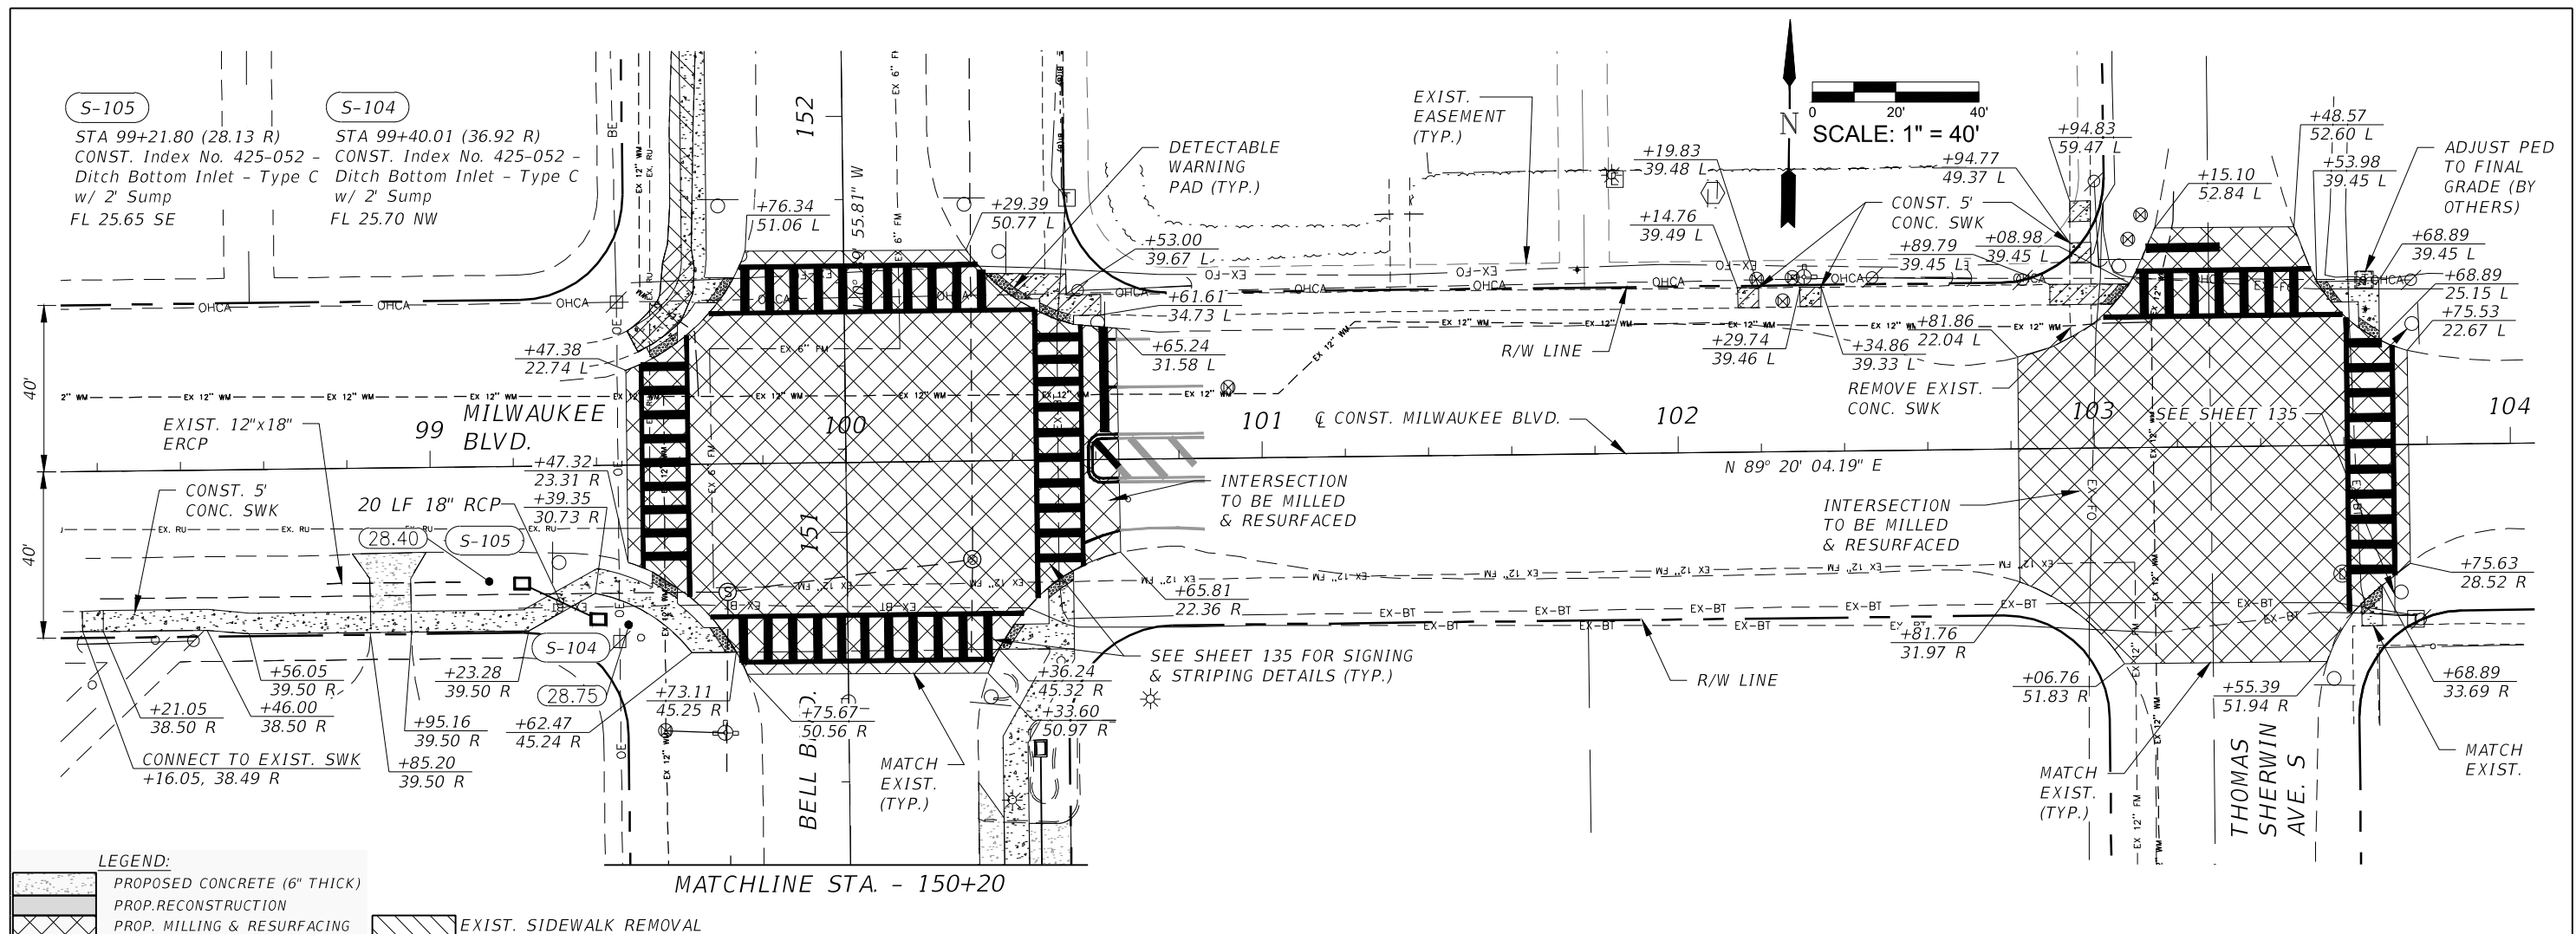
PROPOSED CONCRETE (6" THICK)

PROP. RECONSTRUCTION

PROP. MILLING & RESURFACING

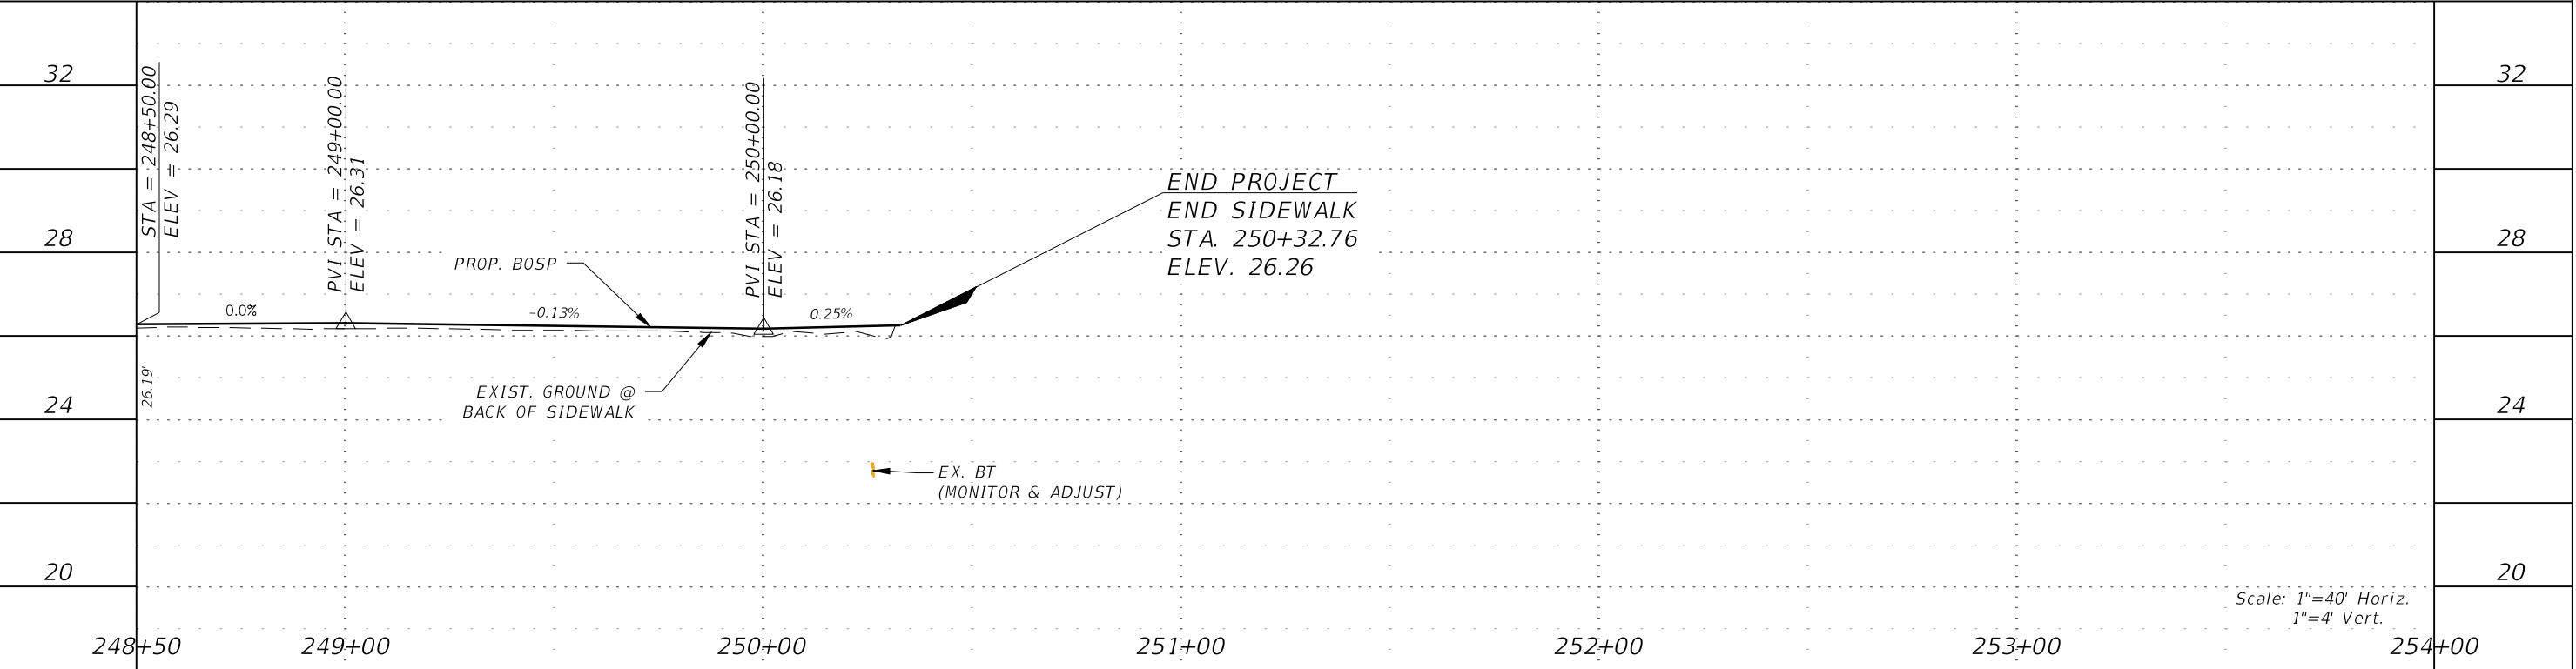

REVISIONS				<div><div></div><div>Q. Grady Minor and Associates, P.A. 3800 Via Del Rey Bonita Springs, Florida 34134 Phone: 239.947.1144 R. DANIEL FLYNN, P.E. NO. 76205</div></div> <div>Civil Engineers • Land Surveyors • Planners • Landscape Architects <small>CERT. OF AUTH. EB 0005151    CERT. OF AUTH. LB 0005151    BUSINESS LC 26000266</small></div>	LEE COUNTY		ROADWAY PLAN & PROFILE STA. 248+50 TO STA. 254+00	SHEET NO.
DATE	DESCRIPTION	DATE	DESCRIPTION		ROAD NO.	COUNTY PROJECT NO.		70
					BELL BLVD. SR 82 TO SUNRISE BLVD. SIDEWALK	6002		



REVISIONS				<div><div>Q. Grady Minor and Associates, P.A. 3800 Via Del Rey Bonita Springs, Florida 34134 Phone: 239.947.1144 R. DANIEL FLYNN, P.E. NO. 76205</div></div> <div>GradyMinor <small>Civil Engineers • Land Surveyors • Planners • Landscape Architects Cert. of Auth. EB 0005131    Cert. of Auth. LB 0005131    Business Lic. 26000266</small></div>	LEE COUNTY		ROADWAY PLAN & PROFILE MILWAUKEE BLVD. STA. 98+20 TO STA. 104+00	SHEET NO.
DATE	DESCRIPTION	DATE	DESCRIPTION		ROAD NO.	COUNTY PROJECT NO.		71
				BELL BLVD. SR 82 TO SUNRISE BLVD. SIDEWALK	6002			

LEE COUNTY  
DEPARTMENT OF TRANSPORTATION  
BELL BOULEVARD SIDEWALK ADDITION  
LEHIGH ACRES, LEE COUNTY, FLORIDA

DATE OF SURVEY : APRIL 6-8, 2022  
SURVEY MADE BY : UNIVERSAL ENGINEERING SCIENCES  
SUBMITTED BY : ADAM DORNACKER, P.E.

ROAD : BELL BOULEVARD

CROSS SECTION SOIL SURVEY FOR THE DESIGN OF ROADS  
SURVEY BEGINS: State Road 82 SURVEY ENDS: SUNRISE BOULEVARD

STRATUM NO.	ORGANIC CONTENT			SIEVE ANALYSIS RESULTS % PASS						ATTERBERG LIMITS (%)			AASHTO GROUP	DESCRIPTIONDESCRIPTION	CORROSION SERIES TEST RESULTS				
	NO. OF TESTS	% ORGANIC.	% MOISTURE CONTENT	NO. OF TESTS	4 MESH	10 MESH	40 MESH	100 MESH	200 MESH	NO. OF TESTS	LIQUID LIMIT	PLASTIC INDEX			NO. OF TESTS	RESISTIVITY ohms-cm	CHLORIDE mg/L	SULFATES mg/L	pH
1	-	-	-	-	-	-	-	-	-	-	-	-	A-3	Gray to Light Gray, Dark Brown to Light Brown, to Tan SAND (SP),slight silty (SP-SM), slightly clayey (SC) with Traces of Organics, shell, and limestone	-	-	-	-	-
2	-	-	-	-	-	-	-	-	-	-	-	-	A-2-6	Gray to Light Gray, Tan Clayey SAND (SC)	-	-	-	-	-
2	-	-	-	-	-	-	-	-	-	-	-	-	A-6	Gray, Tan CLAY (CL)	-	-	-	-	-

NOTES:


EMBANKMENT AND SUBGRADE MATERIAL  
STRATA BOUNDARIES ARE APPROXIMATE

Ground water was encountered at depths of about 2 to 4 feet at boring locations at the time of our drilling.

The material from Stratum Number 1 appears satisfactory for use in the embankment when utilized in accordance with Index 505, except where organics were encountered.


It has been the experience of the Department, with projects constructed within this general geographic area, that rock may be encountered. Therefor the contractor should consider the increased cost of all underground work activities while preparing the bid.

All costs of rock excavation shall be included in the appropriate items of work contained within the contract. No extra compensation of time extension will be allowed for additional work directly associated with the splitting, excavation, excavation, crushing, disposal, replacement, of displaced volume of extracted rock with fill material or special handling of rock

REVISIONS							UNIVERSAL ENGINEERING 201 WALDO AVE NORTH LEHIGH ACRES, FLORIDA 33971  Adam J. Dornacker, P.E. #85319	LEE COUNTY DEPARTMENT OF TRANSPORTATION			ROADWAY SOIL SURVEY BELL BOULEVARD SIDEWALK ADDITION LEHIGH ACRES, LEE COUNTY, FLORIDA		SHEET NO.  72
DATE	BY	DESCRIPTION	DATE	BY	DESCRIPTION			ROAD NAME	COUNTY NAME	PROJECT ID			
								BELL BOULEVARD	LEE	0530.2100395.0000			



SOIL PROFILES

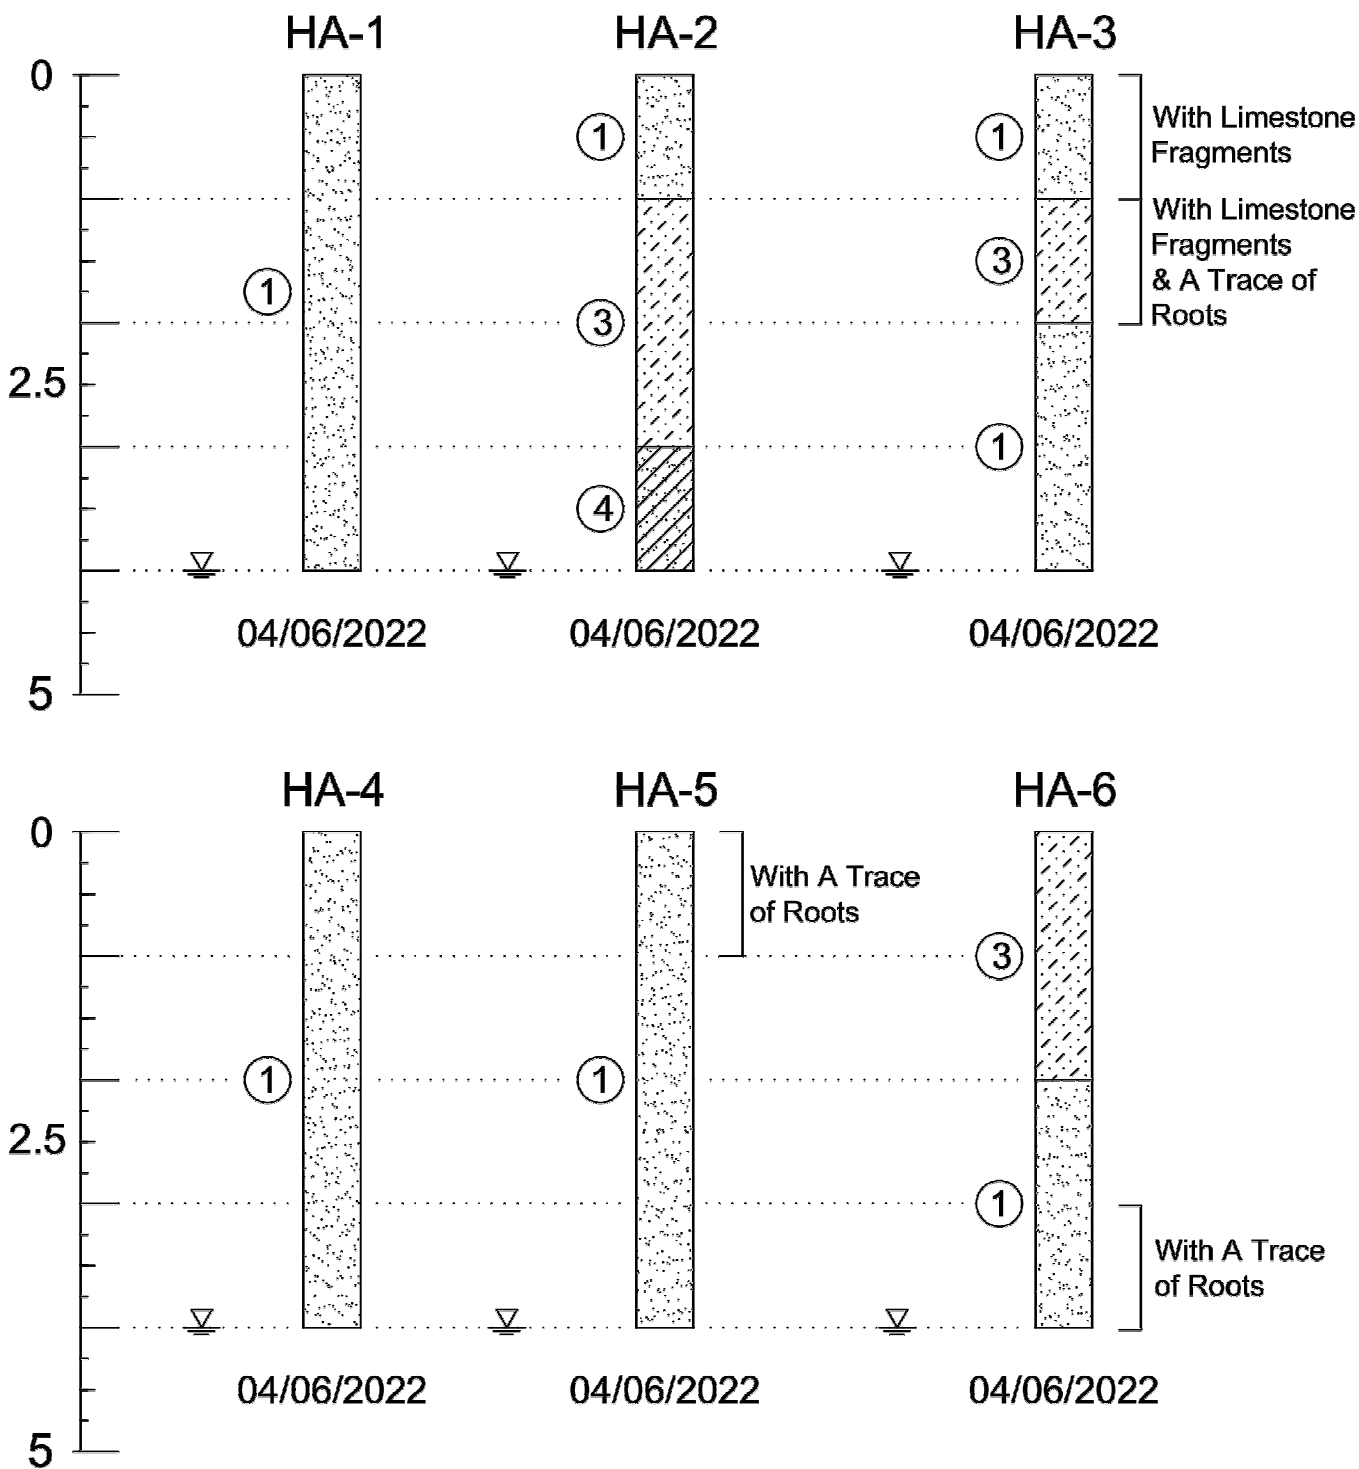

SOIL PROFILE LEGEND

HA-X = HAND AUGER NUMBER

SOIL TYPE (X) SOIL SYMBOL

GROUND WATER LEVEL

INDICATES PRACTICAL REFUSAL TO EQUIPMENT

= INDICATES GRADUAL TRANSITION IN SOIL TYPES

SOIL LEGEND

- ① Brown to Dark Brown, Black, Dark Gray to Light Gray, Orange, Tan, Yellow SAND (SP)
- ② Gray Slightly Silty SAND (SP-SM)
- ③ Brown to Light Brown, Dark Gray to Light Gray, Tan Slightly Clayey SAND (SP-SC)
- ④ Gray to Light Gray, Tan Clayey SAND (SC)
- ⑤ Gray, Tan CLAY (CL)

SOIL CLASSIFICATION

APPROXIMATE FINES CONTENT	MODIFIERS	APPROXIMATE SHELL CONTENT	MODIFIERS	APPROXIMATE ORGANIC CONTENT	MODIFIERS
5% TO 15%	SLIGHTLY SILTY OR SLIGHTLY CLAYEY	0% TO 12%	SLIGHTLY SHELLY	2.5% TO 5%	WITH A TRACE
16% TO 25%	SILTY OR CLAYEY	13% TO 30%	SHELLY	5% TO 20%	WITH ORGANICS
26% TO 49%	VERY SILTY OR VERY CLAYEY	31% TO 50%	VERY SHELLY	20% TO 75%	HIGHLY ORGANIC
				75% TO 100%	PEAT

DEFINITION OF DESCRIPTIVE TERMS OF MODIFIERS FOR SILTS/CLAYS/SHELLS/GRAVELS ARE DESCRIBED AS FOLLOWS:

PERCENTAGE OF MODIFIER MATERIAL	FIRST QUALIFIER	SECOND QUALIFIER
5 - 12	SLIGHTLY + MODIFIER + Y	WITH A LITTLE
12 - 30	MODIFIER + Y	WITH SOME
30 - 50	VERY + MODIFIER + Y	AND

RECORD OF TEST BORINGS

	Universal Engineering Sciences 201 Waldo Ave. N. Lehigh Acres, Florida 33971 239-489-2443 www.universalengineering.com	Client: Grady Minor Project No: 0530.2100395.0000 Project: Bell Blvd Sidewalk Alexander Graham Bell Blvd from SR 82 to Sunrise Blvd, Lehigh Acres, Lee County, FL	Date: 04/19/2022 Field Rep.: GW, DB Drawn By: GB Approved by: AJD

REVISIONS

DATE	BY	DESCRIPTION	DATE	BY	DESCRIPTION



UNIVERSAL ENGINEERING  
201 WALDO AVE NORTH  
LEHIGH ACRES, FLORIDA 33971  
Adam J. Dornacker, P.E. #85319

LEE COUNTY  
DEPARTMENT OF TRANSPORTATION


ROAD NAME	COUNTY NAME	PROJECT ID
BELL BOULEVARD	LEE	0530.2100395.0000

ROADWAY SOIL SURVEY  
BELL BOULEVARD SIDEWALK ADDITION  
LEHIGH ACRES, LEE COUNTY, FLORIDA

SHEET NO.

73

SOIL PROFILES

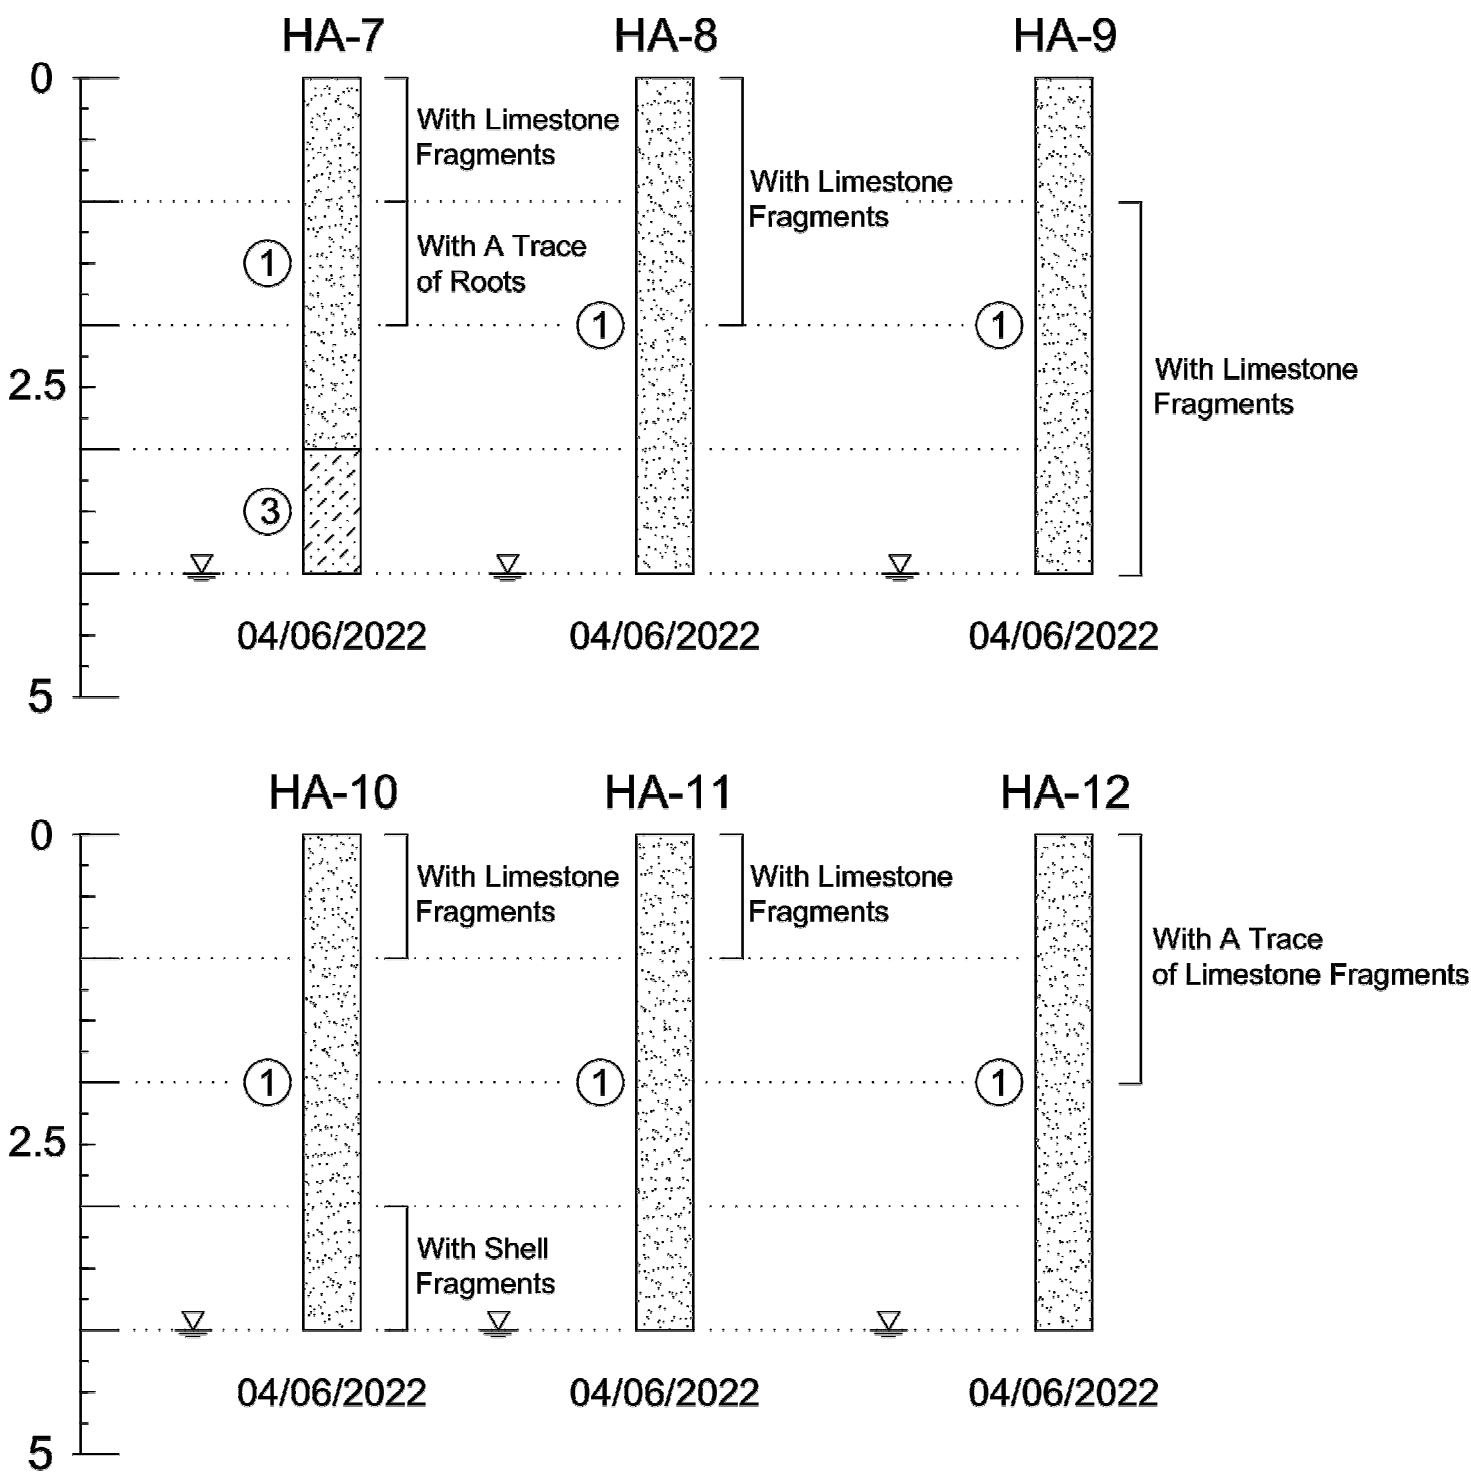

SOIL PROFILE LEGEND

HA-X = HAND AUGER NUMBER  
SOIL TYPE (X)  
GROUND WATER LEVEL  
INDICATES PRACTICAL REFUSAL TO EQUIPMENT  
= INDICATES GRADUAL TRANSITION IN SOIL TYPES

SOIL LEGEND

- 1 Brown to Dark Brown, Black, Dark Gray to Light Gray, Orange, Tan, Yellow SAND (SP)
- 2 Gray Slightly Silty SAND (SP-SM)
- 3 Brown to Light Brown, Dark Gray to Light Gray, Tan Slightly Clayey SAND (SP-SC)
- 4 Gray to Light Gray, Tan Clayey SAND (SC)
- 5 Gray, Tan CLAY (CL)

SOIL CLASSIFICATION

APPROXIMATE FINES CONTENT	MODIFIERS	APPROXIMATE SHELL CONTENT	MODIFIERS	APPROXIMATE ORGANIC CONTENT	MODIFIERS
5% TO 15%	SLIGHTLY SILTY OR SLIGHTLY CLAYEY	6% TO 12%	SLIGHTLY SHELLY	2.5% TO 5%	WITH A TRACE
16% TO 25%	SILTY OR CLAYEY	13% TO 30%	SHELLY	5% TO 20%	WITH ORGANICS
26% TO 49%	VERY SILTY OR VERY CLAYEY	31% TO 50%	VERY SHELLY	20% TO 75%	HIGHLY ORGANIC
				75% TO 100%	PEAT

DEFINITION OF DESCRIPTIVE TERMS OF MODIFIERS FOR SILTS/CLAYS/SHELLS/GRAVELS ARE DESCRIBED AS FOLLOWS:

PERCENTAGE OF MODIFIER MATERIAL	FIRST QUALIFIER	SECOND QUALIFIER
5 - 12	SLIGHTLY + MODIFIER + Y	WITH A LITTLE
12 - 30	MODIFIER + Y	WITH SOME
30 - 50	VERY + MODIFIER + Y	AND

RECORD OF TEST BORINGS

	Universal Engineering Sciences 201 Waldo Ave. N. Lehigh Acres, Florida 33971 239-489-2443 www.universalengineering.com	Client: Grady Minor Project No: 0530.2100395.0000 Project: Bell Blvd Sidewalk Alexander Graham Bell Blvd from SR 82 to Sunrise Blvd, Lehigh Acres, Lee County, FL	Date: 04/19/2022 Field Rep.: GW, DB Drawn By: GB Approved by: AJD

REVISIONS

DATE	BY	DESCRIPTION	DATE	BY	DESCRIPTION



UNIVERSAL ENGINEERING  
201 WALDO AVE NORTH  
LEHIGH ACRES, FLORIDA 33971  
Adam J. Dornacker, P.E. #85319

LEE COUNTY  
DEPARTMENT OF TRANSPORTATION


ROAD NAME	COUNTY NAME	PROJECT ID
BELL BOULEVARD	LEE	0530.2100395.0000

ROADWAY SOIL SURVEY  
BELL BOULEVARD SIDEWALK ADDITION  
LEHIGH ACRES, LEE COUNTY, FLORIDA

SHEET NO.

74

SOIL PROFILES

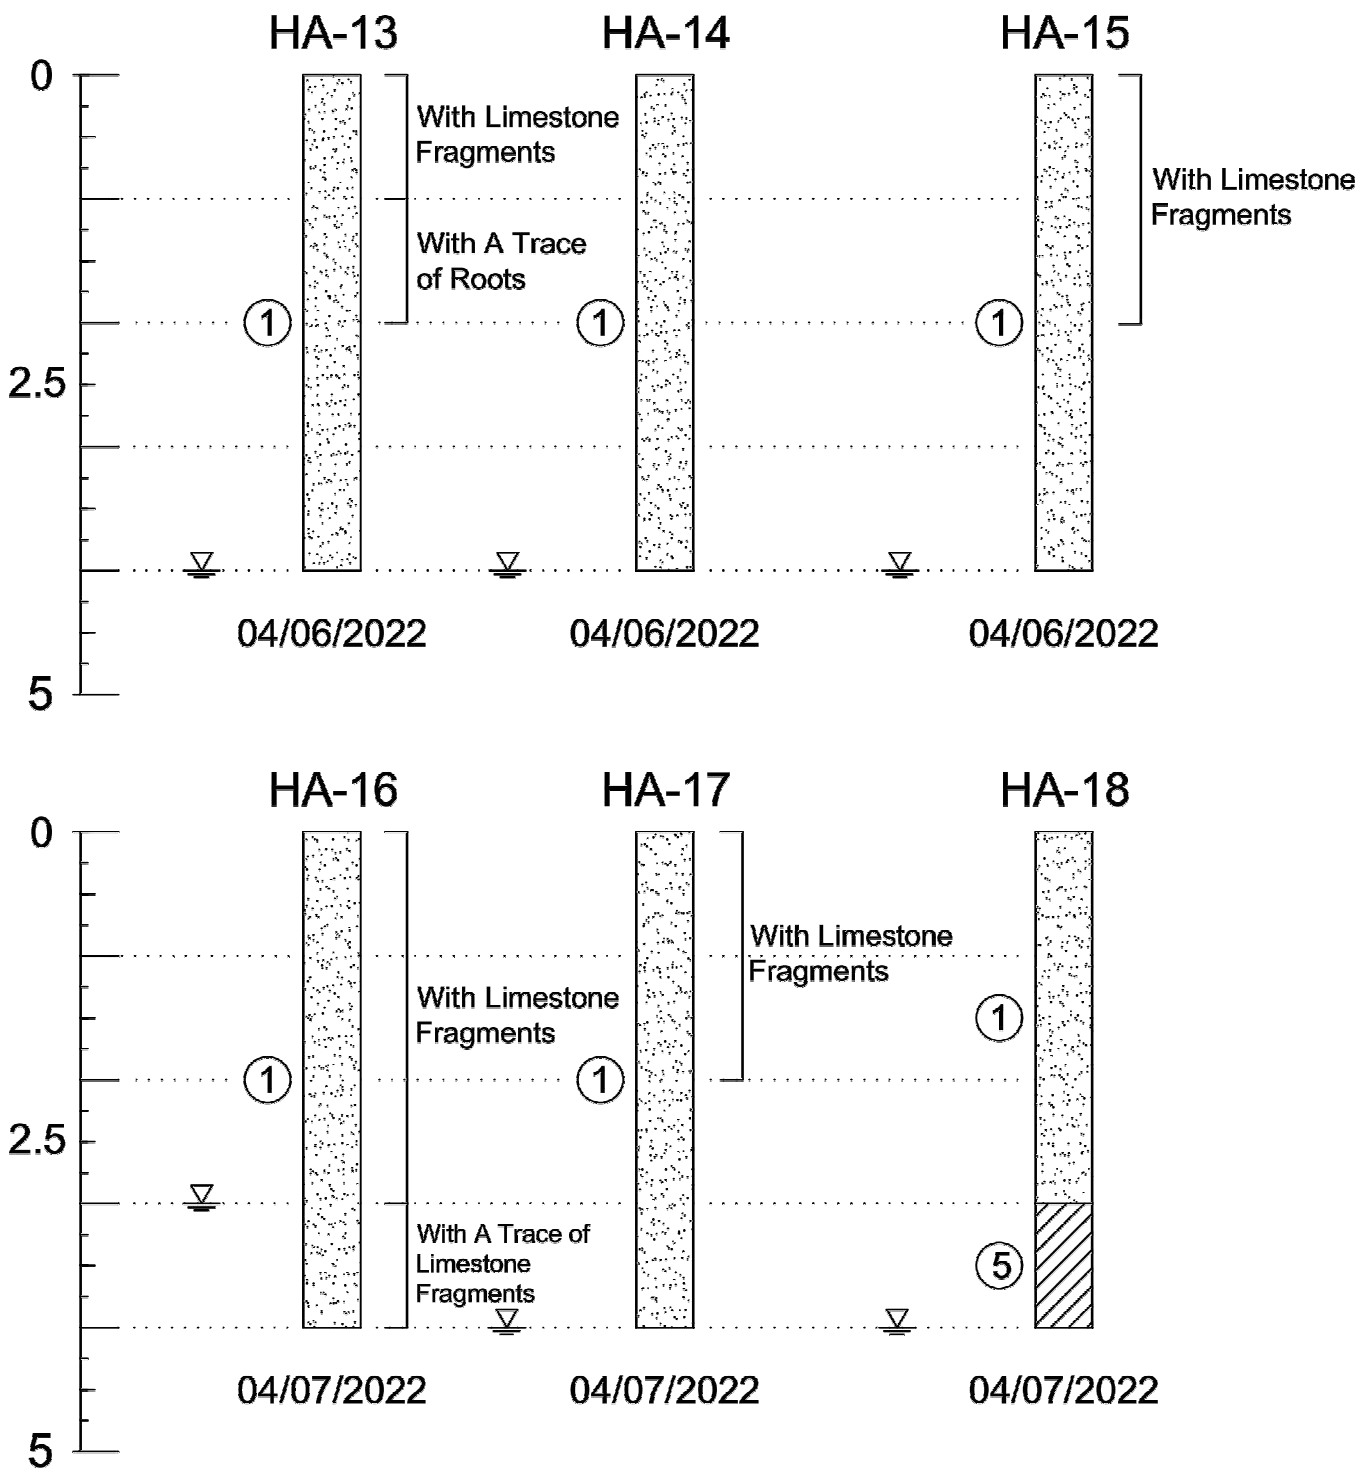

SOIL PROFILE LEGEND

HA-X = HAND AUGER NUMBER  
SOIL TYPE (X)  
GROUND WATER LEVEL  
INDICATES PRACTICAL REFUSAL TO EQUIPMENT  
= INDICATES GRADUAL TRANSITION IN SOIL TYPES

SOIL LEGEND

- 1 Brown to Dark Brown, Black, Dark Gray to Light Gray, Orange, Tan, Yellow SAND (SP)
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- 3 Brown to Light Brown, Dark Gray to Light Gray, Tan Slightly Clayey SAND (SP-SC)
- 4 Gray to Light Gray, Tan Clayey SAND (SC)
- 5 Gray, Tan CLAY (CL)

SOIL CLASSIFICATION

APPROXIMATE FINES CONTENT	MODIFIERS	APPROXIMATE SHELL CONTENT	MODIFIERS	APPROXIMATE ORGANIC CONTENT	MODIFIERS
5% TO 15%	SLIGHTLY SILTY OR SLIGHTLY CLAYEY	0% TO 12%	SLIGHTLY SHELLY	2.5% TO 5%	WITH A TRACE
16% TO 25%	SILTY OR CLAYEY	13% TO 30%	SHELLY	5% TO 20%	WITH ORGANICS
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				75% TO 100%	PEAT

DEFINITION OF DESCRIPTIVE TERMS OF MODIFIERS FOR SILTS/CLAYS/SHELLS/GRAVELS ARE DESCRIBED AS FOLLOWS:

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5 - 12	SLIGHTLY + MODIFIER + Y	WITH A LITTLE
12 - 30	MODIFIER + Y	WITH SOME
30 - 50	VERY + MODIFIER + Y	AND

RECORD OF TEST BORINGS



Universal Engineering Sciences  
201 Waldo Ave. N.  
Lehigh Acres, Florida 33971  
239-489-2443  
www.universalengineering.com

Client: Grady Minor  
Project No: 0530.2100395.0000  
Project:  
Bell Blvd Sidewalk  
Alexander Graham Bell Blvd  
from SR 82 to Sunrise Blvd,  
Lehigh Acres, Lee County, FL

Date: 04/19/2022  
Field Rep.: GW, DB  
Drawn By: GB  
Approved by: AJD

REVISIONS

DATE	BY	DESCRIPTION	DATE	BY	DESCRIPTION



UNIVERSAL ENGINEERING  
201 WALDO AVE NORTH  
LEHIGH ACRES, FLORIDA 33971  
Adam J. Dornacker, P.E. #85319

LEE COUNTY  
DEPARTMENT OF TRANSPORTATION


ROAD NAME	COUNTY NAME	PROJECT ID
BELL BOULEVARD	LEE	0530.2100395.0000

ROADWAY SOIL SURVEY  
BELL BOULEVARD SIDEWALK ADDITION  
LEHIGH ACRES, LEE COUNTY, FLORIDA

SHEET NO.

75

SOIL PROFILES

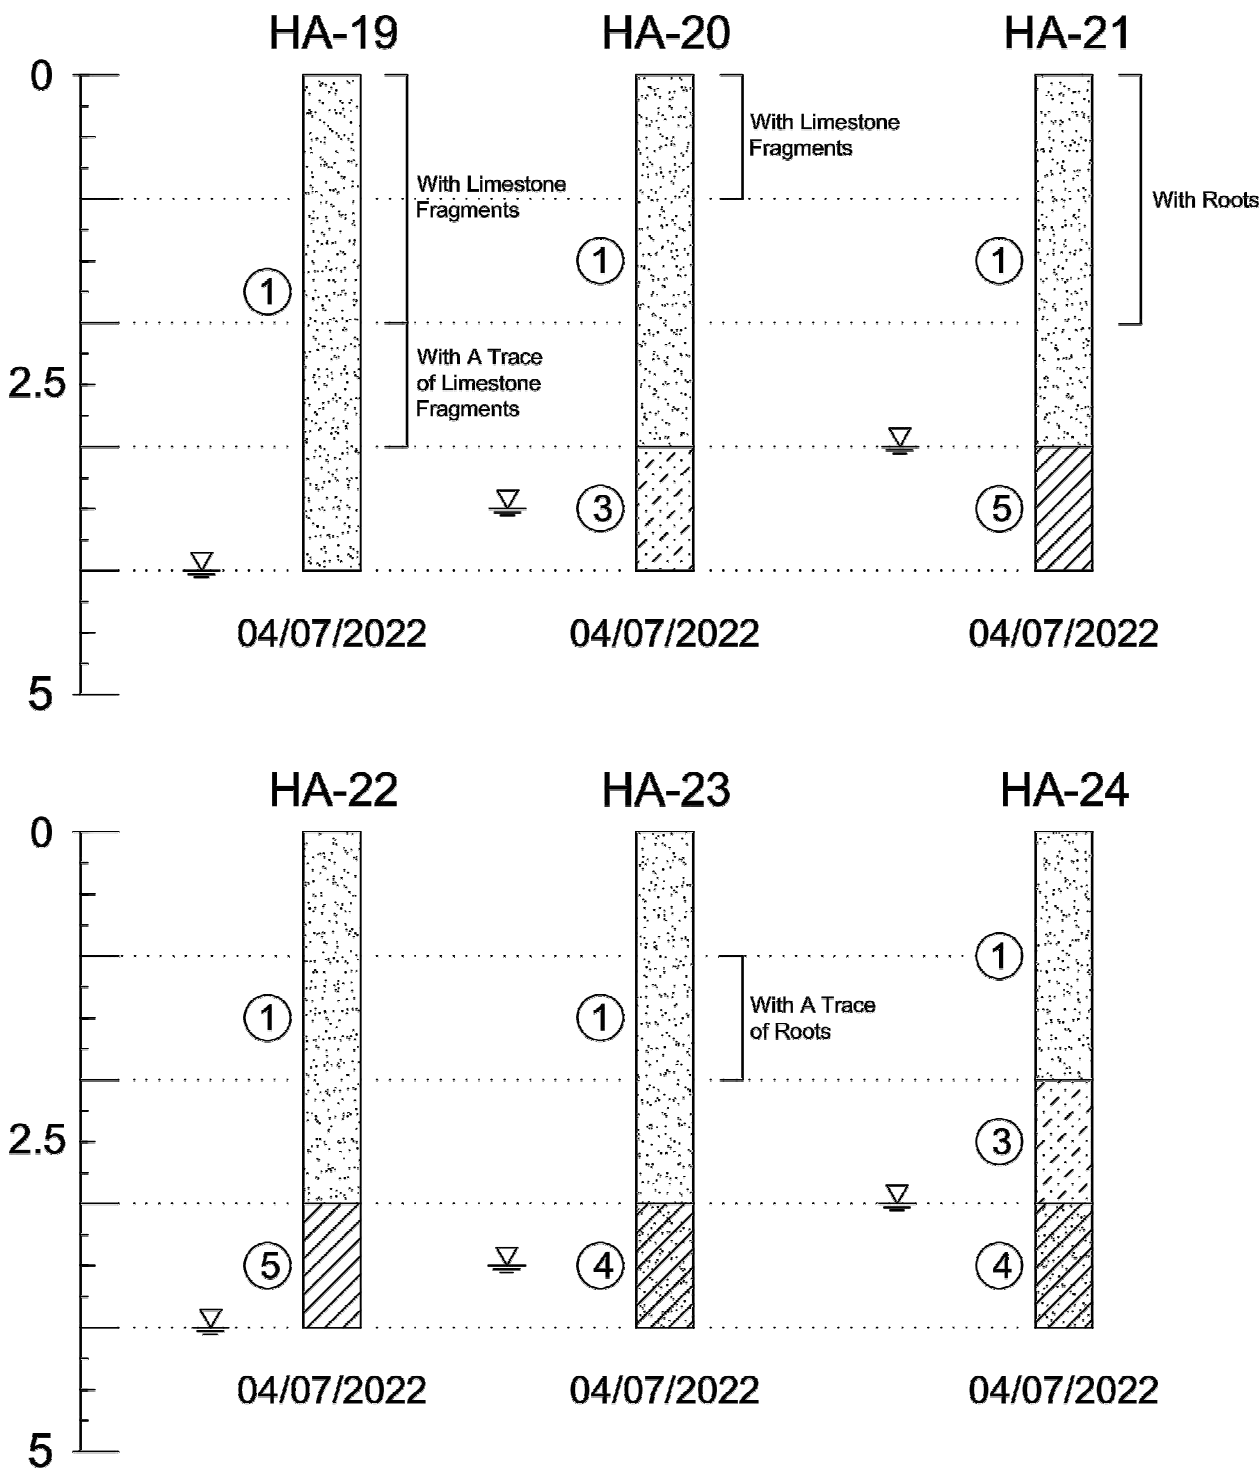

SOIL PROFILE LEGEND

HA-X = HAND AUGER NUMBER  
SOIL TYPE (X)  
GROUND WATER LEVEL  
= INDICATES GRADUAL TRANSITION IN SOIL TYPES  
INDICATES PRACTICAL REFUSAL TO EQUIPMENT

SOIL LEGEND

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- ④ Gray to Light Gray, Tan Clayey SAND (SC)
- ⑤ Gray, Tan CLAY (CL)

SOIL CLASSIFICATION

APPROXIMATE FINES CONTENT	MODIFIERS	APPROXIMATE SHELL CONTENT	MODIFIERS	APPROXIMATE ORGANIC CONTENT	MODIFIERS
5% TO 15%	SLIGHTLY SILTY OR SLIGHTLY CLAYEY	0% TO 12%	SLIGHTLY SHELLY	2.5% TO 5%	WITH A TRACE
16% TO 25%	SILTY OR CLAYEY	13% TO 30%	SHELLY	5% TO 20%	WITH ORGANICS
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				75% TO 100%	PEAT

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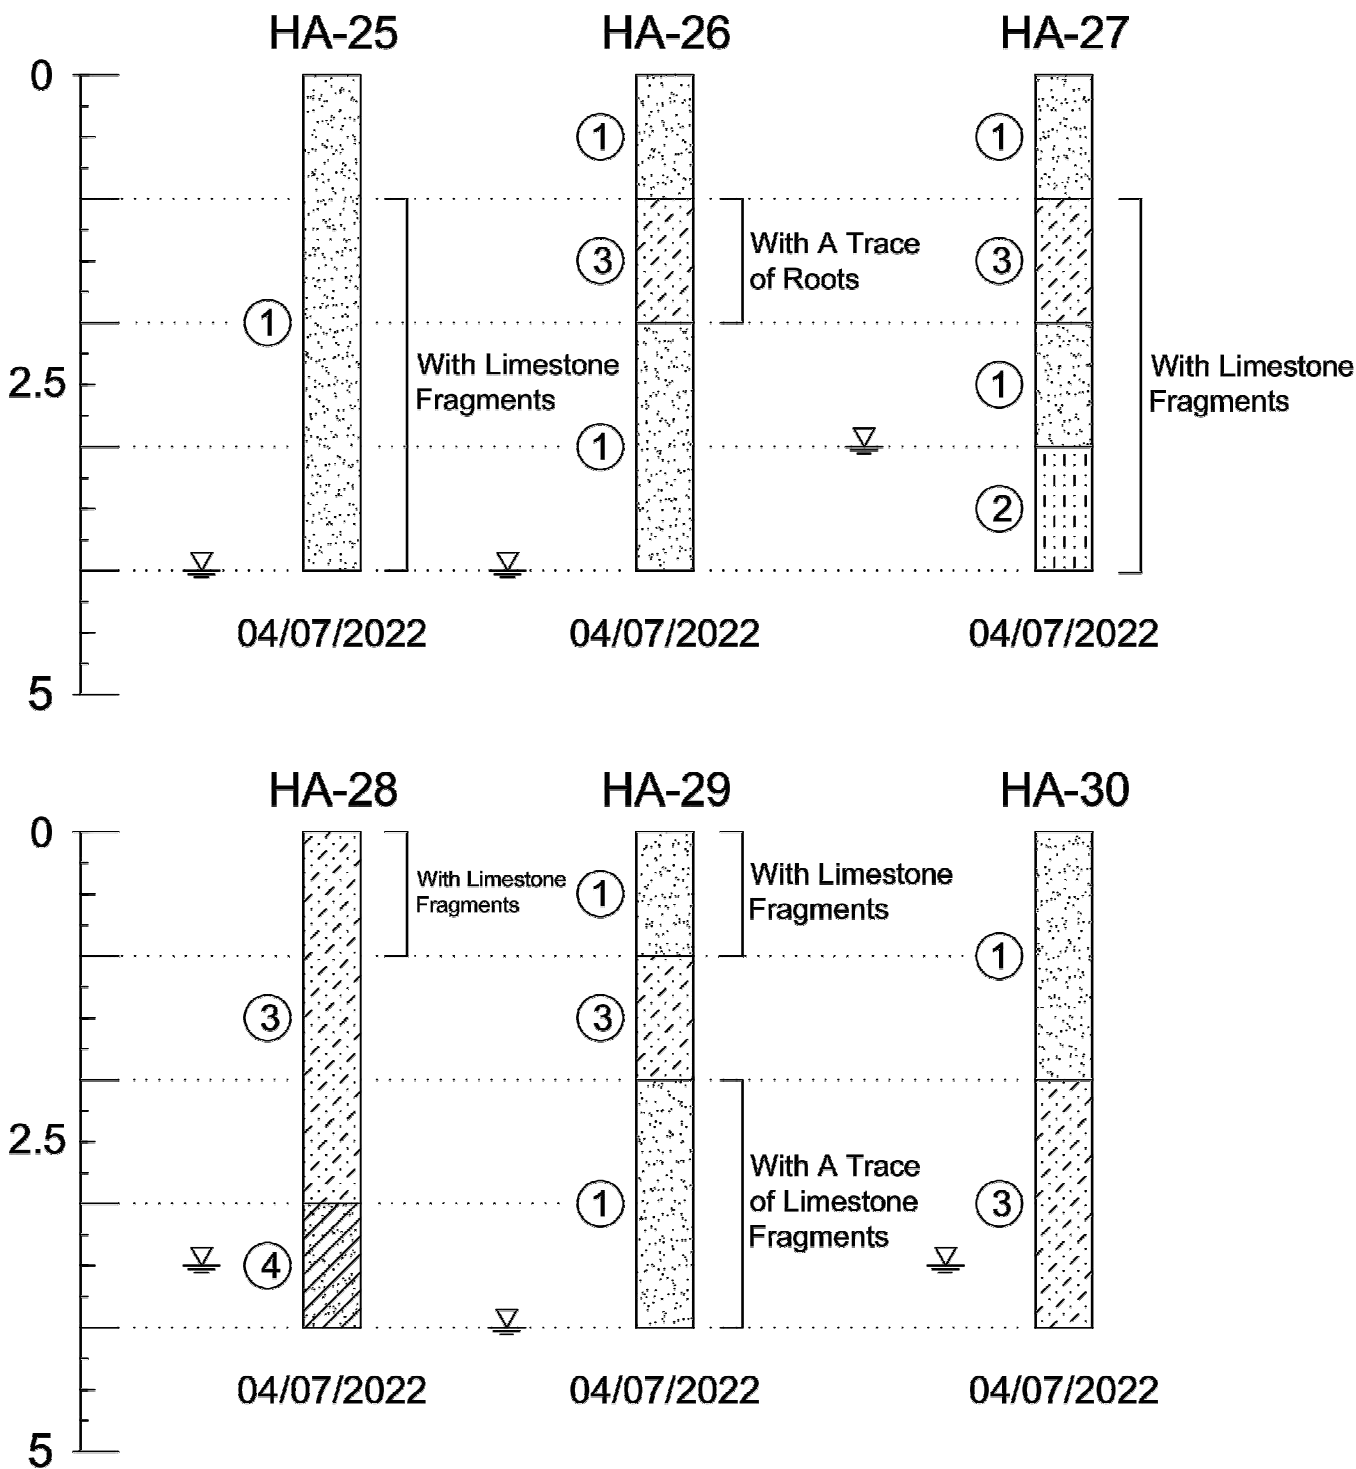
PERCENTAGE OF MODIFIER MATERIAL	FIRST QUALIFIER	SECOND QUALIFIER
5 - 12	SLIGHTLY + MODIFIER + Y	WITH A LITTLE
12 - 30	MODIFIER + Y	WITH SOME
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RECORD OF TEST BORINGS

	Universal Engineering Sciences 201 Waldo Ave. N. Lehigh Acres, Florida 33971 239-489-2443 www.universalengineering.com	Client: Grady Minor Project No: 0530.2100395.0000 Project: Bell Blvd Sidewalk Alexander Graham Bell Blvd from SR 82 to Sunrise Blvd, Lehigh Acres, Lee County, FL	Date: 04/19/2022 Field Rep.: GW, DB Drawn By: GB Approved by: AJD



SOIL PROFILES



SOIL PROFILE LEGEND

HA-X = HAND AUGER NUMBER

SOIL TYPE (X) SOIL SYMBOL

INDICATES PRACTICAL REFUSAL TO EQUIPMENT

GROUND WATER LEVEL

= INDICATES GRADUAL TRANSITION IN SOIL TYPES

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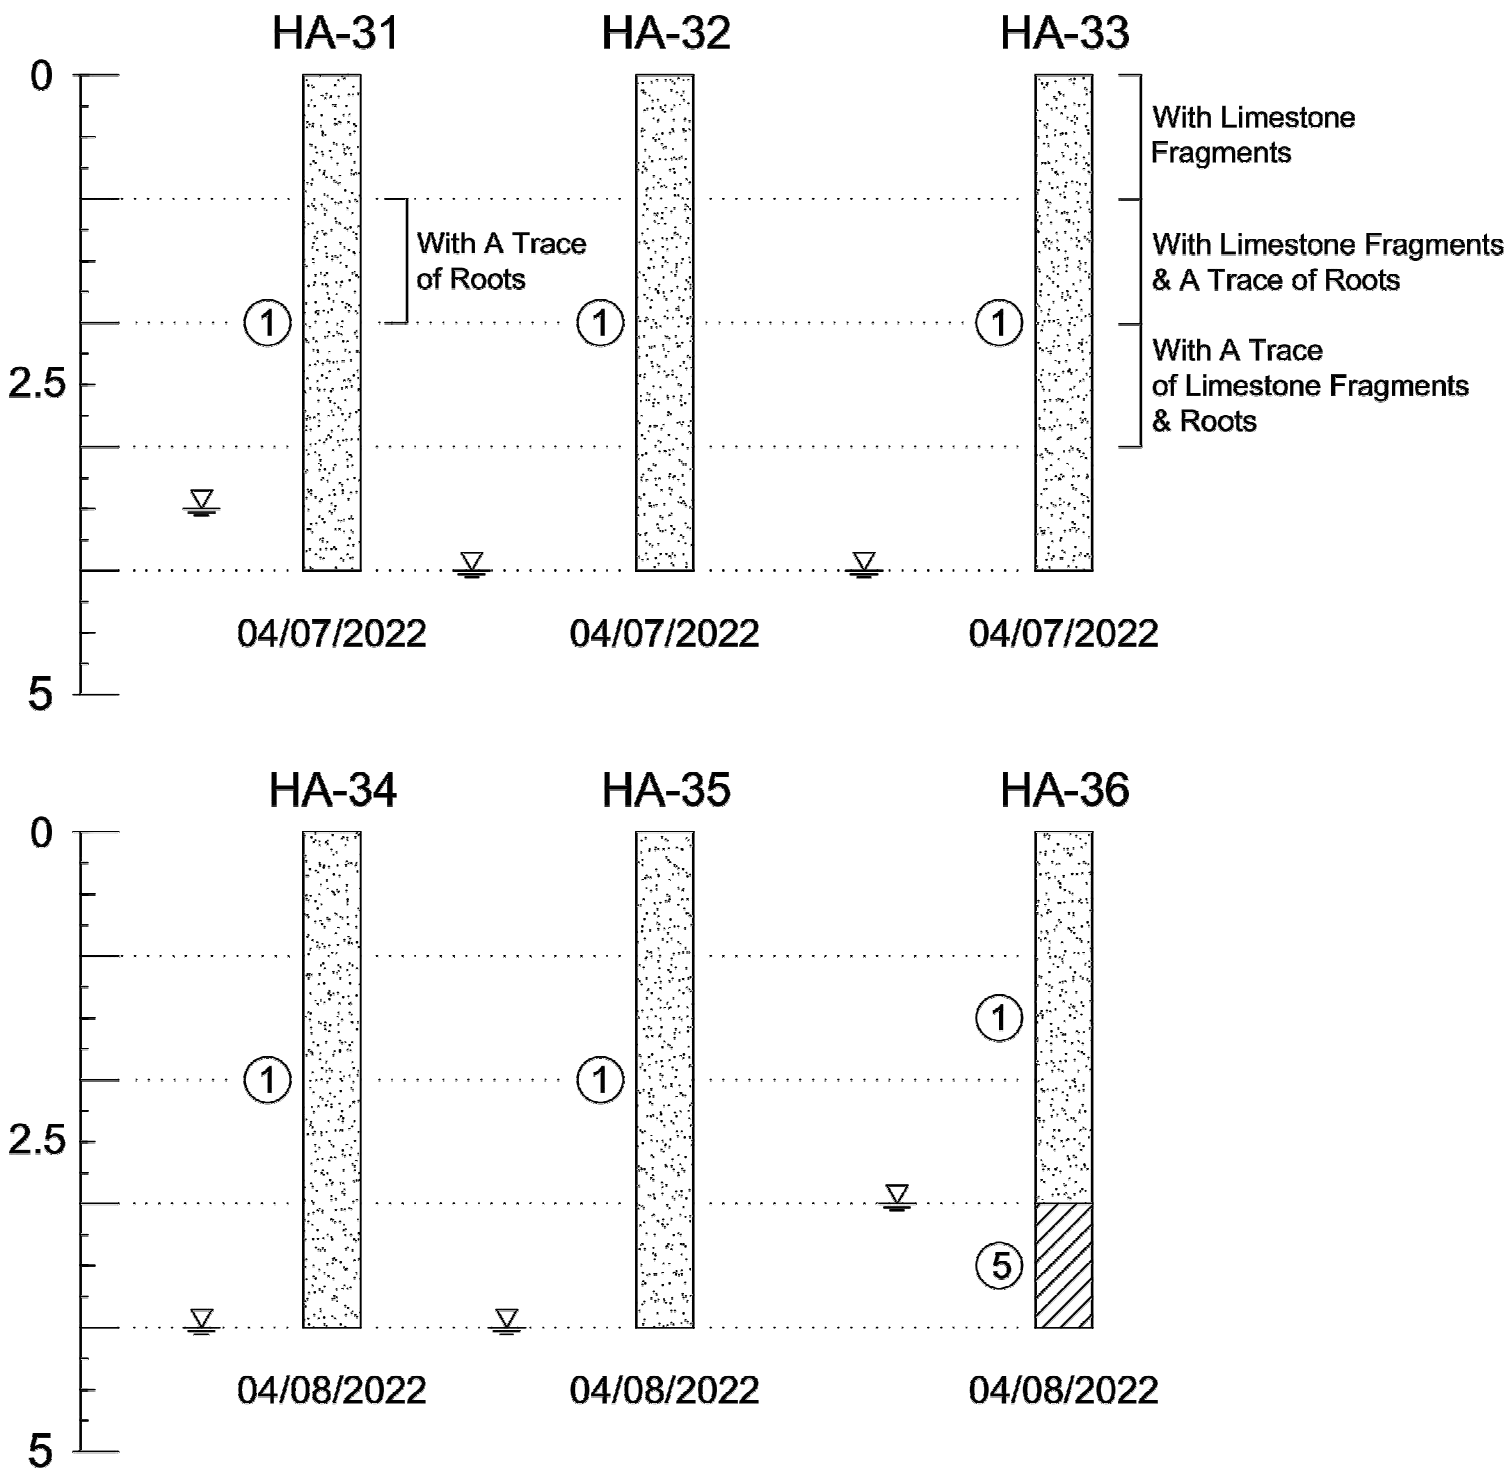
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SOIL PROFILES



SOIL PROFILE LEGEND

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				75% TO 100%	PEAT


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SOIL PROFILES



SOIL PROFILE LEGEND

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
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RECORD OF TEST BORINGS

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REVISIONS

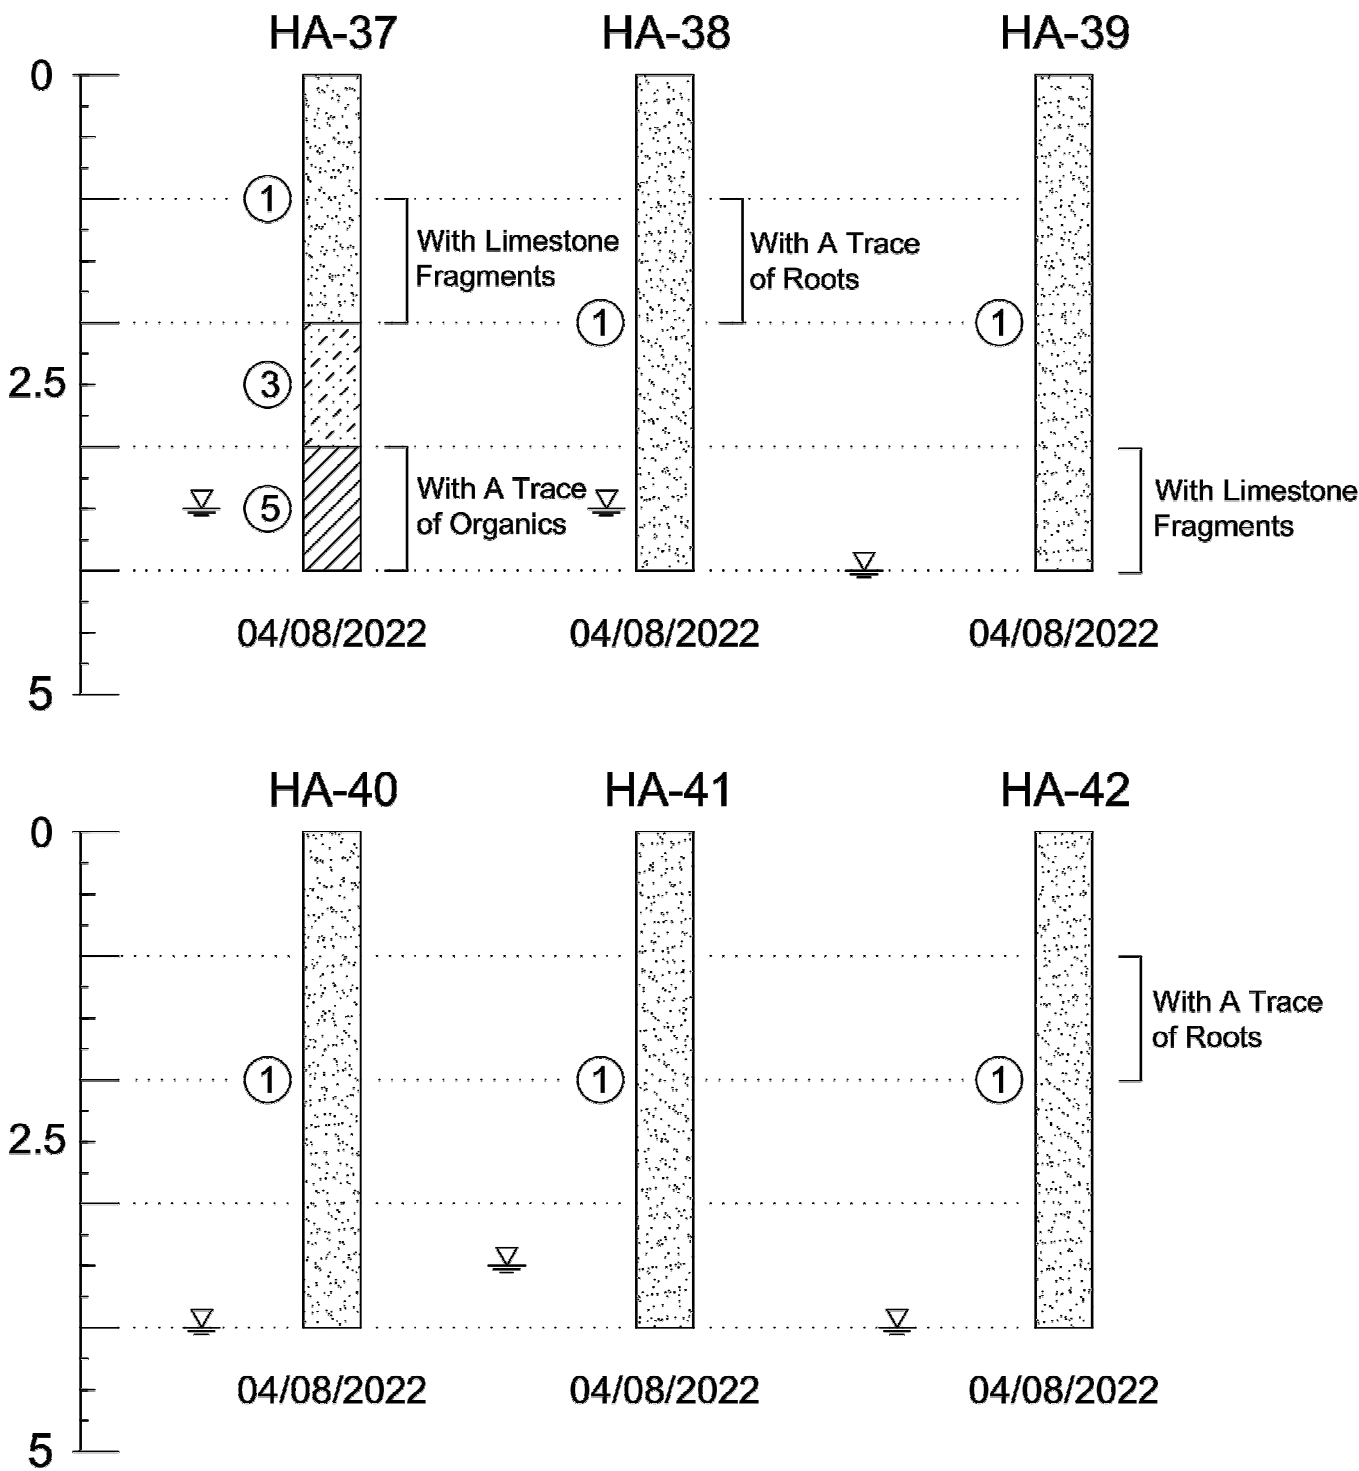DATE	BY	DESCRIPTION	DATE	BY	DESCRIPTION



UNIVERSAL ENGINEERING  
201 WALDO AVE NORTH  
LEHIGH ACRES, FLORIDA 33971  
Adam J. Dornacker, P.E. #85319

LEE COUNTY  
DEPARTMENT OF TRANSPORTATION

ROAD NAME	COUNTY NAME	PROJECT ID
BELL BOULEVARD	LEE	0530.2100395.0000


ROADWAY SOIL SURVEY

BELL BOULEVARD SIDEWALK ADDITION  
LEHIGH ACRES, LEE COUNTY, FLORIDA

SHEET NO.

79

SOIL PROFILES

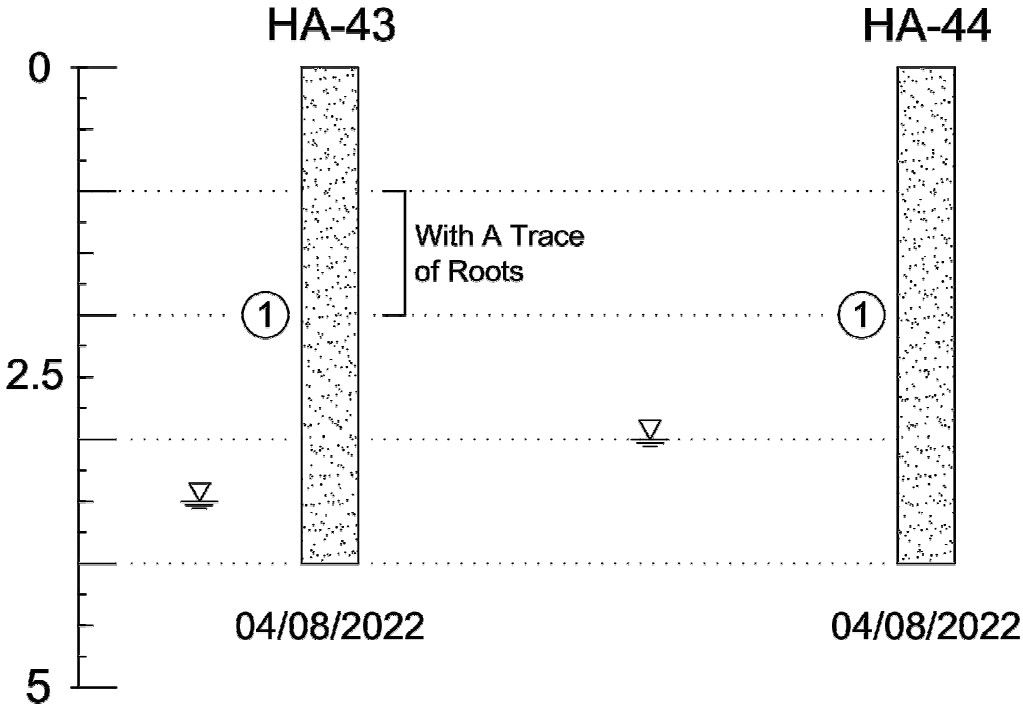

SOIL PROFILE LEGEND

HA-X = HAND AUGER NUMBER  
SOIL TYPE (X)  
GROUND WATER LEVEL  
INDICATES PRACTICAL REFUSAL TO EQUIPMENT  
= INDICATES GRADUAL TRANSITION IN SOIL TYPES

SOIL LEGEND

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SOIL CLASSIFICATION

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12 - 30	MODIFIER + Y	WITH SOME
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UNIVERSAL ENGINEERING  
201 WALDO AVE NORTH  
LEHIGH ACRES, FLORIDA 33971  
Adam J. Dornacker, P.E. #85319

LEE COUNTY  
DEPARTMENT OF TRANSPORTATION


ROAD NAME	COUNTY NAME	PROJECT ID
BELL BOULEVARD	LEE	0530.2100395.0000

ROADWAY SOIL SURVEY  
BELL BOULEVARD SIDEWALK ADDITION  
LEHIGH ACRES, LEE COUNTY, FLORIDA


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80



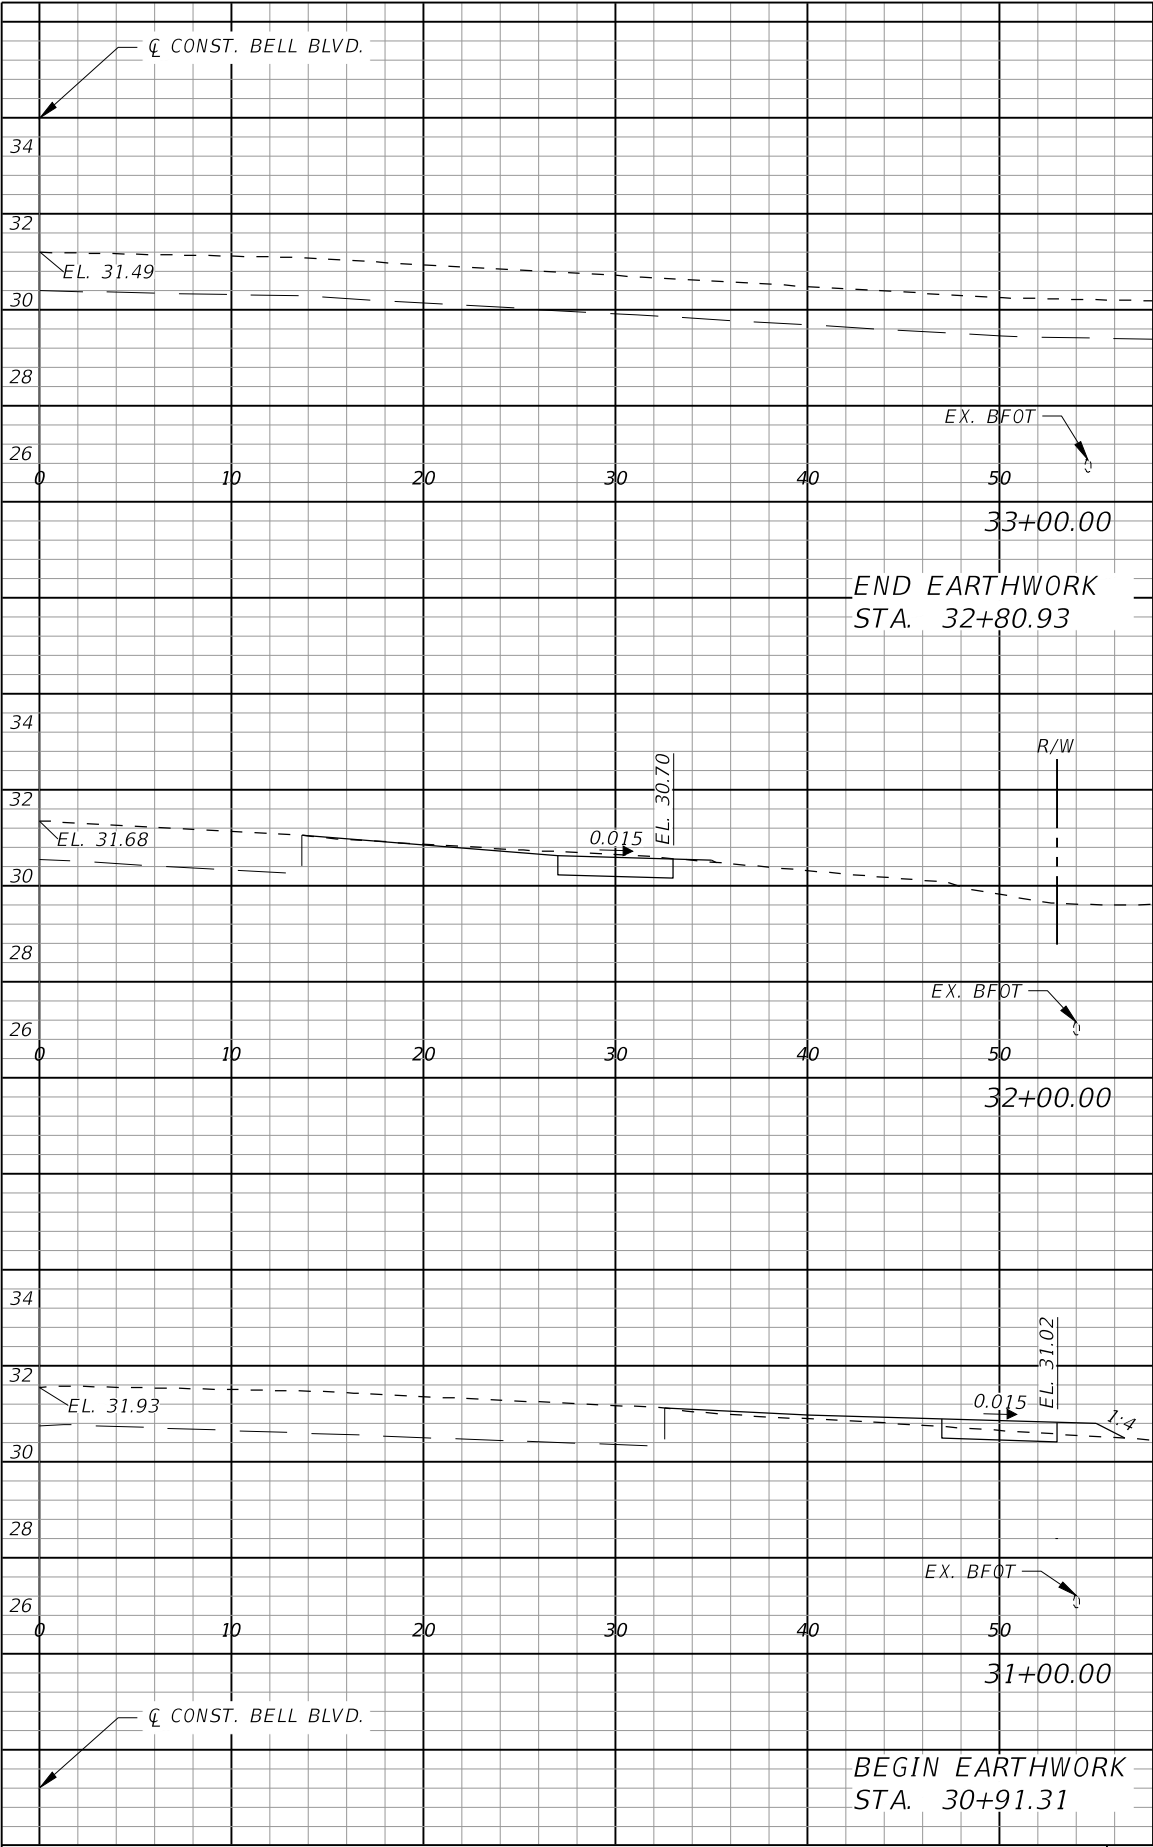


Regular		Exc.	Embankment	
AREA	VOL.		AREA	VOL.
SF	CY		SF	CY
0			0	
4			1	
10			6	
1			3	
0			0	

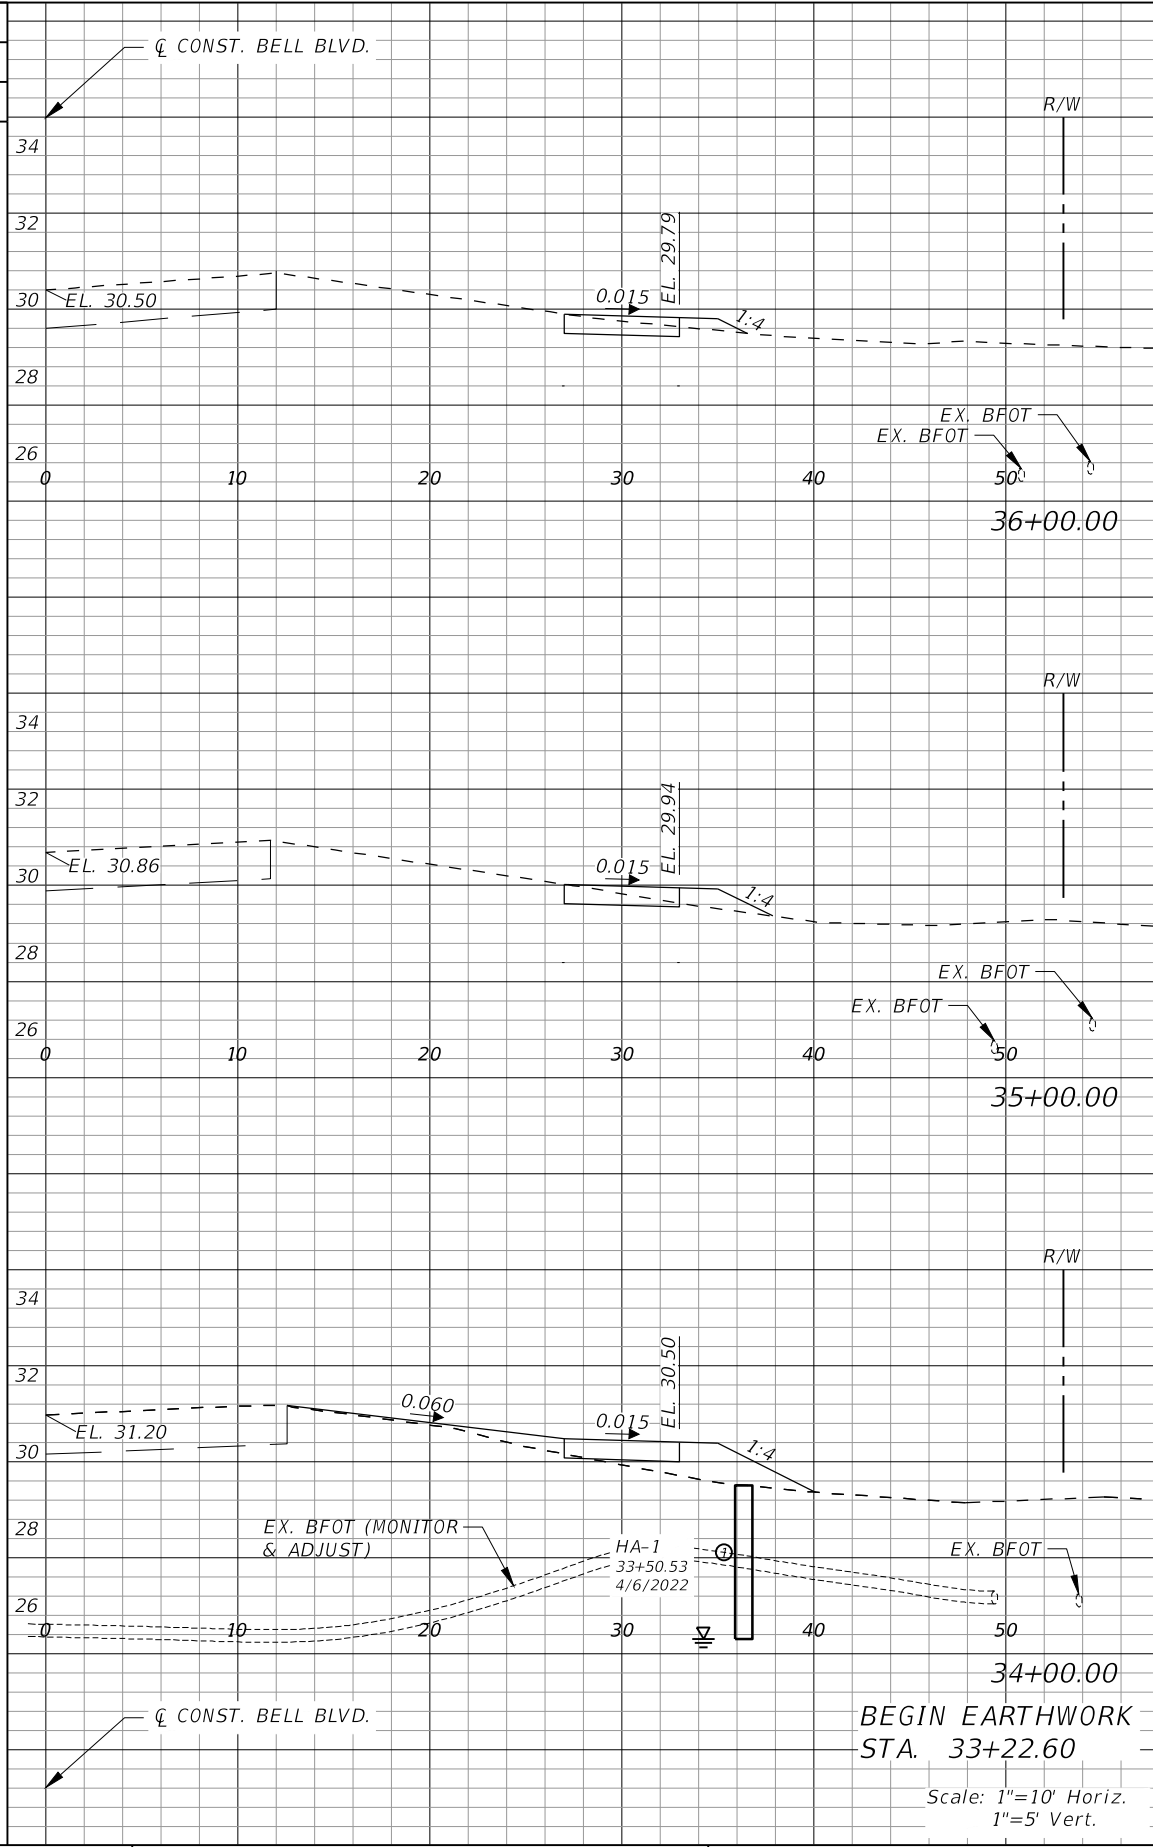

Regular		Exc.	Embankment	
AREA	VOL.		AREA	VOL.
SF	CY		SF	CY
2			1	
2			2	
5			5	
1			7	
0			0	

REVISIONS			
DATE	DESCRIPTION	DATE	DESCRIPTION




**GradyMinor**  
Civil Engineers • Land Surveyors • Planners • Landscape Architects  
Cert. of Auth. EB 0005151 Cert. of Auth. LB 0005151 Business Lic. 26000266

Q. Grady Minor and Associates, P.A.  
3800 Via Del Rey  
Bonita Springs, Florida 34134  
Phone: 239.947.1144  
R. DANIEL FLYNN, P.E. NO. 76205


LEE COUNTY	
ROAD NO.	COUNTY PROJECT NO.
BELL BLVD. SR 82 TO SUNRISE BLVD. SIDEWALK	6002

**CROSS SECTIONS  
BELL BOULEVARD (RT.)**

SHEET NO.  
**81**

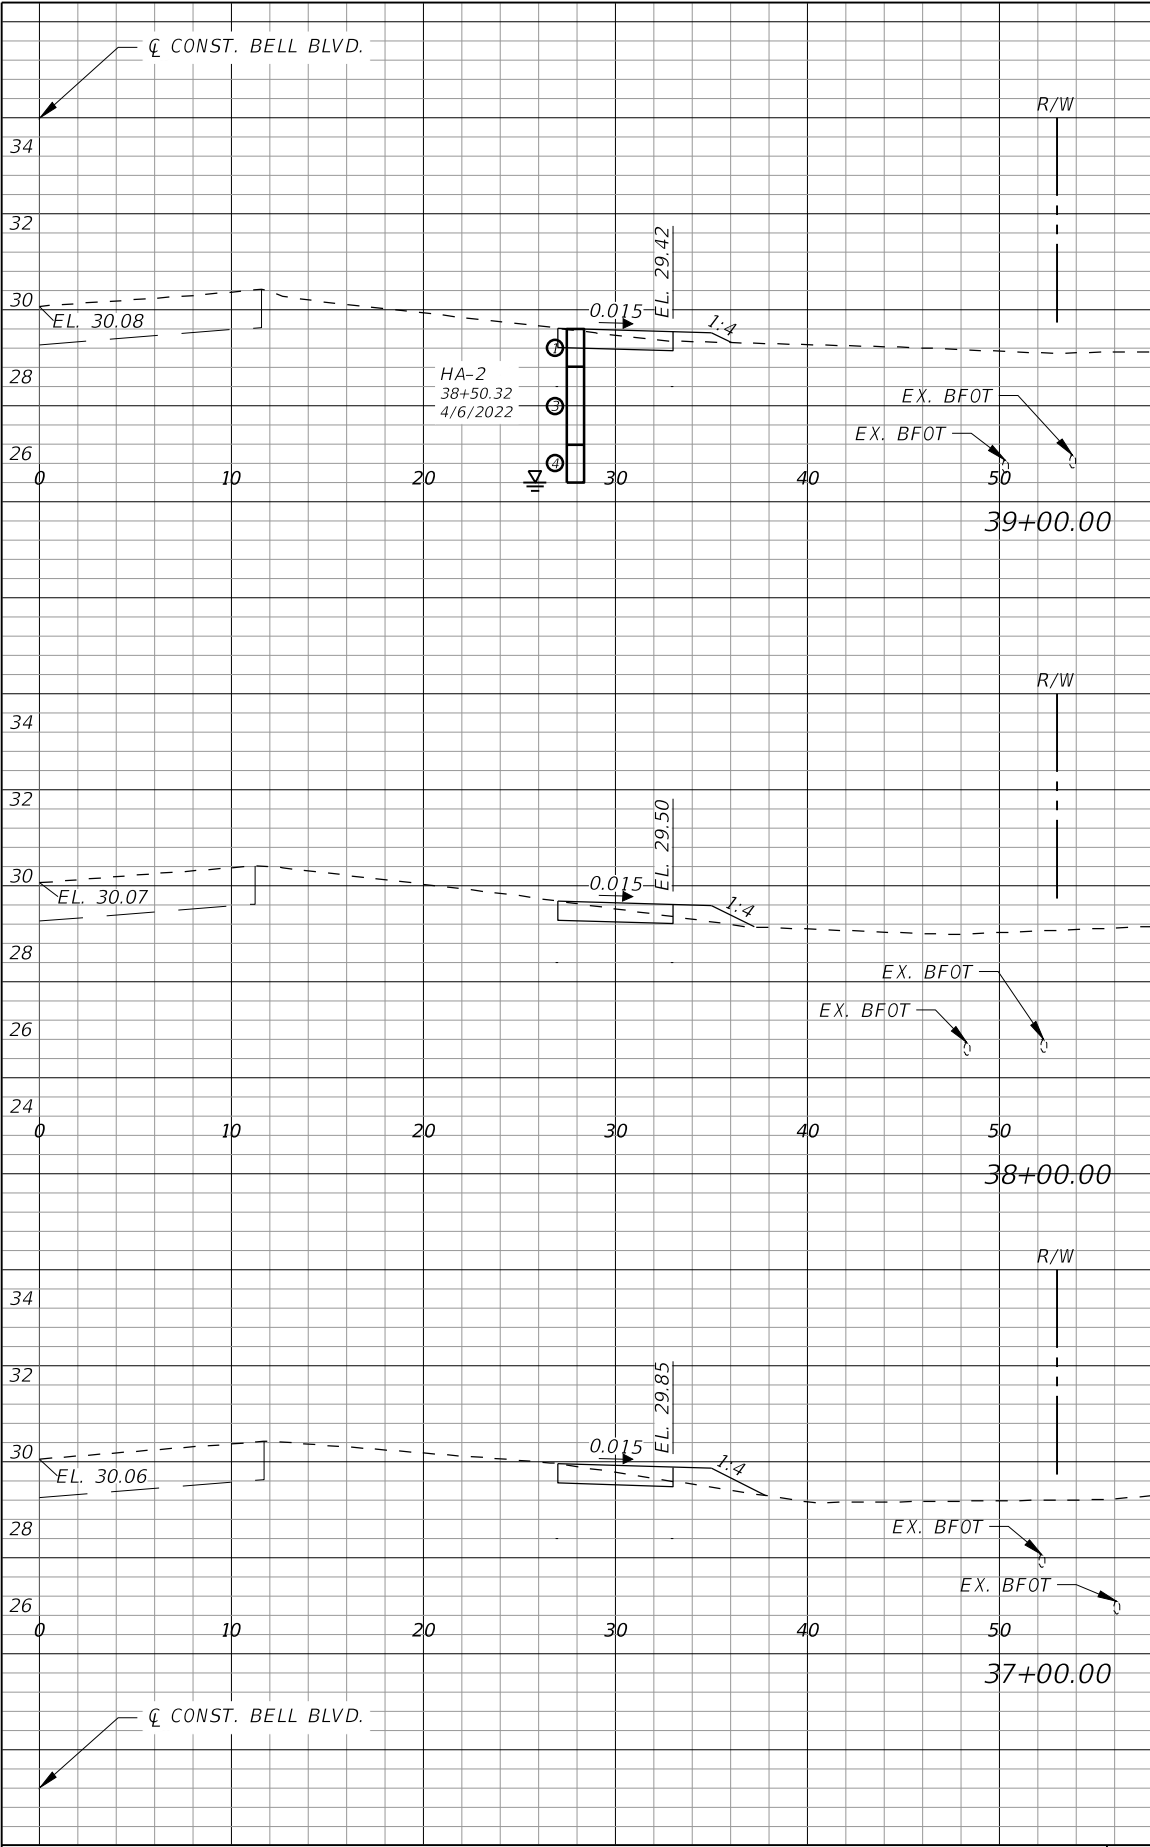


Regular		Exc.	Embankment	
AREA	VOL.		AREA	VOL.
SF	CY		SF	CY
2	8		1	4
2	8		3	
2			1	
7			5	
2			2	

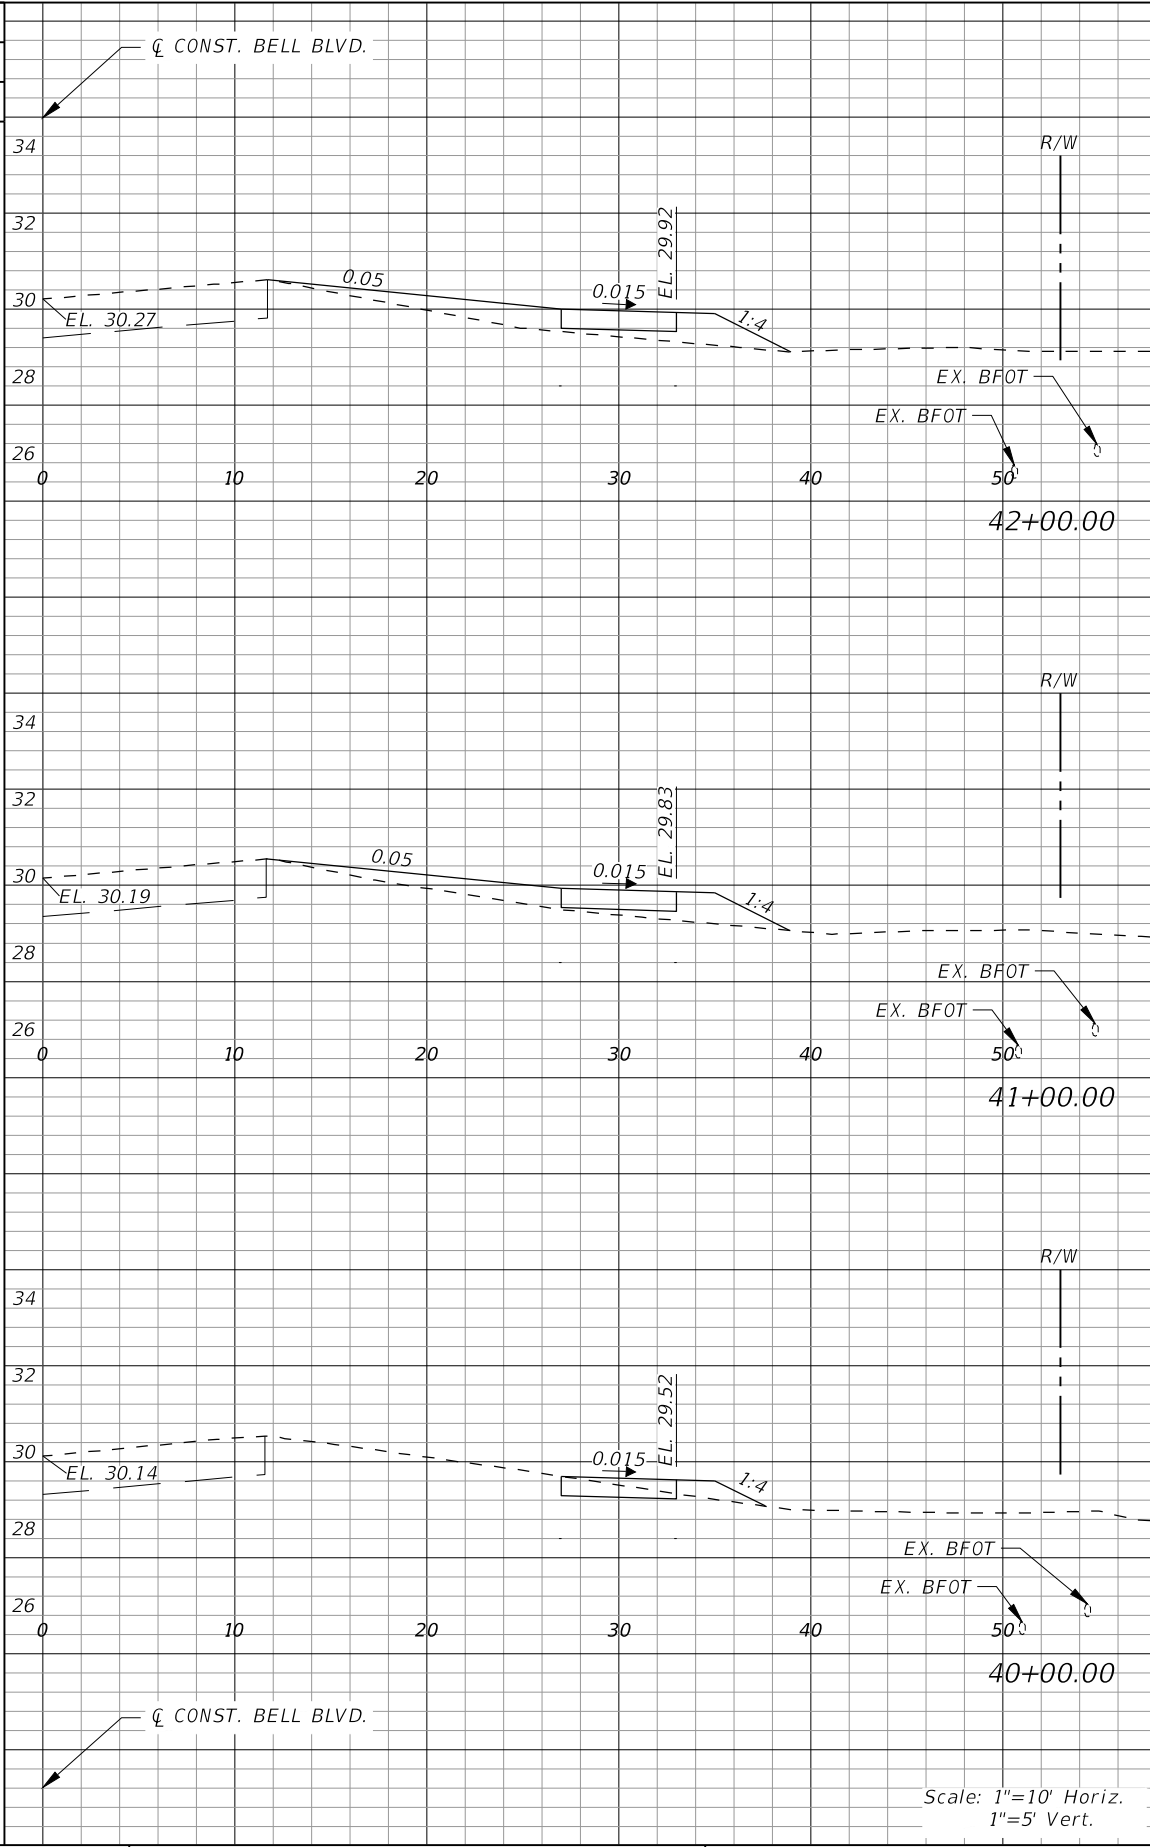

Regular		Exc.	Embankment	
AREA	VOL.		AREA	VOL.
SF	CY		SF	CY
0	0		9	36
0			9	
0			9	
4			19	
2			1	

REVISIONS			
DATE	DESCRIPTION	DATE	DESCRIPTION




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Phone: 239.947.1144  
R. DANIEL FLYNN, P.E. NO. 76205


LEE COUNTY	
ROAD NO.	COUNTY PROJECT NO.
BELL BLVD. SR 82 TO SUNRISE BLVD. SIDEWALK	6002

**CROSS SECTIONS  
BELL BOULEVARD (RT.)**

SHEET NO.  
**82**

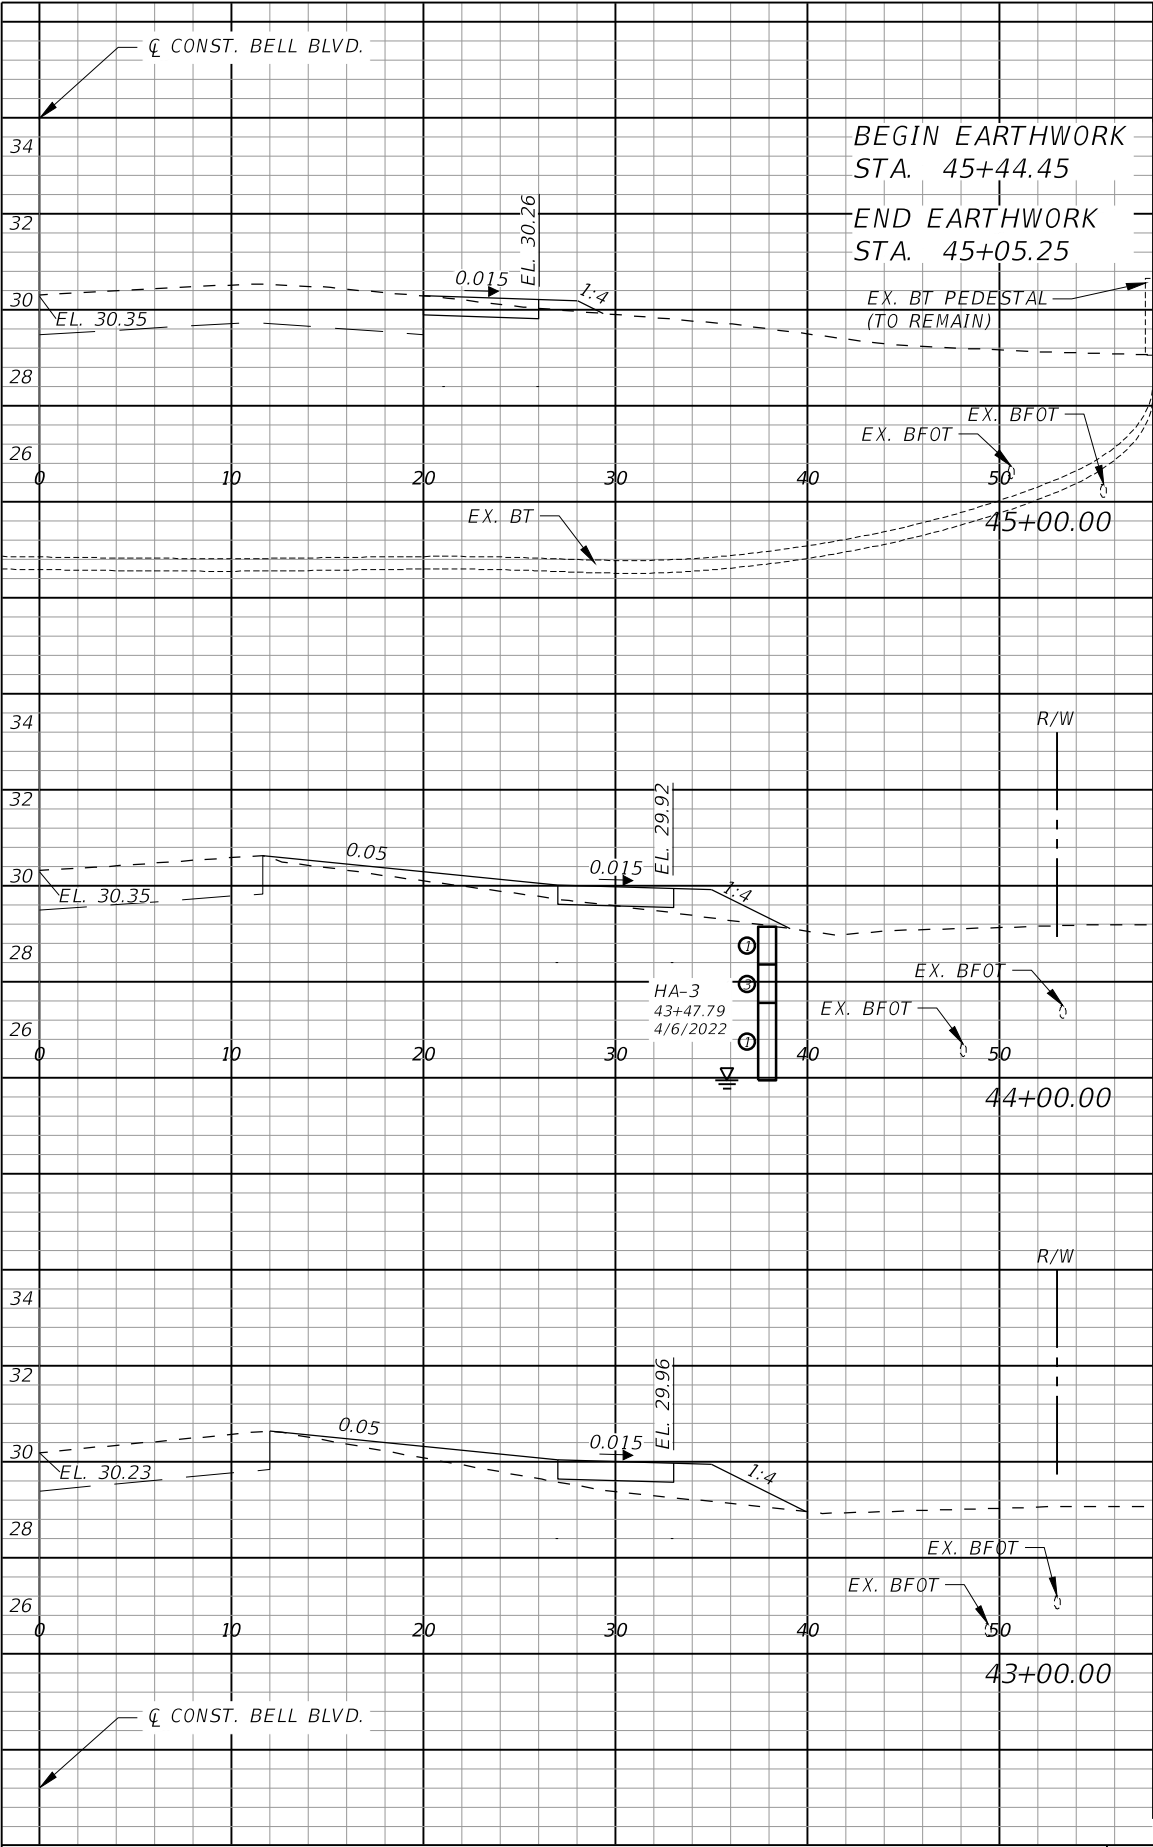


Regular		Exc.	Embankment	
AREA	VOL.		AREA	VOL.
SF	CY		SF	CY
0			0	
0			0	
0			0	
2			1	
6			14	
1			7	
2			31	
0			10	

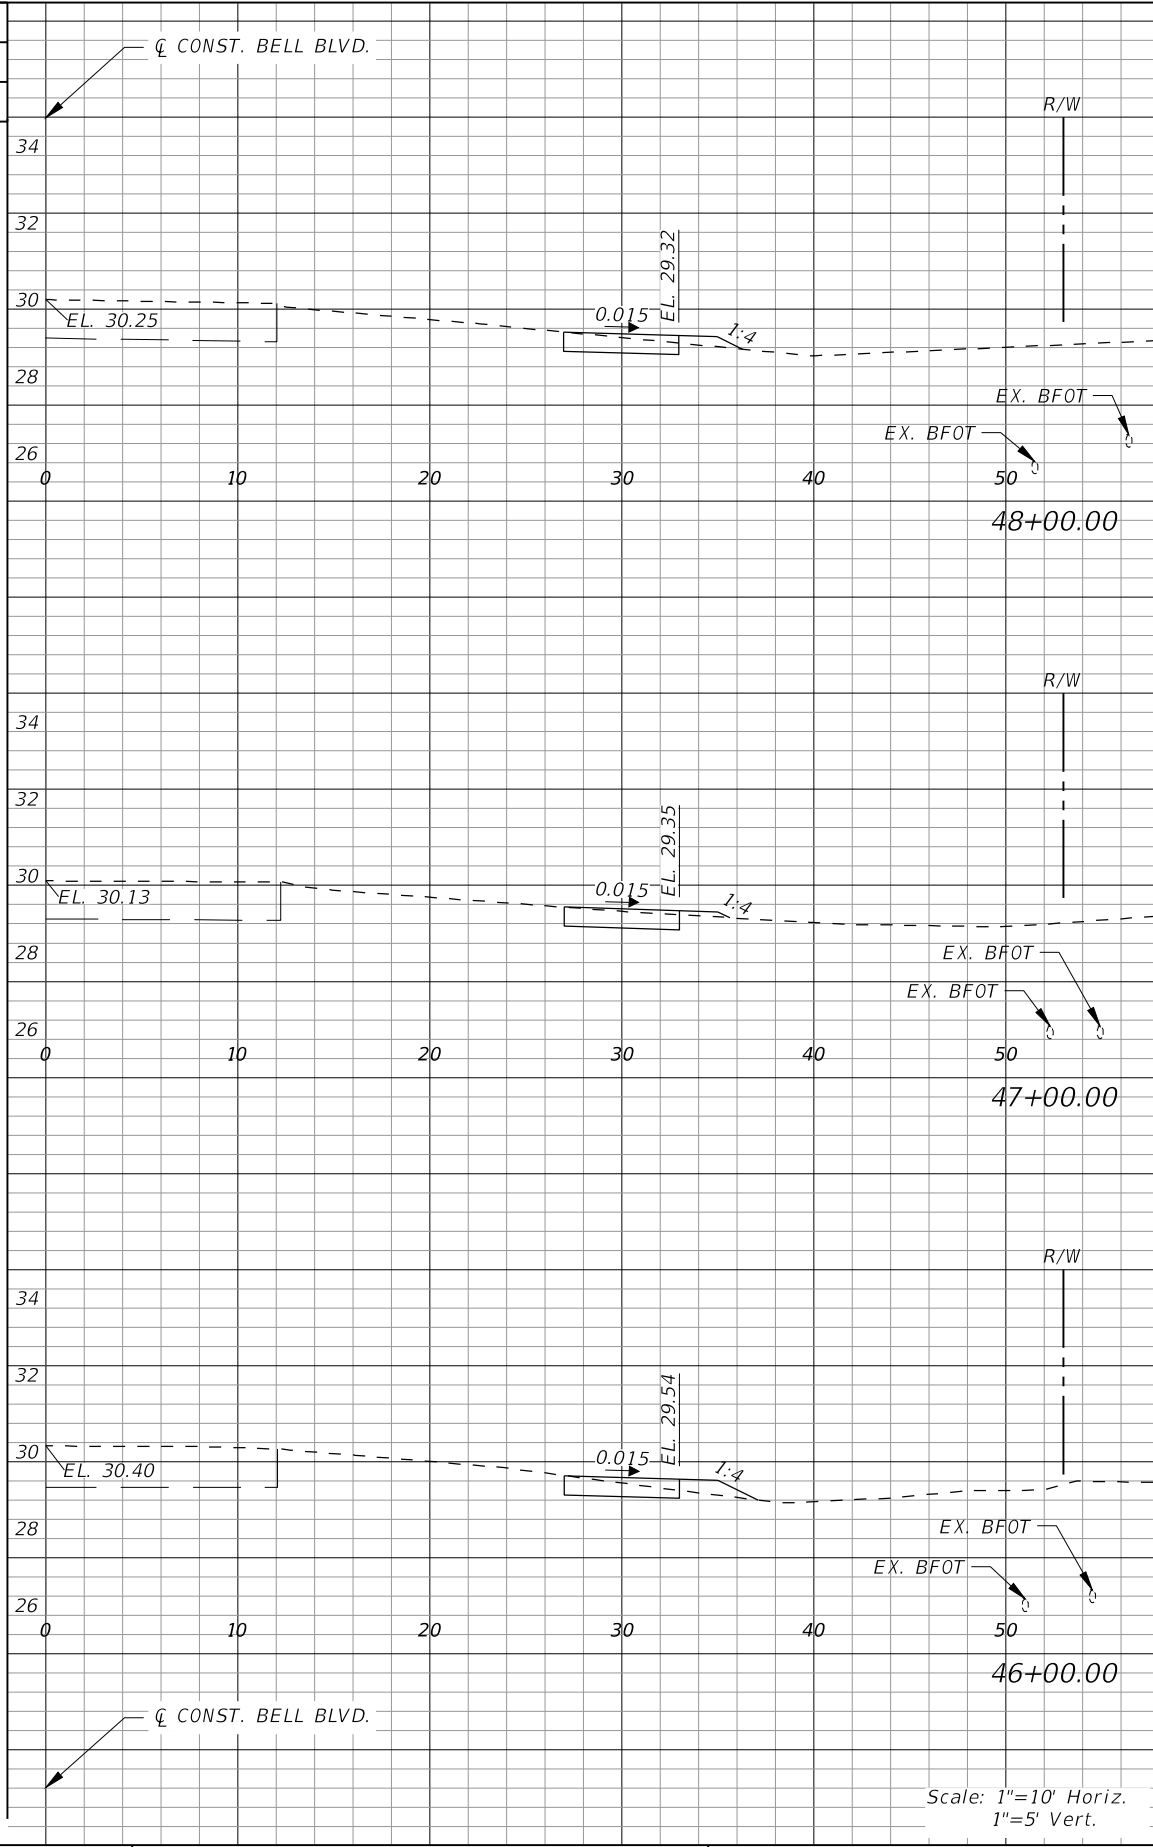

Regular		Exc.	Embankment	
AREA	VOL.		AREA	VOL.
SF	CY		SF	CY
	9		2	
2			1	
9			3	
3			1	
9			4	
2			1	
2			1	

REVISIONS			
DATE	DESCRIPTION	DATE	DESCRIPTION




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Bonita Springs, Florida 34134  
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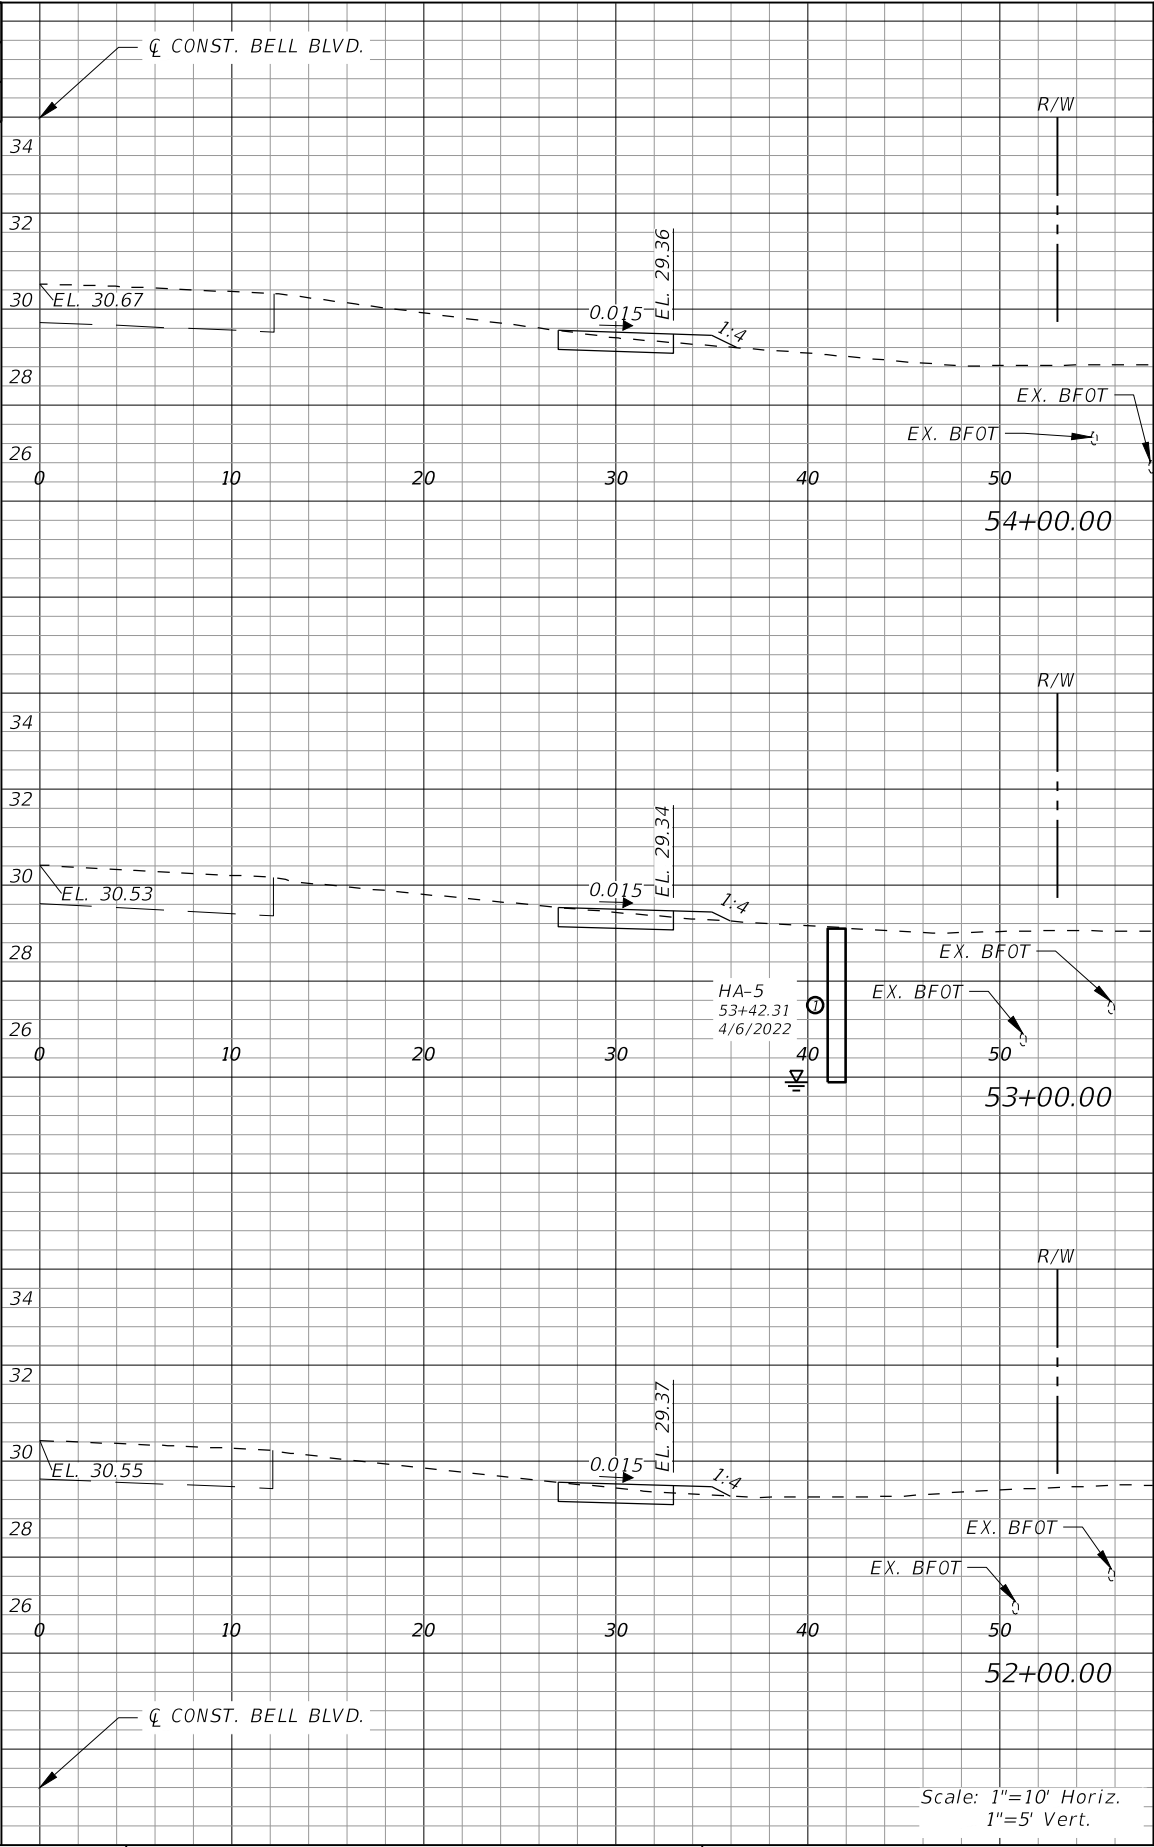
LEE COUNTY	
ROAD NO.	COUNTY PROJECT NO.
BELL BLVD. SR 82 TO SUNRISE BLVD. SIDEWALK	6002

**CROSS SECTIONS  
BELL BOULEVARD (RT.)**

SHEET NO.  
**83**




Regular		Exc.	Embankment	
AREA	VOL.		AREA	VOL.
SF	CY		SF	CY
1	6		1	3
2	9		1	3
2	9		2	3

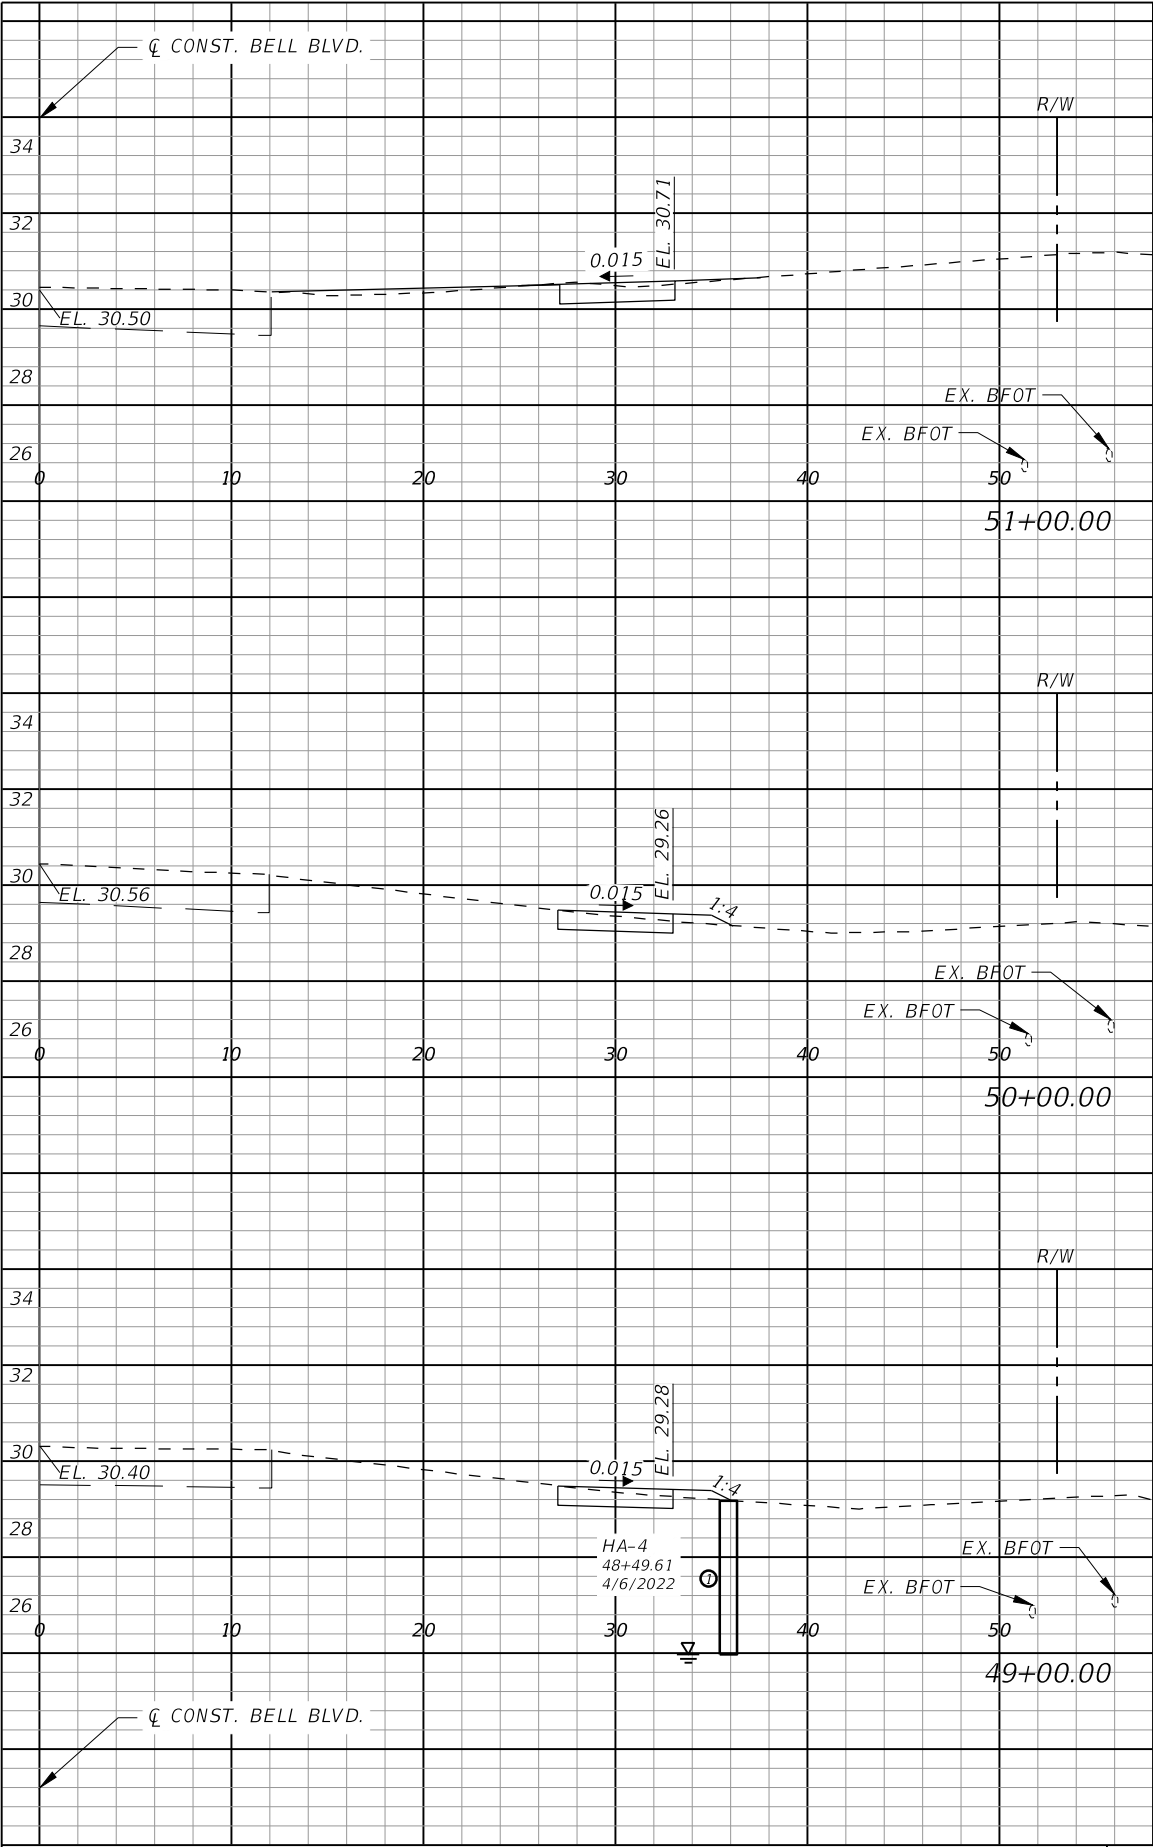

Regular		Exc.	Embankment	
AREA	VOL.		AREA	VOL.
SF	CY		SF	CY
2	9		1	3
2	9		1	3
2	9		1	3

REVISIONS			
DATE	DESCRIPTION	DATE	DESCRIPTION



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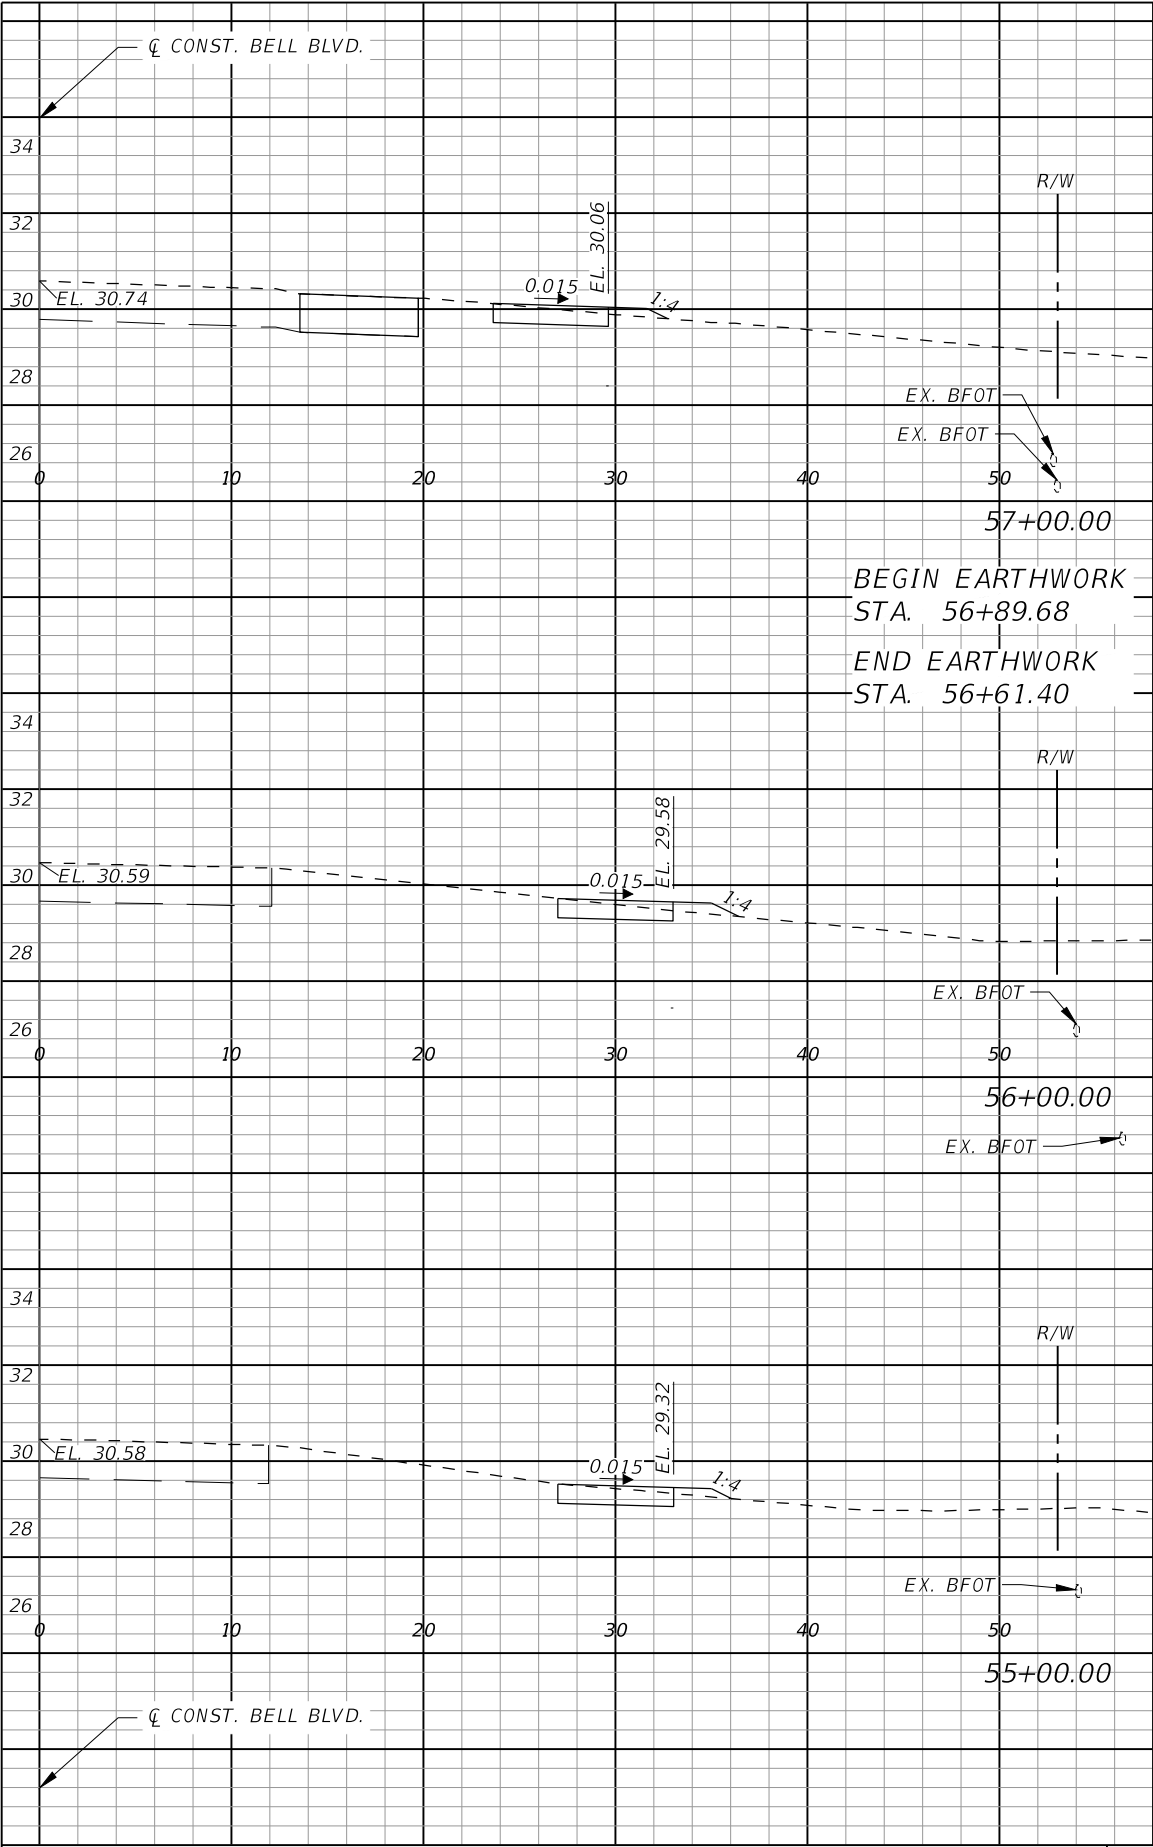
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ROAD NO.	COUNTY PROJECT NO.
BELL BLVD. SR 82 TO SUNRISE BLVD. SIDEWALK	6002


**CROSS SECTIONS**  
**BELL BOULEVARD (RT.)**

SHEET  
NO.  
**84**






Regular		Exc.	Embankment	
AREA	VOL.		AREA	VOL.
SF	CY		SF	CY
	10		3	
2	0	1	0	
0		0		
0		0		
3		1		
2	1			
9		3		
3	1			

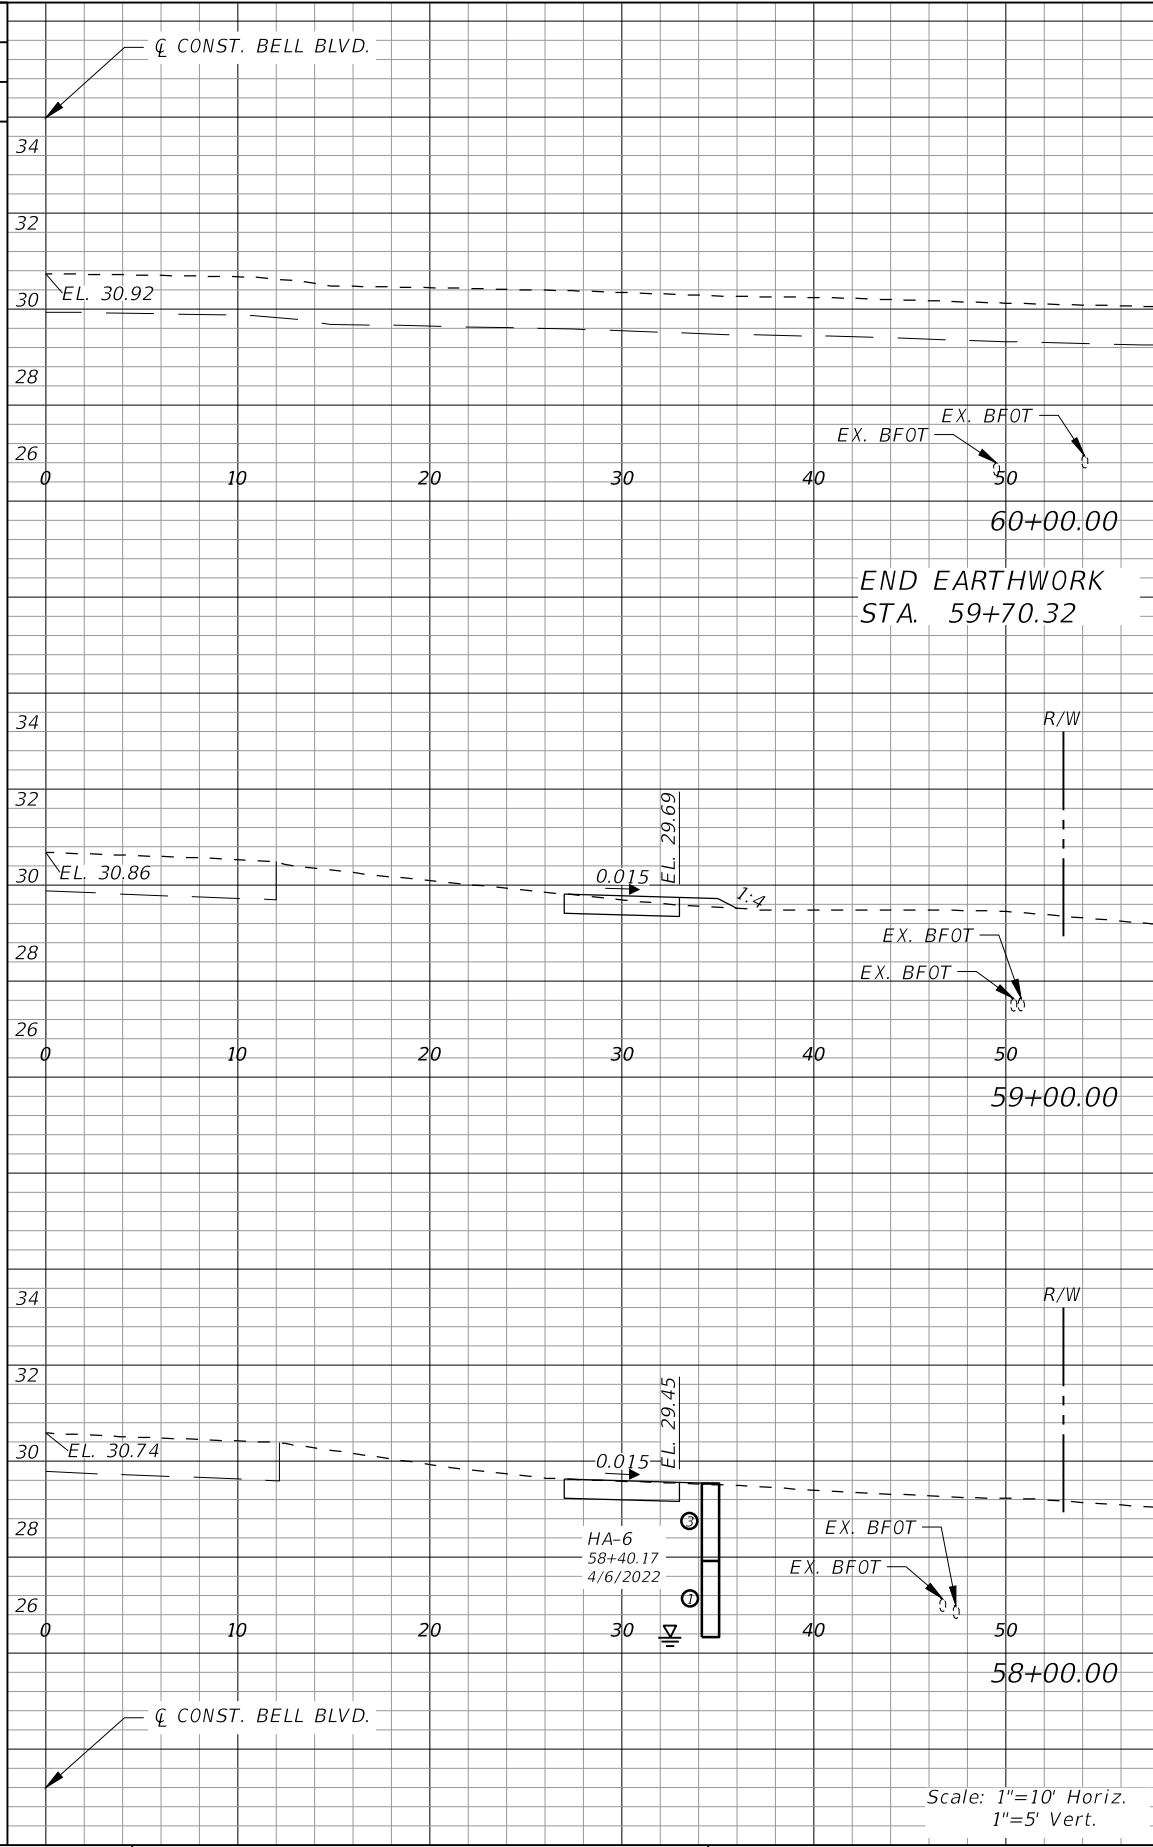

Regular		Exc.	Embankment	
AREA	VOL.		AREA	VOL.
SF	CY		SF	CY
0		0		
2		1		
3		1		
10		3		
3	1			

REVISIONS			
DATE	DESCRIPTION	DATE	DESCRIPTION




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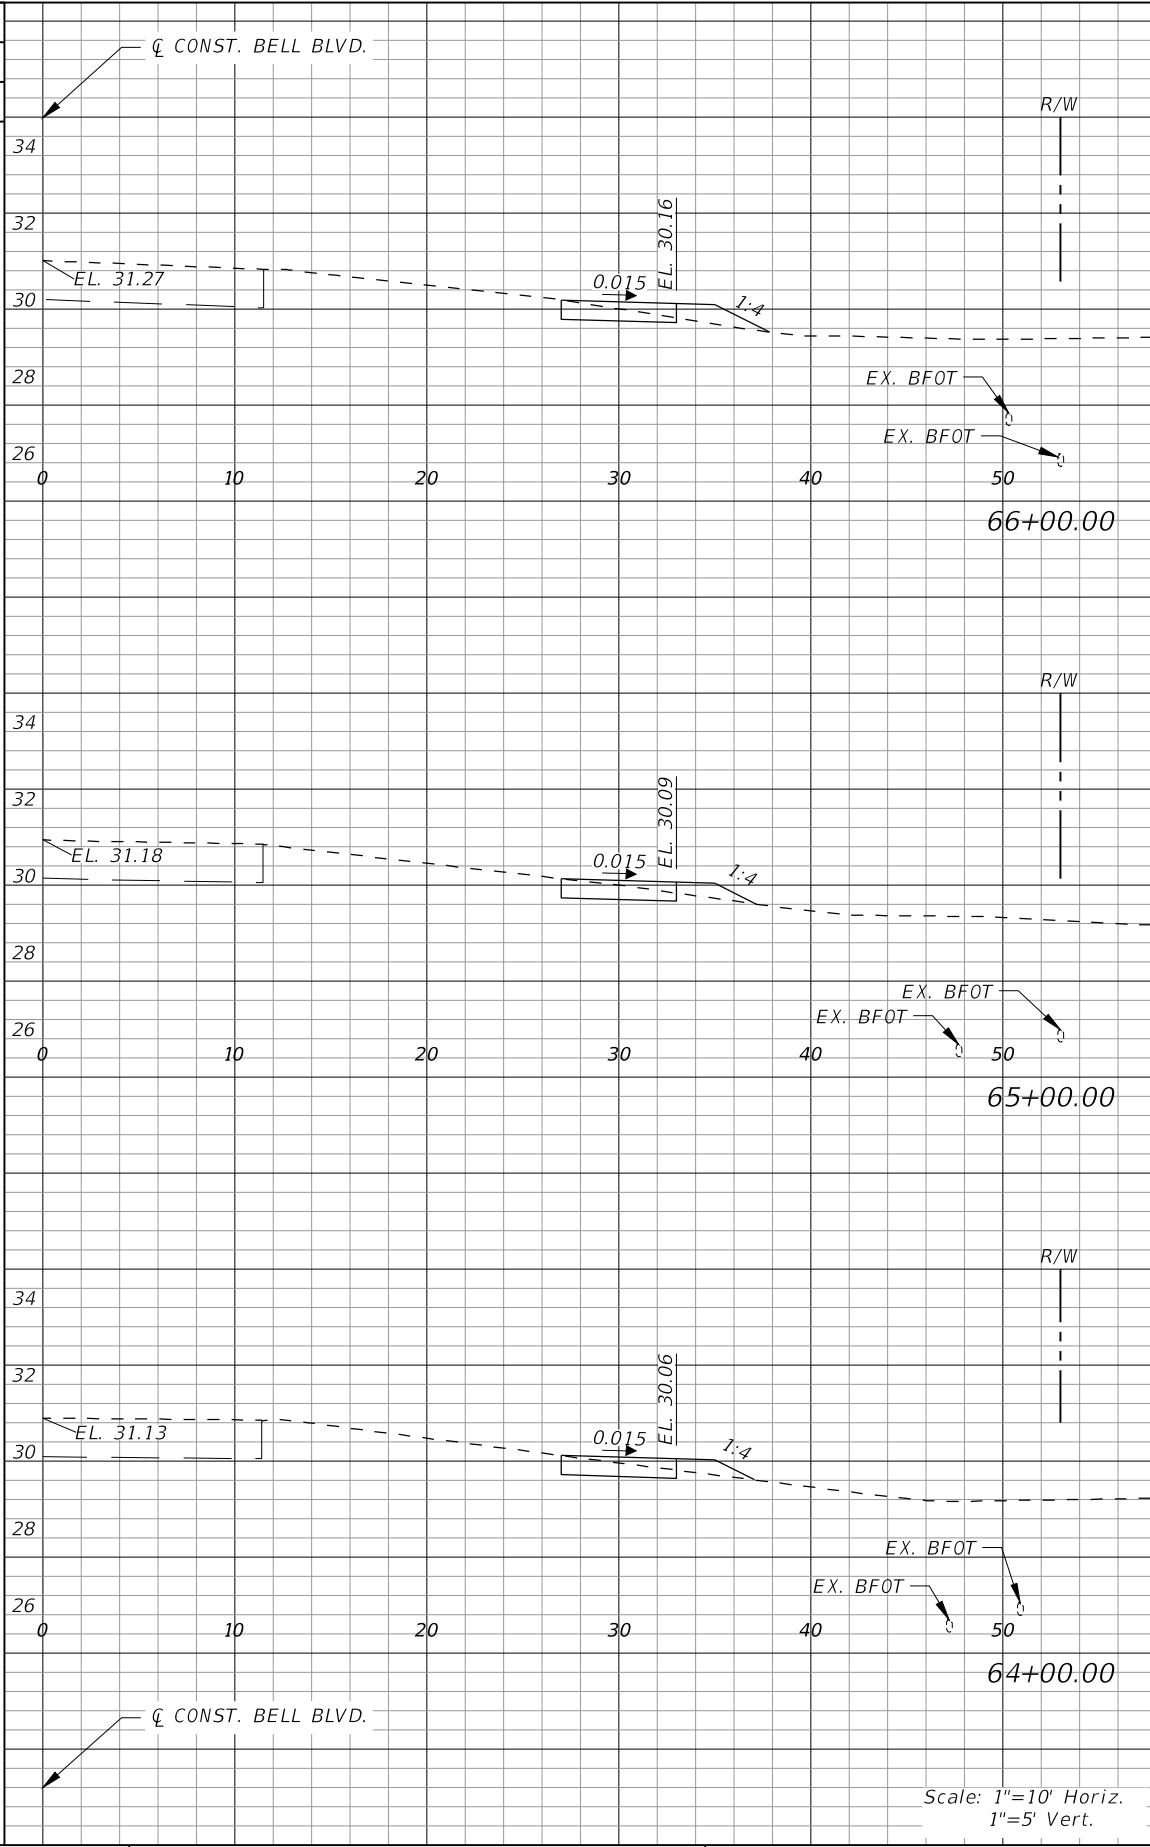
LEE COUNTY	
ROAD NO.	COUNTY PROJECT NO.
BELL BLVD. SR 82 TO SUNRISE BLVD. SIDEWALK	6002

**CROSS SECTIONS**  
**BELL BLVD.**

SHEET NO.  
**85**




Regular		Exc.	Embankment	
AREA	VOL.		AREA	VOL.
SF	CY		SF	CY
2	8		1	4
7			5	
2			2	
7			5	
2			1	
3			2	
0			0	

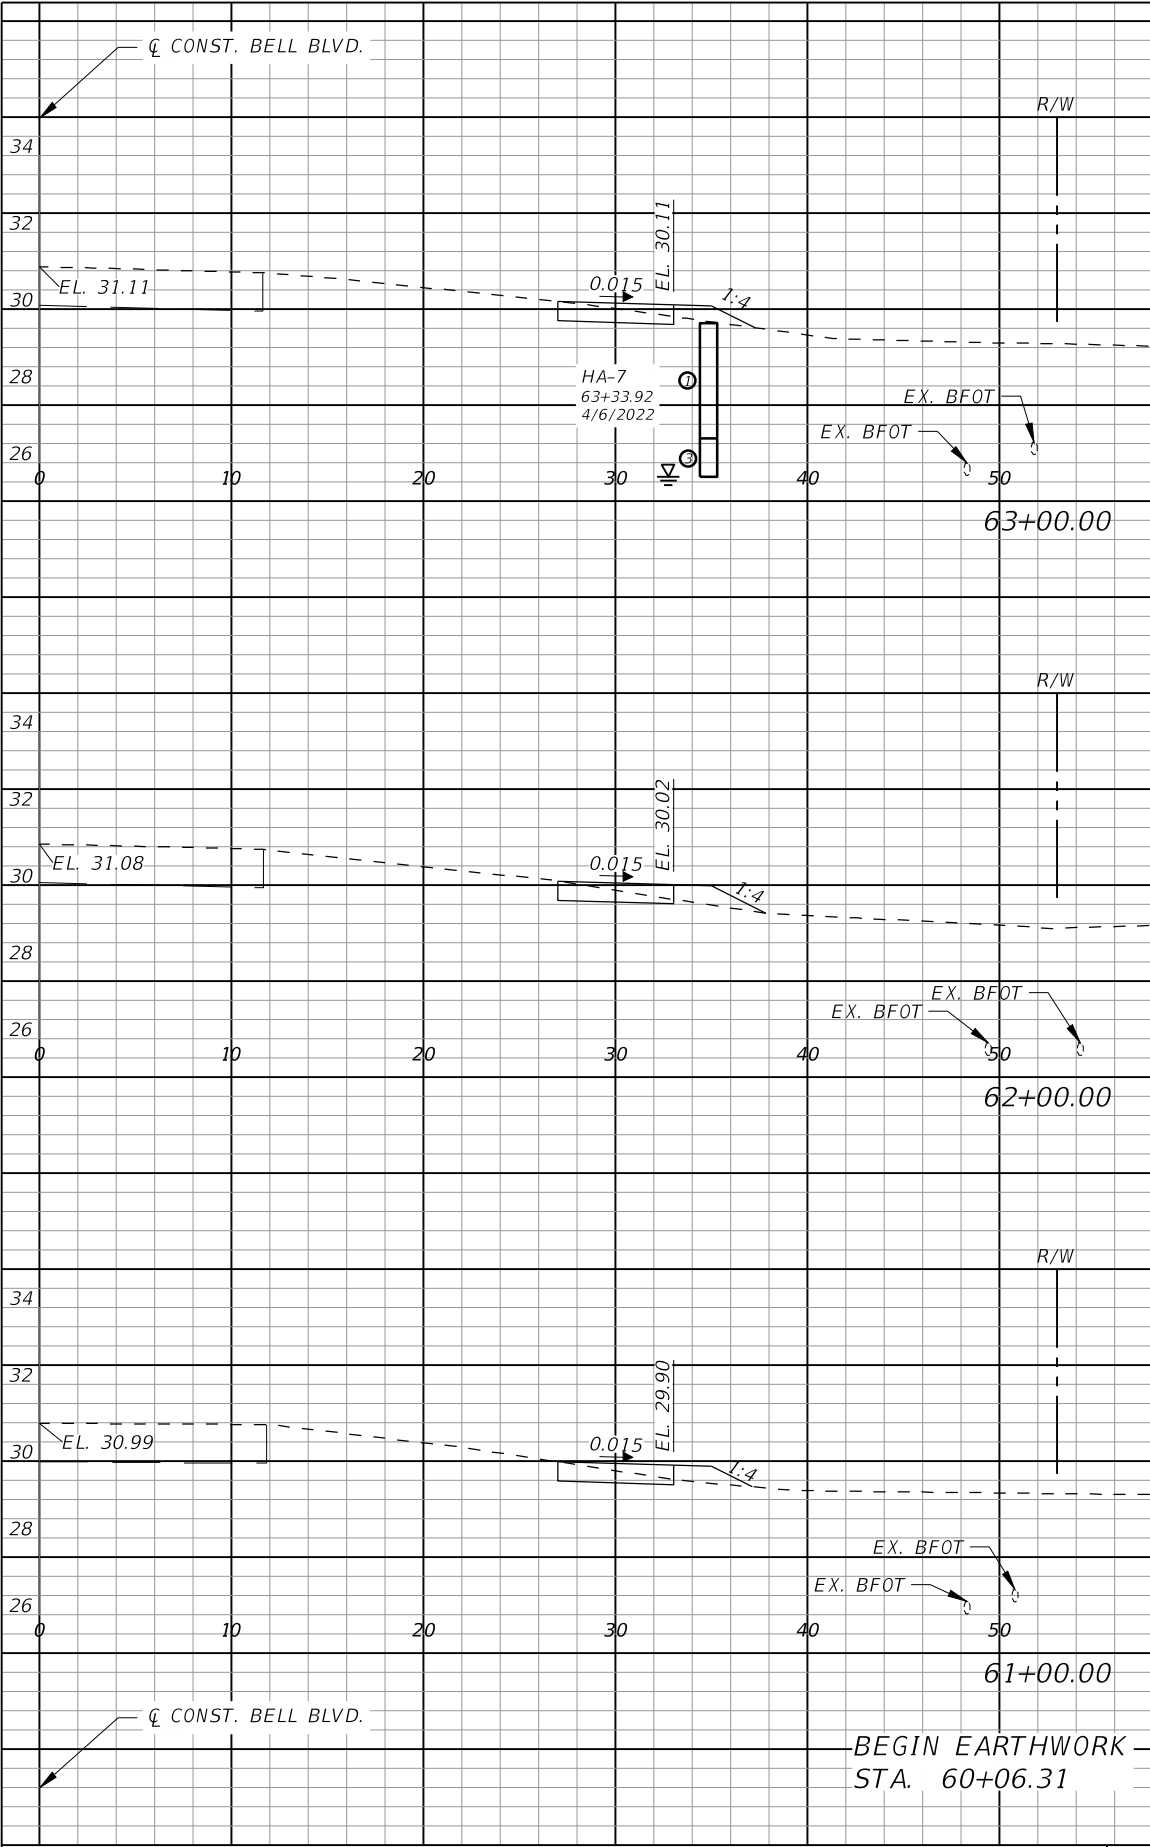

Regular		Exc.	Embankment	
AREA	VOL.		AREA	VOL.
SF	CY		SF	CY
2	7		2	6
7			5	
2			1	
8			4	
2			1	

REVISIONS			
DATE	DESCRIPTION	DATE	DESCRIPTION




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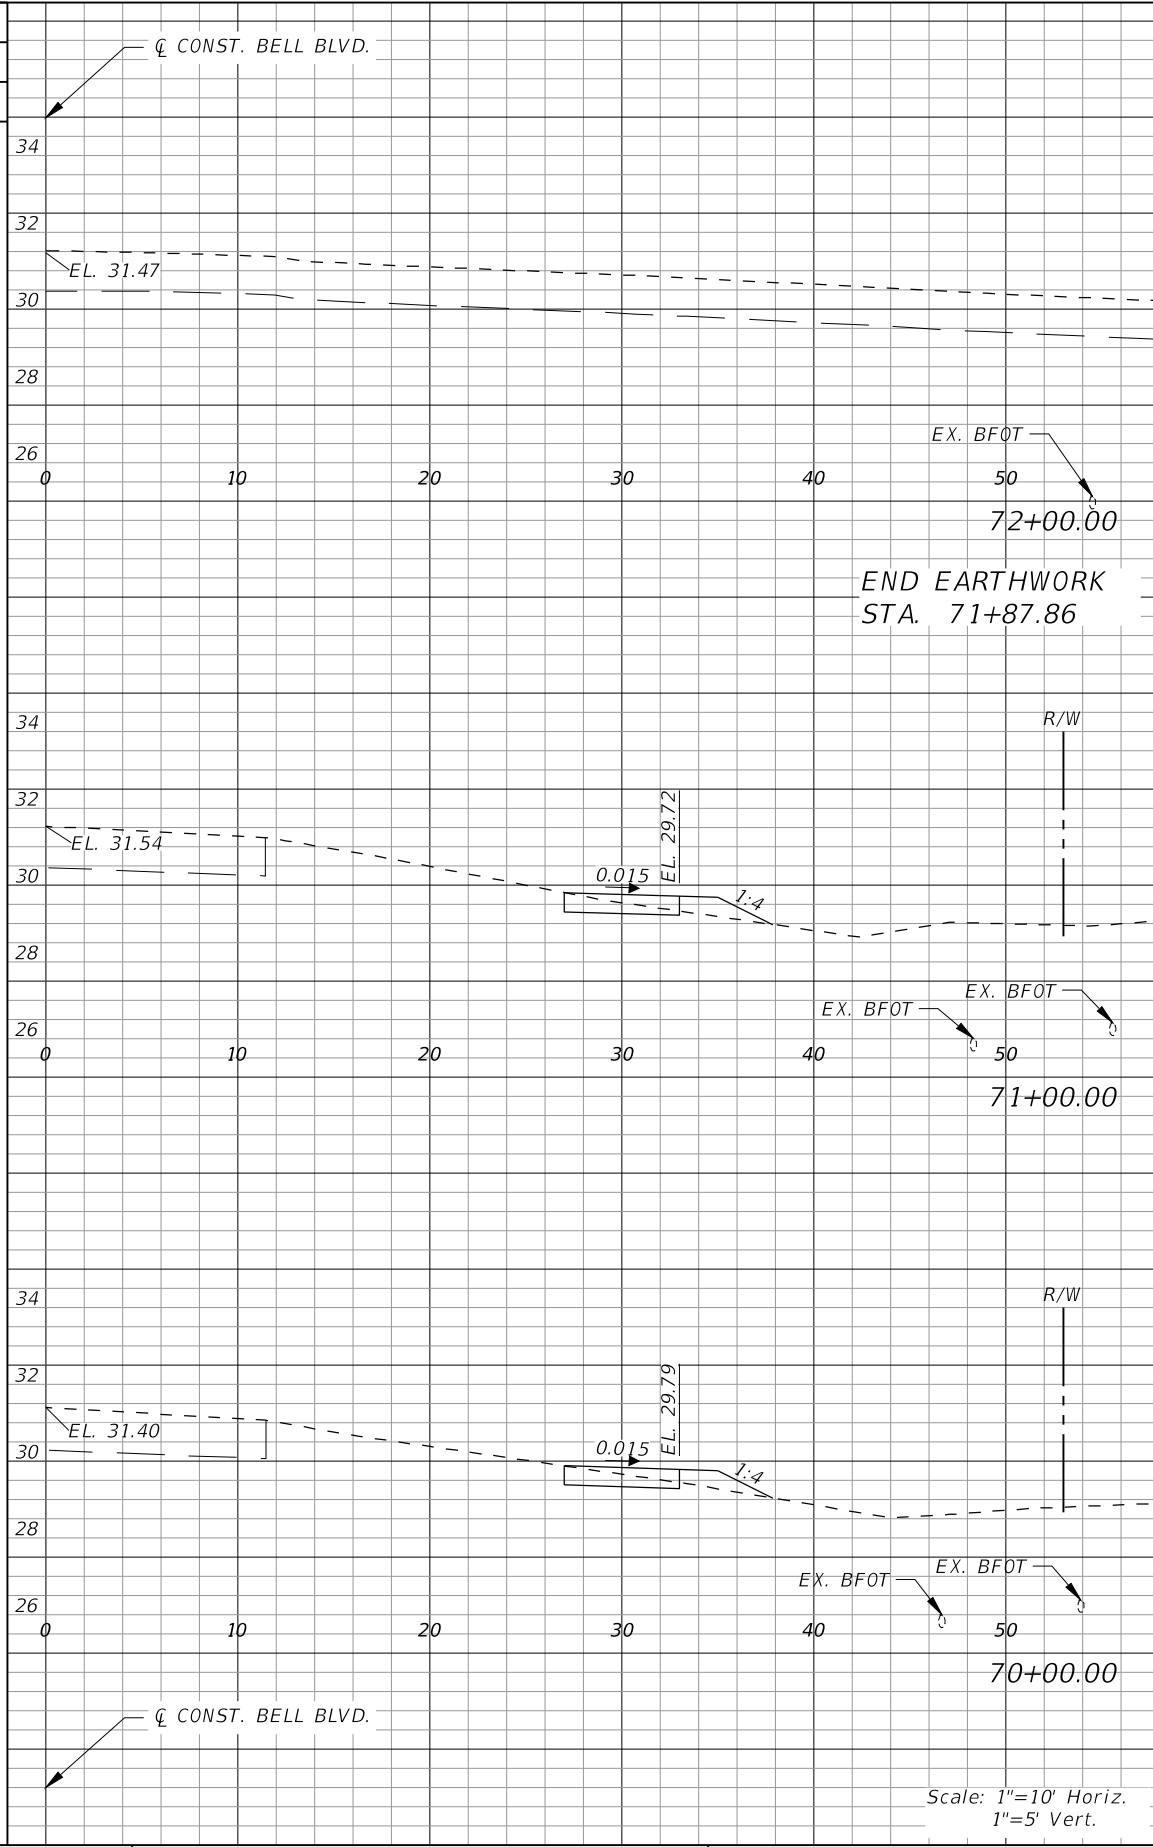
LEE COUNTY	
ROAD NO.	COUNTY PROJECT NO.
BELL BLVD. SR 82 TO SUNRISE BLVD. SIDEWALK	6002

**CROSS SECTIONS  
BELL BOULEVARD (RT.)**

SHEET NO.  
**86**




Regular		Exc.	Embankment	
AREA	VOL.		AREA	VOL.
SF	CY		SF	CY
2	7		2	7
6			7	
2			2	
7			6	

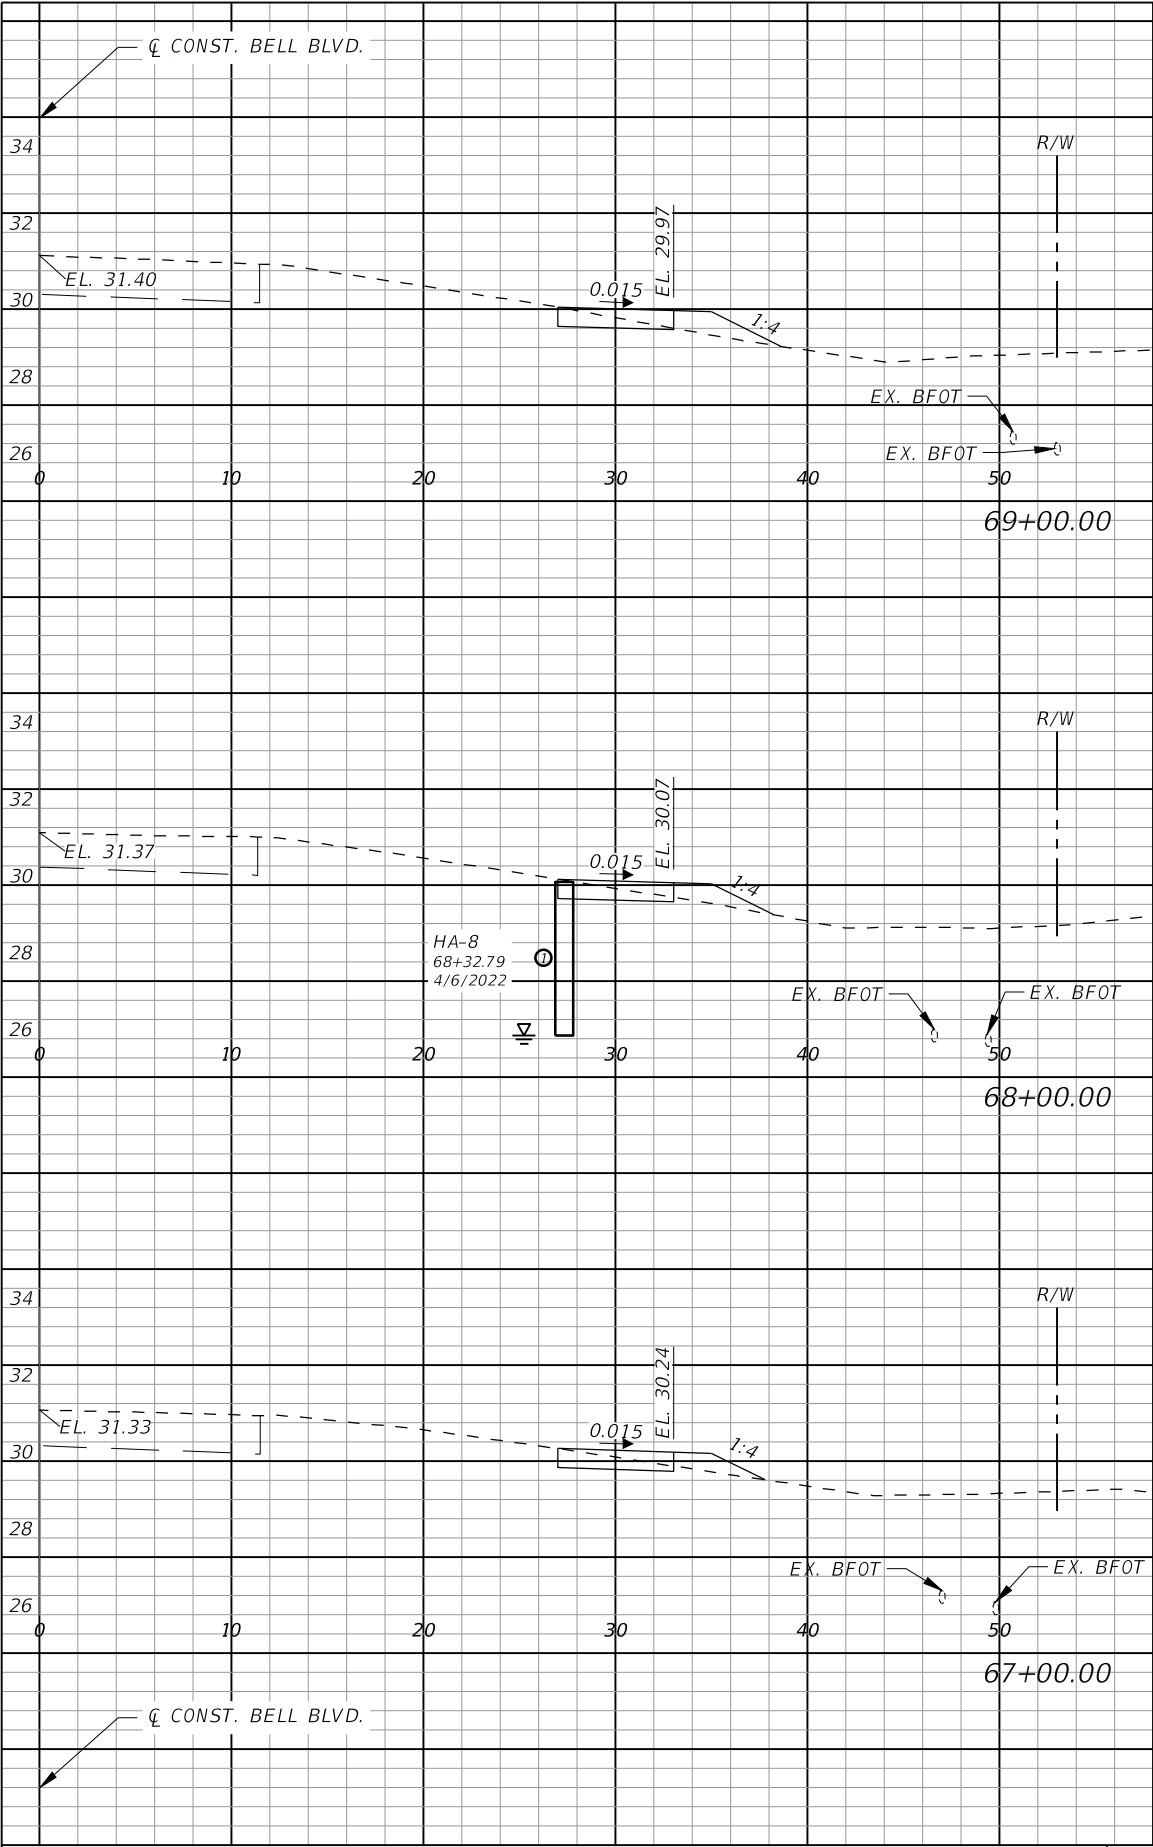

Regular		Exc.	Embankment	
AREA	VOL.		AREA	VOL.
SF	CY		SF	CY
2			2	
7			6	
0			0	
3			3	

REVISIONS			
DATE	DESCRIPTION	DATE	DESCRIPTION



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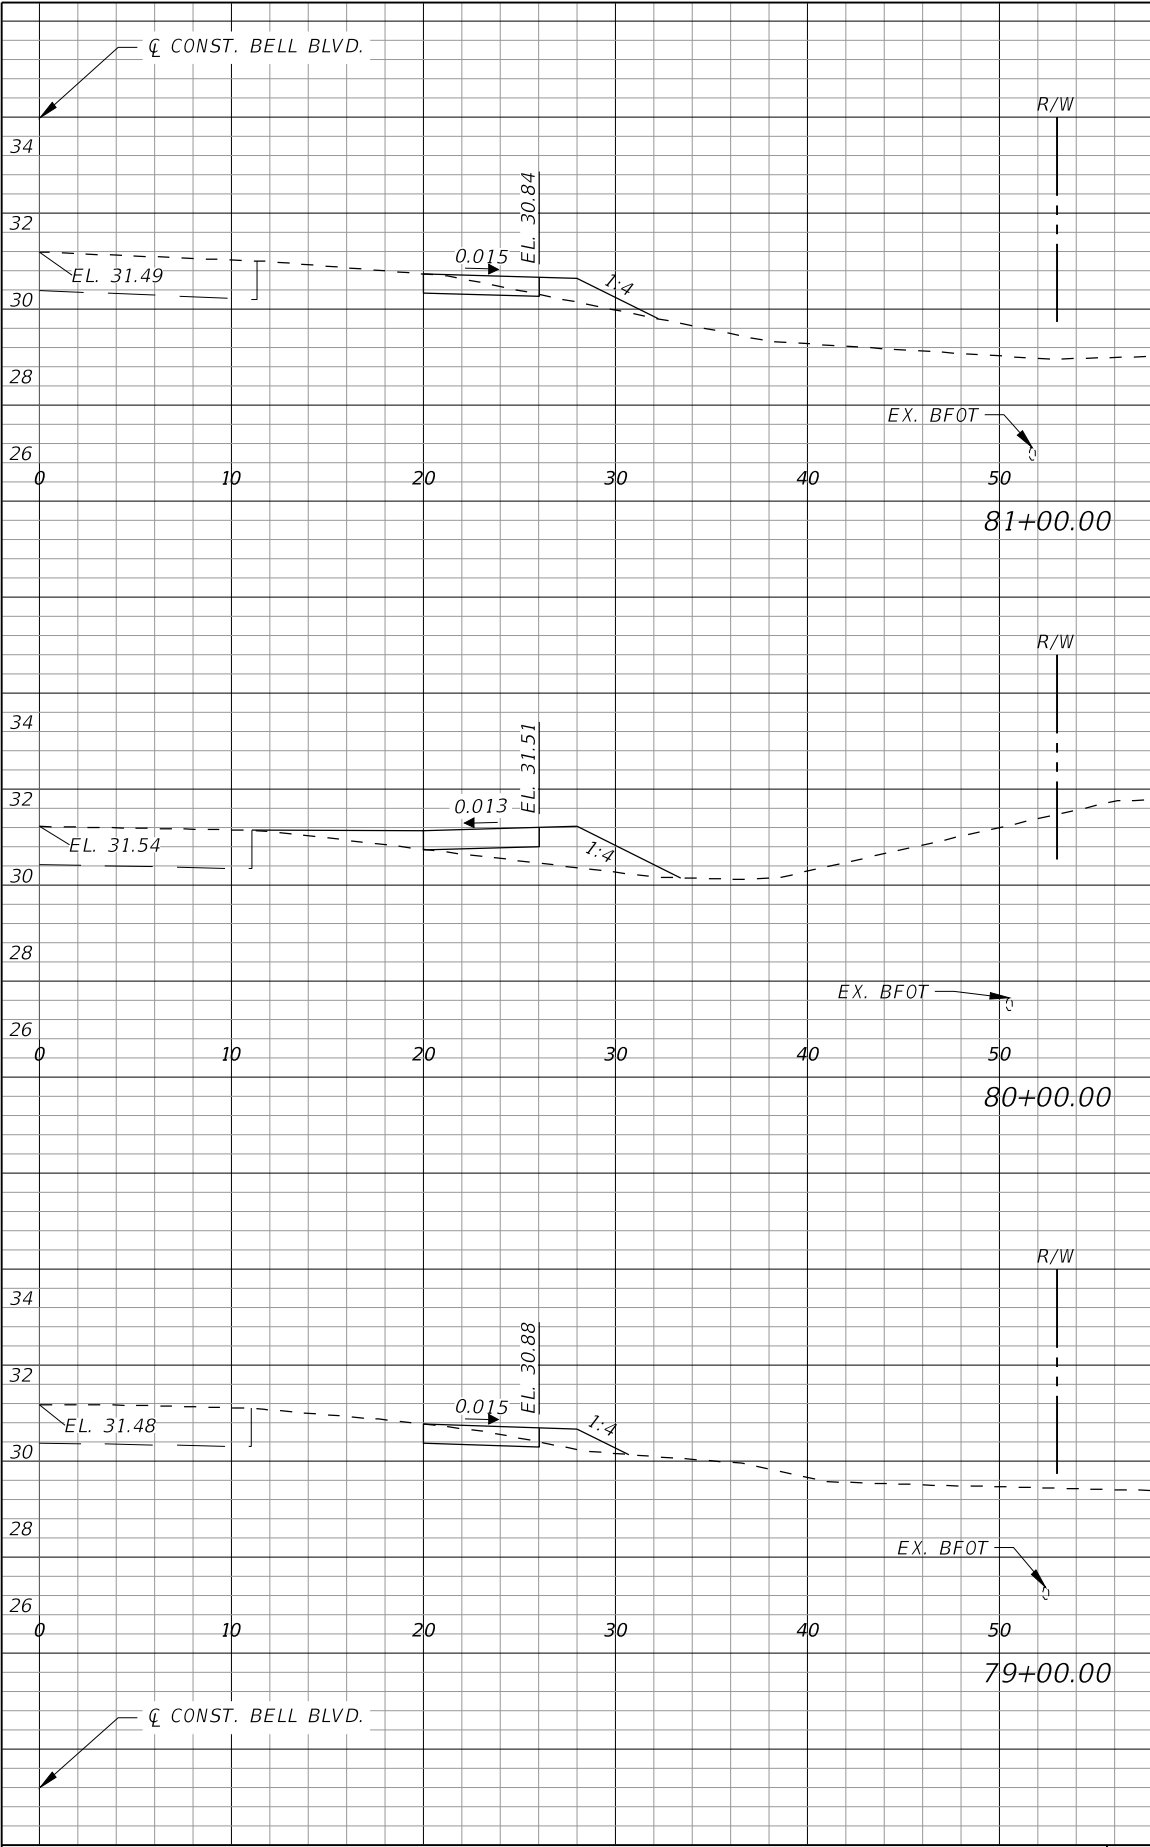
LEE COUNTY	
ROAD NO.	COUNTY PROJECT NO.
BELL BLVD. SR 82 TO SUNRISE BLVD. SIDEWALK	6002

**CROSS SECTIONS  
BELL BOULEVARD (RT.)**


SHEET NO.  
**87**








Regular		Exc.	Embankment	
AREA	VOL.		AREA	VOL.
SF	CY		SF	CY
2	8		2	7
5			20	
1			8	
6			18	
2			2	

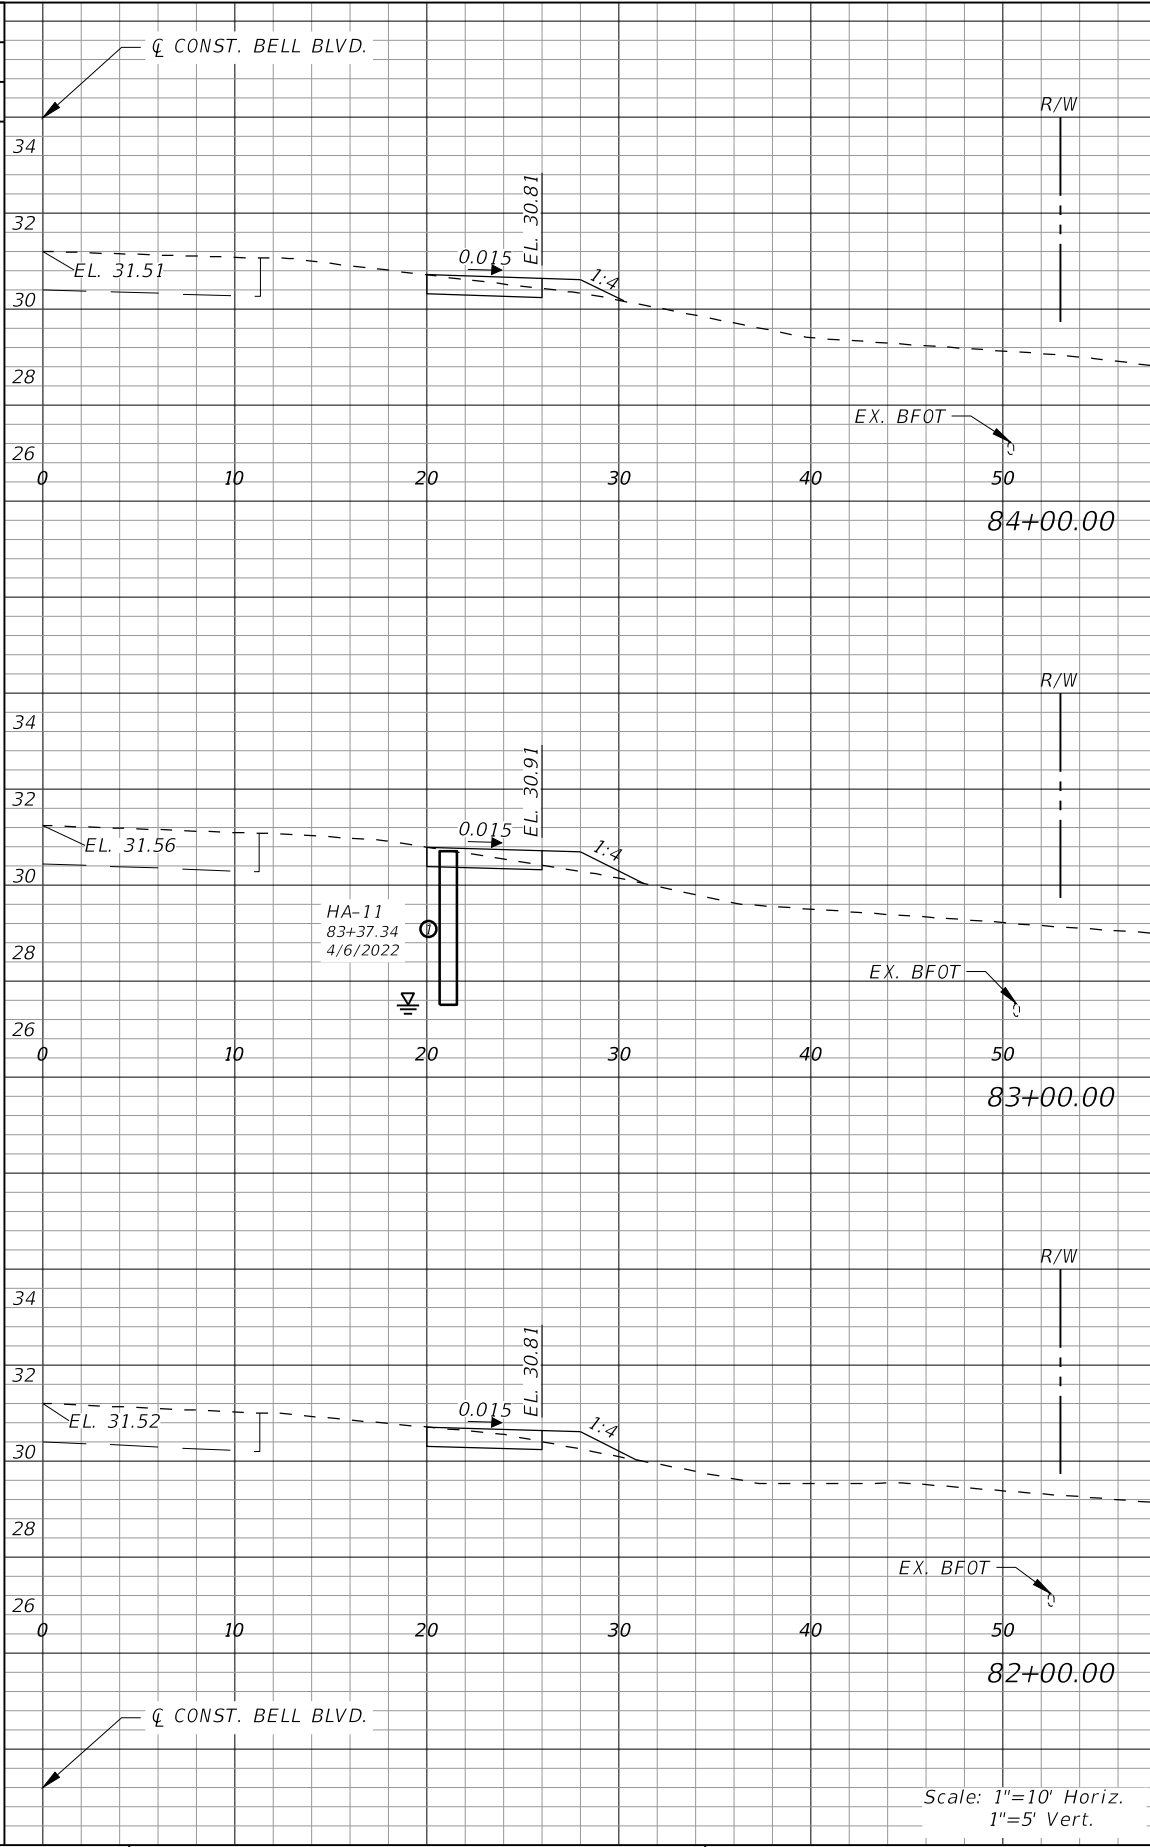

Regular		Exc.	Embankment	
AREA	VOL.		AREA	VOL.
SF	CY		SF	CY
2	9		1	4
2			8	
2			2	
2			8	
2			1	

REVISIONS			
DATE	DESCRIPTION	DATE	DESCRIPTION




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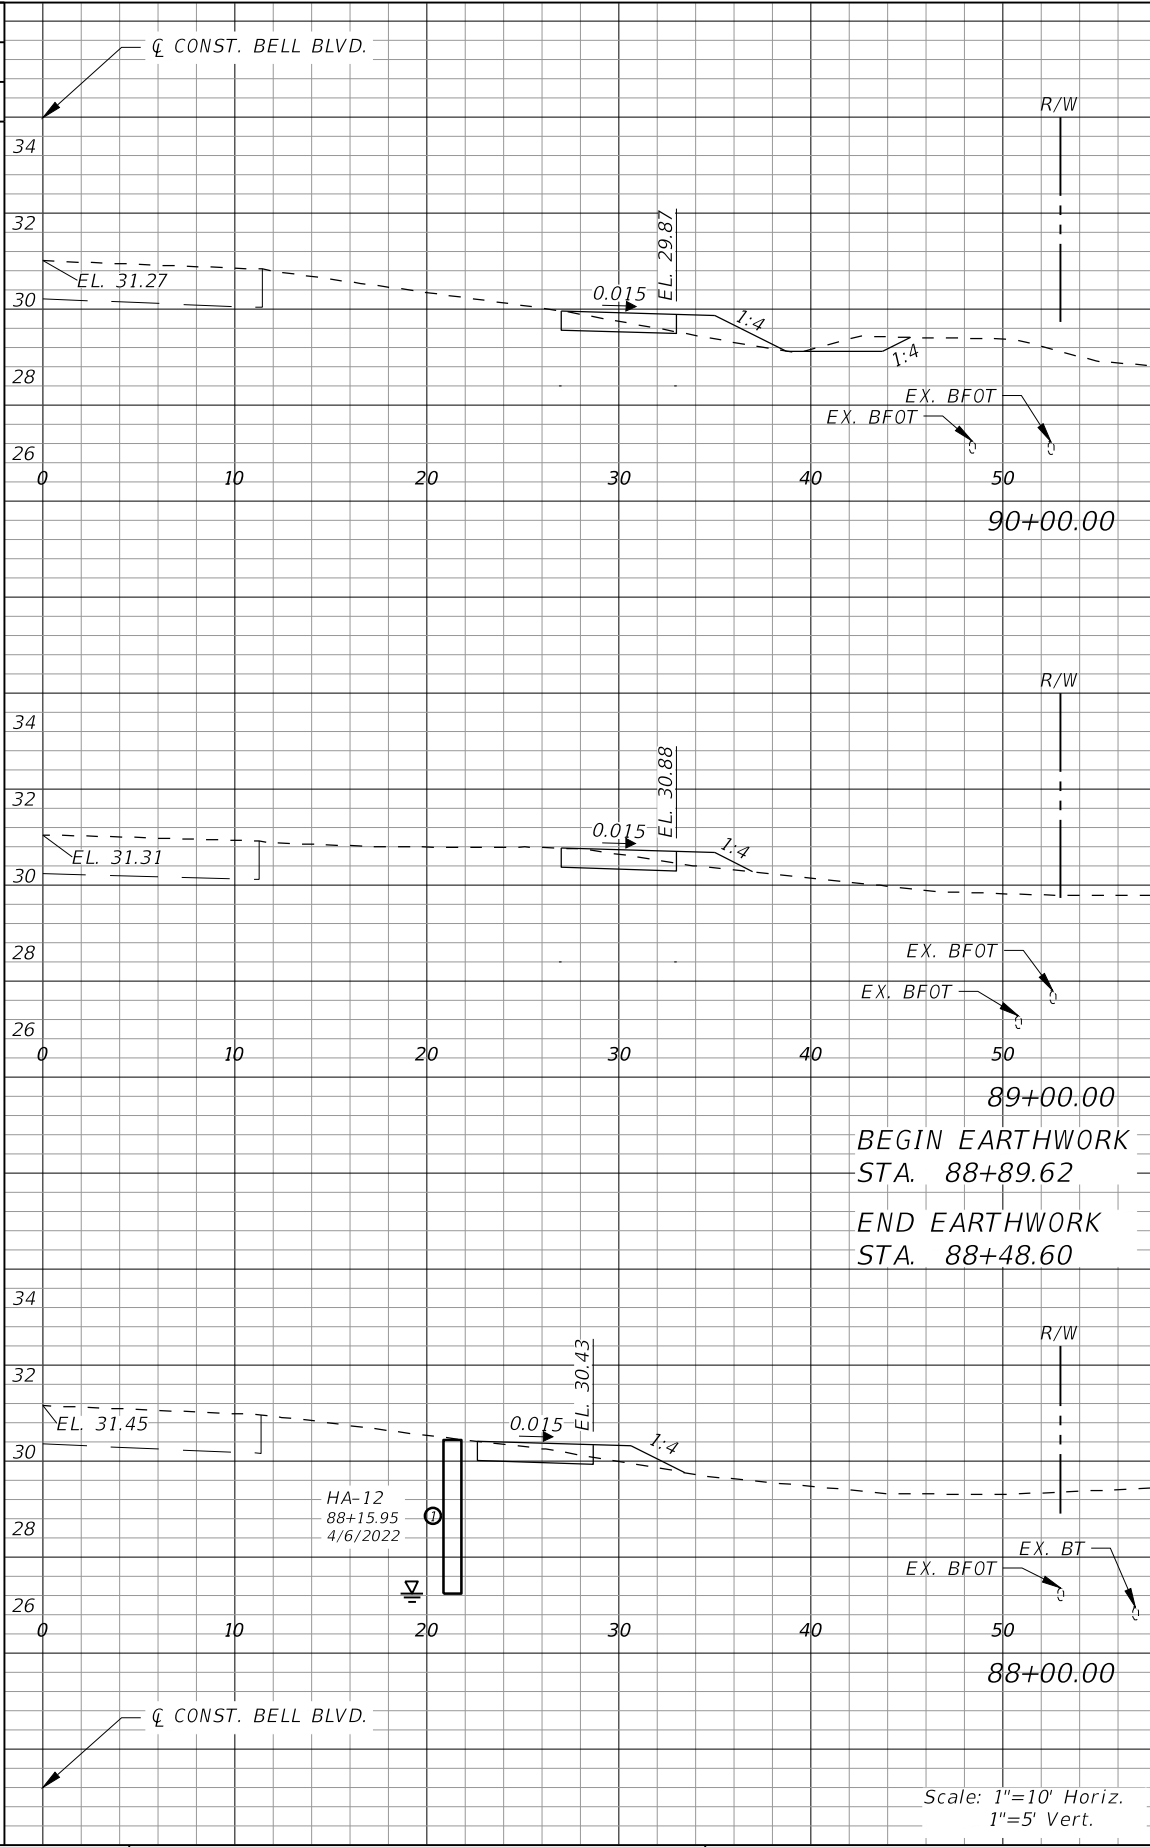
LEE COUNTY	
ROAD NO.	COUNTY PROJECT NO.
BELL BLVD. SR 82 TO SUNRISE BLVD. SIDEWALK	6002

**CROSS SECTIONS  
BELL BOULEVARD (RT.)**

SHEET  
NO.  
**89**



Regular Exc.		Embankment	
AREA	VOL.	AREA	VOL.
SF	CY	SF	CY
1	6	3	8
2	6	2	9
2	9	1	5

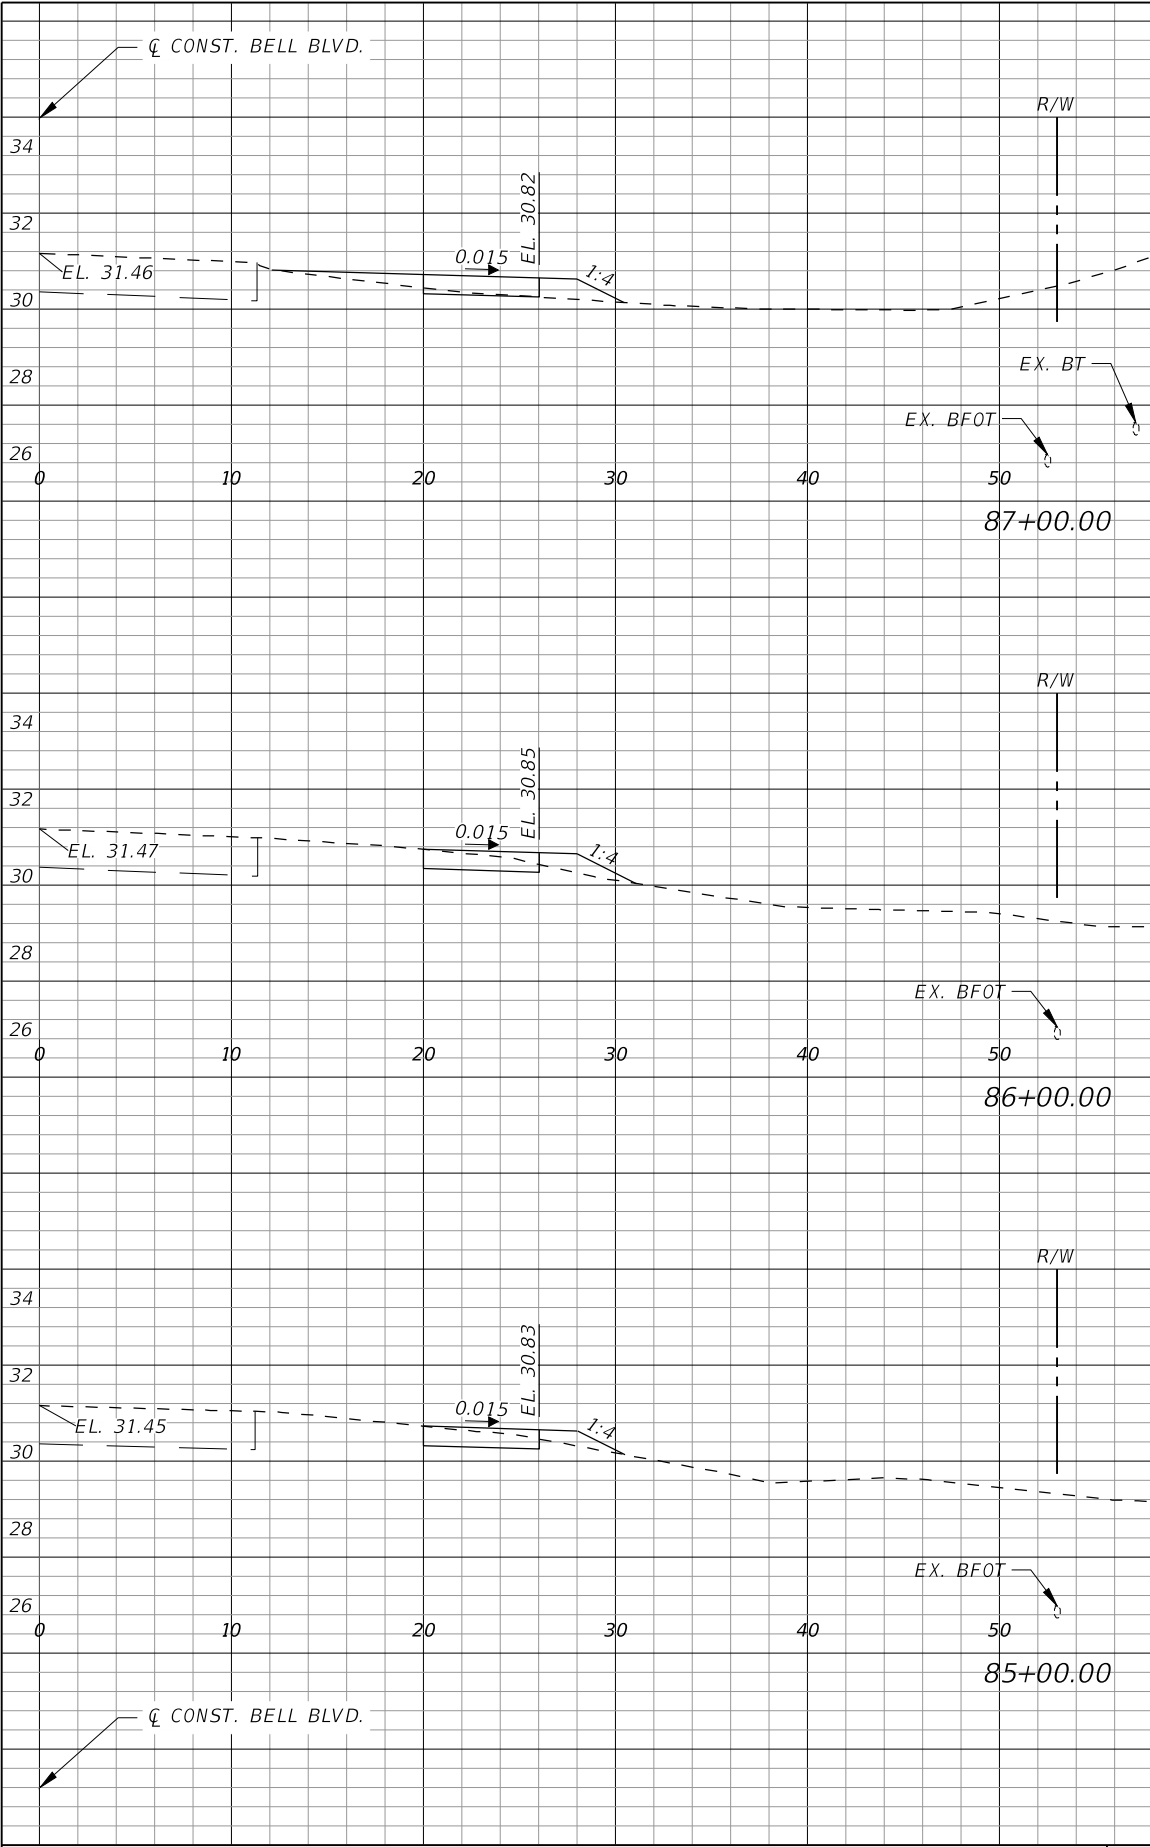

Regular Exc.		Embankment	
AREA	VOL.	AREA	VOL.
SF	CY	SF	CY
3	9	2	9
2	10	1	6
2	2	1	1

REVISIONS			
DATE	DESCRIPTION	DATE	DESCRIPTION




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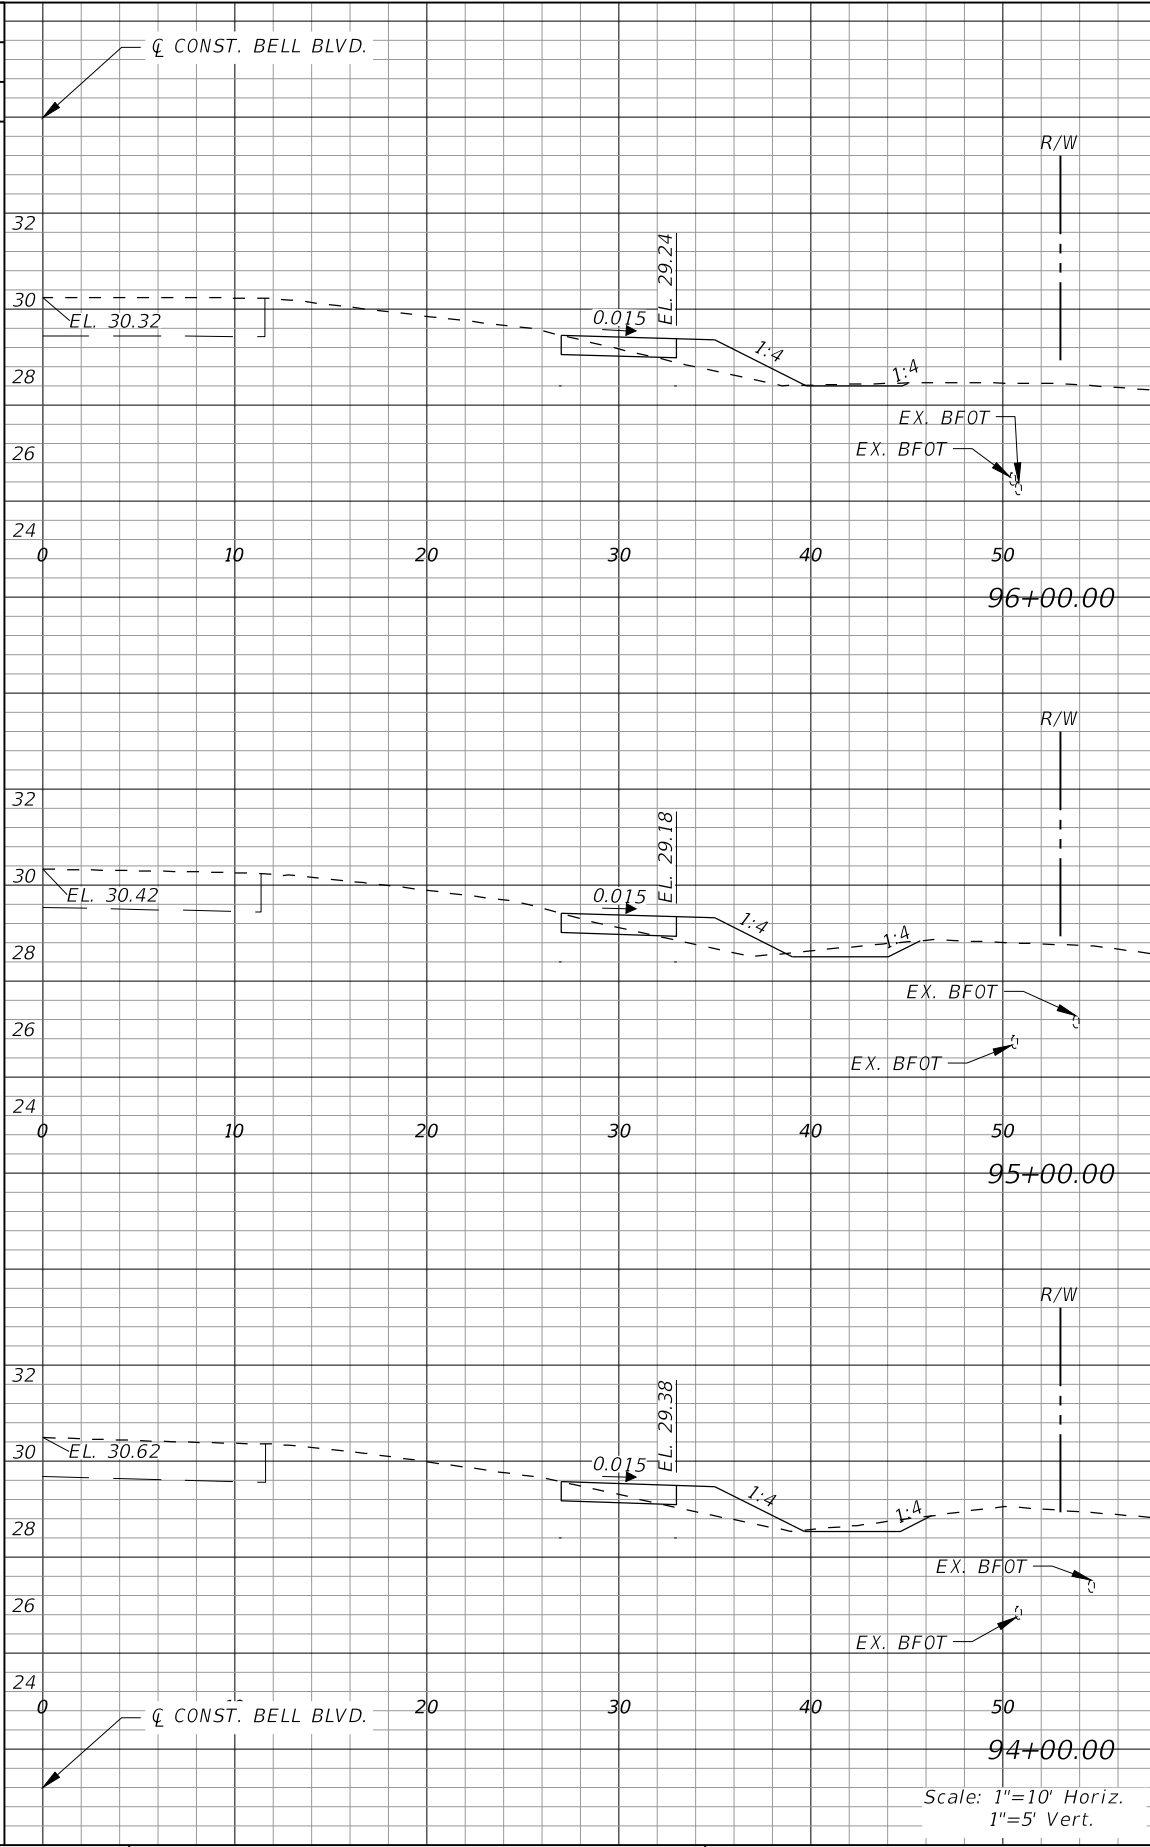
LEE COUNTY	
ROAD NO.	COUNTY PROJECT NO.
BELL BLVD. SR 82 TO SUNRISE BLVD. SIDEWALK	6002

**CROSS SECTIONS  
BELL BOULEVARD (RT.)**

SHEET  
NO.  
**90**



Regular		Exc.	Embankment	
AREA	VOL.		AREA	VOL.
SF	CY		SF	CY
	8			8
2		1		
	1		0	
0				
			0	
	0		7	
0			10	
	3		24	
2		3		

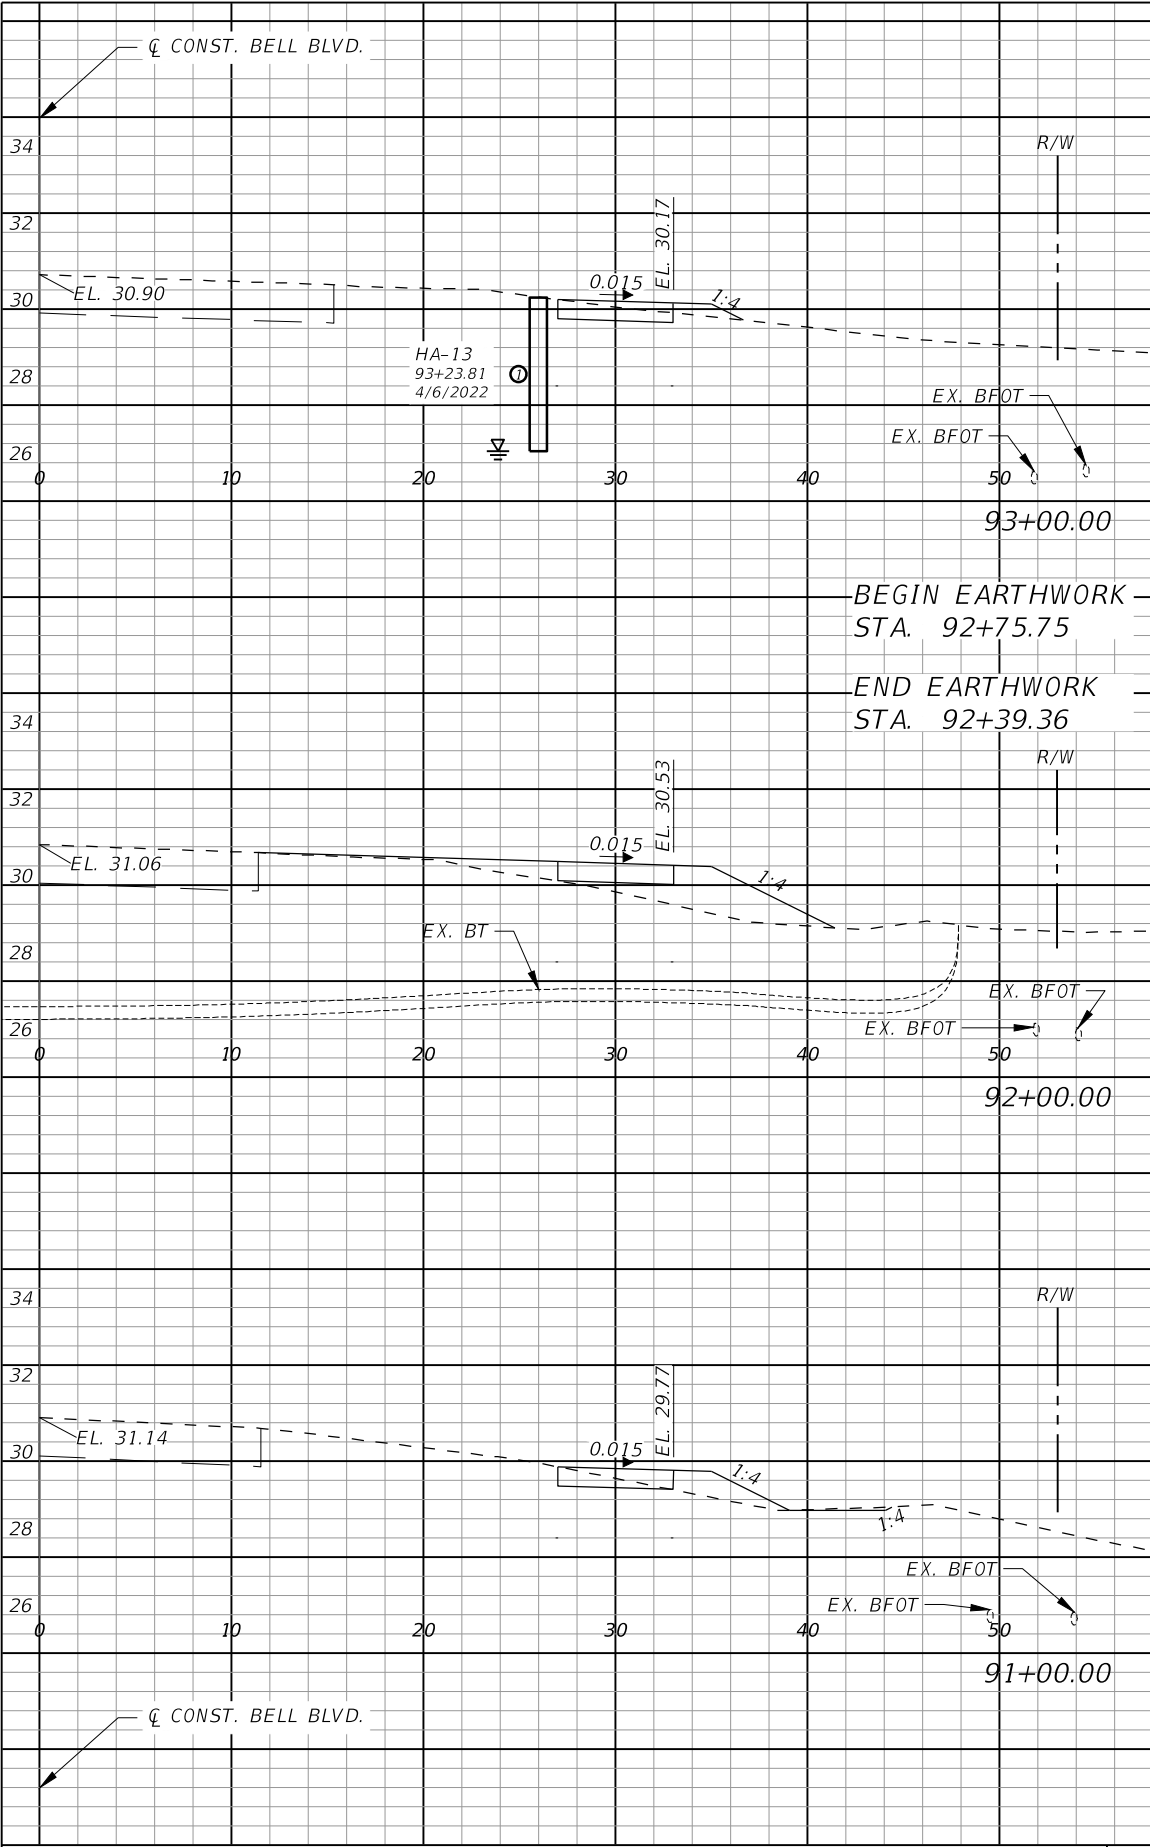

Regular		Exc.	Embankment	
AREA	VOL.		AREA	VOL.
SF	CY		SF	CY
		6		10
1			4	
		7		13
3			3	
	9			12
2			3	


REVISIONS			
DATE	DESCRIPTION	DATE	DESCRIPTION

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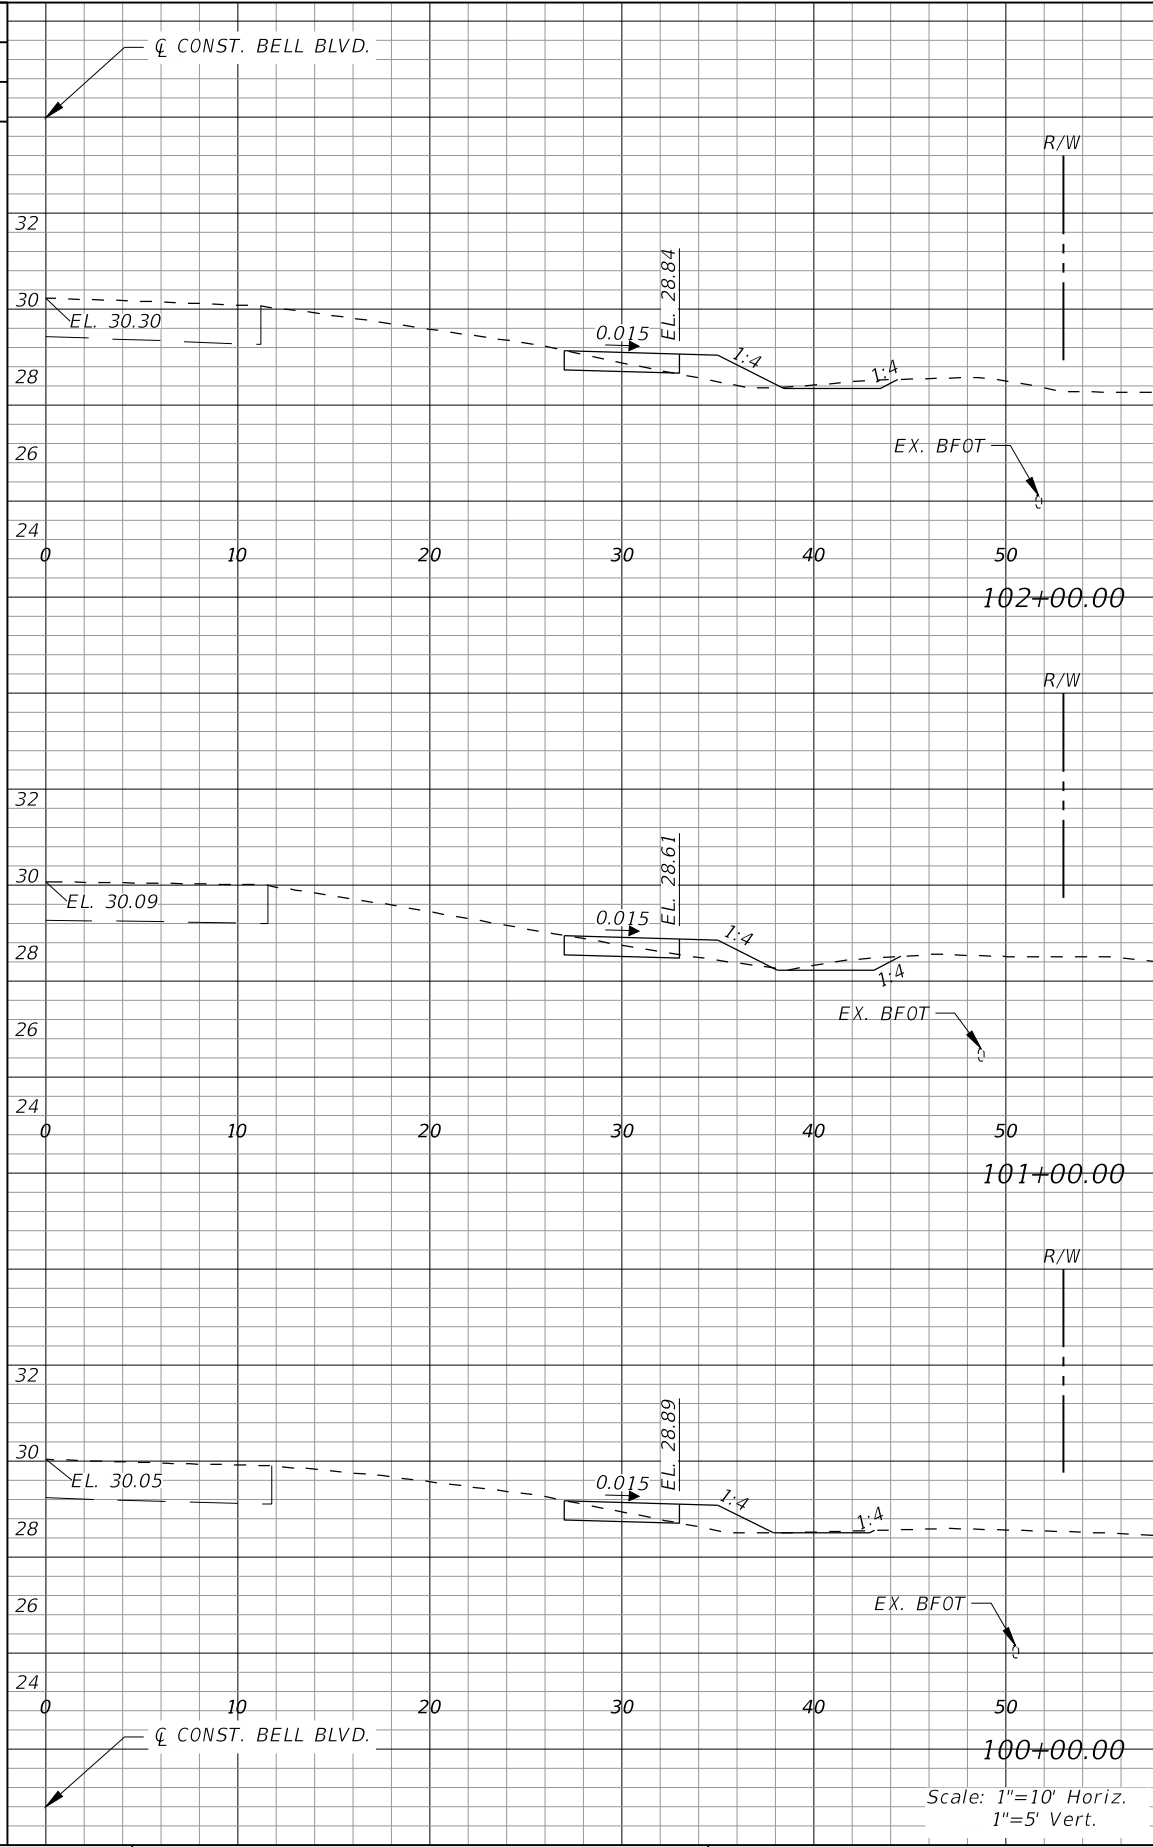
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LEE COUNTY	
ROAD NO.	COUNTY PROJECT NO.
BELL BLVD. SR 82 TO SUNRISE BLVD. SIDEWALK	6002

CROSS SECTIONS BELL BOULEVARD (RT.)	
SHEET NO. 91	



Regular		Exc.	Embankment	
AREA	VOL.		AREA	VOL.
SF	CY		SF	CY
	7			6
2		1		
0	2	0	1	
0		0		
1			0	
3		1		
8			6	
2		2		

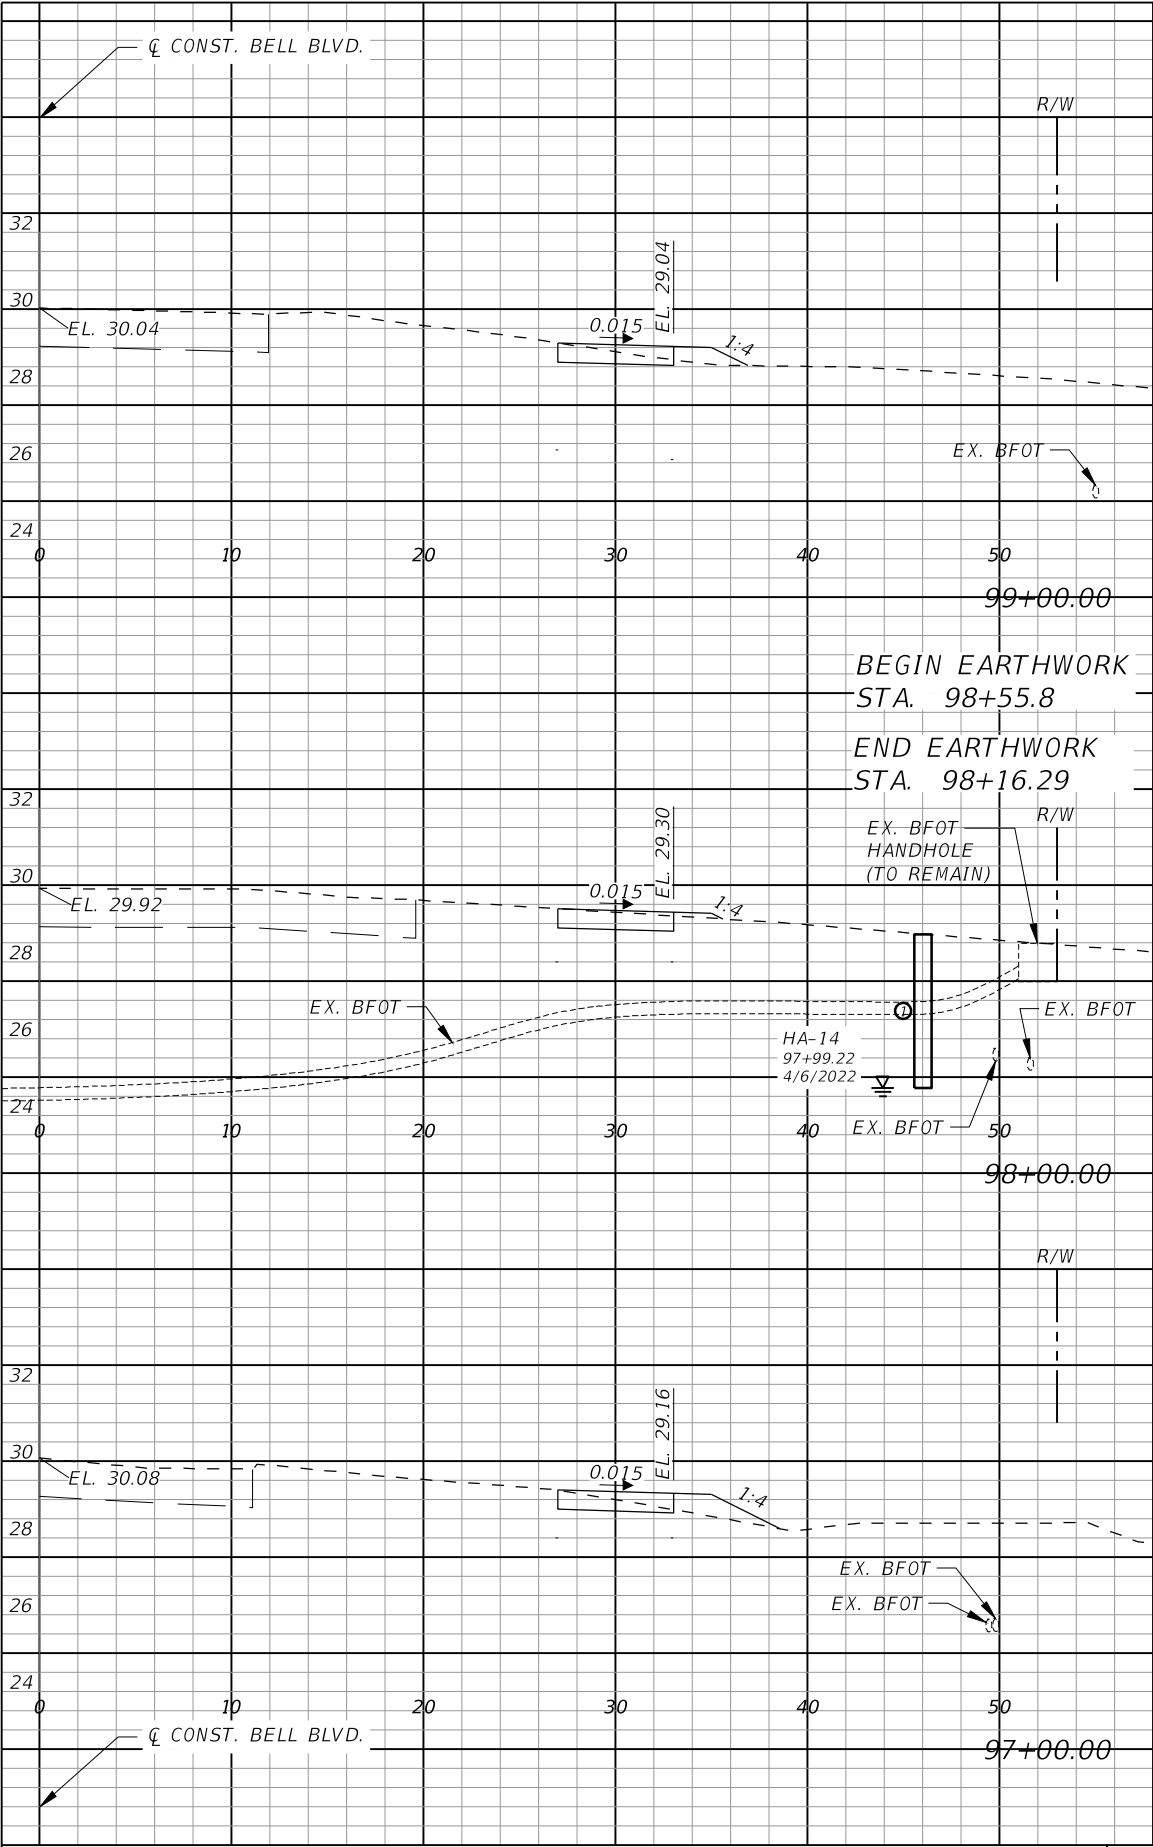

Regular		Exc.	Embankment	
AREA	VOL.		AREA	VOL.
SF	CY		SF	CY
	8			9
2		3		
9			8	
3		2		
8			7	
2		2		

REVISIONS			
DATE	DESCRIPTION	DATE	DESCRIPTION


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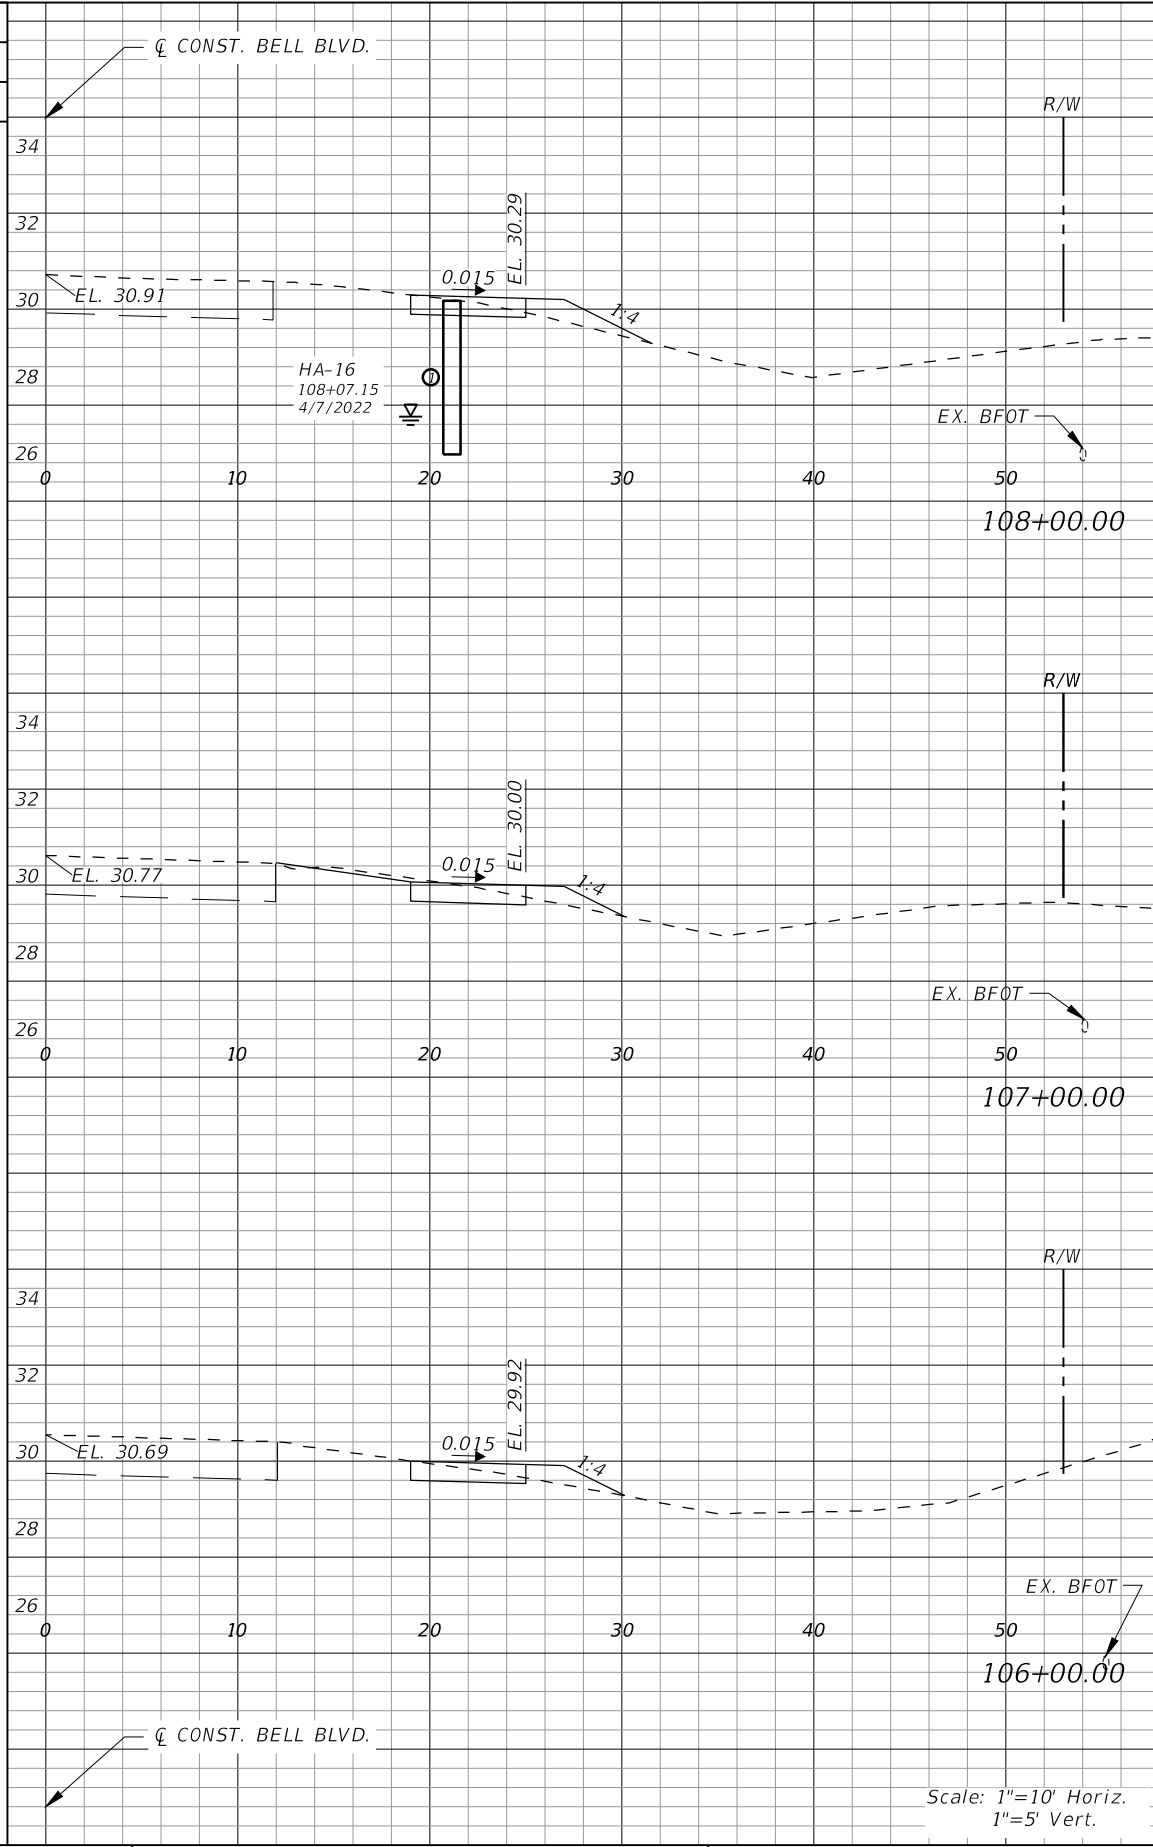
LEE COUNTY	
ROAD NO.	COUNTY PROJECT NO.
BELL BLVD. SR 82 TO SUNRISE BLVD. SIDEWALK	6002

**CROSS SECTIONS  
BELL BLVD.**

SHEET NO.  
**92**




Regular		Exc.	Embankment	
AREA	VOL.		AREA	VOL.
SF	CY		SF	CY
2	7		6	6
6			7	
1			3	
6			9	
2			2	

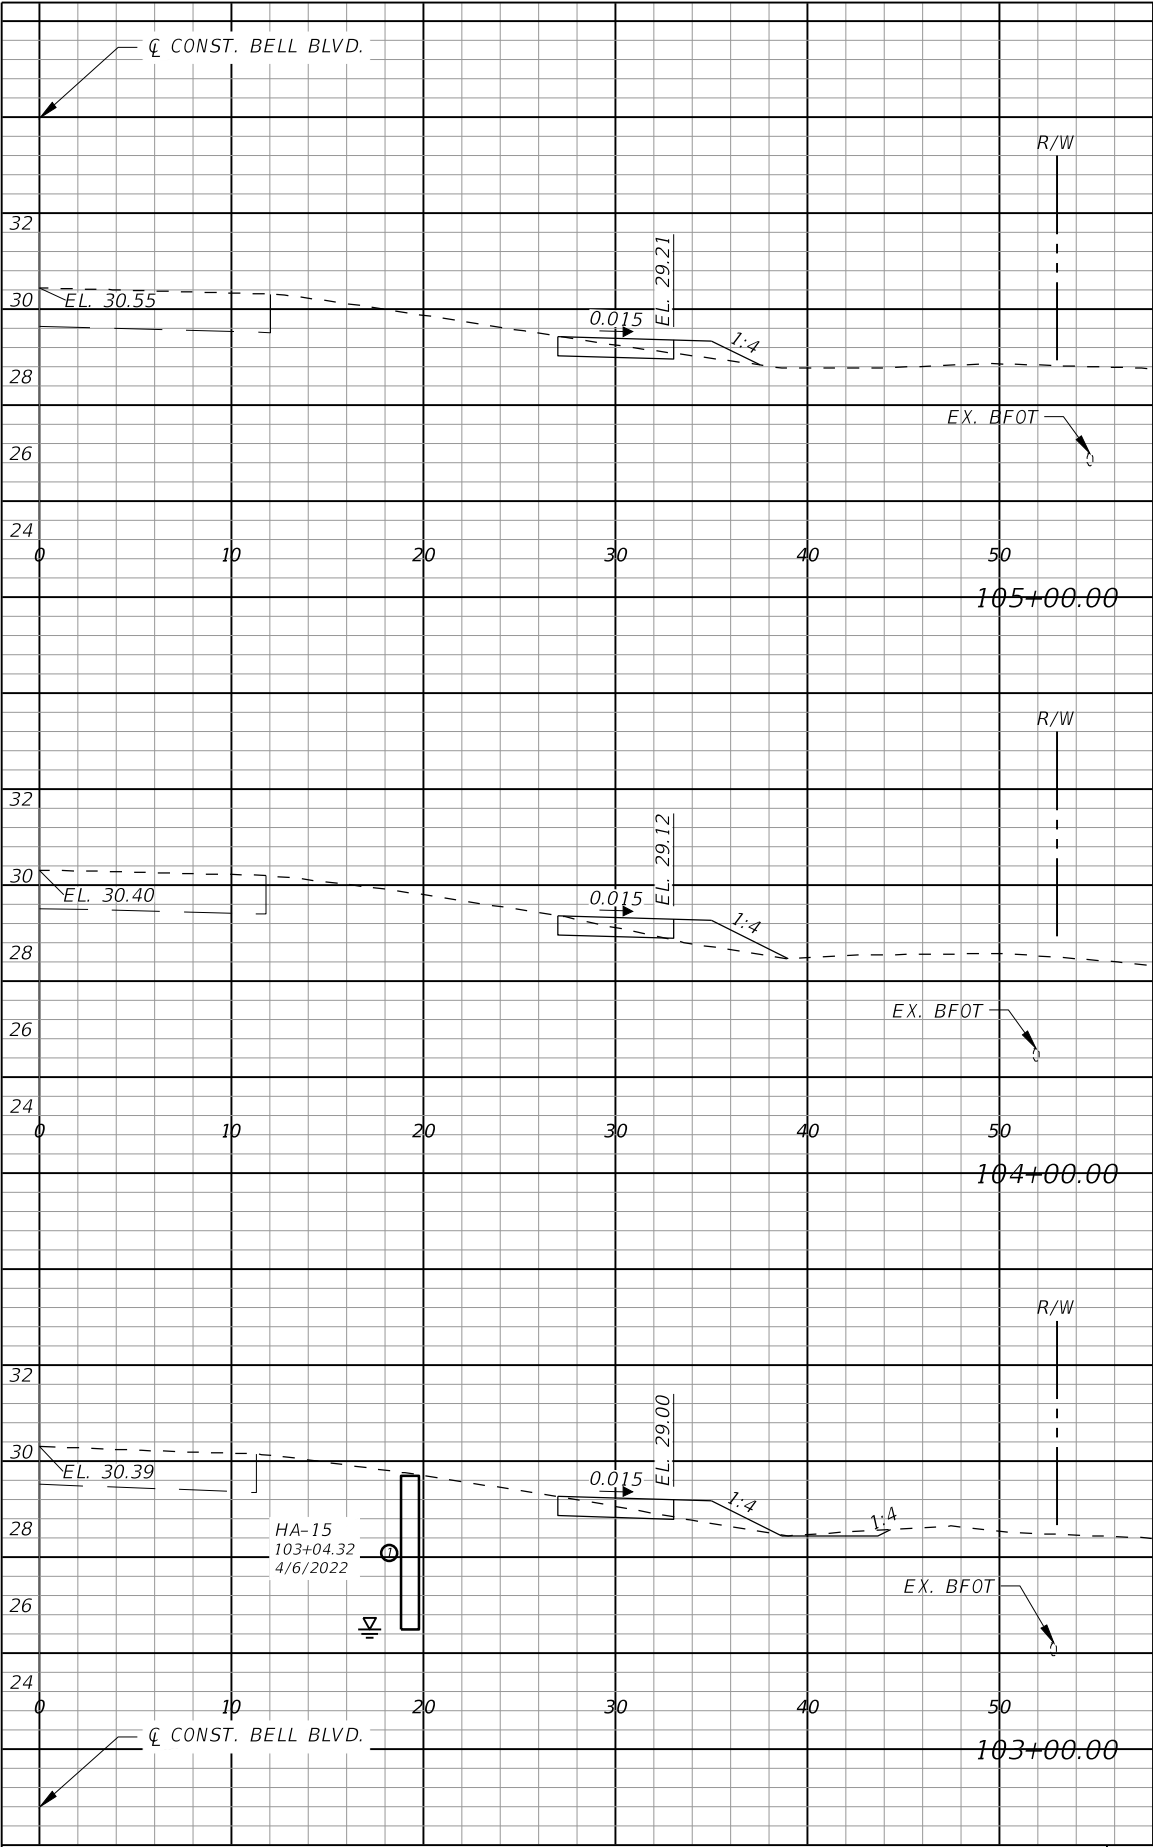

Regular		Exc.	Embankment	
AREA	VOL.		AREA	VOL.
SF	CY		SF	CY
2	7		2	7
3	9		2	7
2			2	
9			6	
2			2	

REVISIONS			
DATE	DESCRIPTION	DATE	DESCRIPTION



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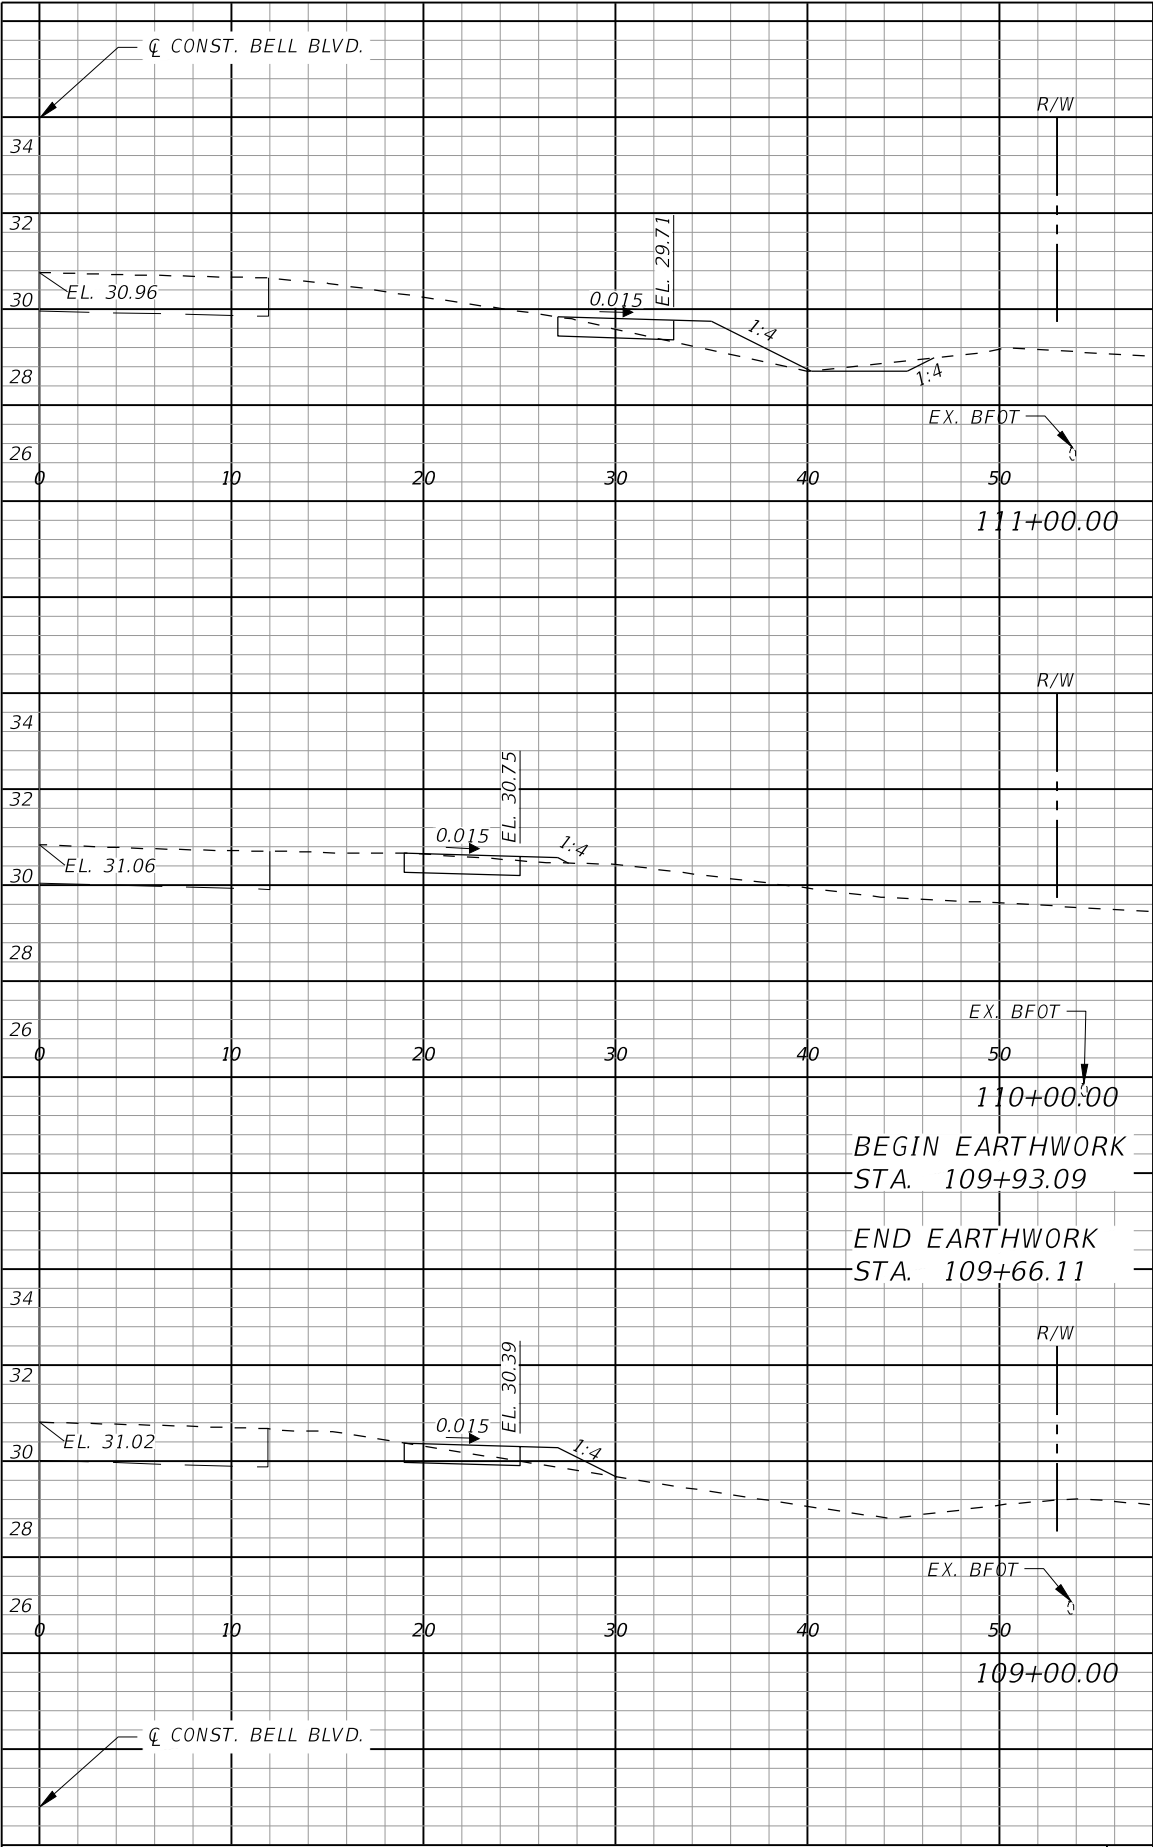
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LEE COUNTY	
ROAD NO.	COUNTY PROJECT NO.
BELL BLVD. SR 82 TO SUNRISE BLVD. SIDEWALK	6002


**CROSS SECTIONS  
BELL BLVD.**

SHEET NO.  
**93**





Regular		Exc.	Embankment	
AREA	VOL.		AREA	VOL.
SF	CY		SF	CY
2	8		13	
9			8	
3			1	
0			0	
0			0	
7			5	
2			2	

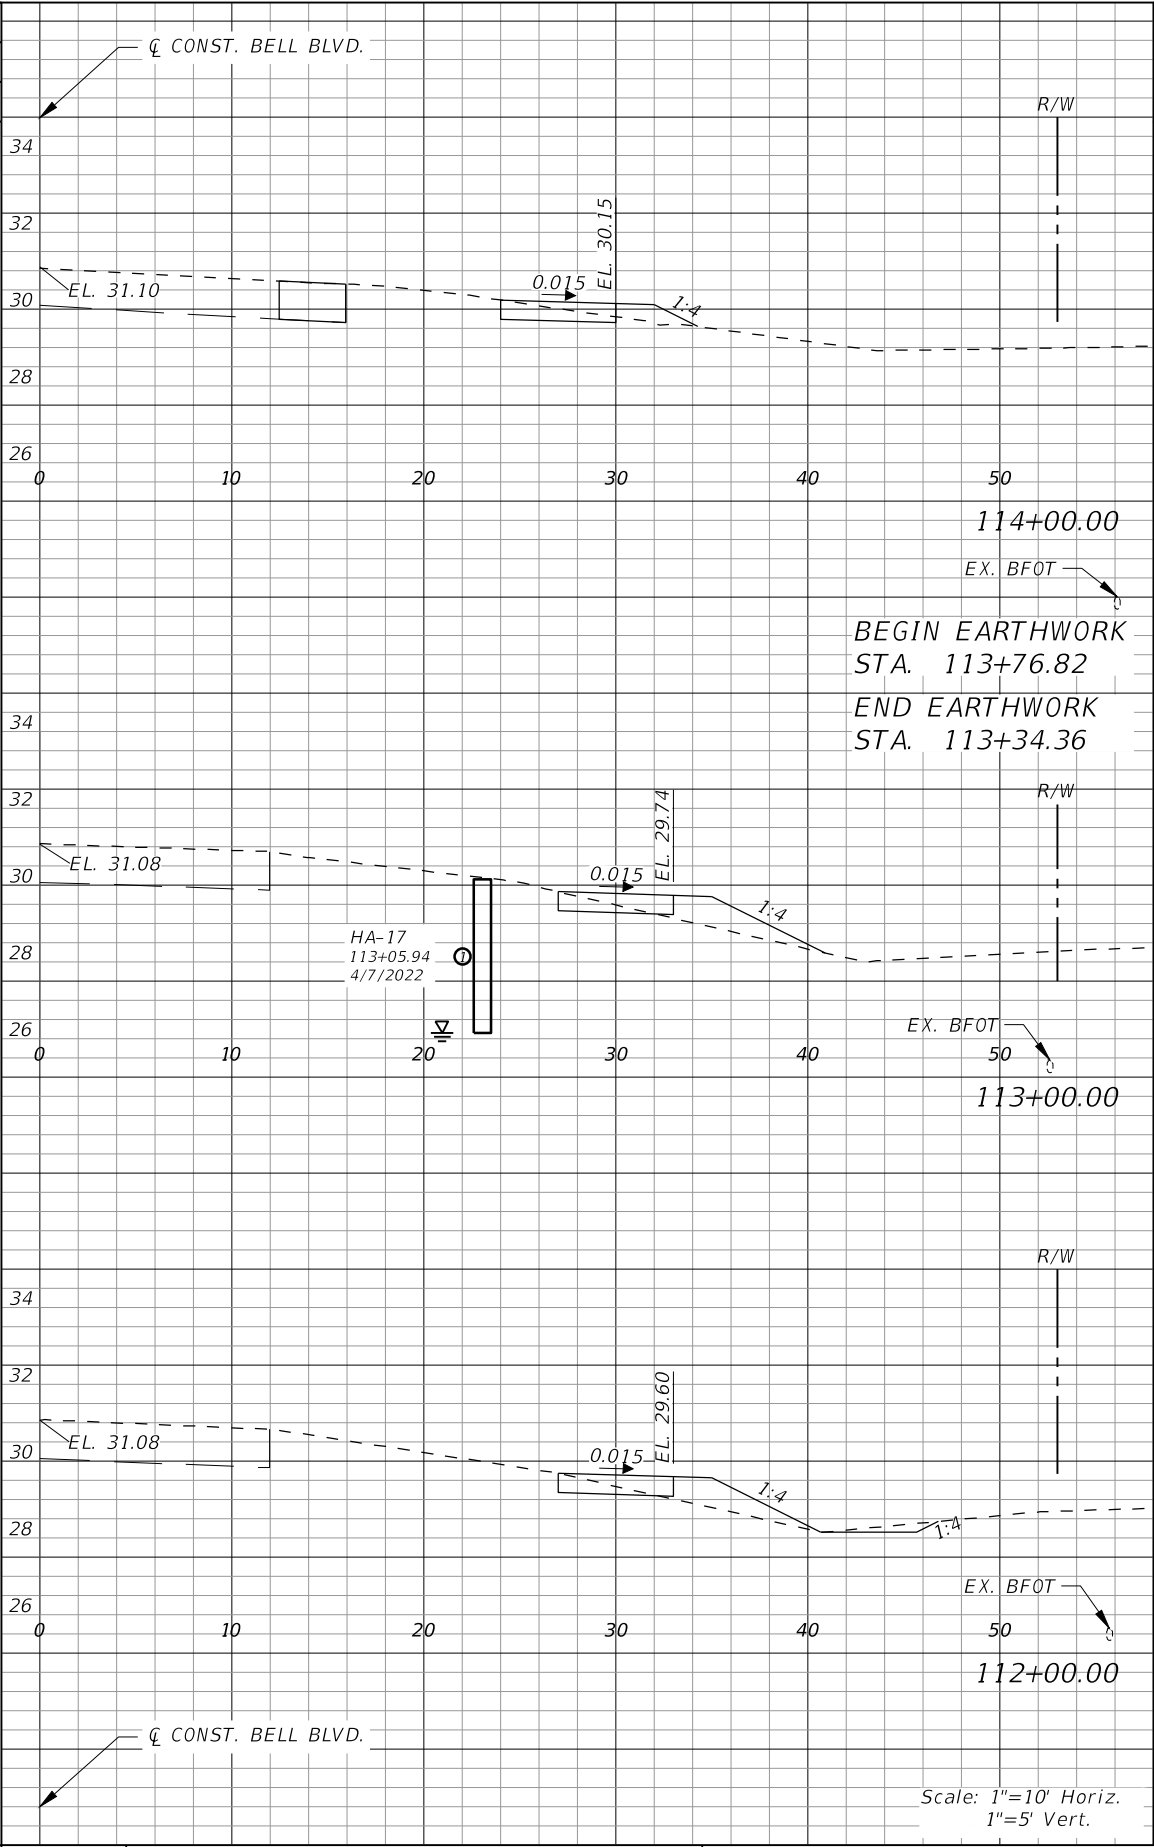

Regular		Exc.	Embankment	
AREA	VOL.		AREA	VOL.
SF	CY		SF	CY
2	7			7
1			1	
0			0	
0			0	
1			2	
1			4	
2			4	

REVISIONS			
DATE	DESCRIPTION	DATE	DESCRIPTION



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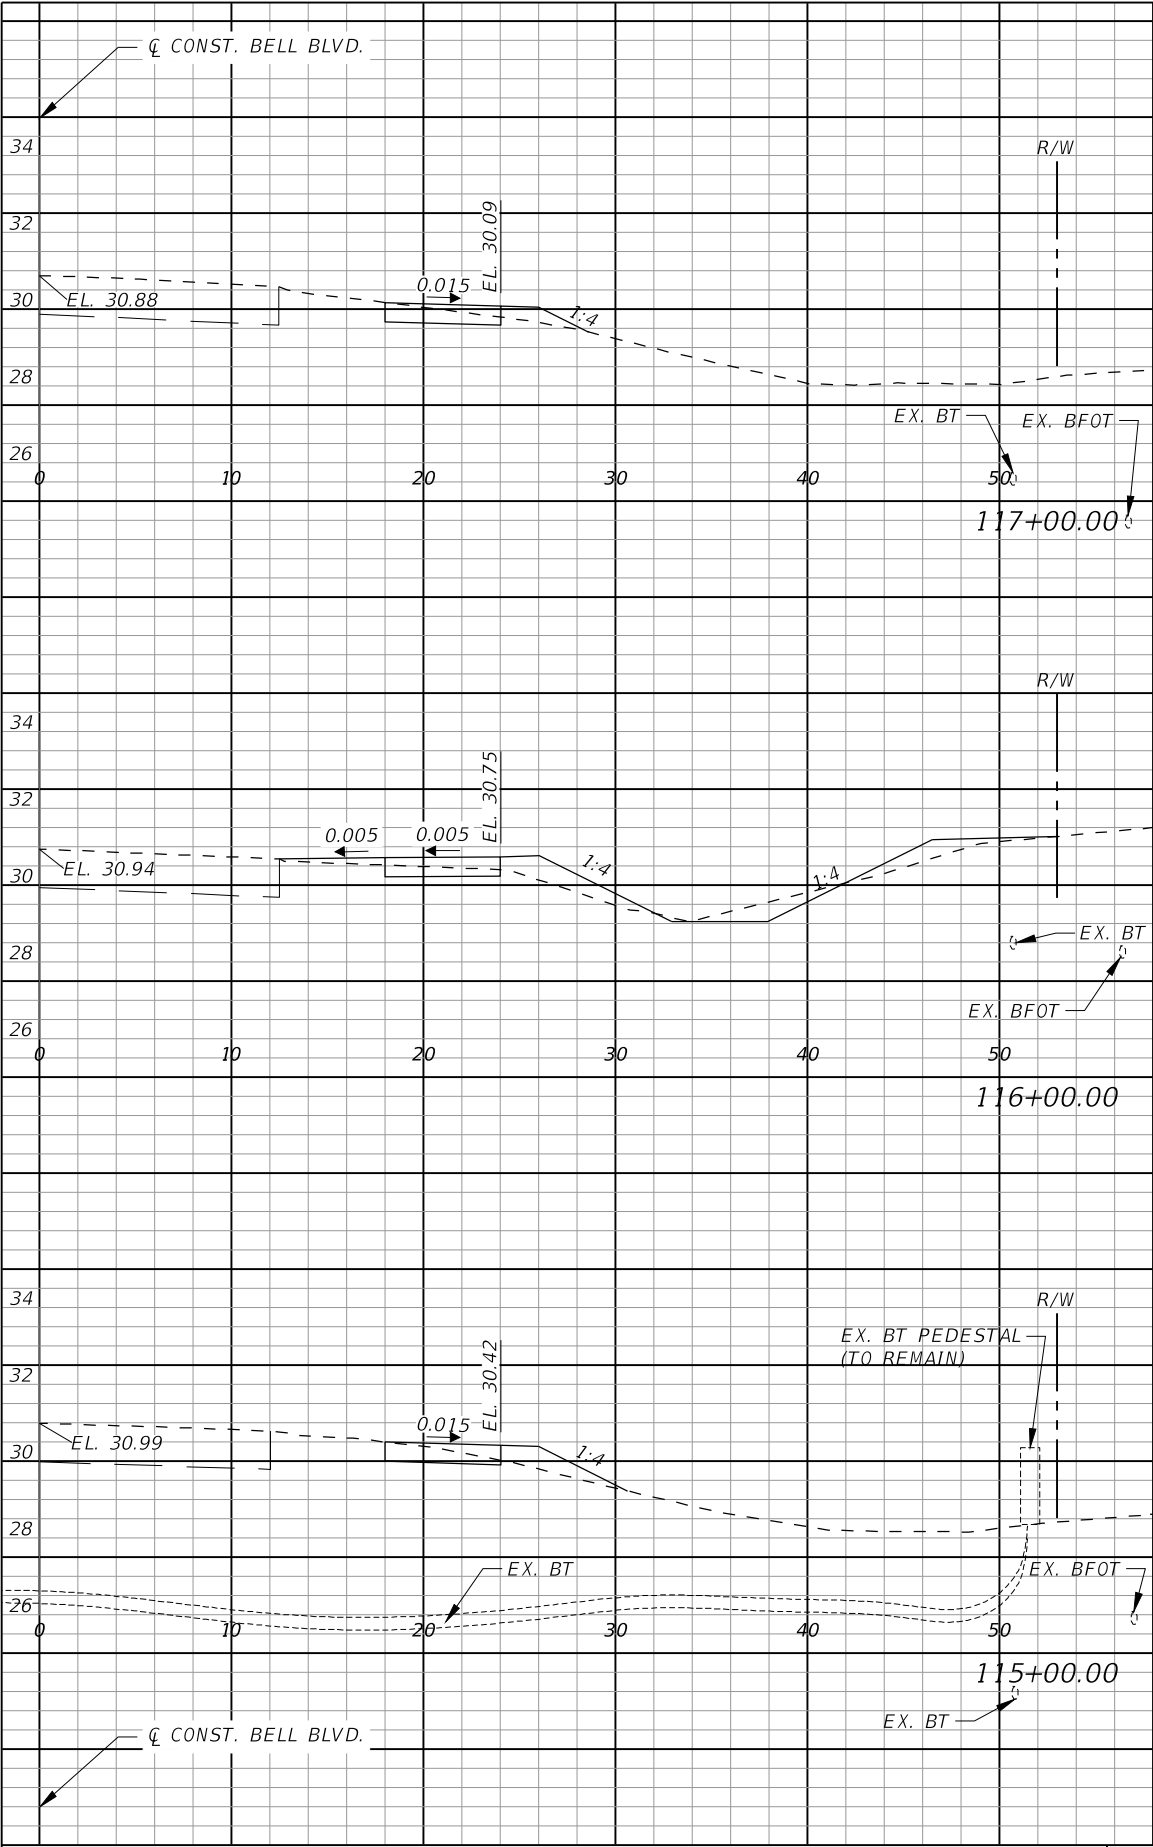
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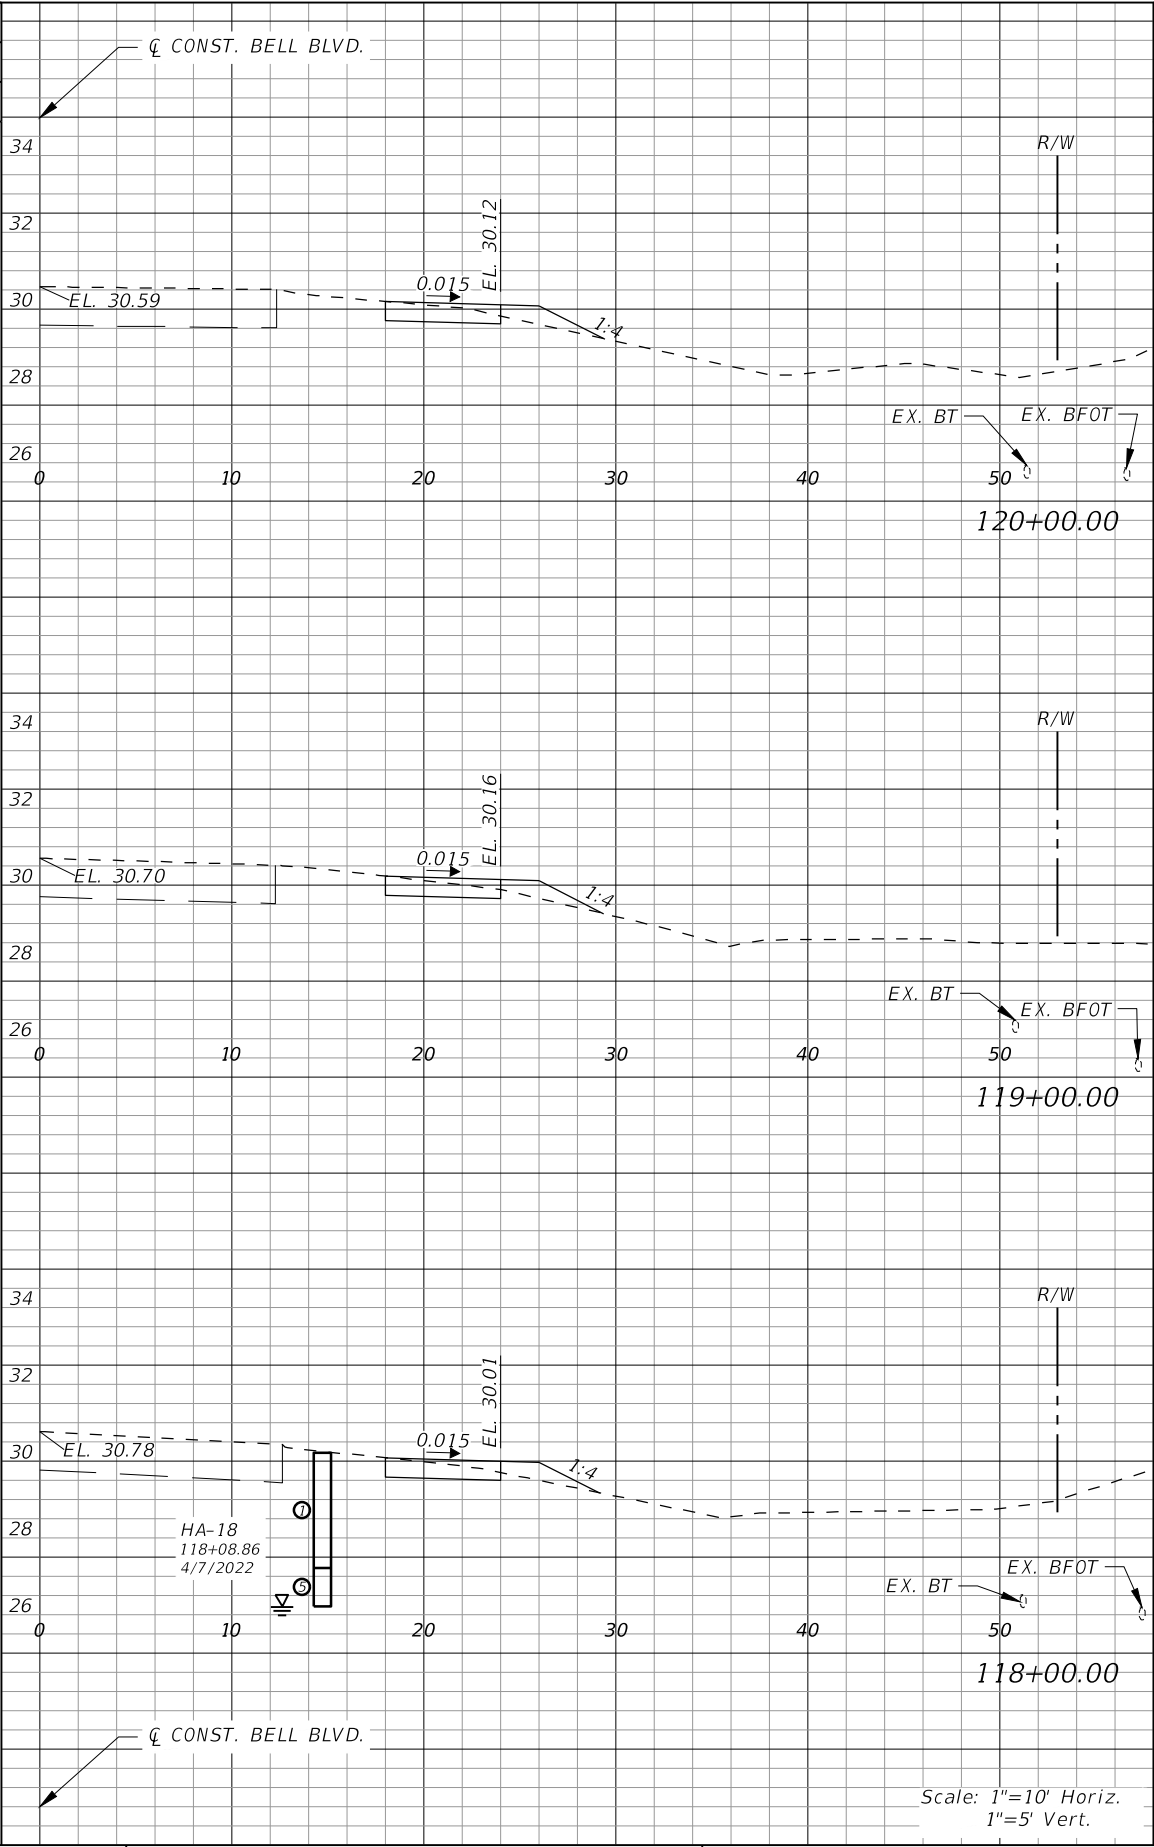
ROAD NO.	COUNTY PROJECT NO.
BELL BLVD. SR 82 TO SUNRISE BLVD. SIDEWALK	6002

**CROSS SECTIONS  
BELL BOULEVARD (RT.)**

SHEET NO.  
**94**




Regular Exc.		Embankment	
AREA	VOL.	AREA	VOL.
SF	CY	SF	CY
2	8	1	5
11		13	
4		6	
2		2	



Regular Exc.		Embankment	
AREA	VOL.	AREA	VOL.
SF	CY	SF	CY
2	9	2	7
2		2	
2		2	
2		2	

REVISIONS			
DATE	DESCRIPTION	DATE	DESCRIPTION




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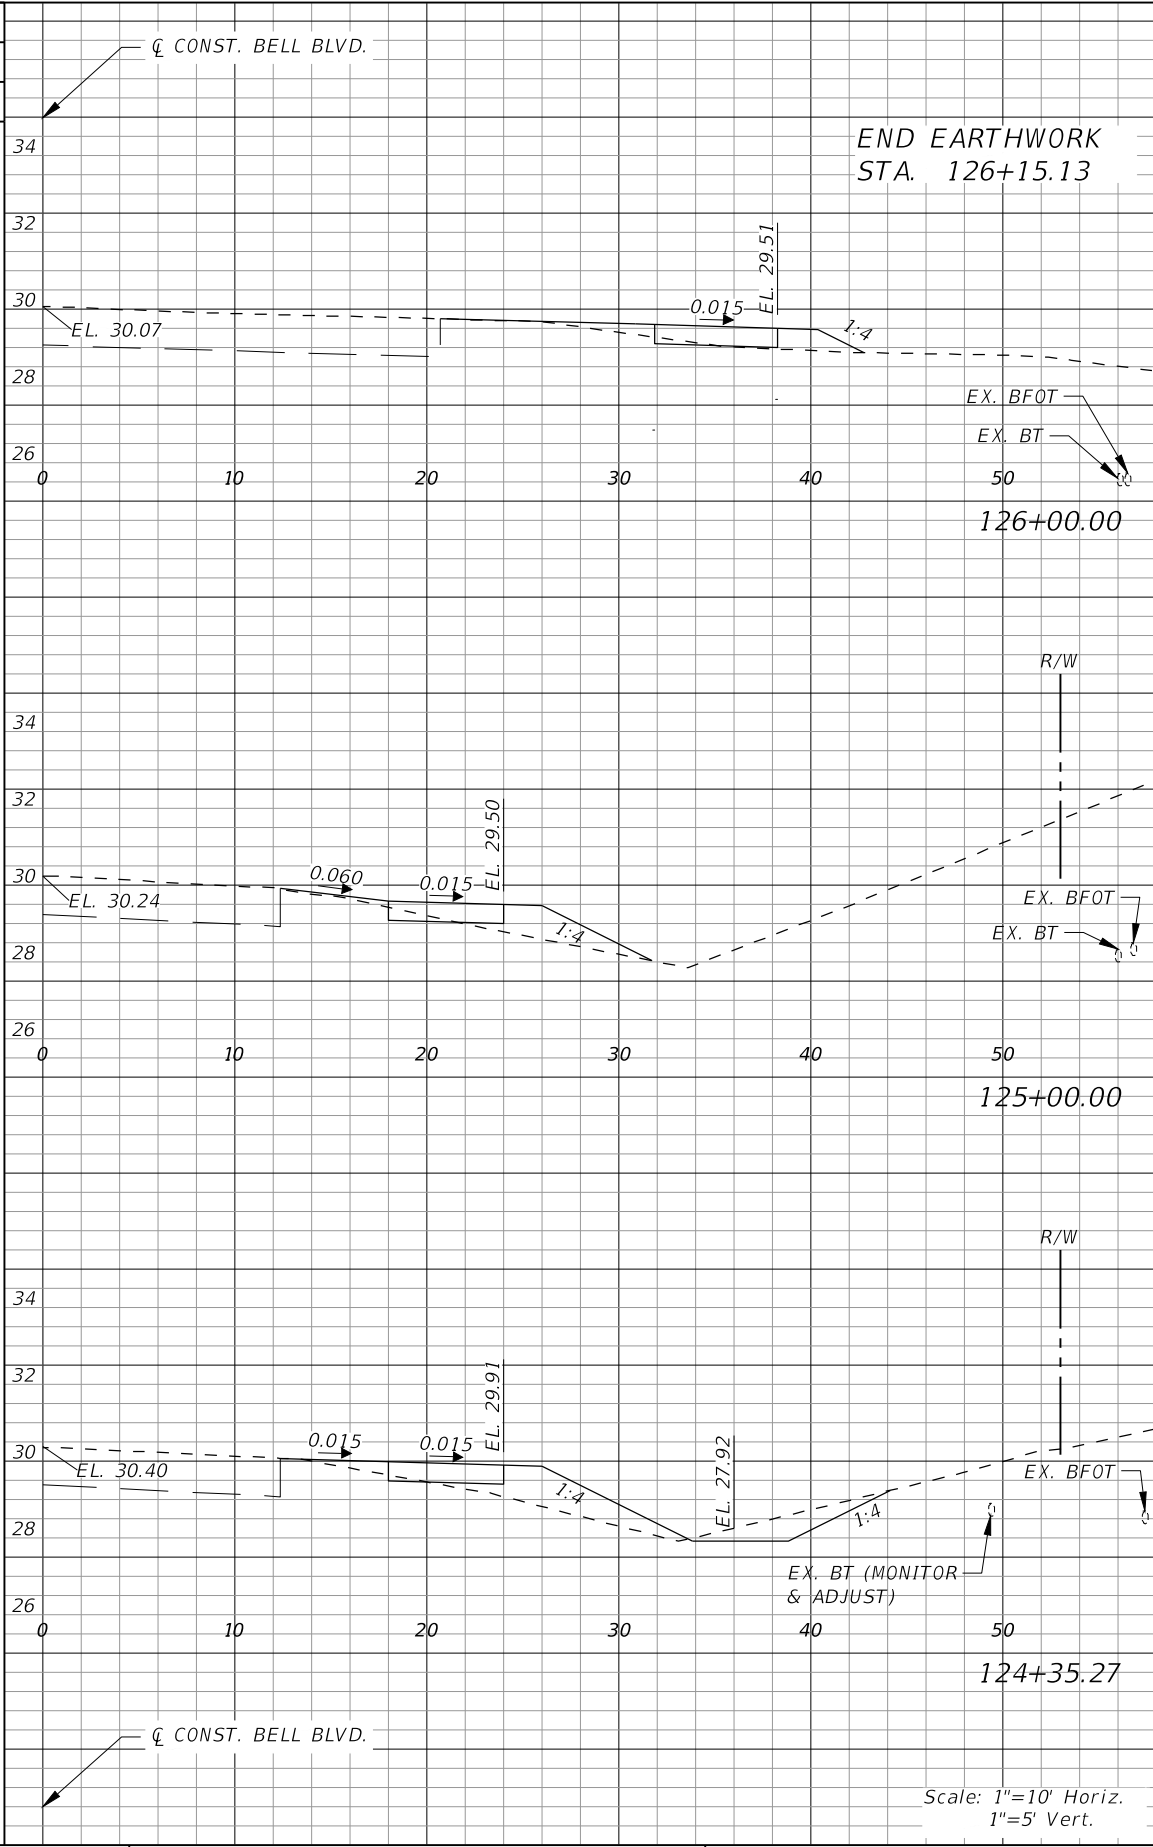
LEE COUNTY	
ROAD NO.	COUNTY PROJECT NO.
BELL BLVD. SR 82 TO SUNRISE BLVD. SIDEWALK	6002

**CROSS SECTIONS  
BELL BOULEVARD (RT.)**

SHEET NO.  
**95**




Regular Exc.		Embankment	
AREA	VOL.	AREA	VOL.
SF	CY	SF	CY
2	14	2	24
7		8	
8		8	
2		2	

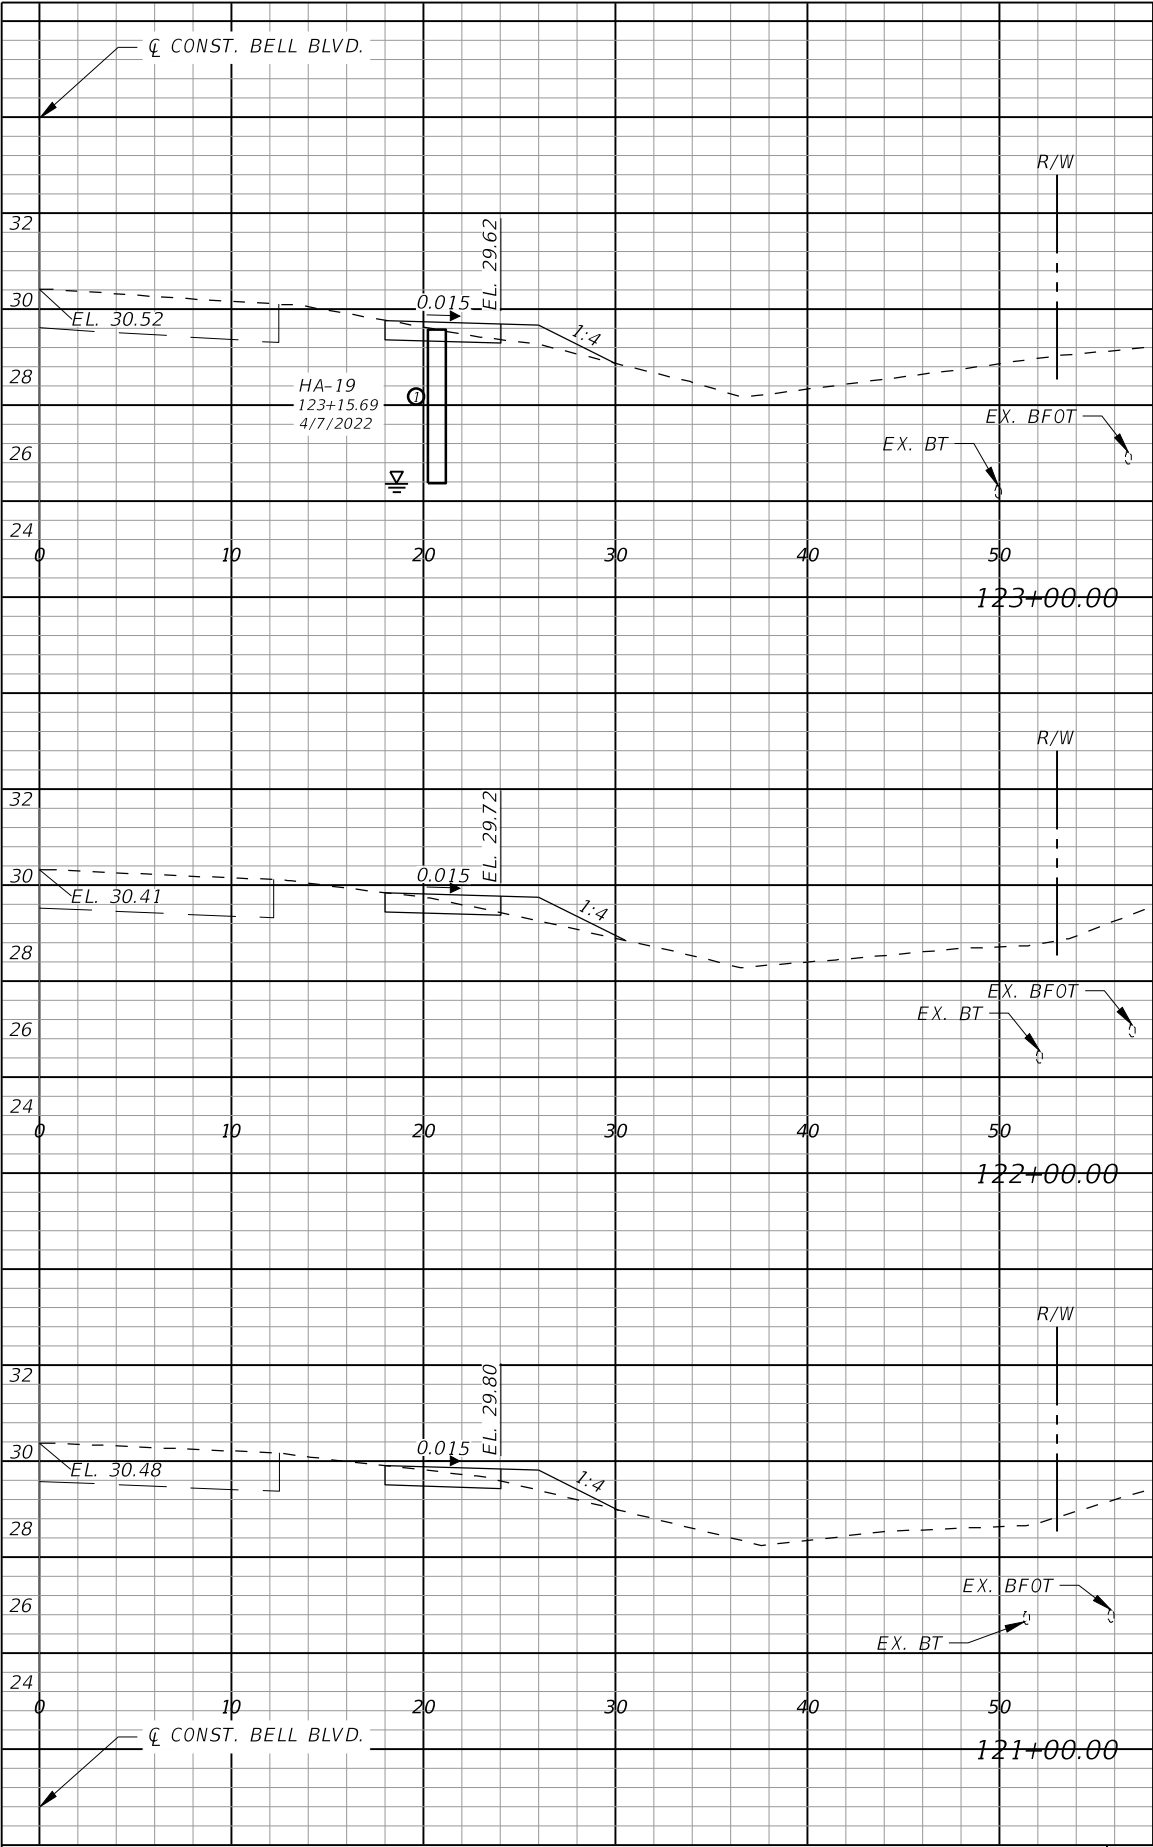

Regular Exc.		Embankment	
AREA	VOL.	AREA	VOL.
SF	CY	SF	CY
0		0	
1	0	3	1
1	3	5	14
4	5	8	15

REVISIONS			
DATE	DESCRIPTION	DATE	DESCRIPTION




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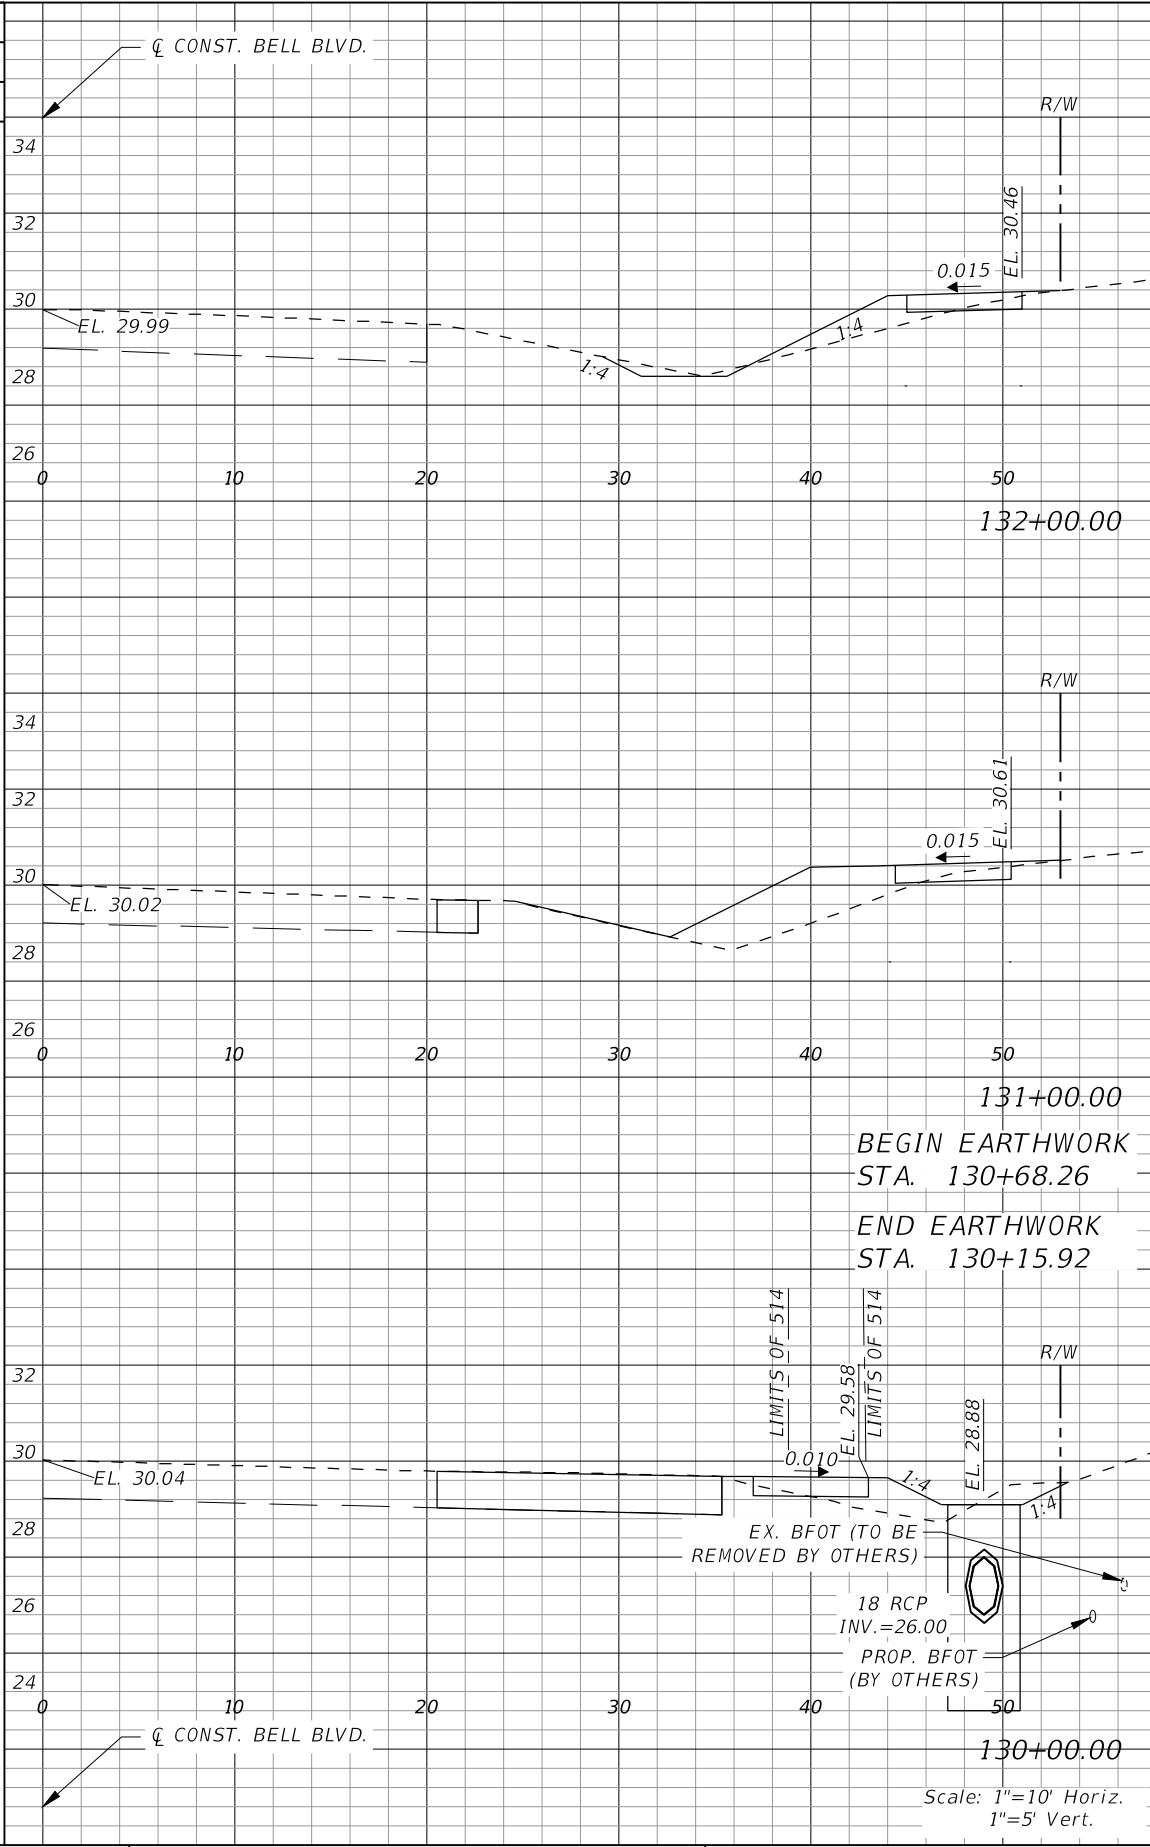
LEE COUNTY	
ROAD NO.	COUNTY PROJECT NO.
BELL BLVD. SR 82 TO SUNRISE BLVD. SIDEWALK	6002

**CROSS SECTIONS  
BELL BOULEVARD (RT.)**

SHEET NO.  
**96**




Regular		Exc.	Embankment	
AREA	VOL.		AREA	VOL.
SF	CY		SF	CY
2	6		3	12
6			30	
1			13	
2			40	
0			9	
0			7	

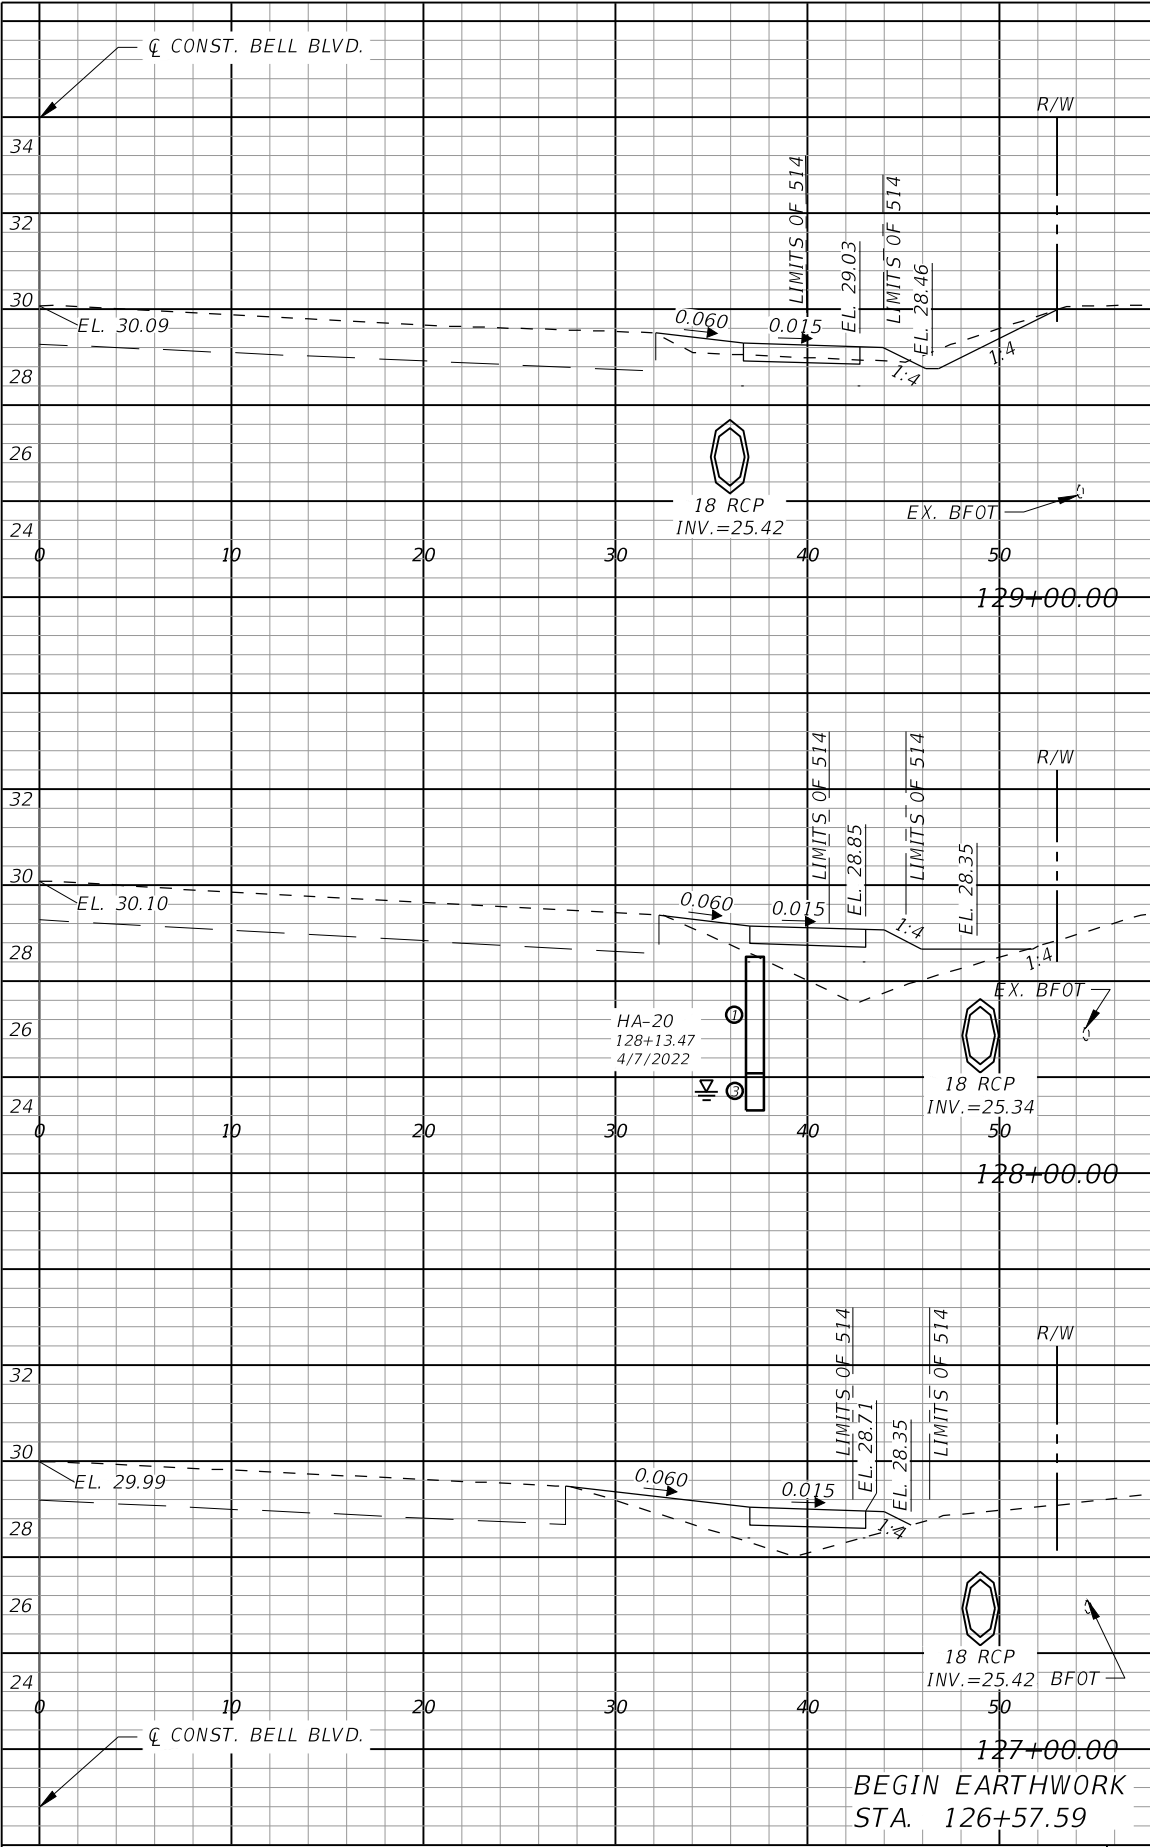

Regular		Exc.	Embankment	
AREA	VOL.		AREA	VOL.
SF	CY		SF	CY
2	6		4	13
5			31	
1	1		12	7
0			0	
0			1	
1			4	

REVISIONS			
DATE	DESCRIPTION	DATE	DESCRIPTION




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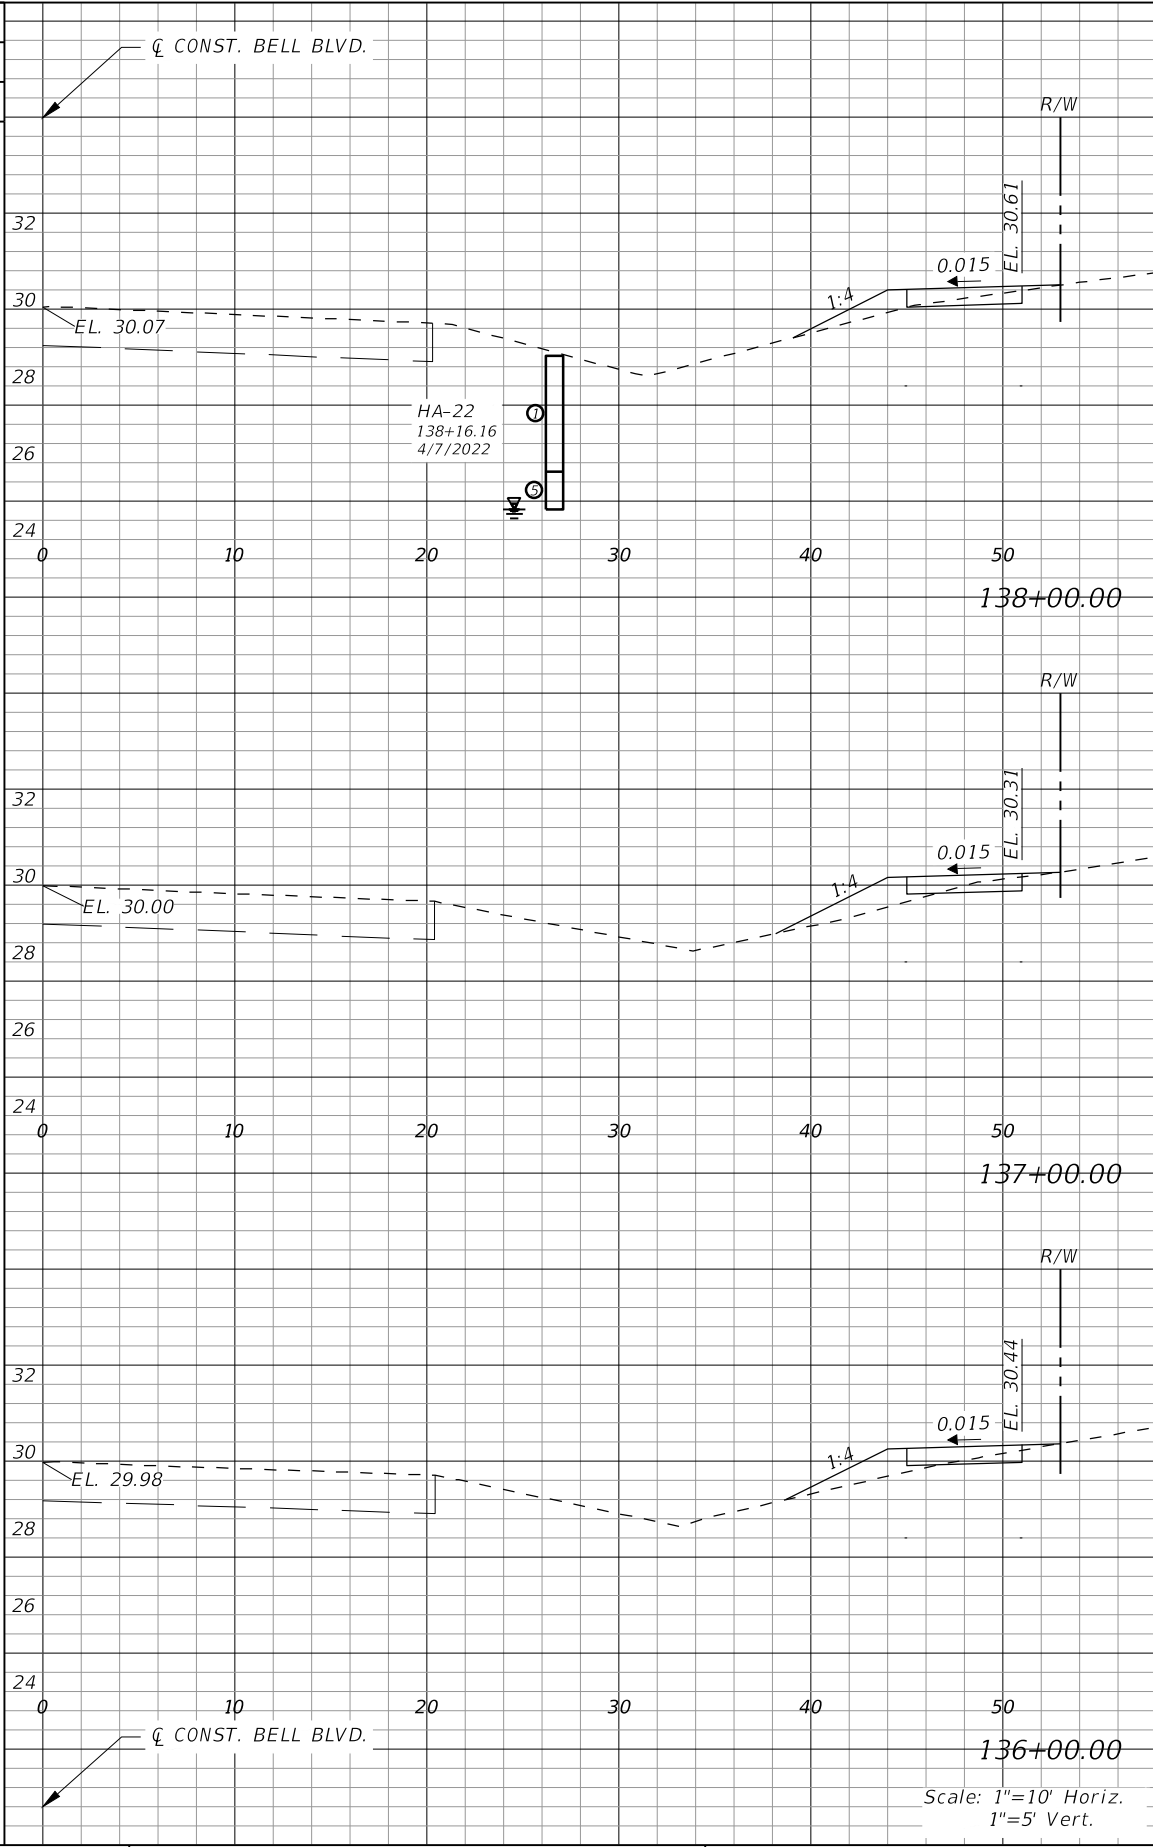
LEE COUNTY	
ROAD NO.	COUNTY PROJECT NO.
BELL BLVD. SR 82 TO SUNRISE BLVD. SIDEWALK	6002

**CROSS SECTIONS  
BELL BOULEVARD (RT.)**

SHEET NO.  
**97**




Regular		Exc.	Embankment	
AREA	VOL.		AREA	VOL.
SF	CY		SF	CY
2	5		1	8
1	5		3	8
2	4		3	11

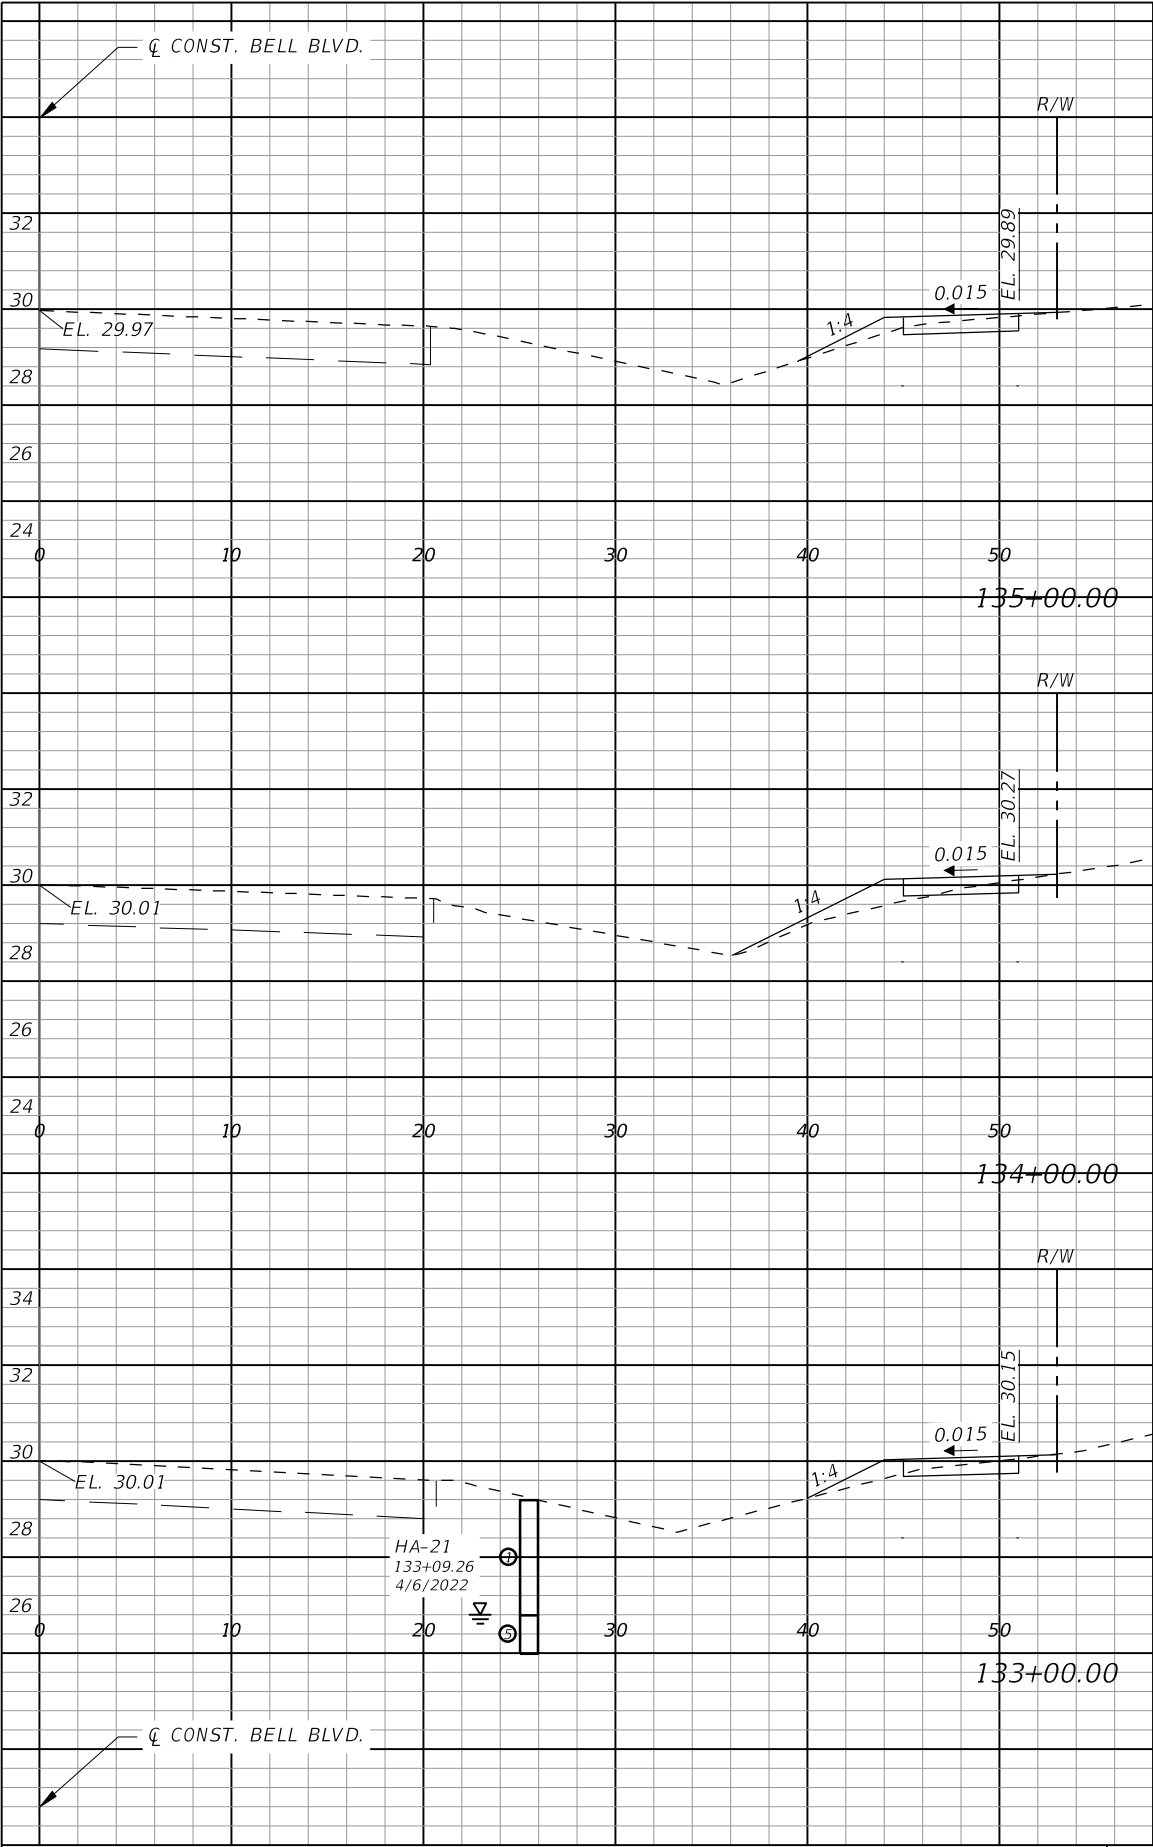

Regular		Exc.	Embankment	
AREA	VOL.		AREA	VOL.
SF	CY		SF	CY
1	4		2	8
1	4		3	10
1	3		3	11

REVISIONS			
DATE	DESCRIPTION	DATE	DESCRIPTION



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Bonita Springs, Florida 34134  
Phone: 239.947.1144  
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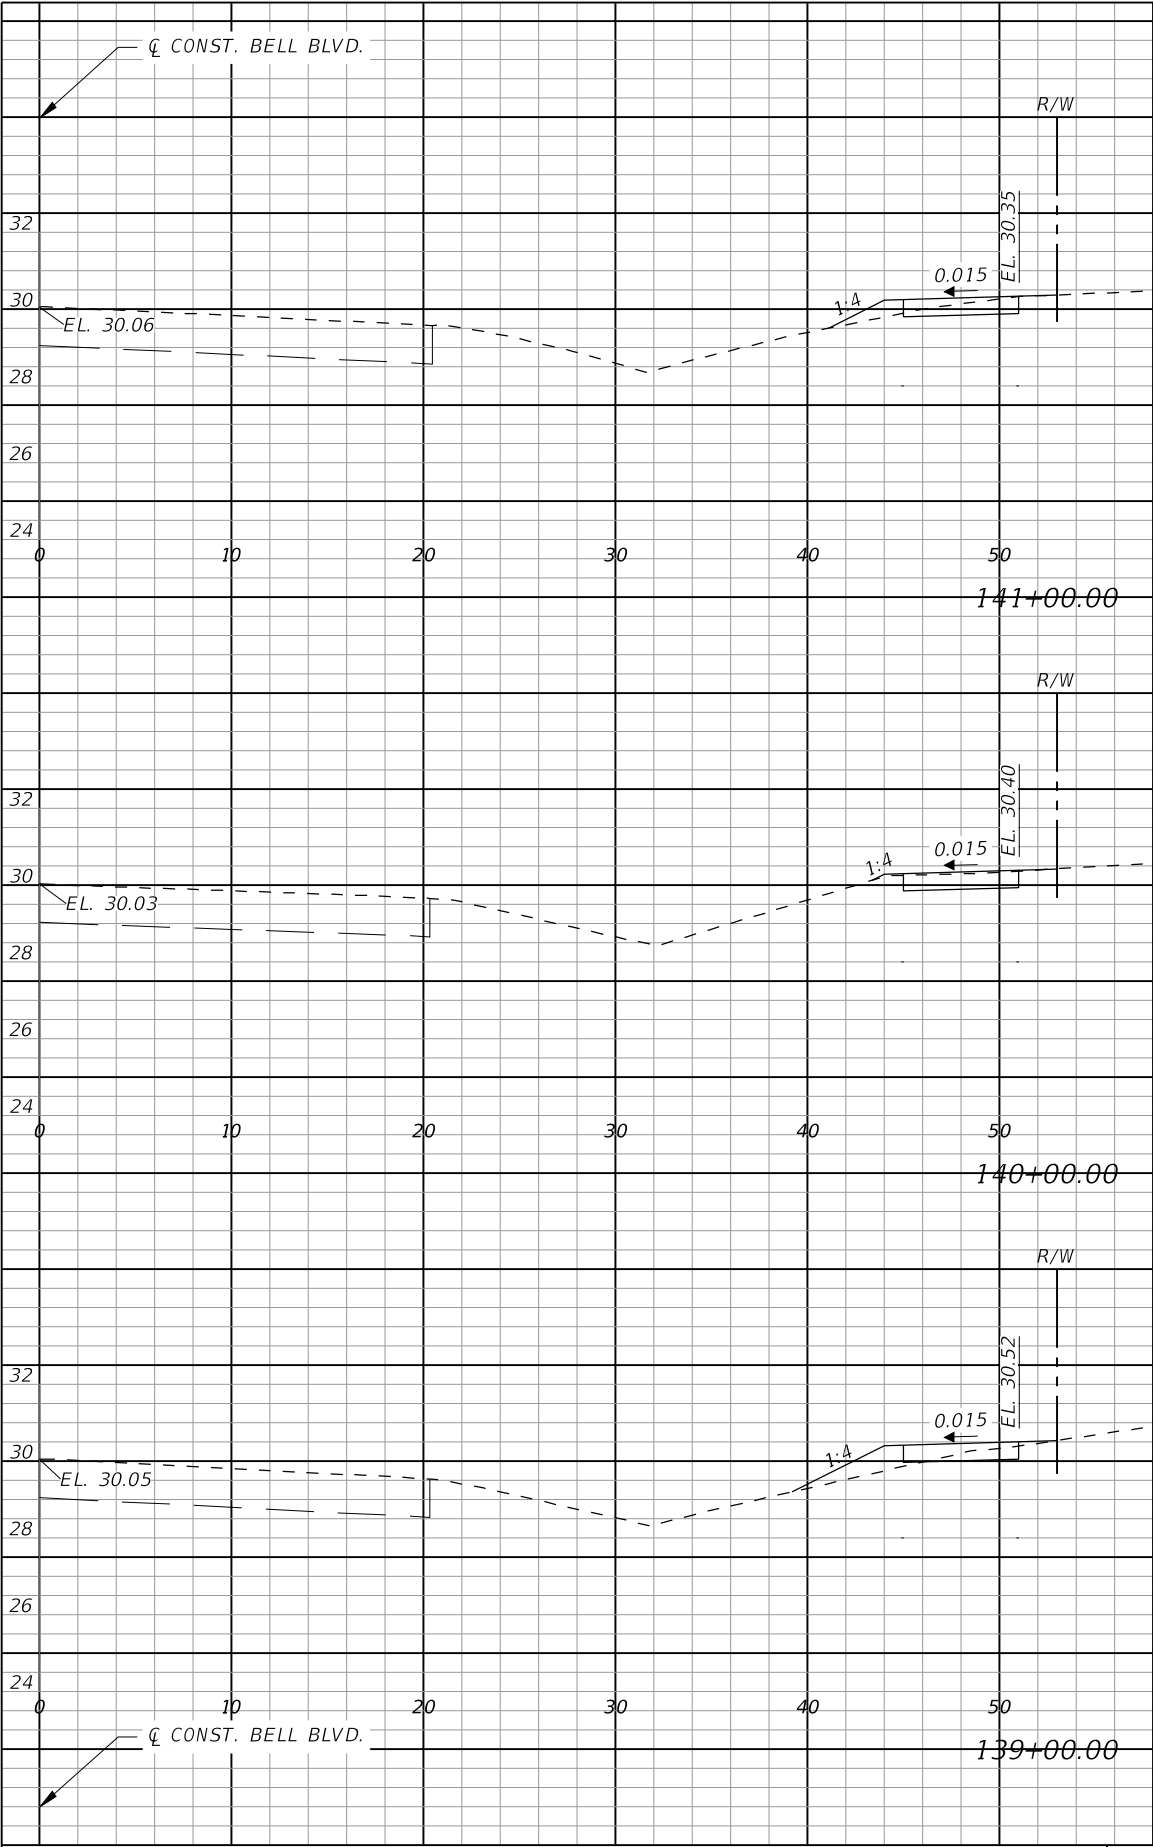
**LEE COUNTY**

ROAD NO.	COUNTY PROJECT NO.
BELL BLVD. SR 82 TO SUNRISE BLVD. SIDEWALK	6002


**CROSS SECTIONS  
BELL BOULEVARD (RT.)**

SHEET NO.  
**98**






Regular Exc.		Embankment	
AREA	VOL.	AREA	VOL.
SF	CY	SF	CY
2	5	1	5
8		4	
2		1	
6		6	
1		2	

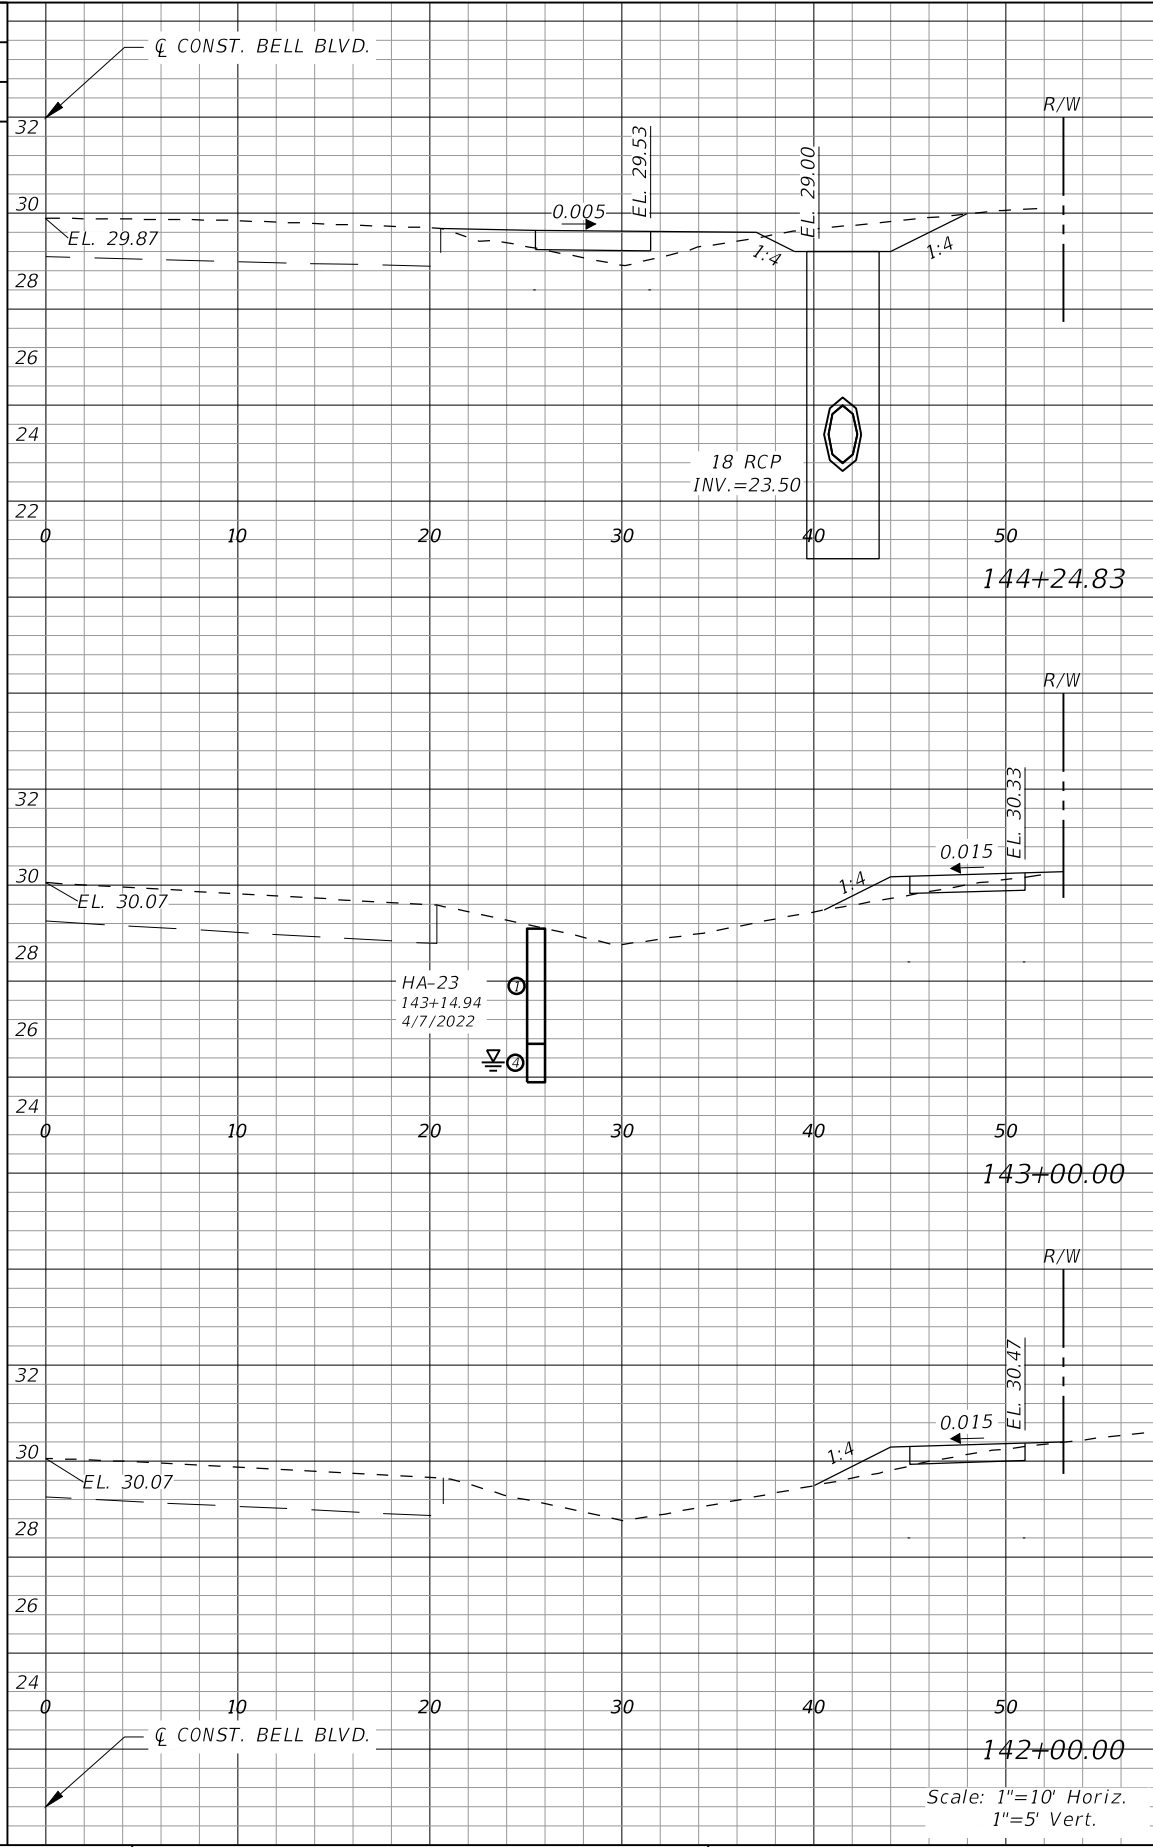

Regular Exc.		Embankment	
AREA	VOL.	AREA	VOL.
SF	CY	SF	CY
5	8	5	7
1	15	2	15
1	4	2	6

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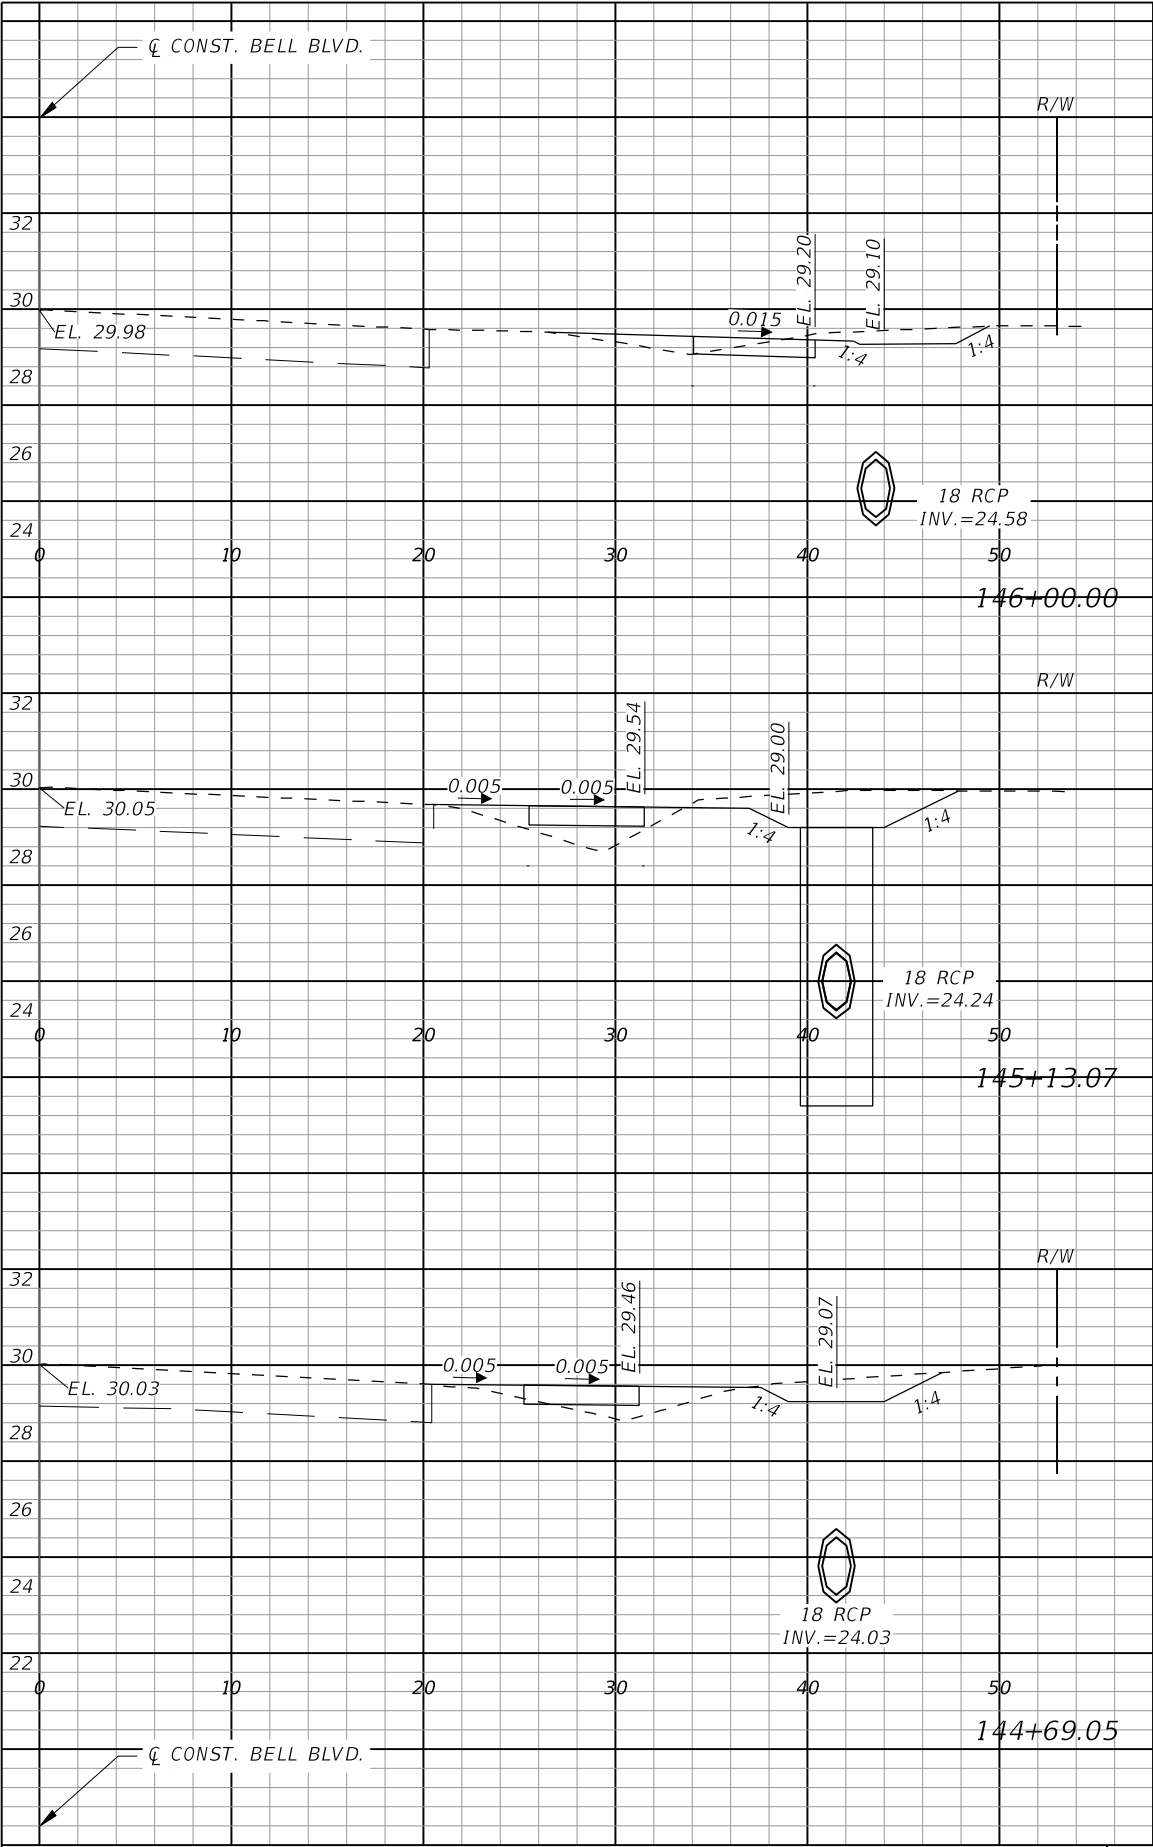
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3800 Via Del Rey  
Bonita Springs, Florida 34134  
Phone: 239.947.1144  
R. DANIEL FLYNN, P.E. NO. 76205

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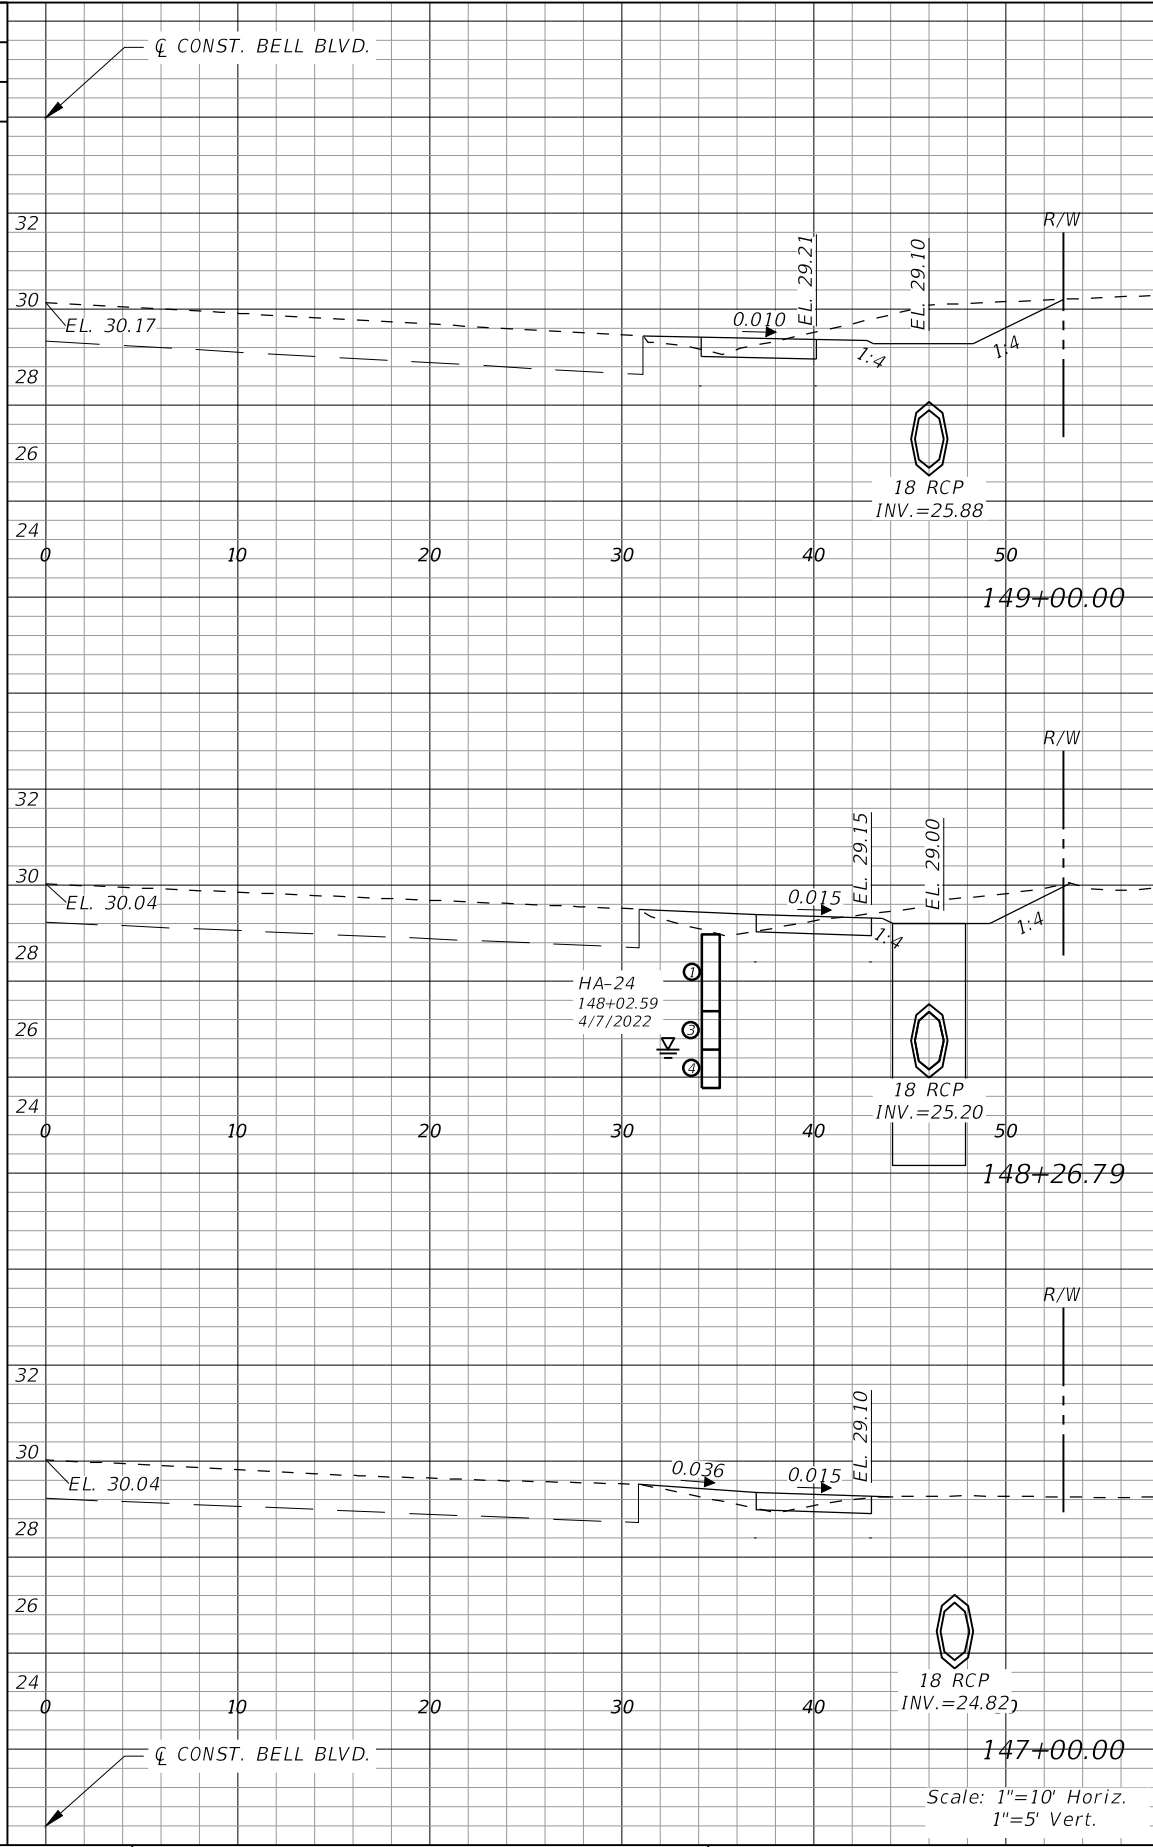
ROAD NO.	COUNTY PROJECT NO.
BELL BLVD. SR 82 TO SUNRISE BLVD. SIDEWALK	6002

**CROSS SECTIONS  
BELL BOULEVARD (RT.)**

SHEET NO.
99




Regular		Exc.	Embankment	
AREA	VOL.		AREA	VOL.
SF	CY		SF	CY
5	11		2	6
21			10	
9			4	
10			7	
4			4	



Regular		Exc.	Embankment	
AREA	VOL.		AREA	VOL.
SF	CY		SF	CY
11	44		1	1
23			4	
6			2	
17			9	
1			1	

REVISIONS			
DATE	DESCRIPTION	DATE	DESCRIPTION



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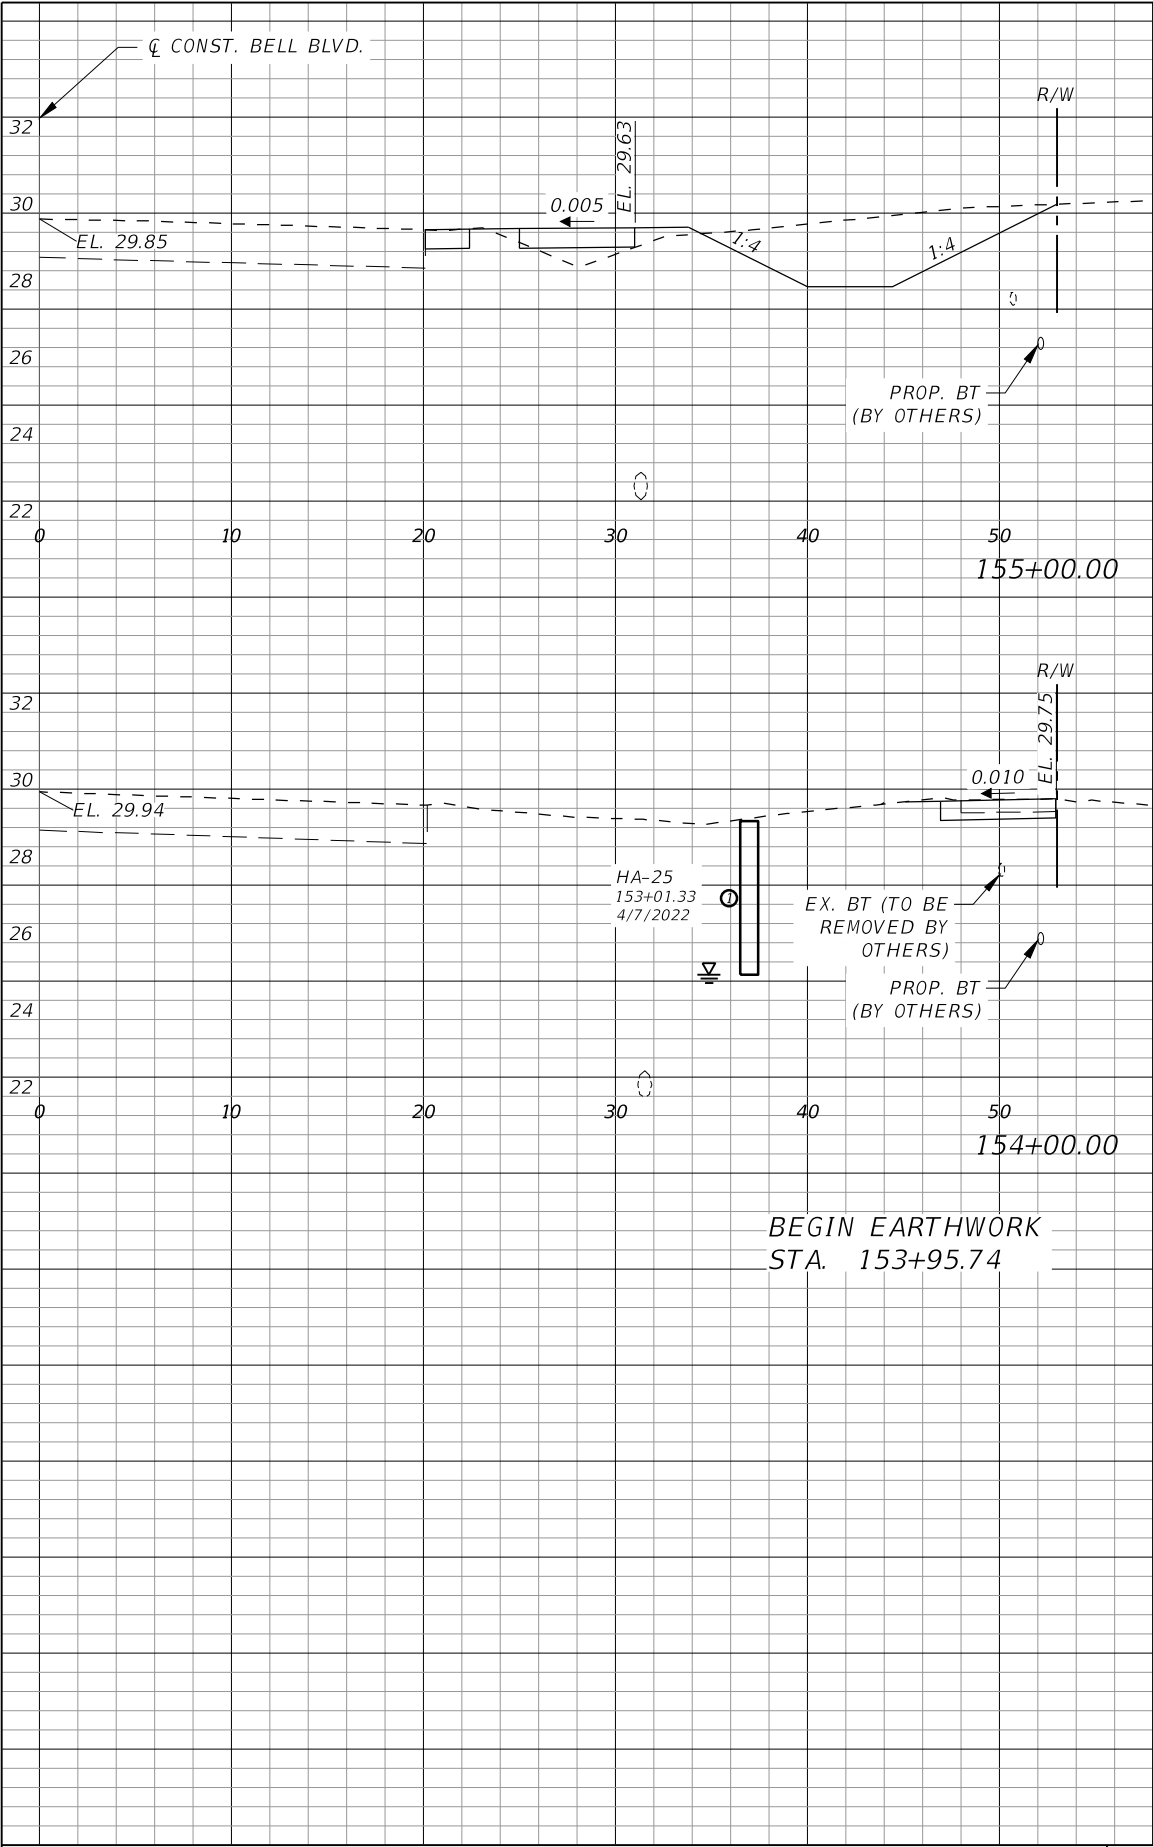
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Phone: 239.947.1144  
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ROAD NO.	COUNTY PROJECT NO.
BELL BLVD. SR 82 TO SUNRISE BLVD. SIDEWALK	6002


**CROSS SECTIONS  
BELL BOULEVARD (RT.)**

SHEET  
NO.  
**100**






Regular		Exc.	Embankment	
AREA	VOL.		AREA	VOL.
SF	CY		SF	CY
20	73		3	11
40			7	
1			1	
1			1	
0			0	

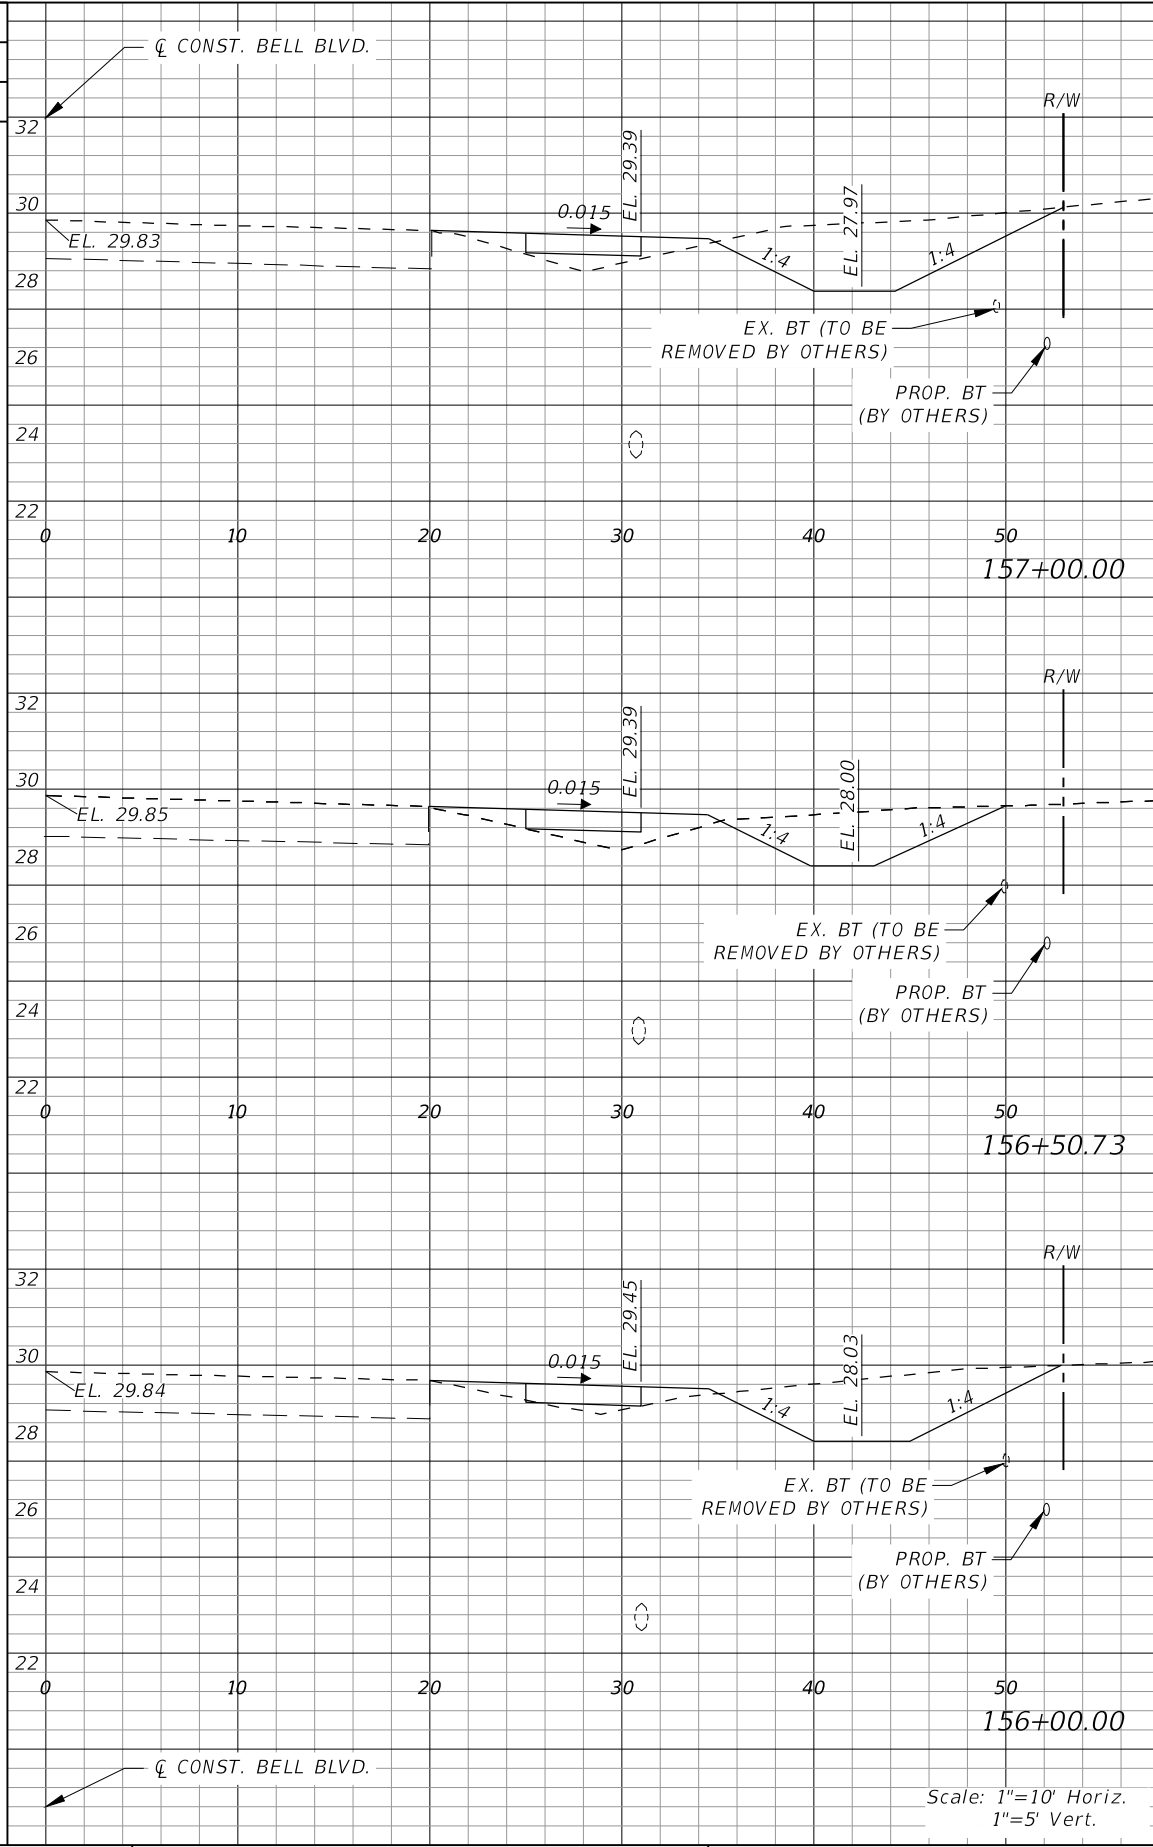

Regular		Exc.	Embankment	
AREA	VOL.		AREA	VOL.
SF	CY		SF	CY
20	78		4	20
5			8	
13			5	
30			7	
19			3	

REVISIONS			
DATE	DESCRIPTION	DATE	DESCRIPTION




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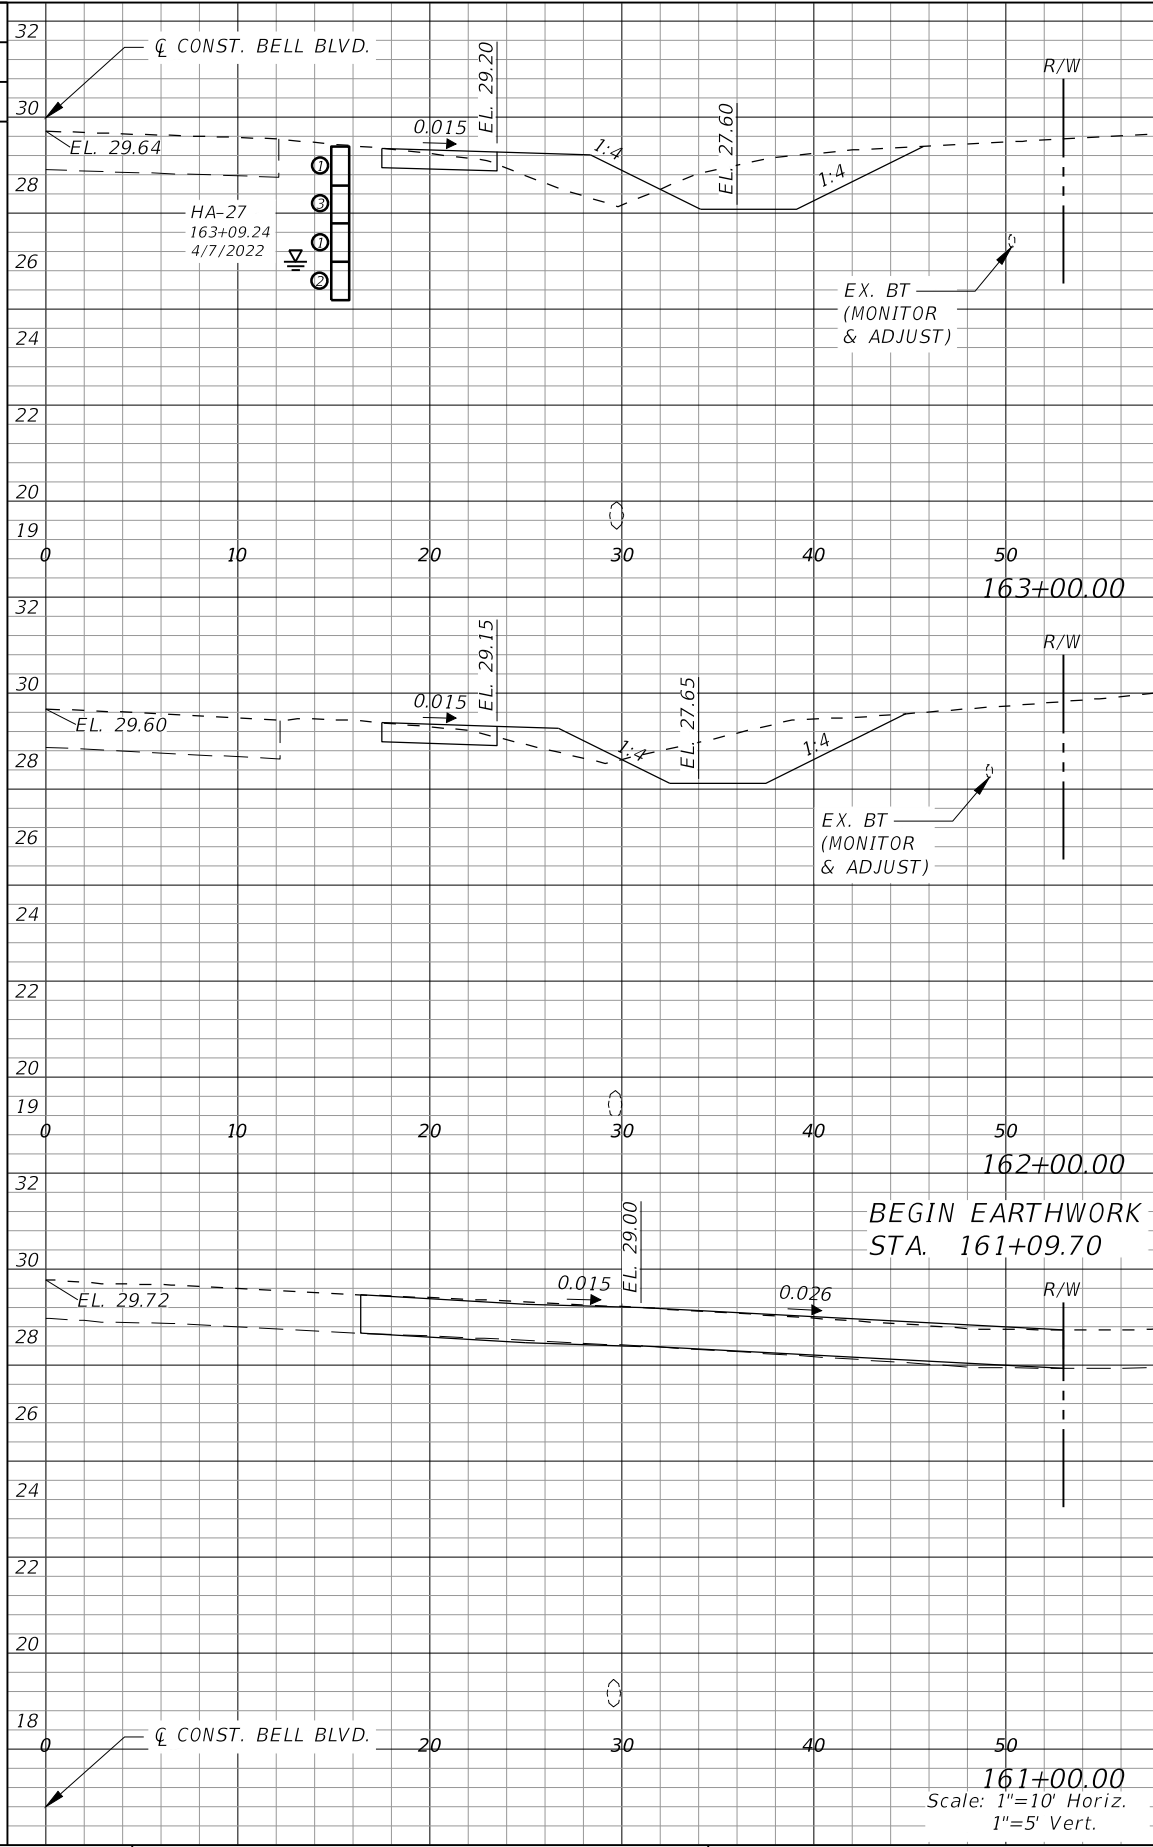
LEE COUNTY	
ROAD NO.	COUNTY PROJECT NO.
BELL BLVD. SR 82 TO SUNRISE BLVD. SIDEWALK	6002

**CROSS SECTIONS  
BELL BOULEVARD (RT.)**

SHEET  
NO.  
**102**




Regular Exc.		Embankment	
AREA	VOL.	AREA	VOL.
SF	CY	SF	CY
0	30	0	4
17	2		
49	9		
18	4		
58	16		
18	6		

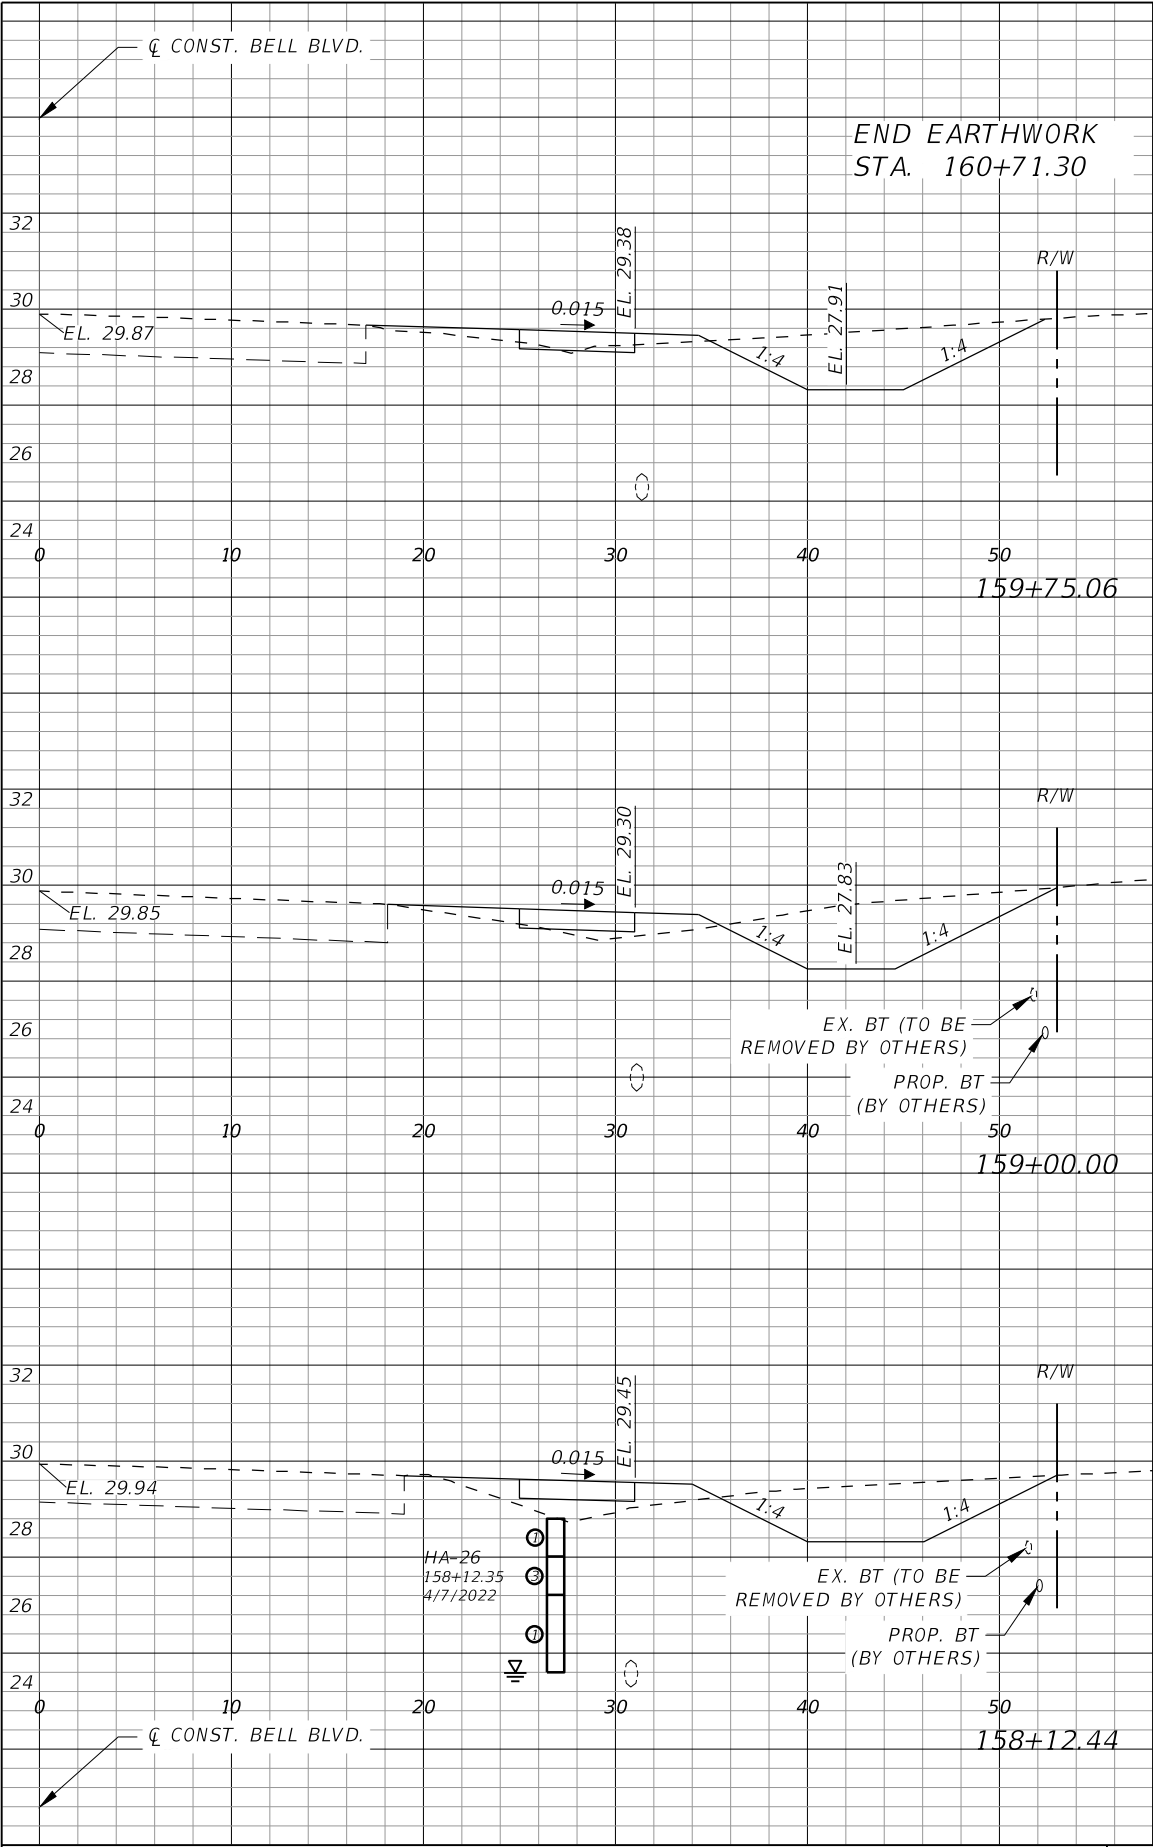

Regular Exc.		Embankment	
AREA	VOL.	AREA	VOL.
SF	CY	SF	CY
	25		14
13	6		
48	17		
14	3		
23	5		
0	0		

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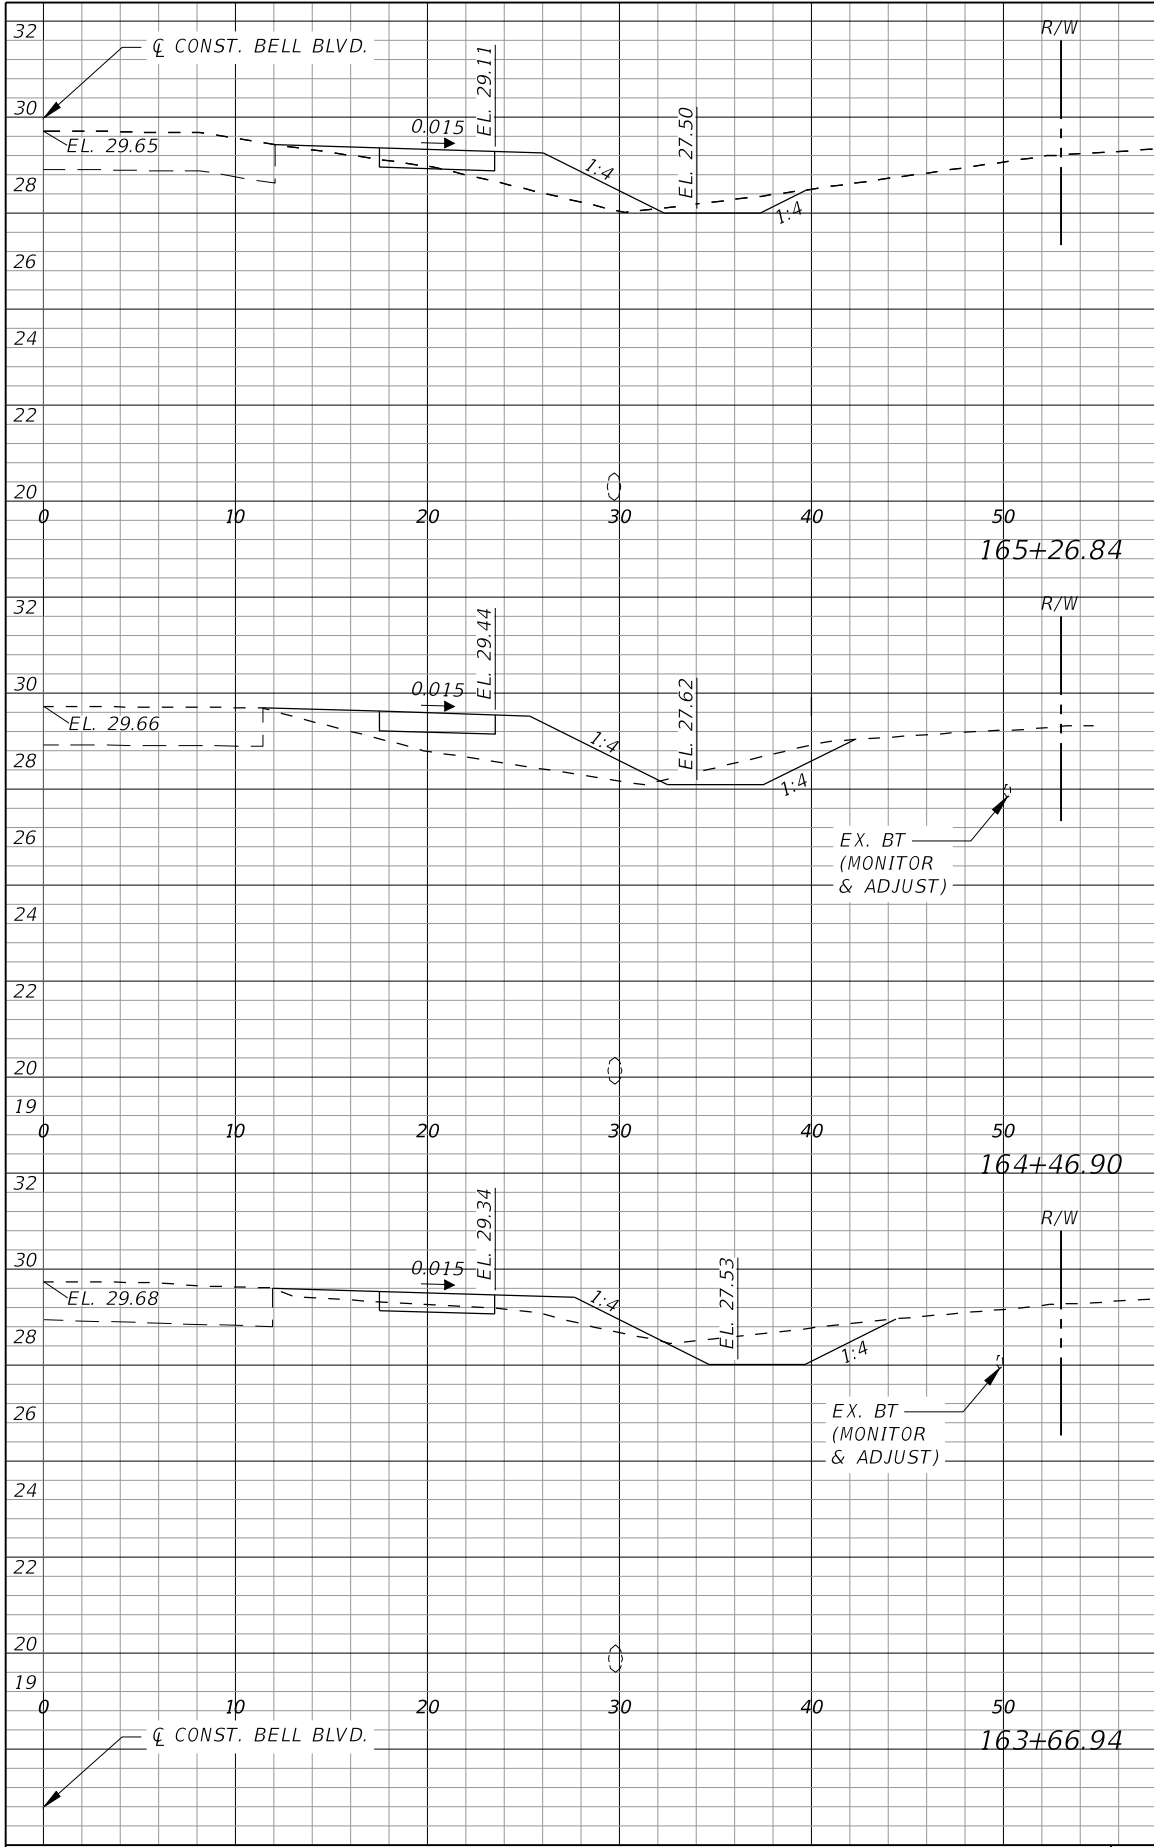
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LEE COUNTY	
ROAD NO.	COUNTY PROJECT NO.
BELL BLVD. SR 82 TO SUNRISE BLVD. SIDEWALK	6002


**CROSS SECTIONS  
BELL BOULEVARD (RT.)**

SHEET NO.  
**103**






Regular		Exc.	Embankment	
AREA	VOL.		AREA	VOL.
SF	CY		SF	CY
2	7		12	
4	10		29	
8	18		26	
	5			

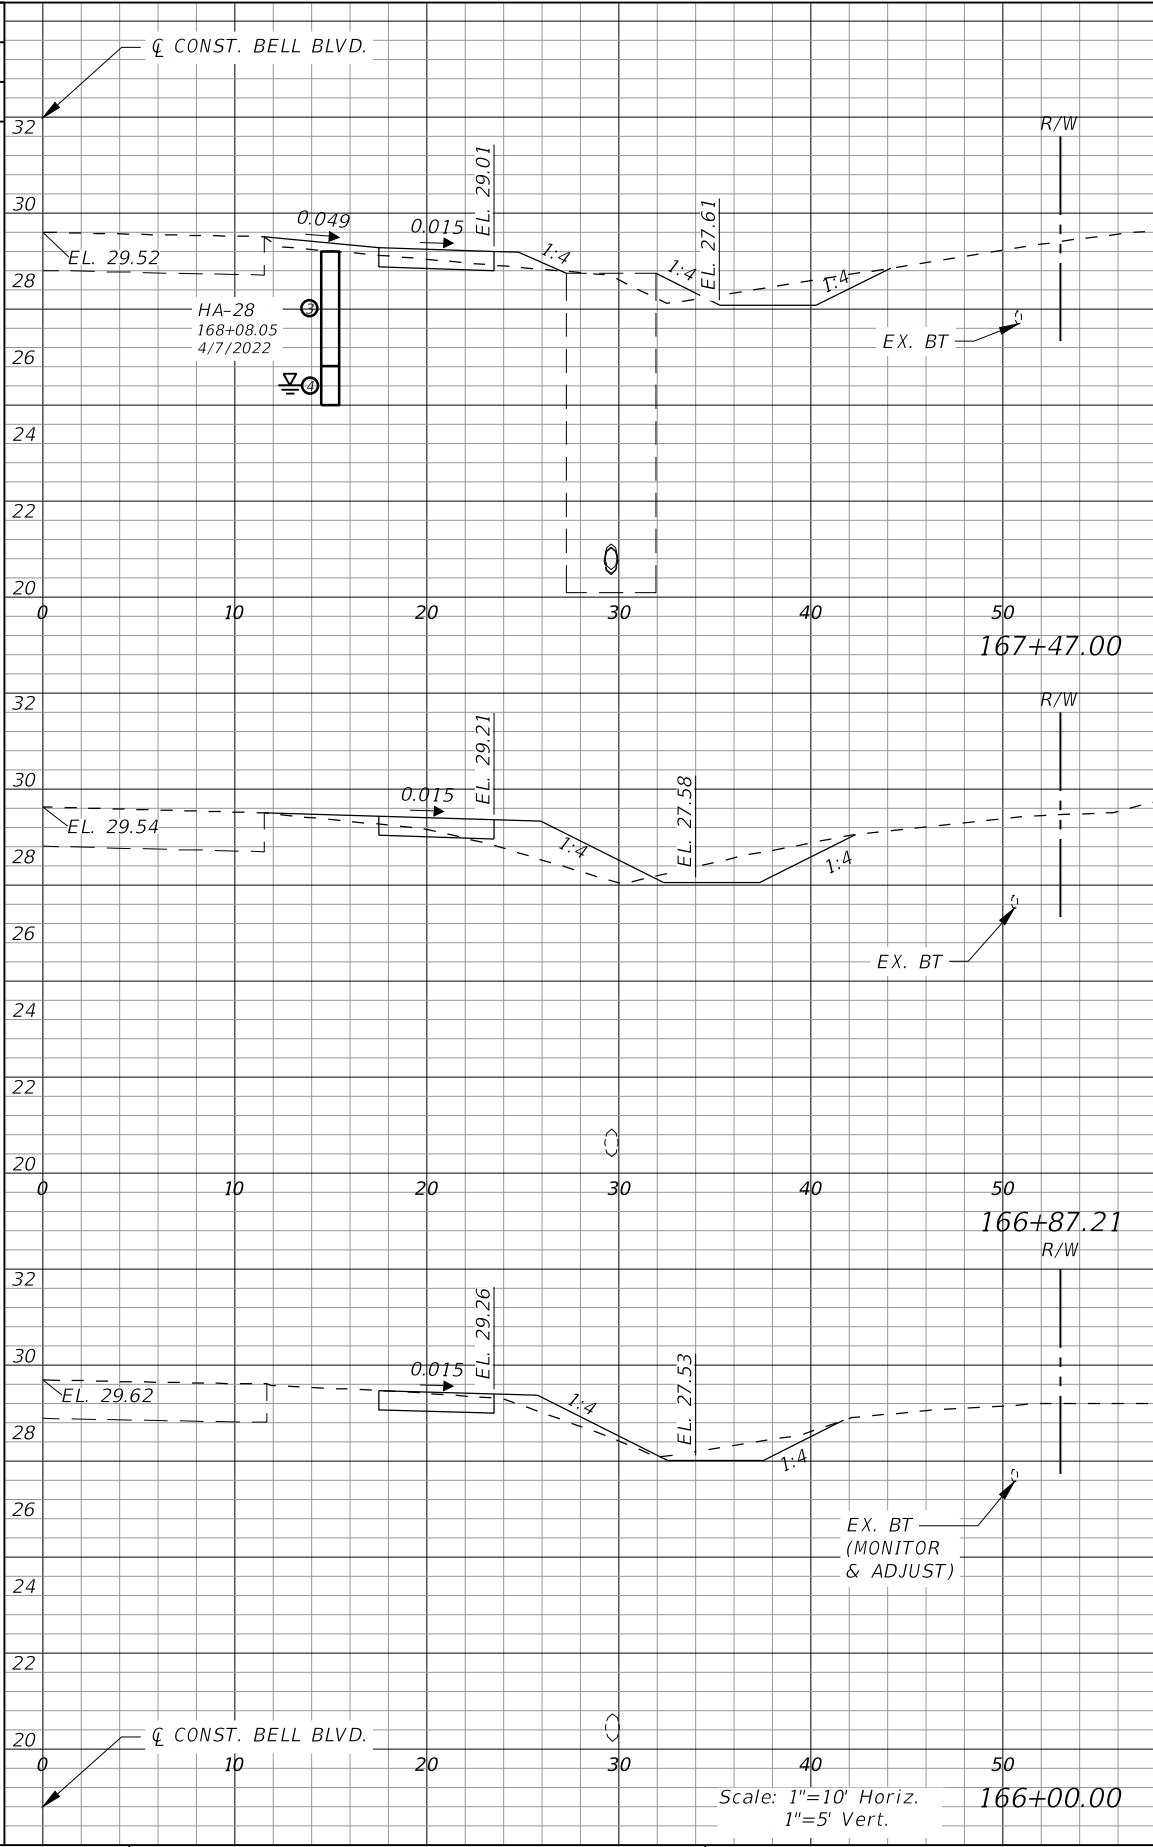

Regular		Exc.	Embankment	
AREA	VOL.		AREA	VOL.
SF	CY		SF	CY
4	4		3	
7	11		10	
3	15		14	
	2			

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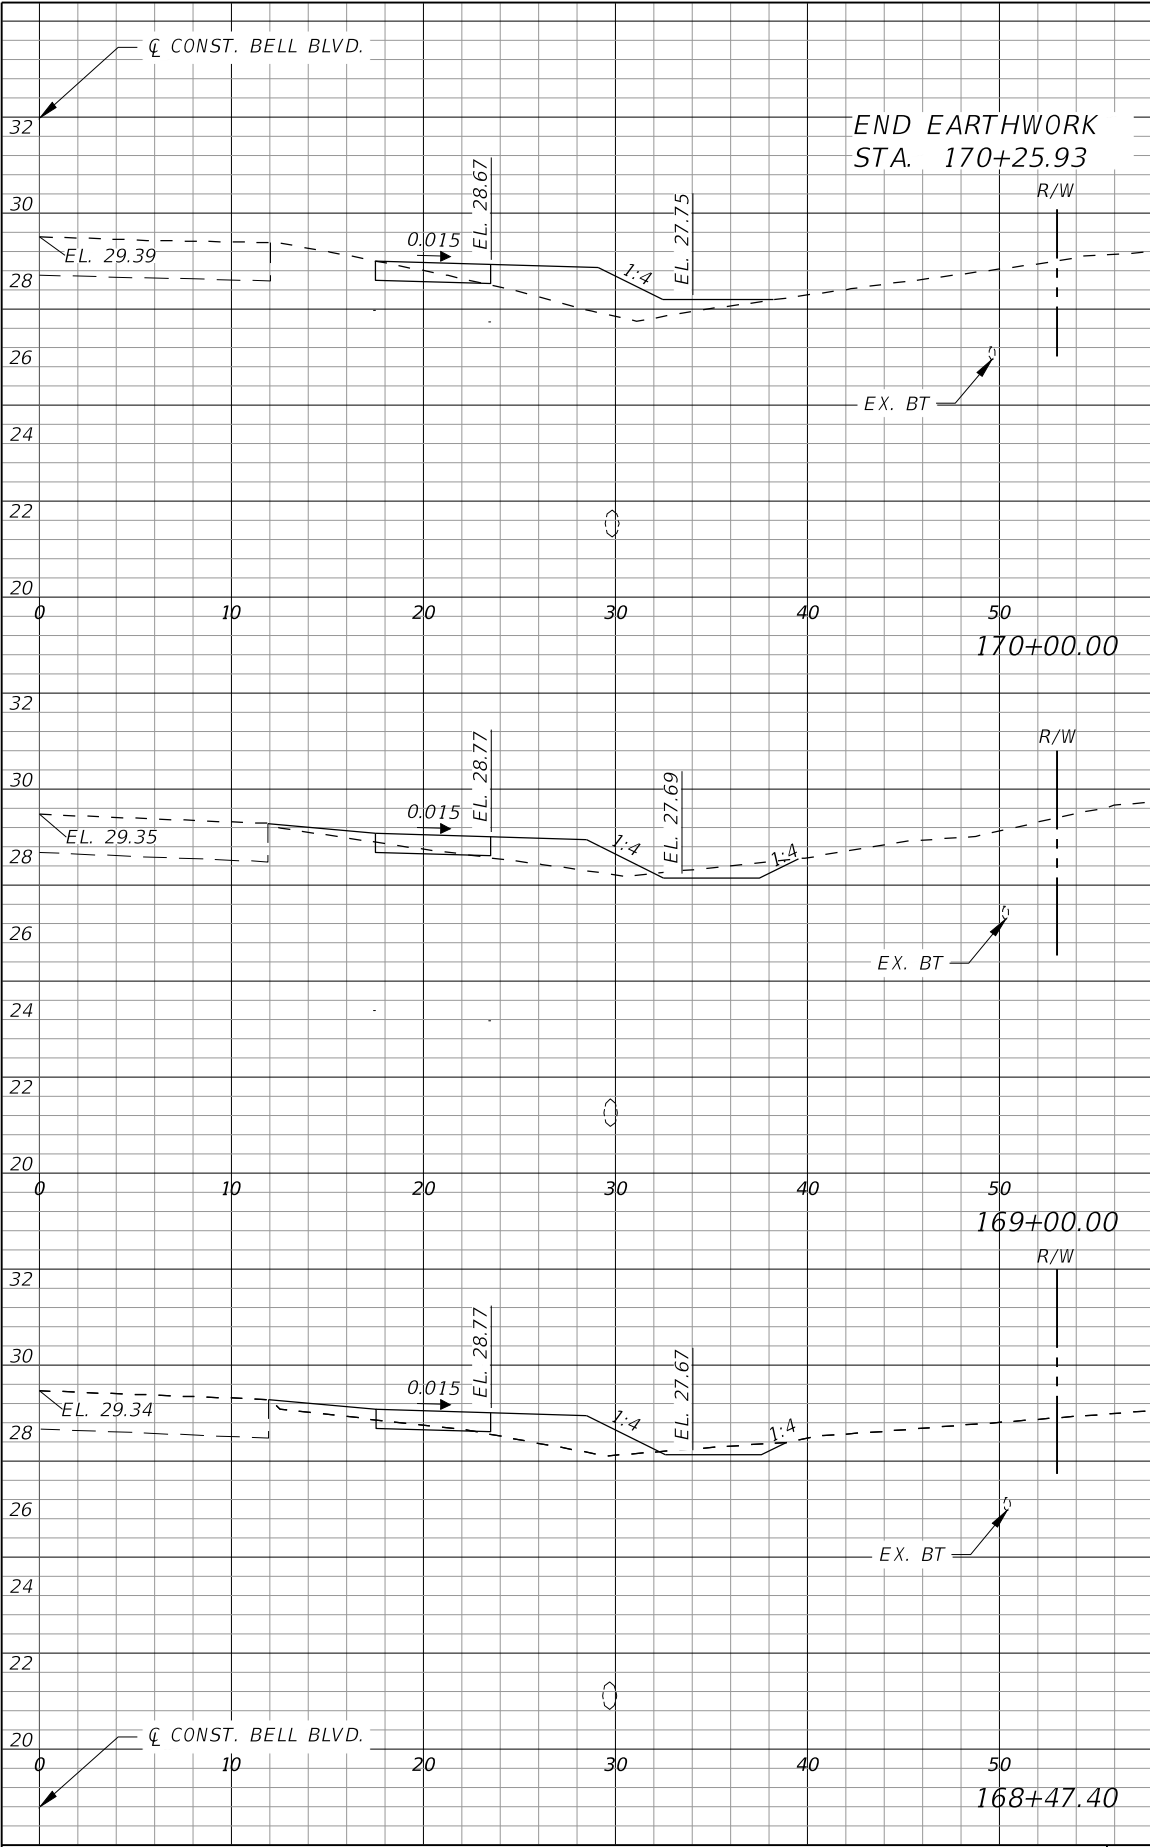
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3800 Via Del Rey  
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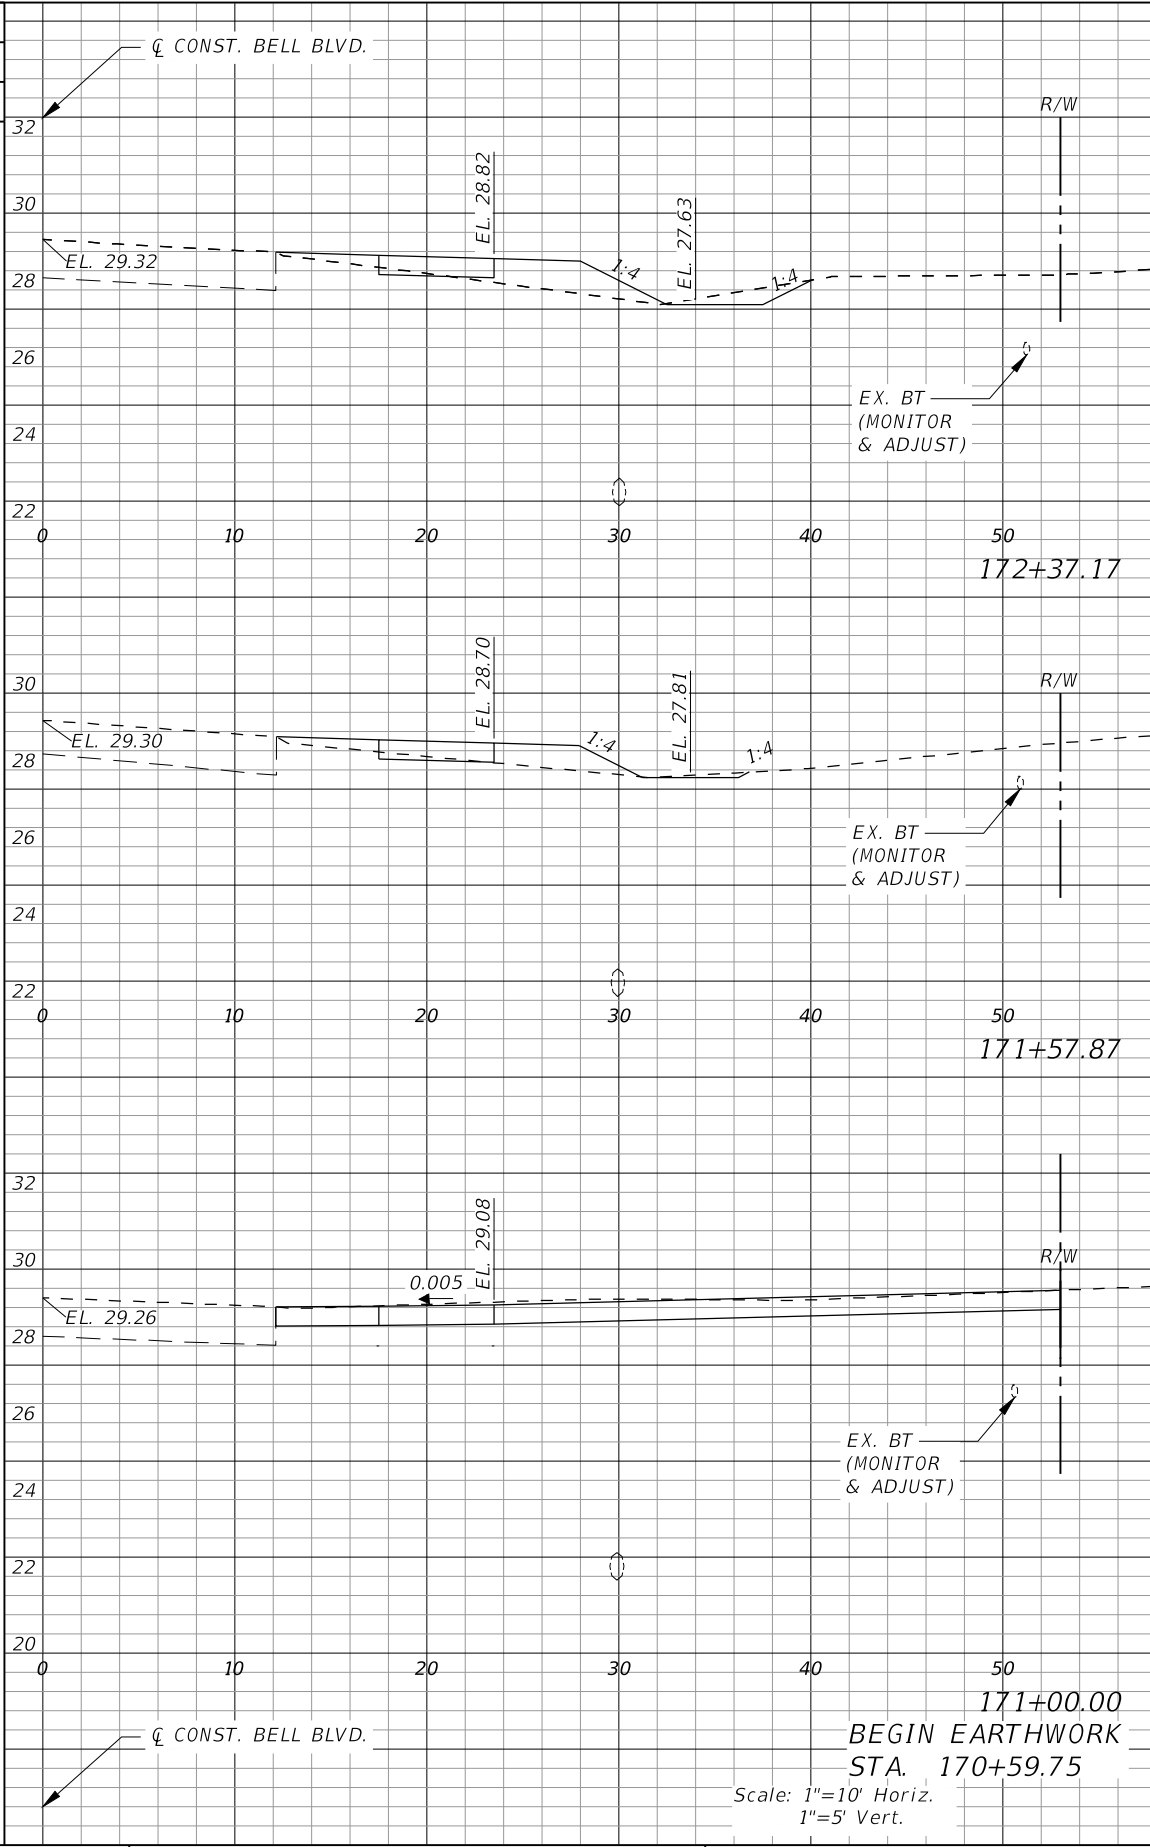
ROAD NO.	COUNTY PROJECT NO.
BELL BLVD. SR 82 TO SUNRISE BLVD. SIDEWALK	6002

**CROSS SECTIONS  
BELL BOULEVARD (RT.)**

SHEET NO.  
**104**




Regular		Exc.	Embankment	
AREA	VOL.		AREA	VOL.
SF	CY		SF	CY
0	1		0	4
1			9	
7			27	
2			6	
4			13	
2			7	



Regular		Exc.	Embankment	
AREA	VOL.		AREA	VOL.
SF	CY		SF	CY
	7			11
2			6	
	5			18
1			6	
	1			6
0			0	
0			0	

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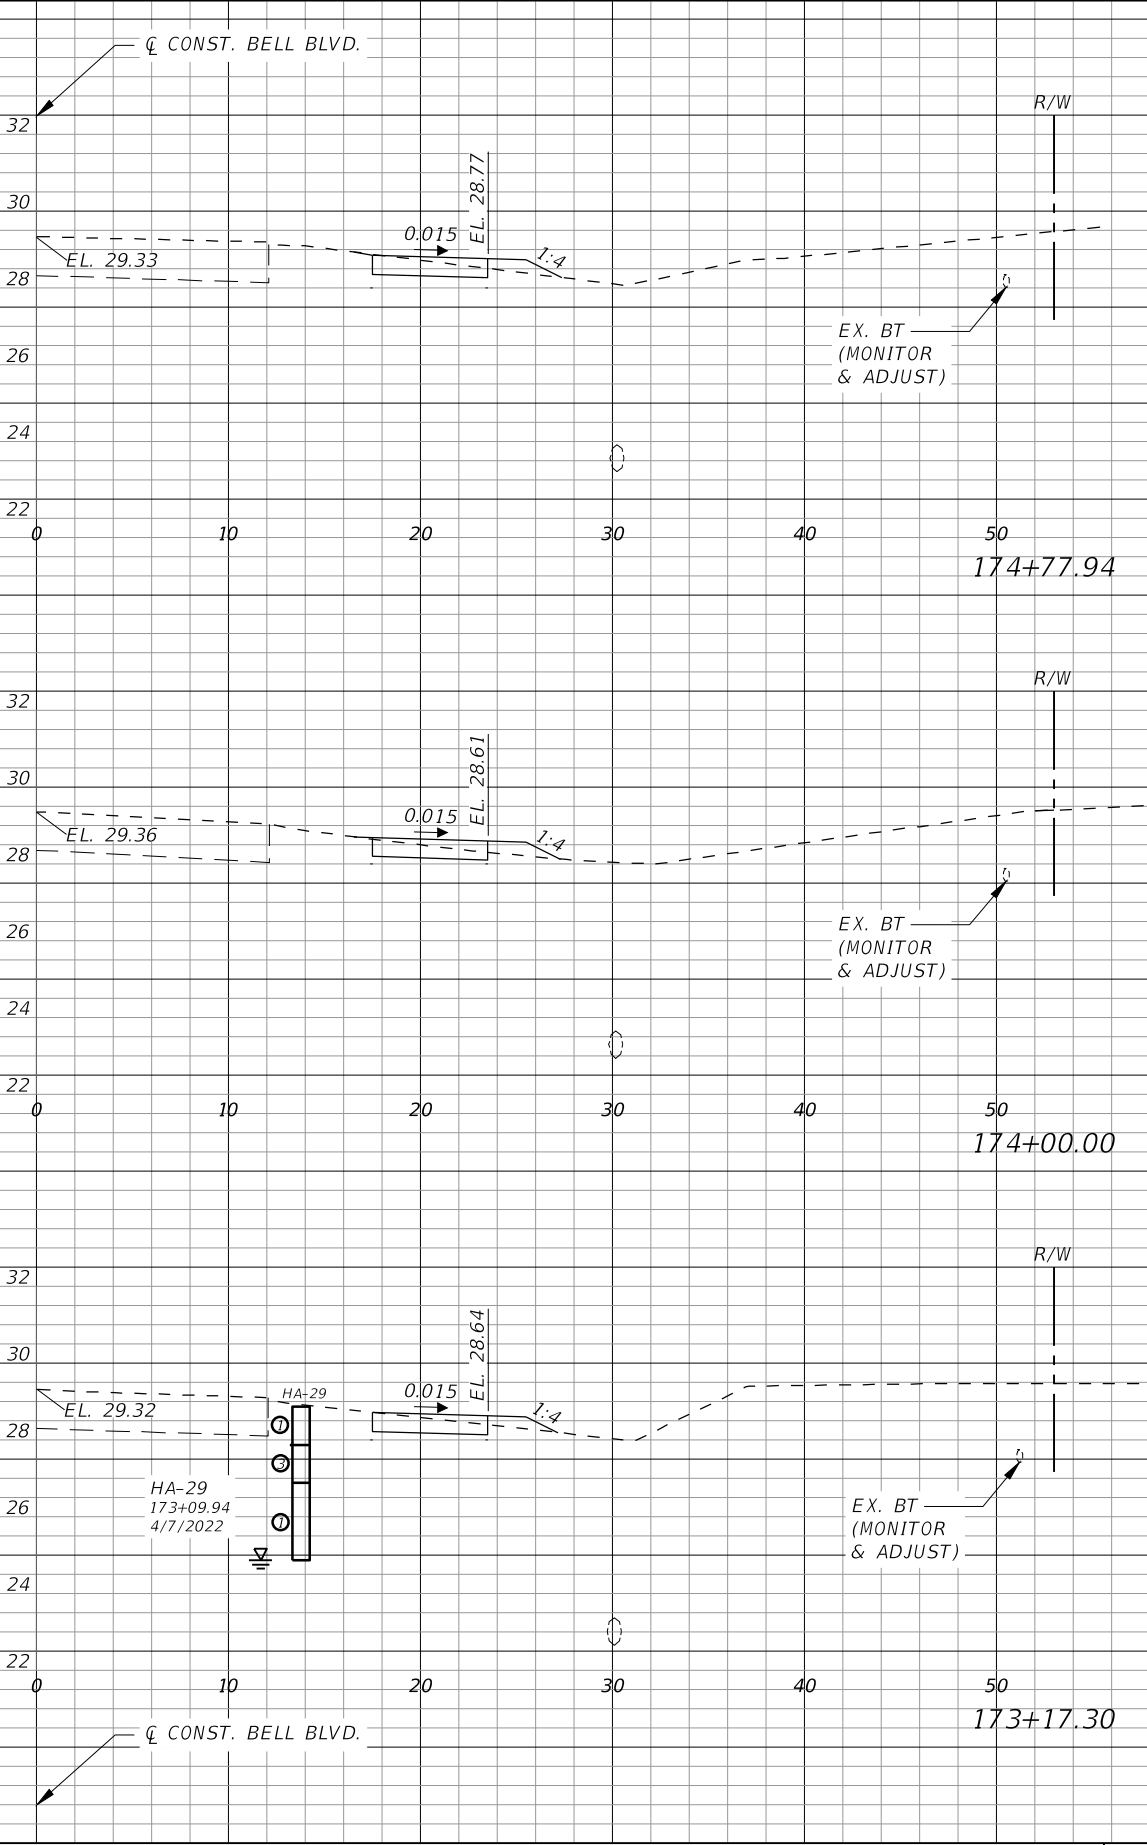
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3800 Via Del Rey  
Bonita Springs, Florida 34134  
Phone: 239.947.1144  
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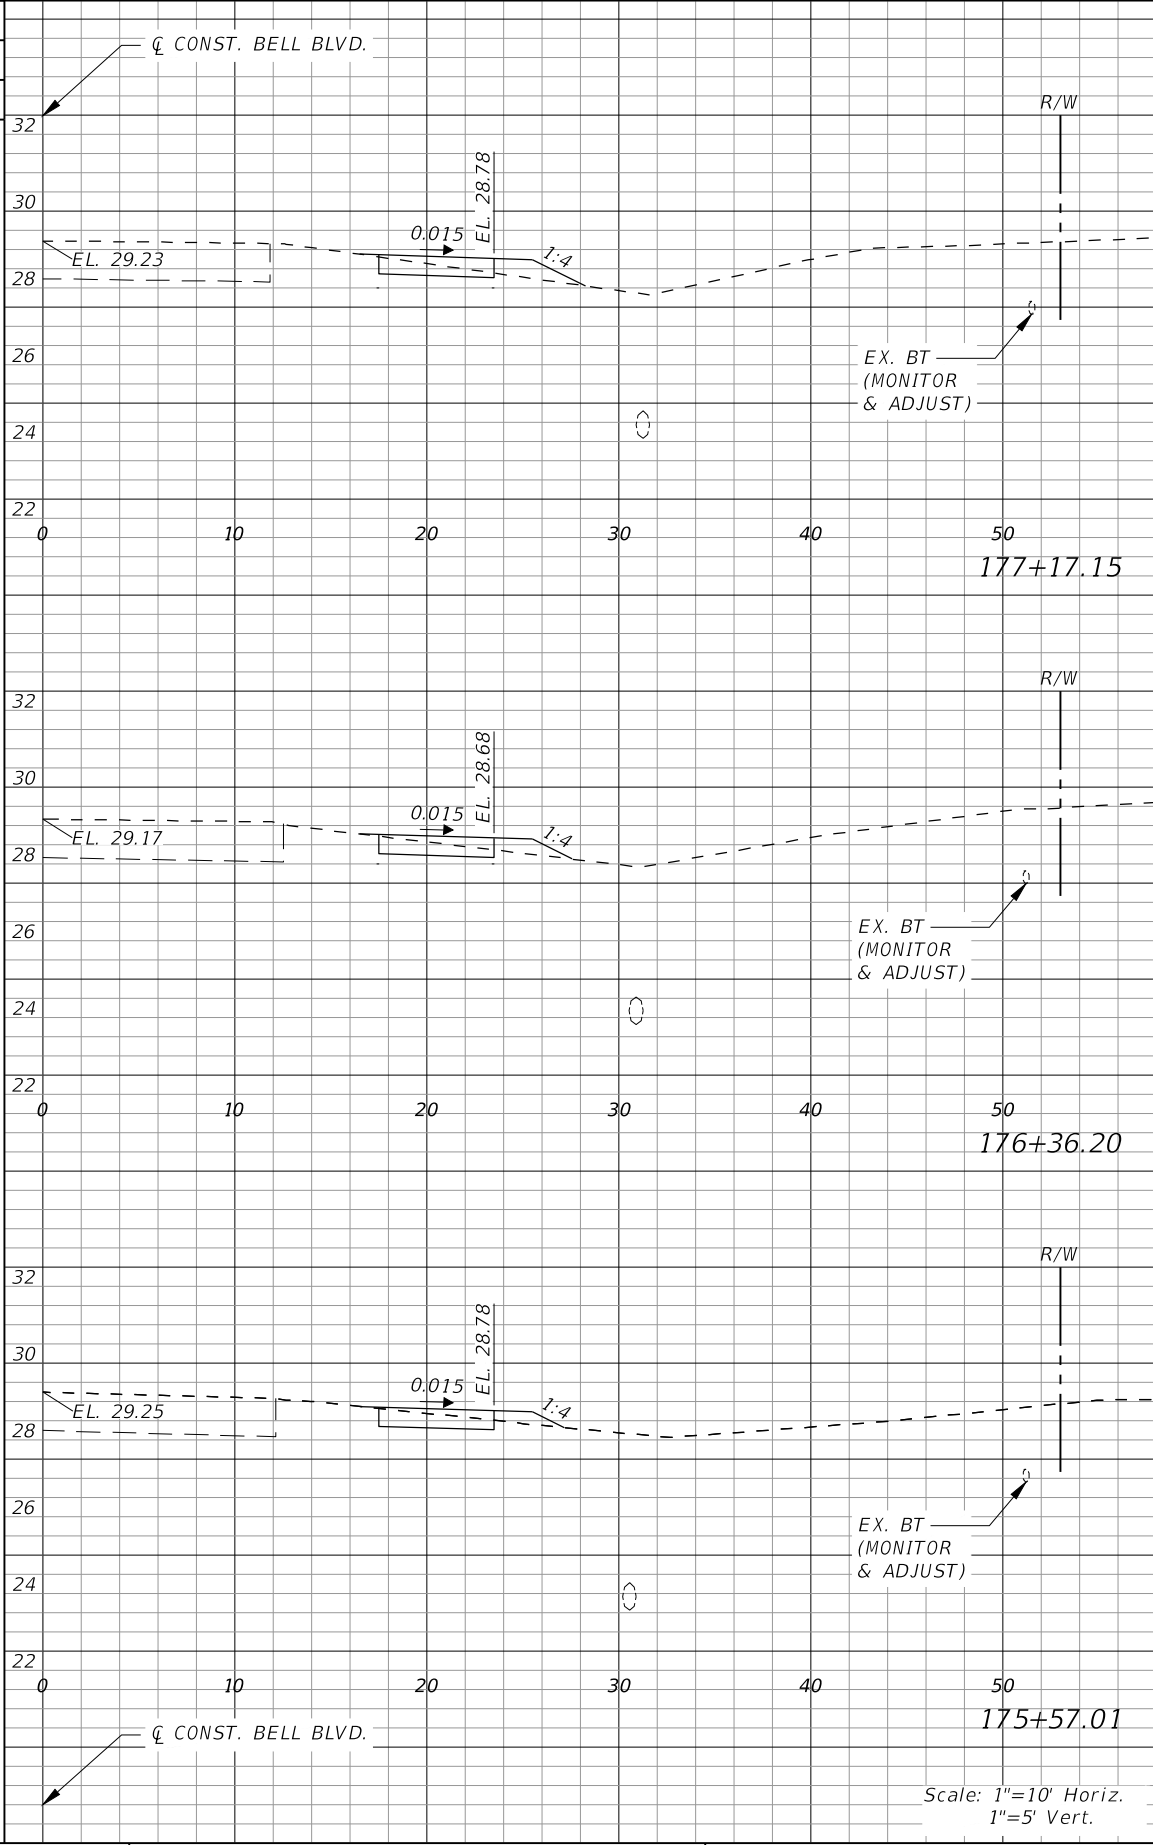
ROAD NO.	COUNTY PROJECT NO.
BELL BLVD. SR 82 TO SUNRISE BLVD. SIDEWALK	6002

**CROSS SECTIONS  
BELL BOULEVARD (RT.)**

SHEET NO.
105



Regular		Exc.	Embankment	
AREA	VOL.		AREA	VOL.
SF	CY		SF	CY
2	7		1	3
6			3	
2			1	
6			3	
2			1	



Regular		Exc.	Embankment	
AREA	VOL.		AREA	VOL.
SF	CY		SF	CY
2	5		2	6
5			4	
2			1	
6			3	
2			1	

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DATE	DESCRIPTION	DATE	DESCRIPTION



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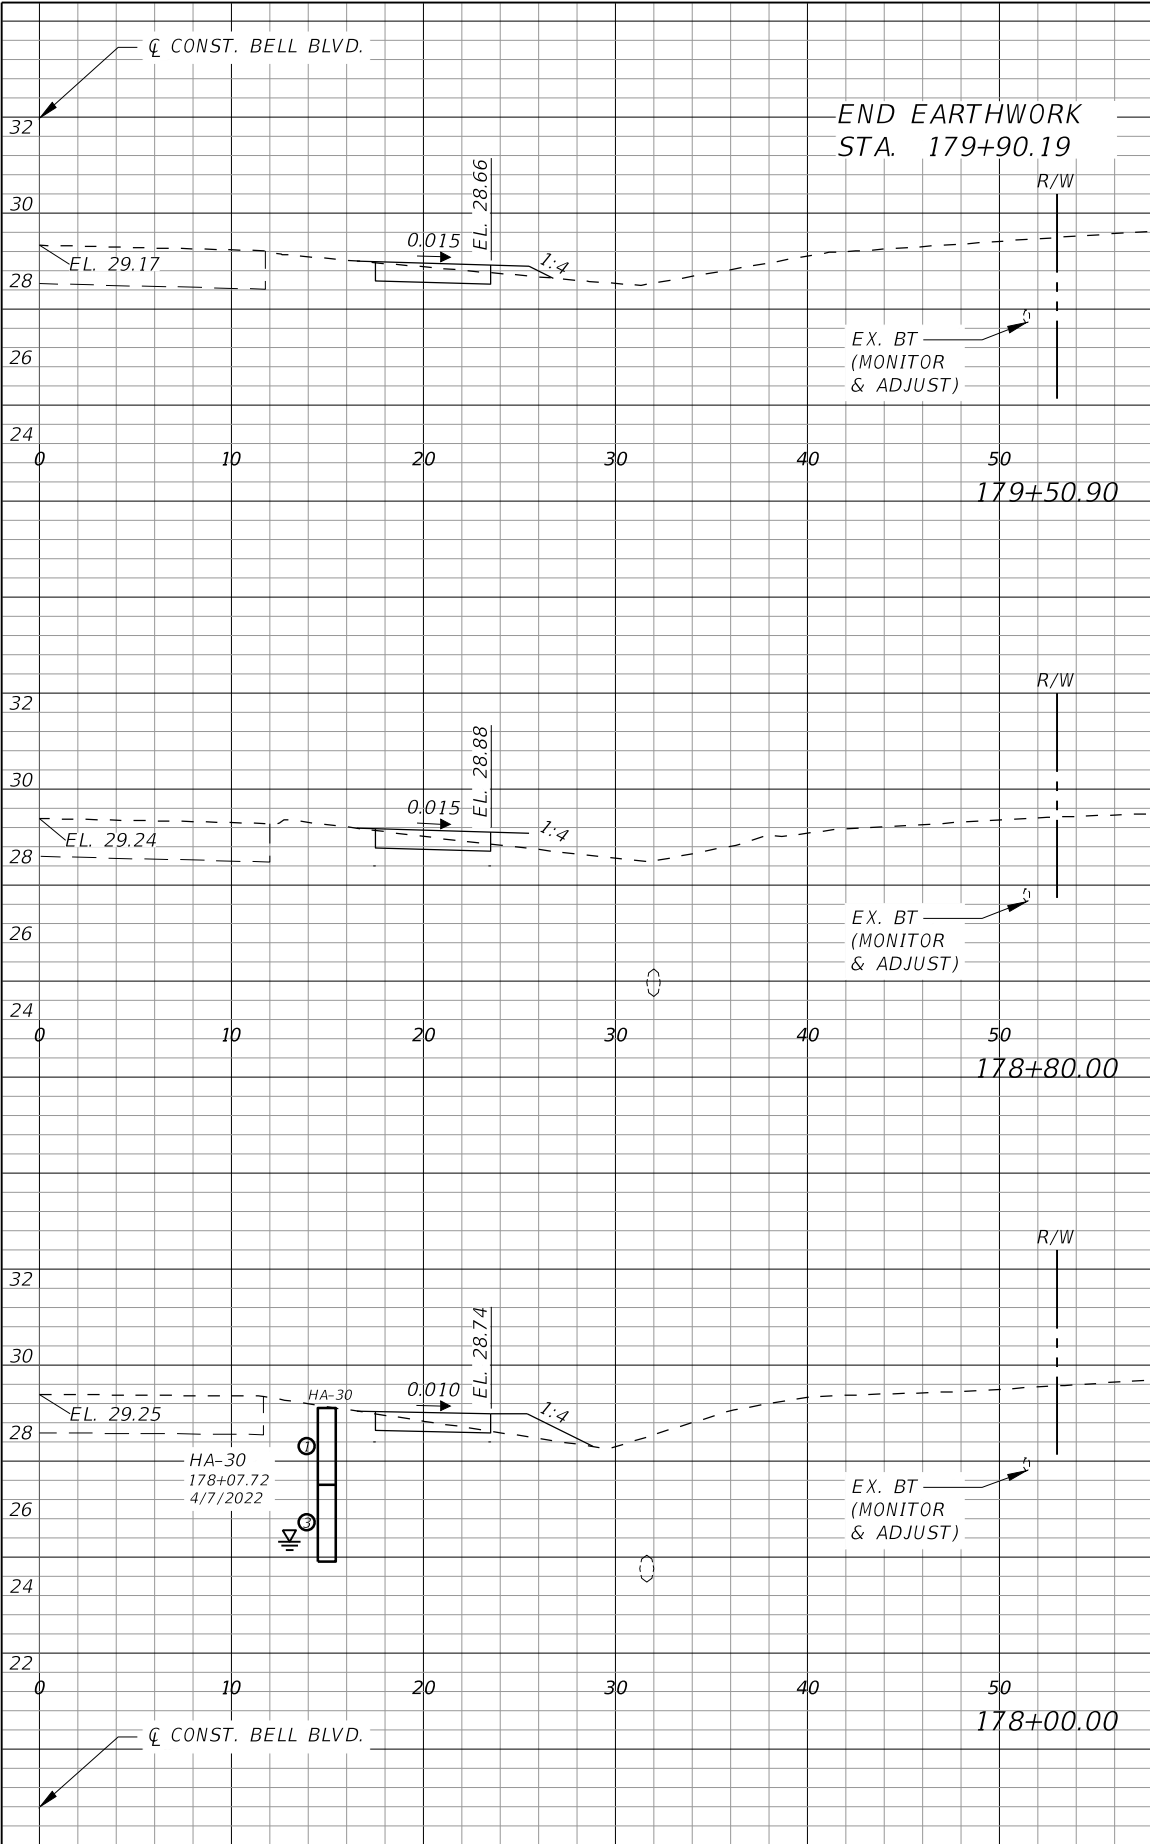
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3800 Via Del Rey  
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Phone: 239.947.1144  
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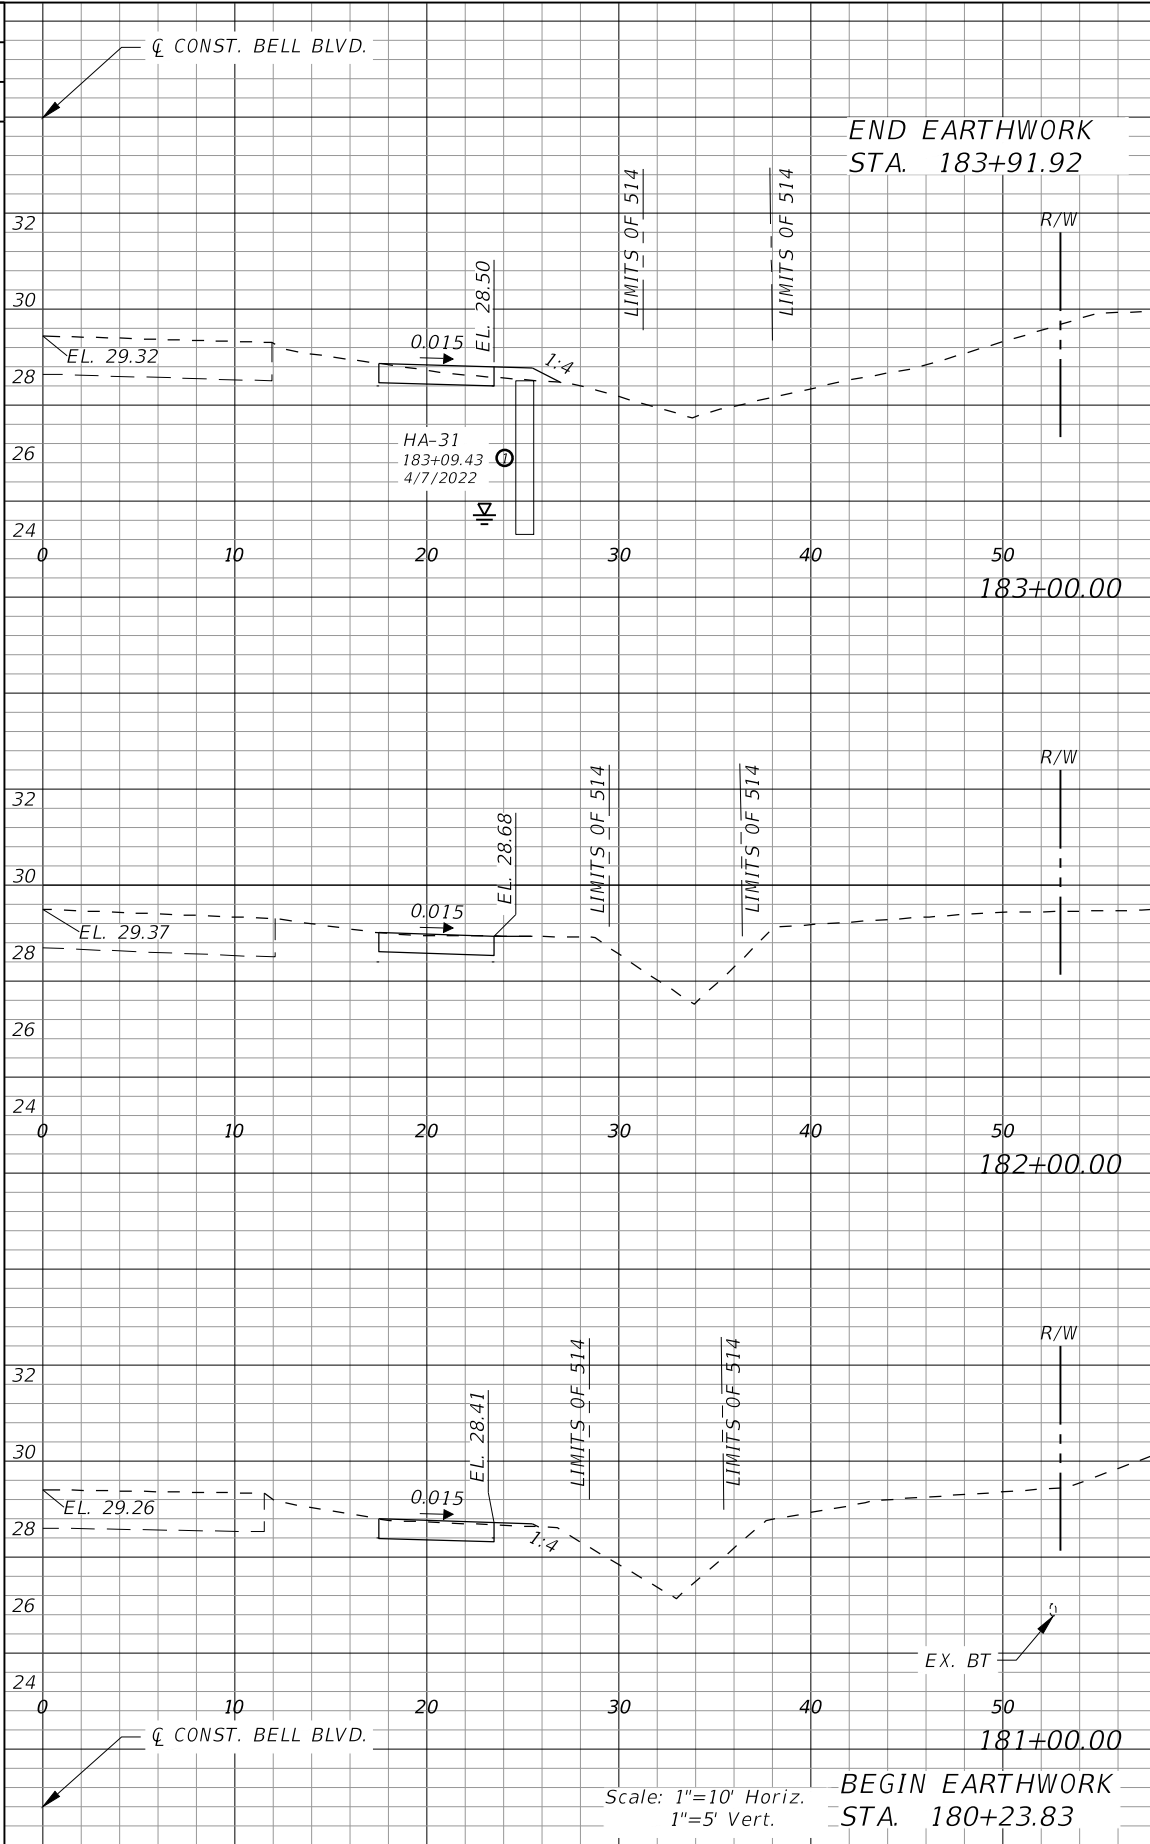
ROAD NO.	COUNTY PROJECT NO.
BELL BLVD. SR 82 TO SUNRISE BLVD. SIDEWALK	6002

**CROSS SECTIONS  
BELL BOULEVARD (RT.)**

SHEET NO.  
**106**




Regular		Exc.	Embankment	
AREA	VOL.		AREA	VOL.
SF	CY		SF	CY
0	2		0	0
2			1	
6			3	
2			1	
6			3	
1			2	



Regular		Exc.	Embankment	
AREA	VOL.		AREA	VOL.
SF	CY		SF	CY
0	4		0	1
2			1	
9			2	
3			0	
10			2	
3			1	
0			0	

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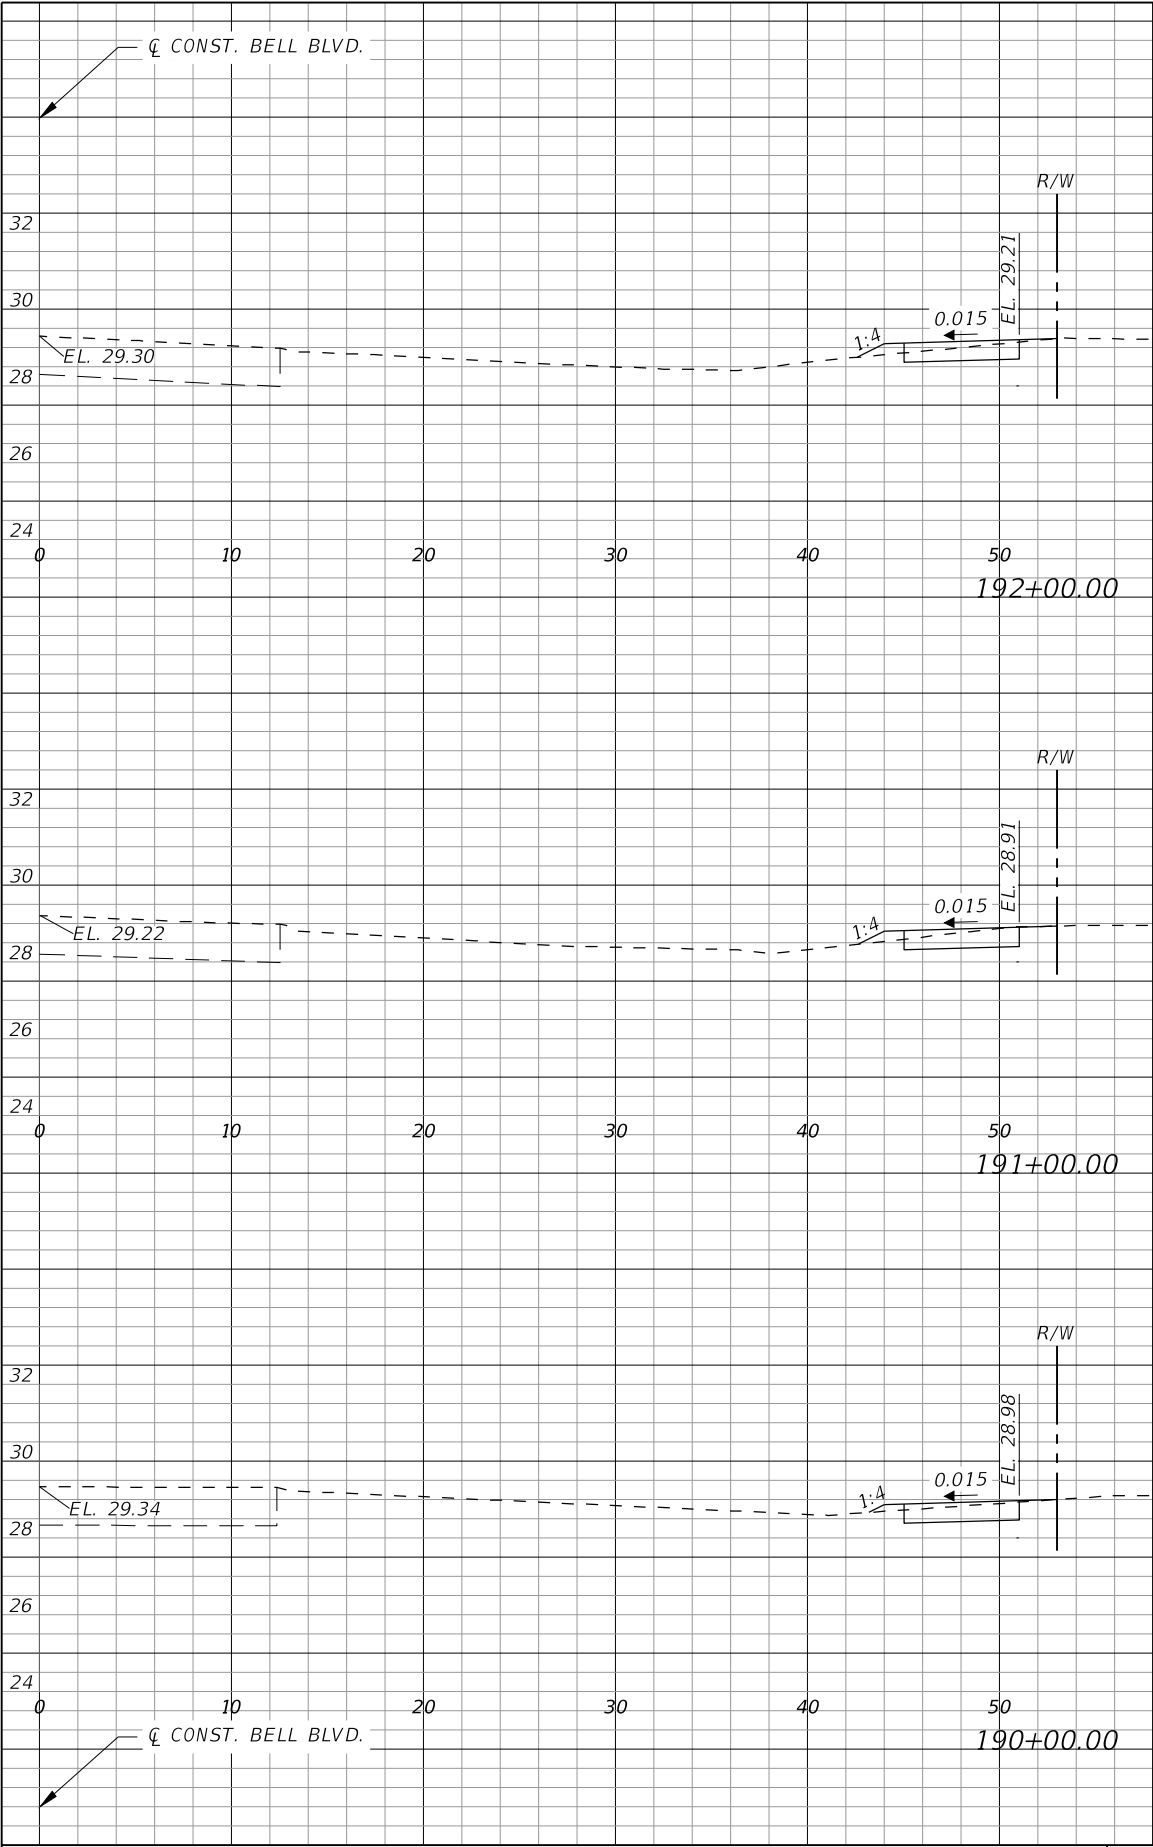
LEE COUNTY	
ROAD NO.	COUNTY PROJECT NO.
BELL BLVD. SR 82 TO SUNRISE BLVD. SIDEWALK	6002

**CROSS SECTIONS**  
**BELL BOULEVARD (RT.)**


SHEET  
NO.  
**107**








Regular		Exc.	Embankment	
AREA	VOL.		AREA	VOL.
SF	CY		SF	CY
2	7		3	
5			8	
2			1	
9			4	
2			1	

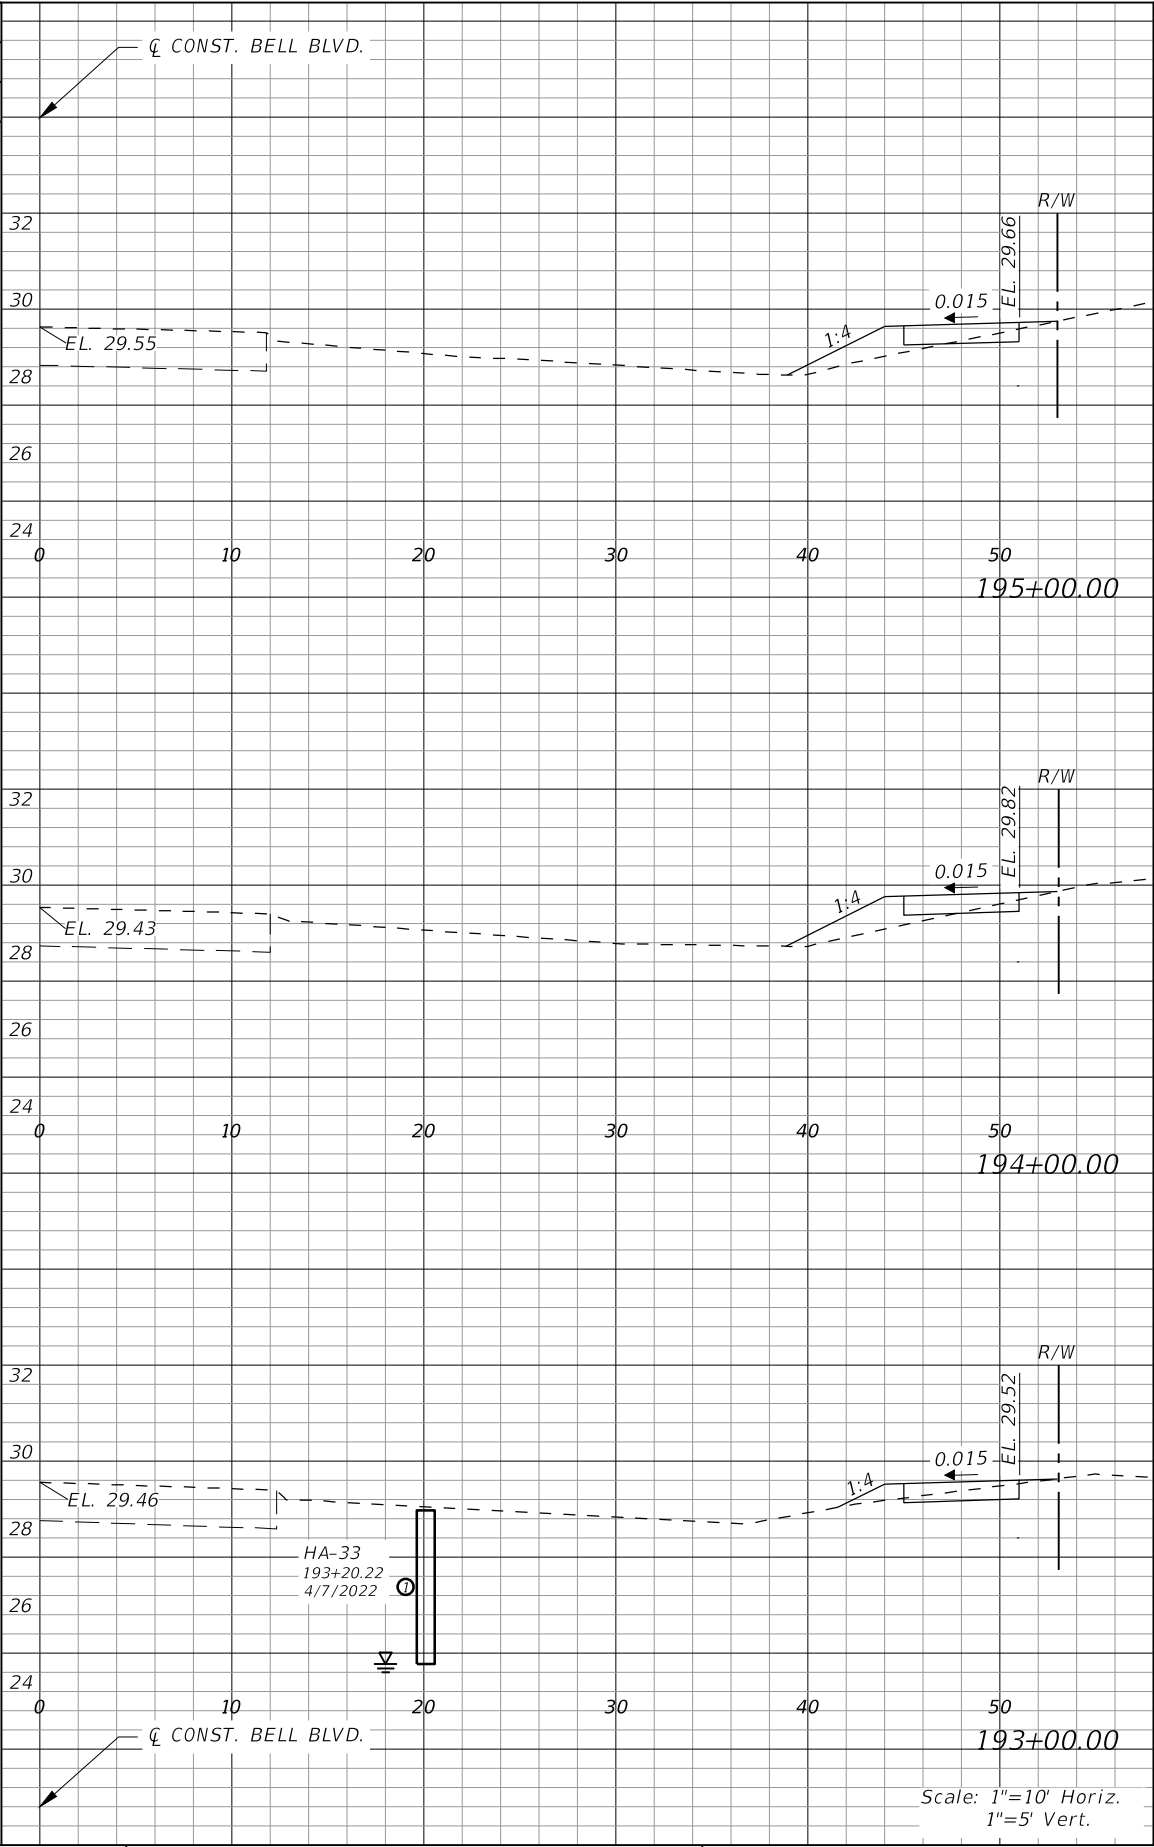

Regular		Exc.	Embankment	
AREA	VOL.		AREA	VOL.
SF	CY		SF	CY
1	3		3	10
1			2	13
1			3	
4			9	
2			1	

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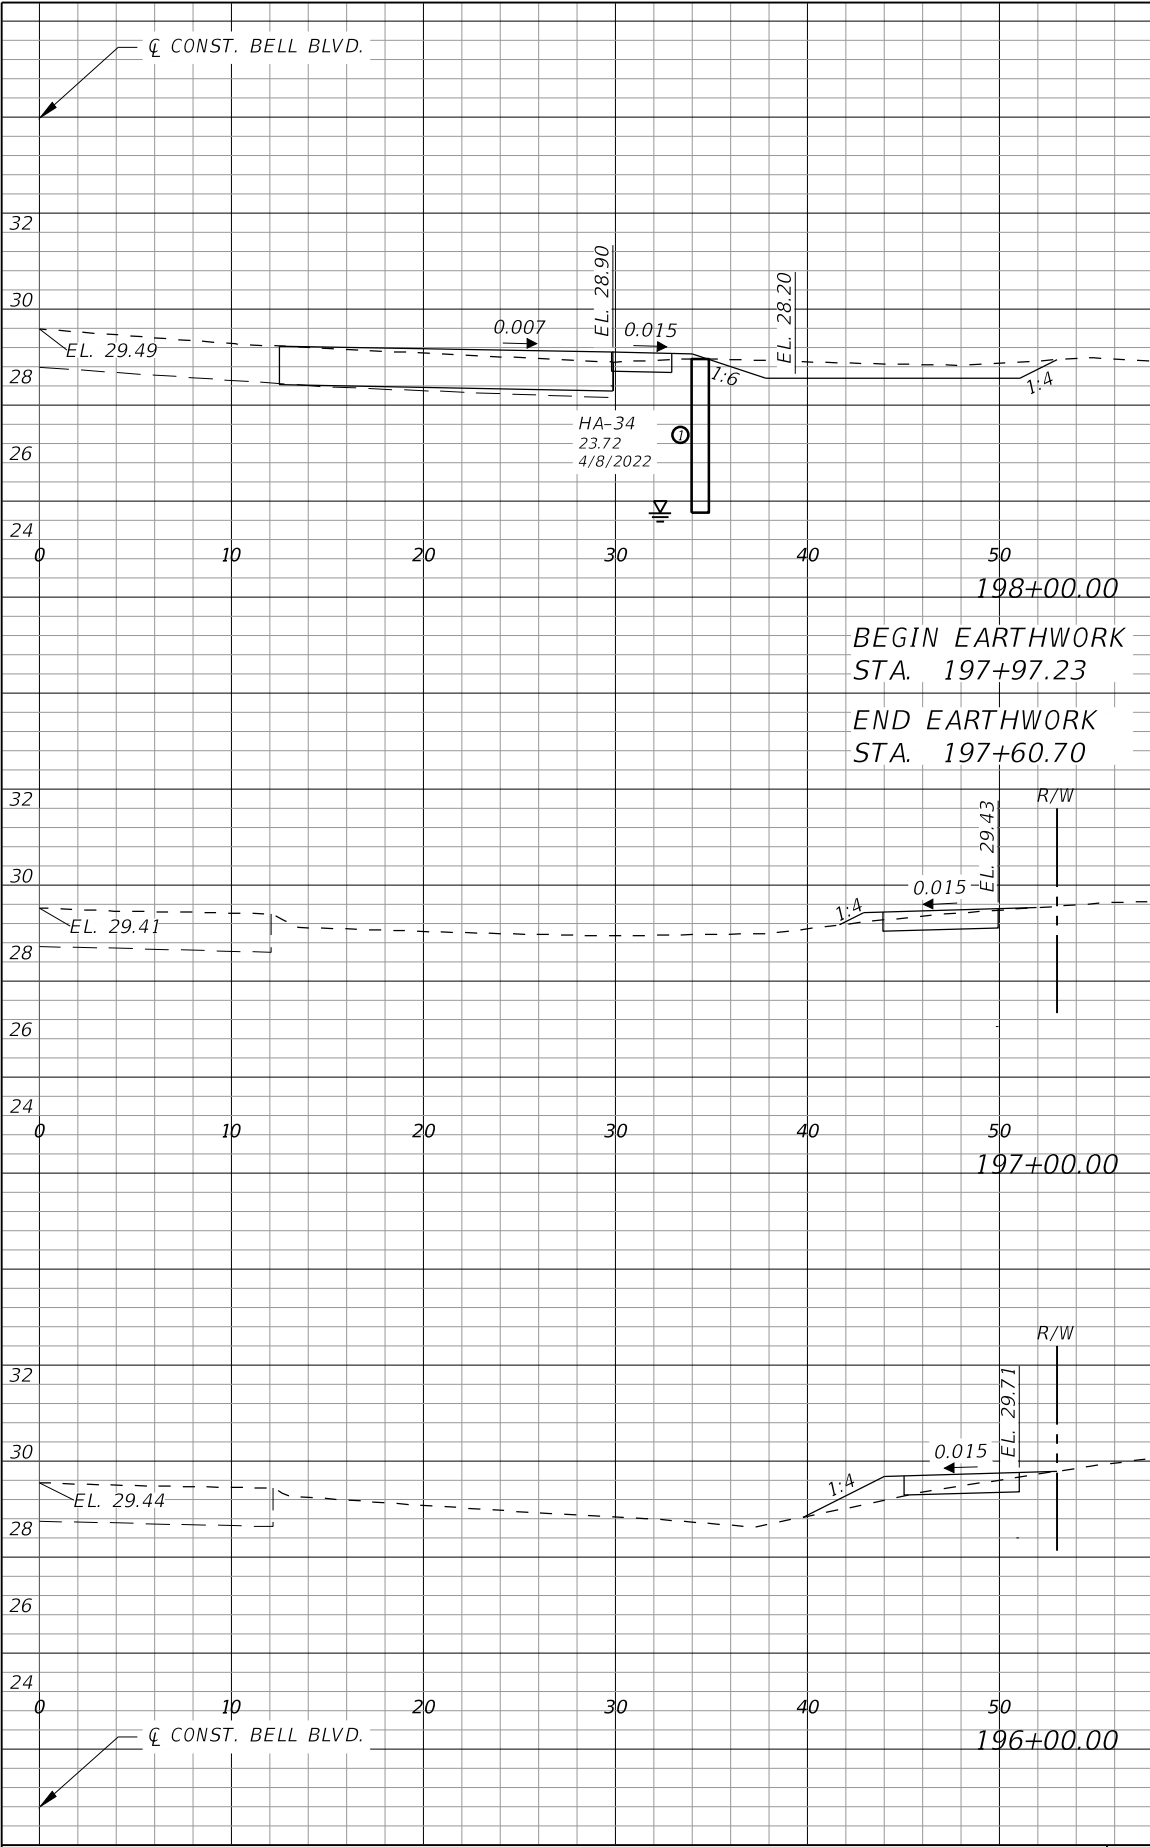
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3800 Via Del Rey  
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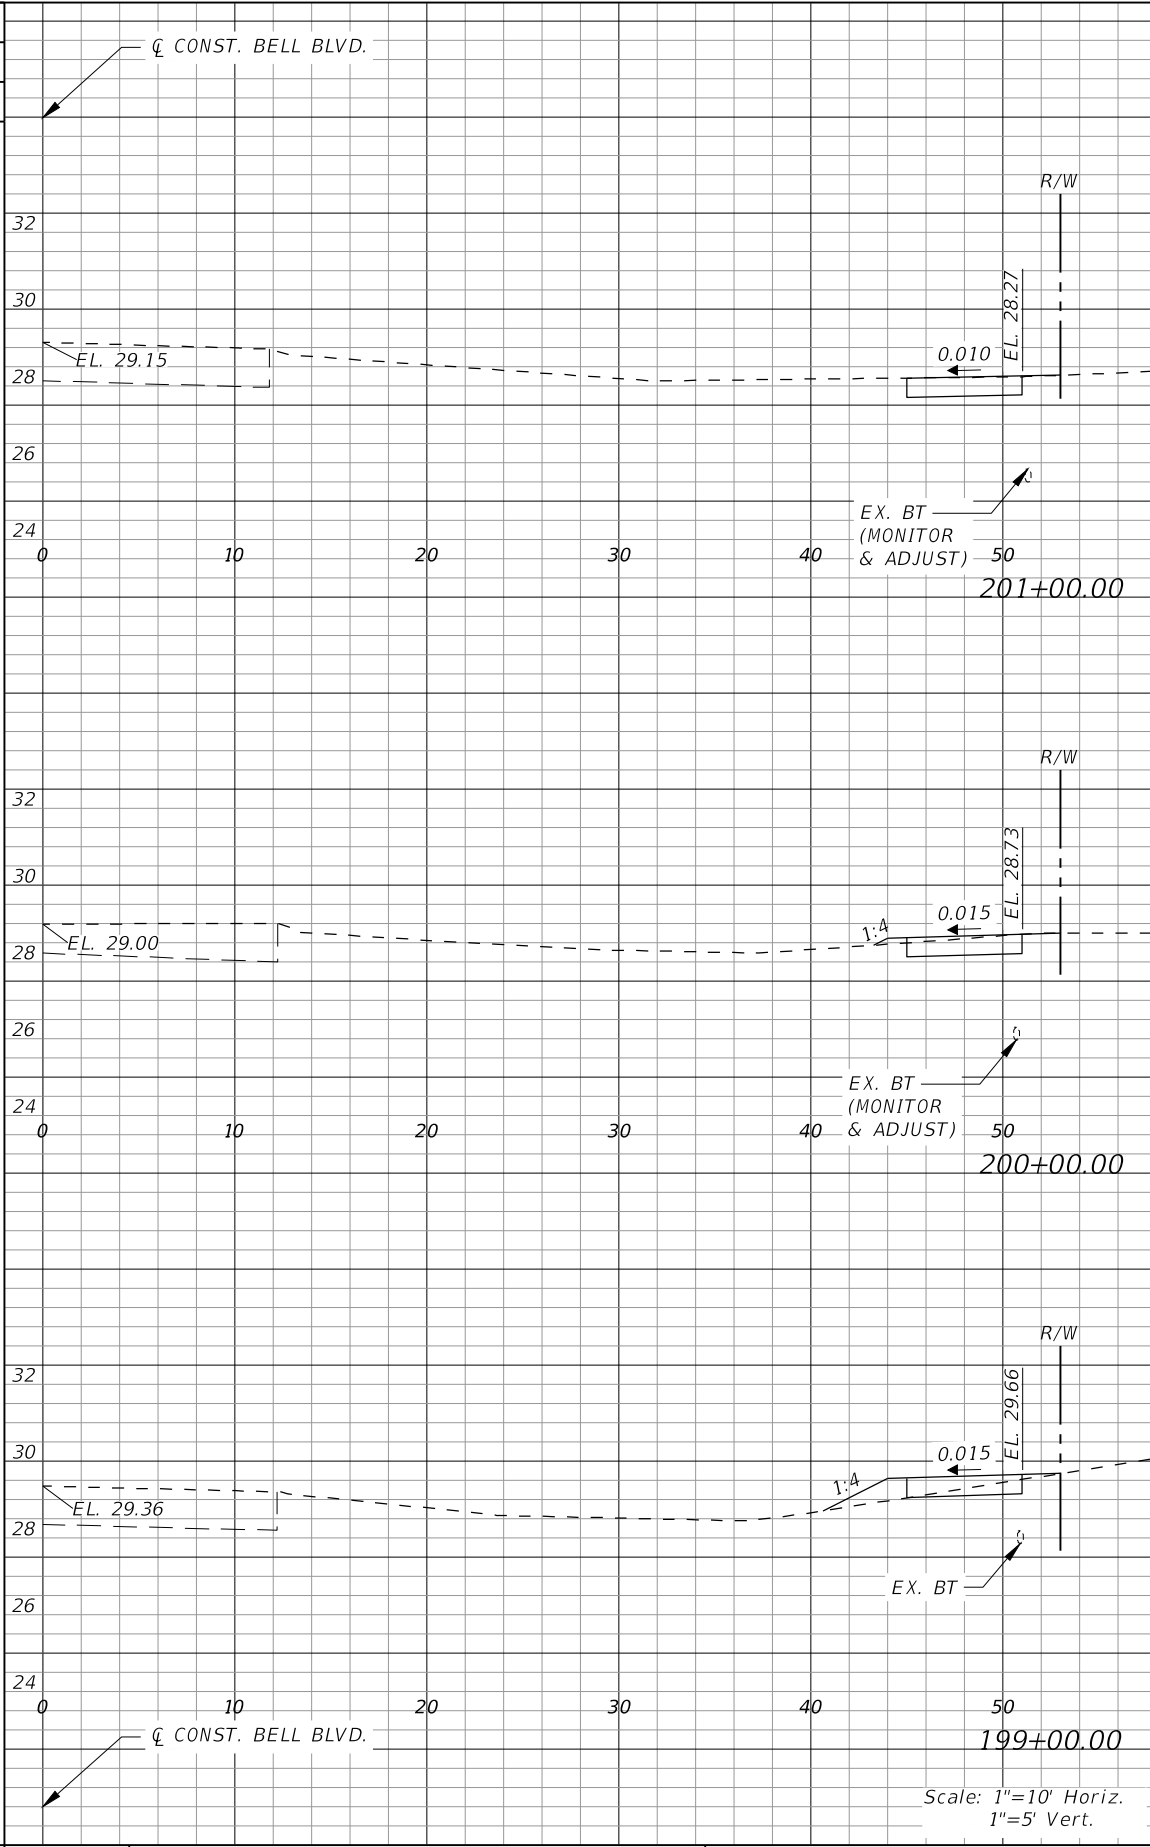
ROAD NO.	COUNTY PROJECT NO.
BELL BLVD. SR 82 TO SUNRISE BLVD. SIDEWALK	6002

**CROSS SECTIONS  
BELL BOULEVARD (RT.)**

SHEET NO.  
**109**



Regular		Exc.	Embankment	
AREA	VOL.		AREA	VOL.
SF	CY		SF	CY
	16			5
7		1		
0			0	
0			0	
3			1	
2		1		
7			6	
1		2		



Regular		Exc.	Embankment	
AREA	VOL.		AREA	VOL.
SF	CY		SF	CY
	9			3
3			1	
		10		4
3			1	
		7		5
1			2	

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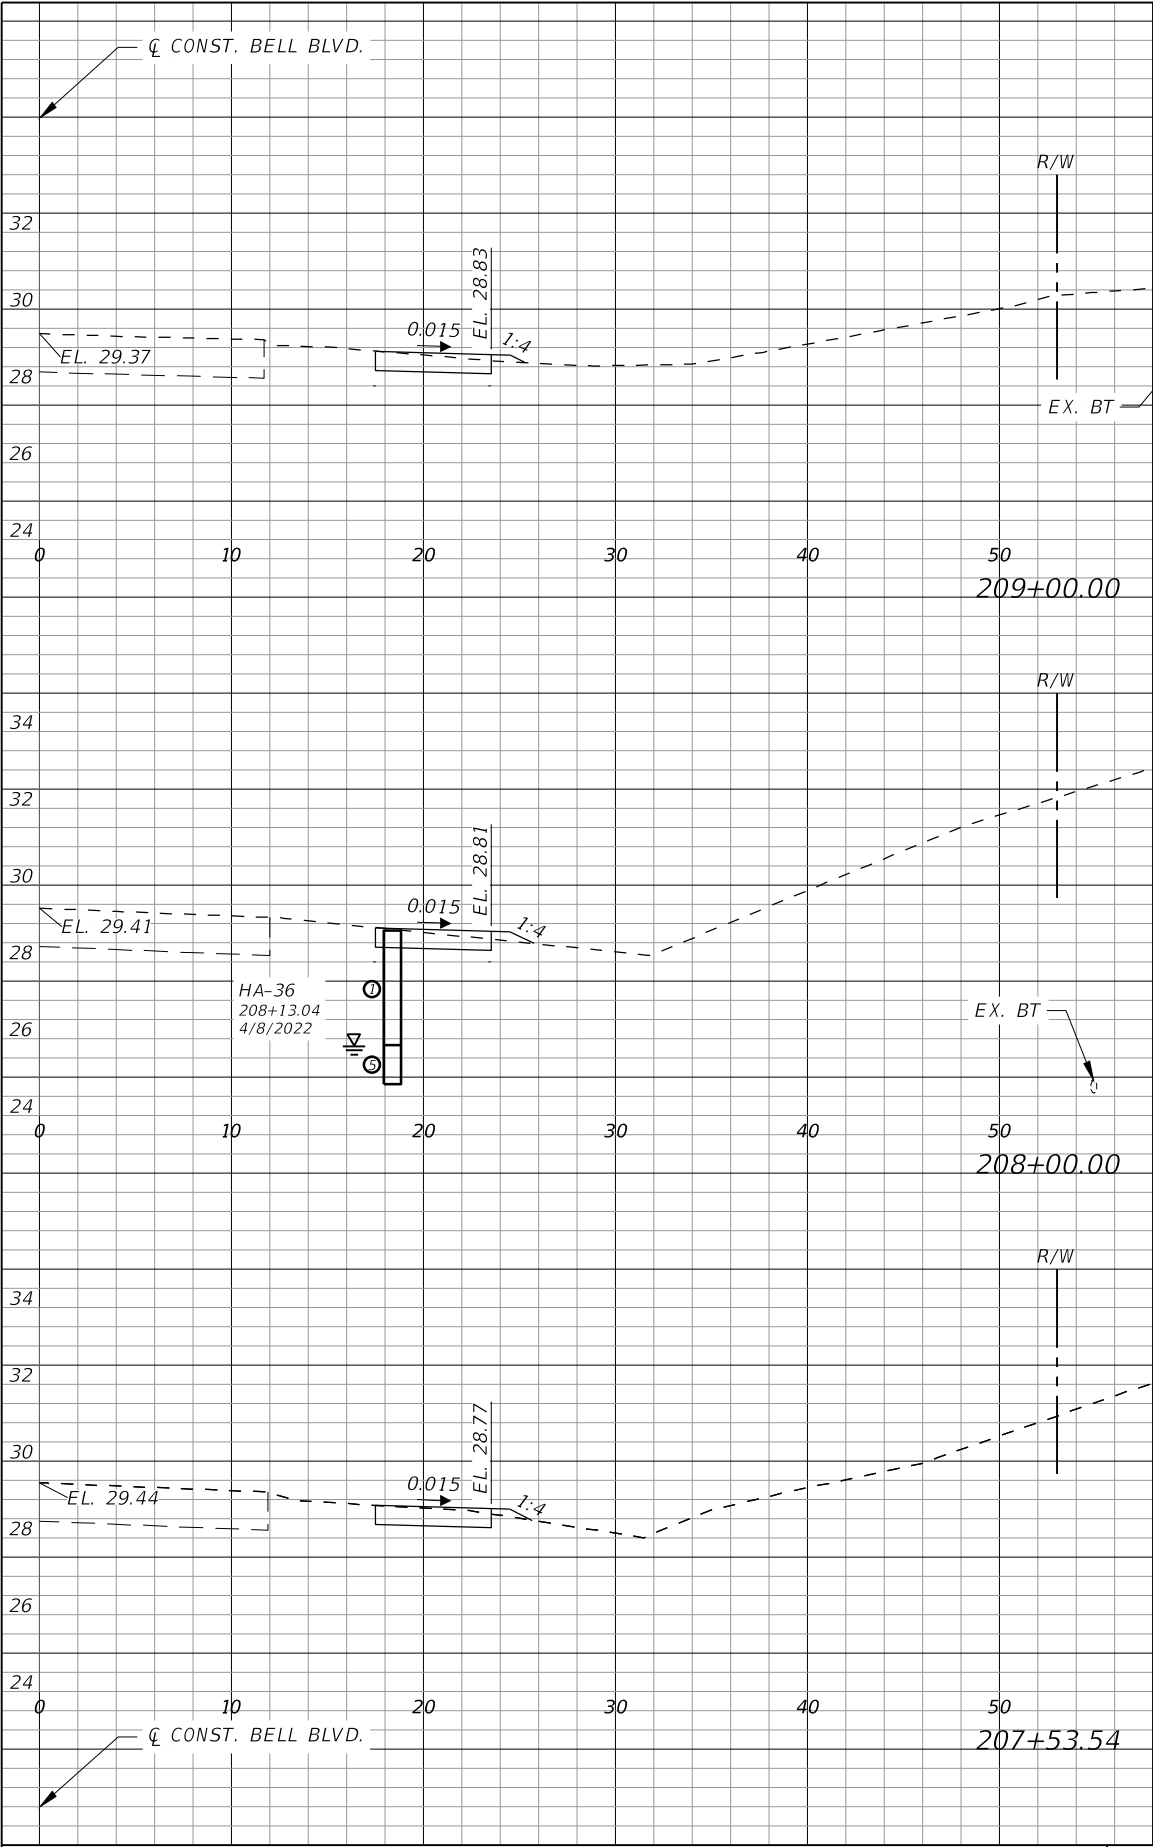
**LEE COUNTY**

ROAD NO.	COUNTY PROJECT NO.
BELL BLVD. SR 82 TO SUNRISE BLVD. SIDEWALK	6002


**CROSS SECTIONS  
BELL BOULEVARD (RT.)**

SHEET NO.  
**110**






Regular		Exc.	Embankment	
AREA	VOL.		AREA	VOL.
SF	CY		SF	CY
3	7		2	
10			4	
3			1	
6			1	
3			1	

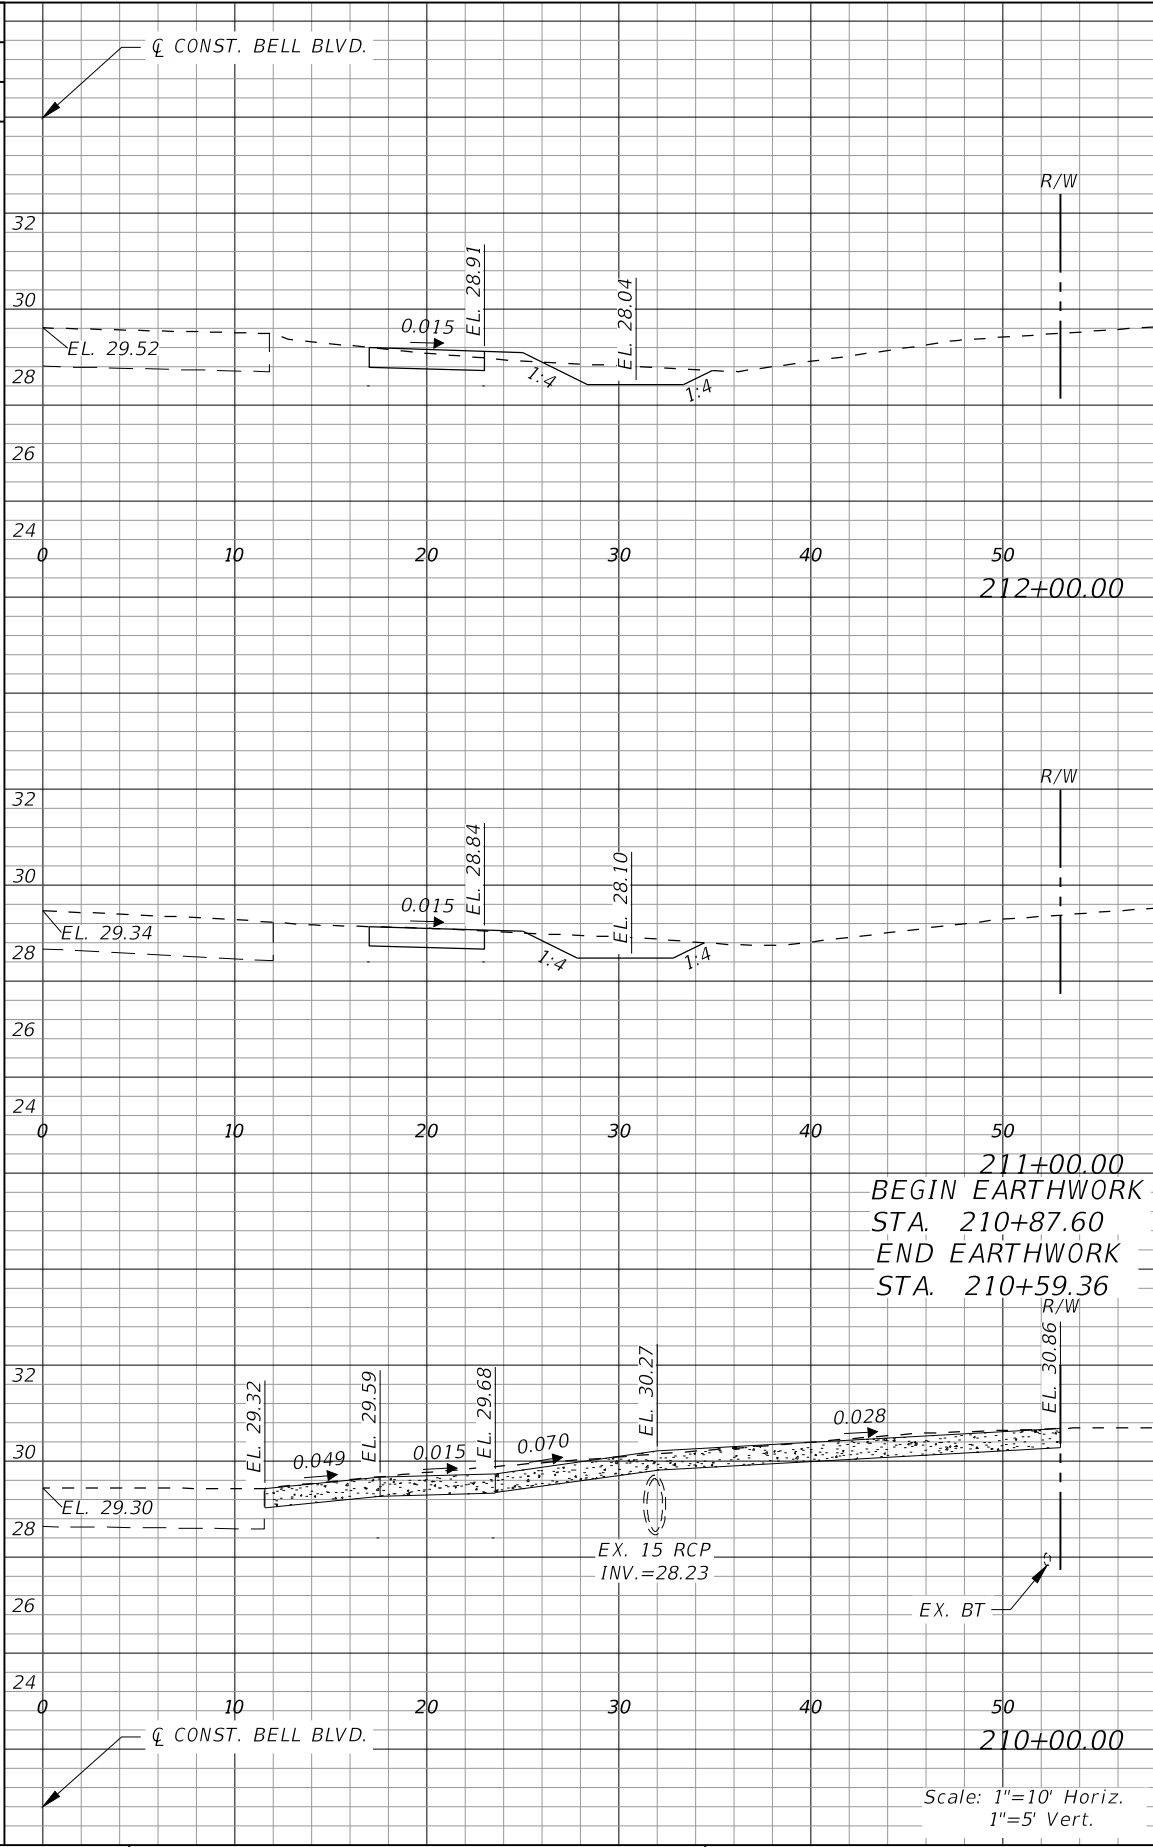

Regular		Exc.	Embankment	
AREA	VOL.		AREA	VOL.
SF	CY		SF	CY
6	25		1	
7			3	
0			0	
0			0	
1			0	
1			0	

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DATE	DESCRIPTION	DATE	DESCRIPTION



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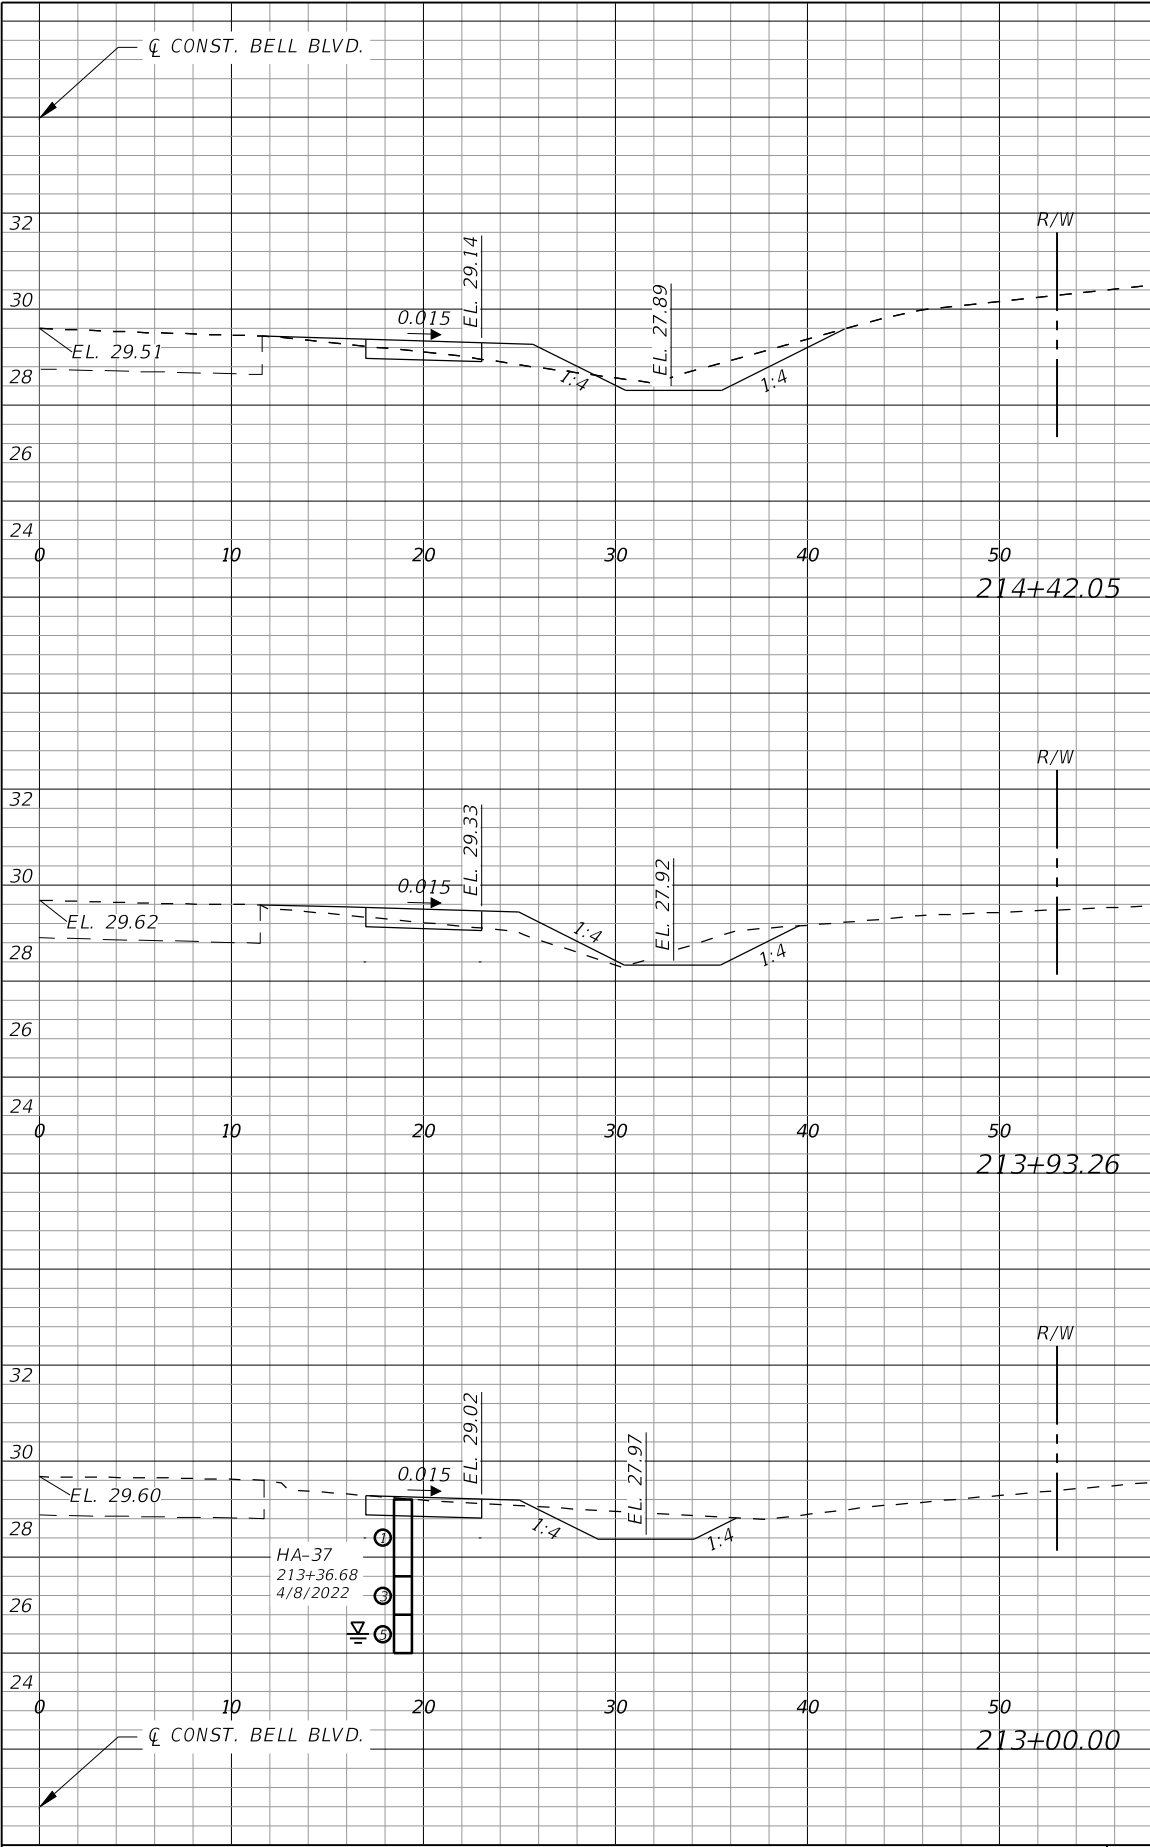
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**LEE COUNTY**


ROAD NO.	COUNTY PROJECT NO.
BELL BLVD. SR 82 TO SUNRISE BLVD. SIDEWALK	6002

**CROSS SECTIONS  
BELL BOULEVARD (RT.)**

SHEET NO.  
**112**




Regular		Exc.	Embankment	
AREA	VOL.		AREA	VOL.
SF	CY		SF	CY
6	14		3	6
5	9		3	6
8	22		1	8

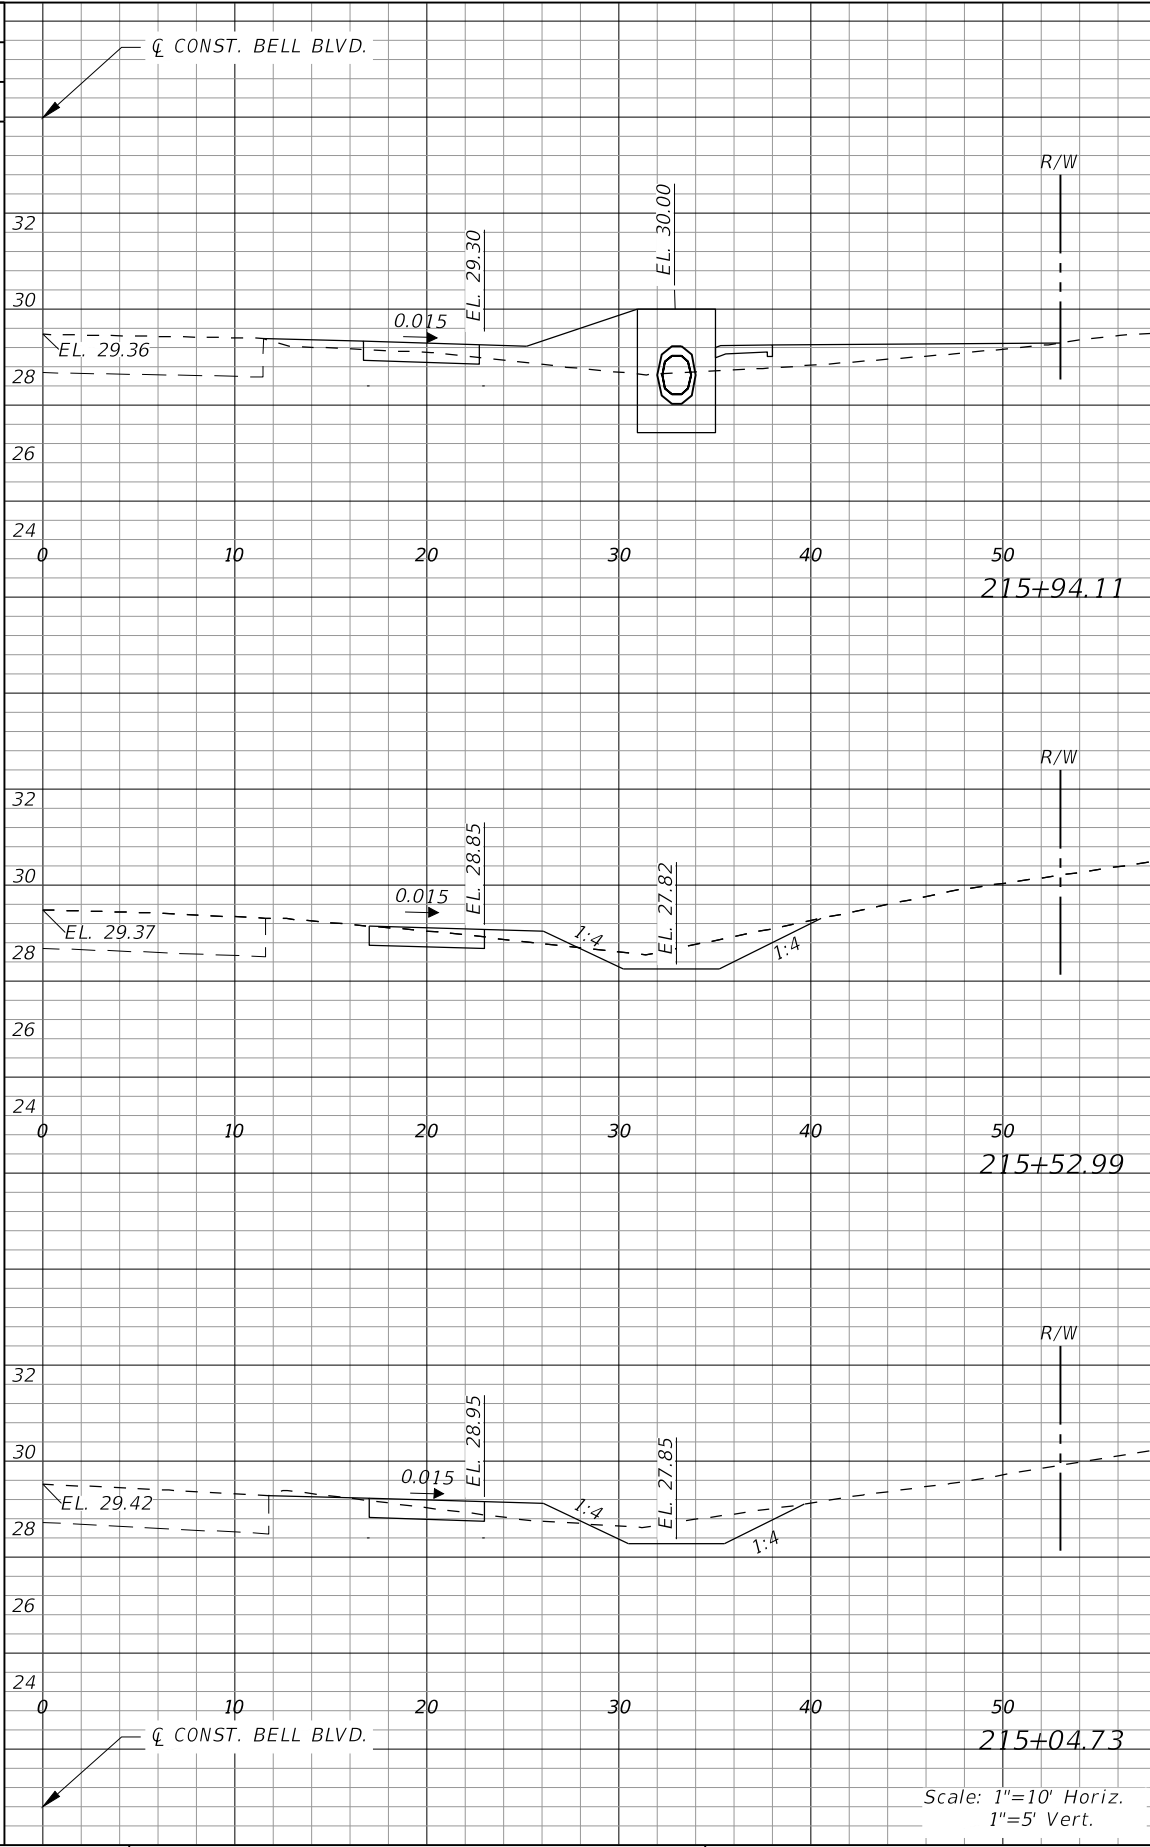

Regular		Exc.	Embankment	
AREA	VOL.		AREA	VOL.
SF	CY		SF	CY
1	2		15	21
8	10		1	3
7	13		2	3

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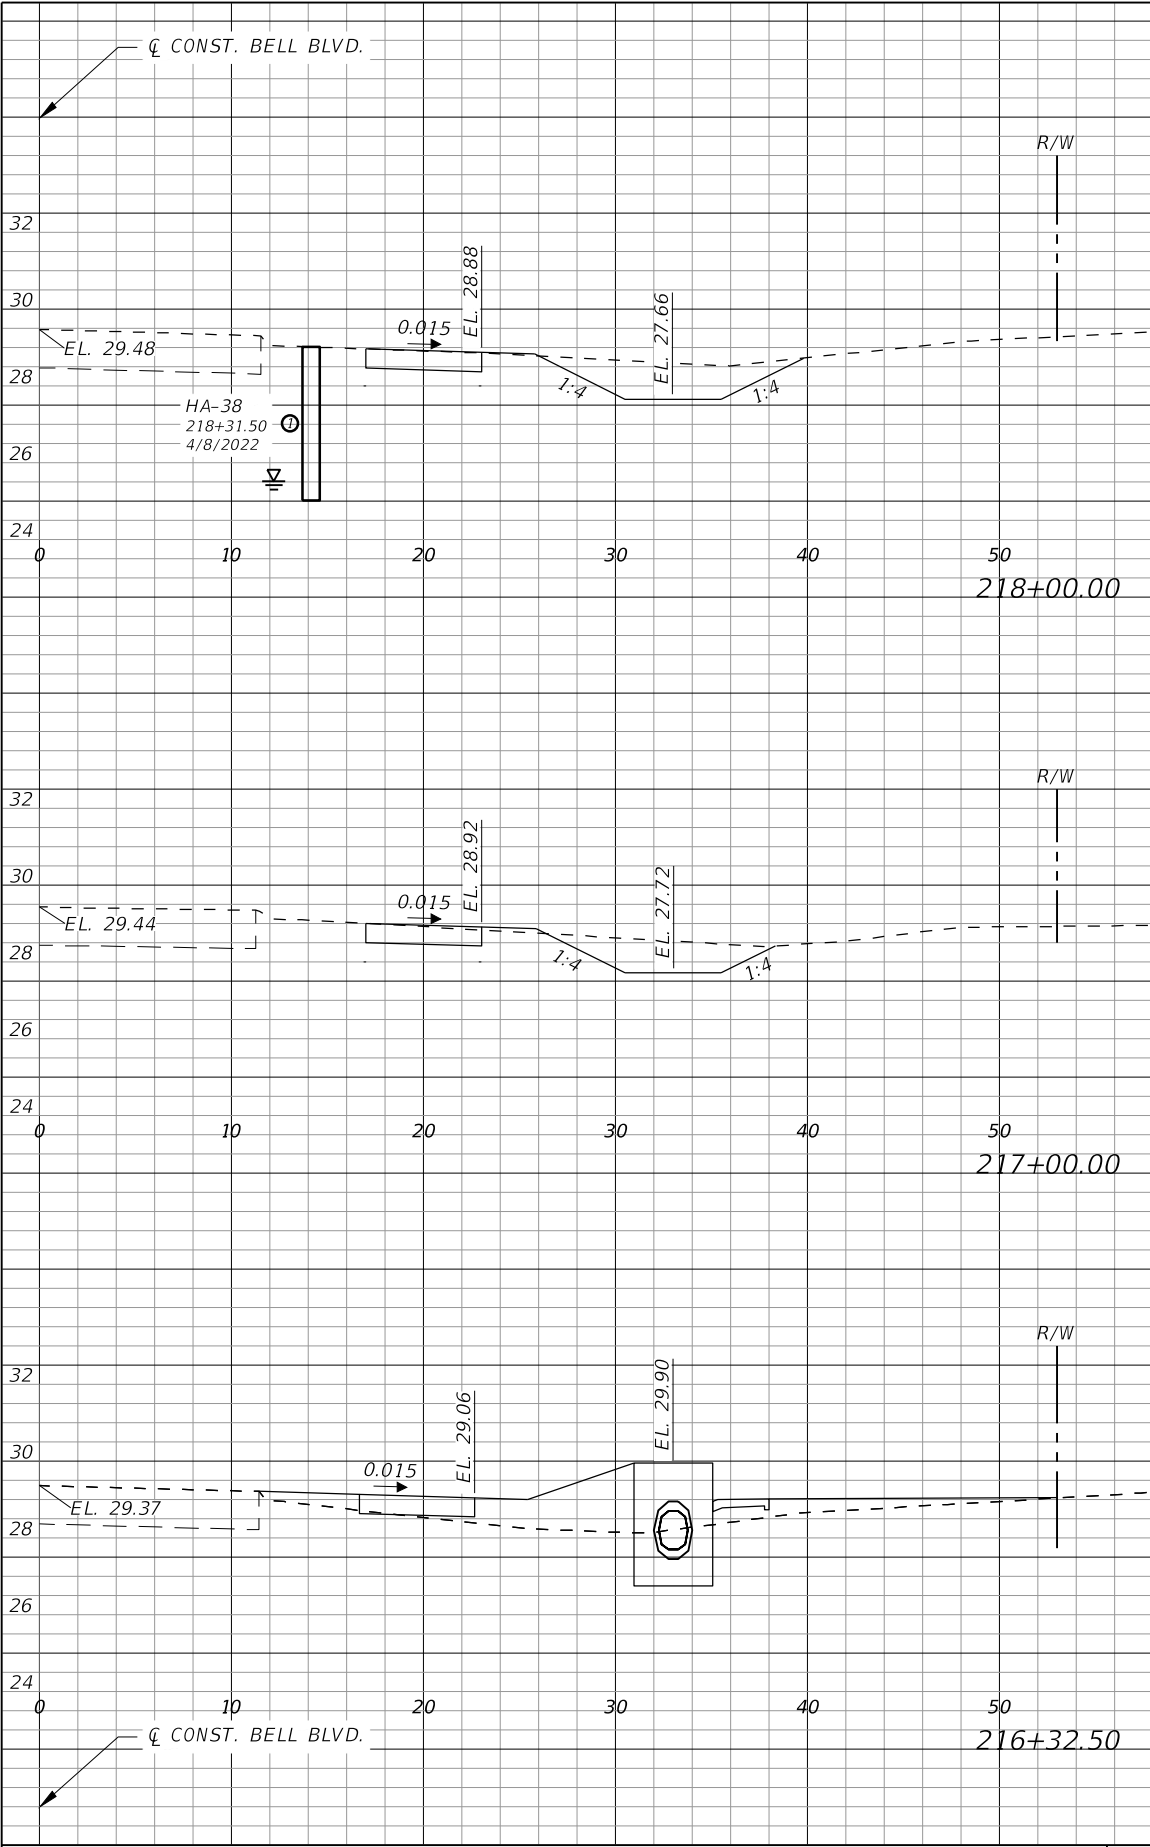
**LEE COUNTY**

ROAD NO.	COUNTY PROJECT NO.
BELL BLVD. SR 82 TO SUNRISE BLVD. SIDEWALK	6002


**CROSS SECTIONS  
BELL BOULEVARD (RT.)**

SHEET NO.  
**113**





Regular		Exc.	Embankment	
AREA	VOL.		AREA	VOL.
SF	CY		SF	CY
12	38		4	
40			4	
10			1	
1			15	

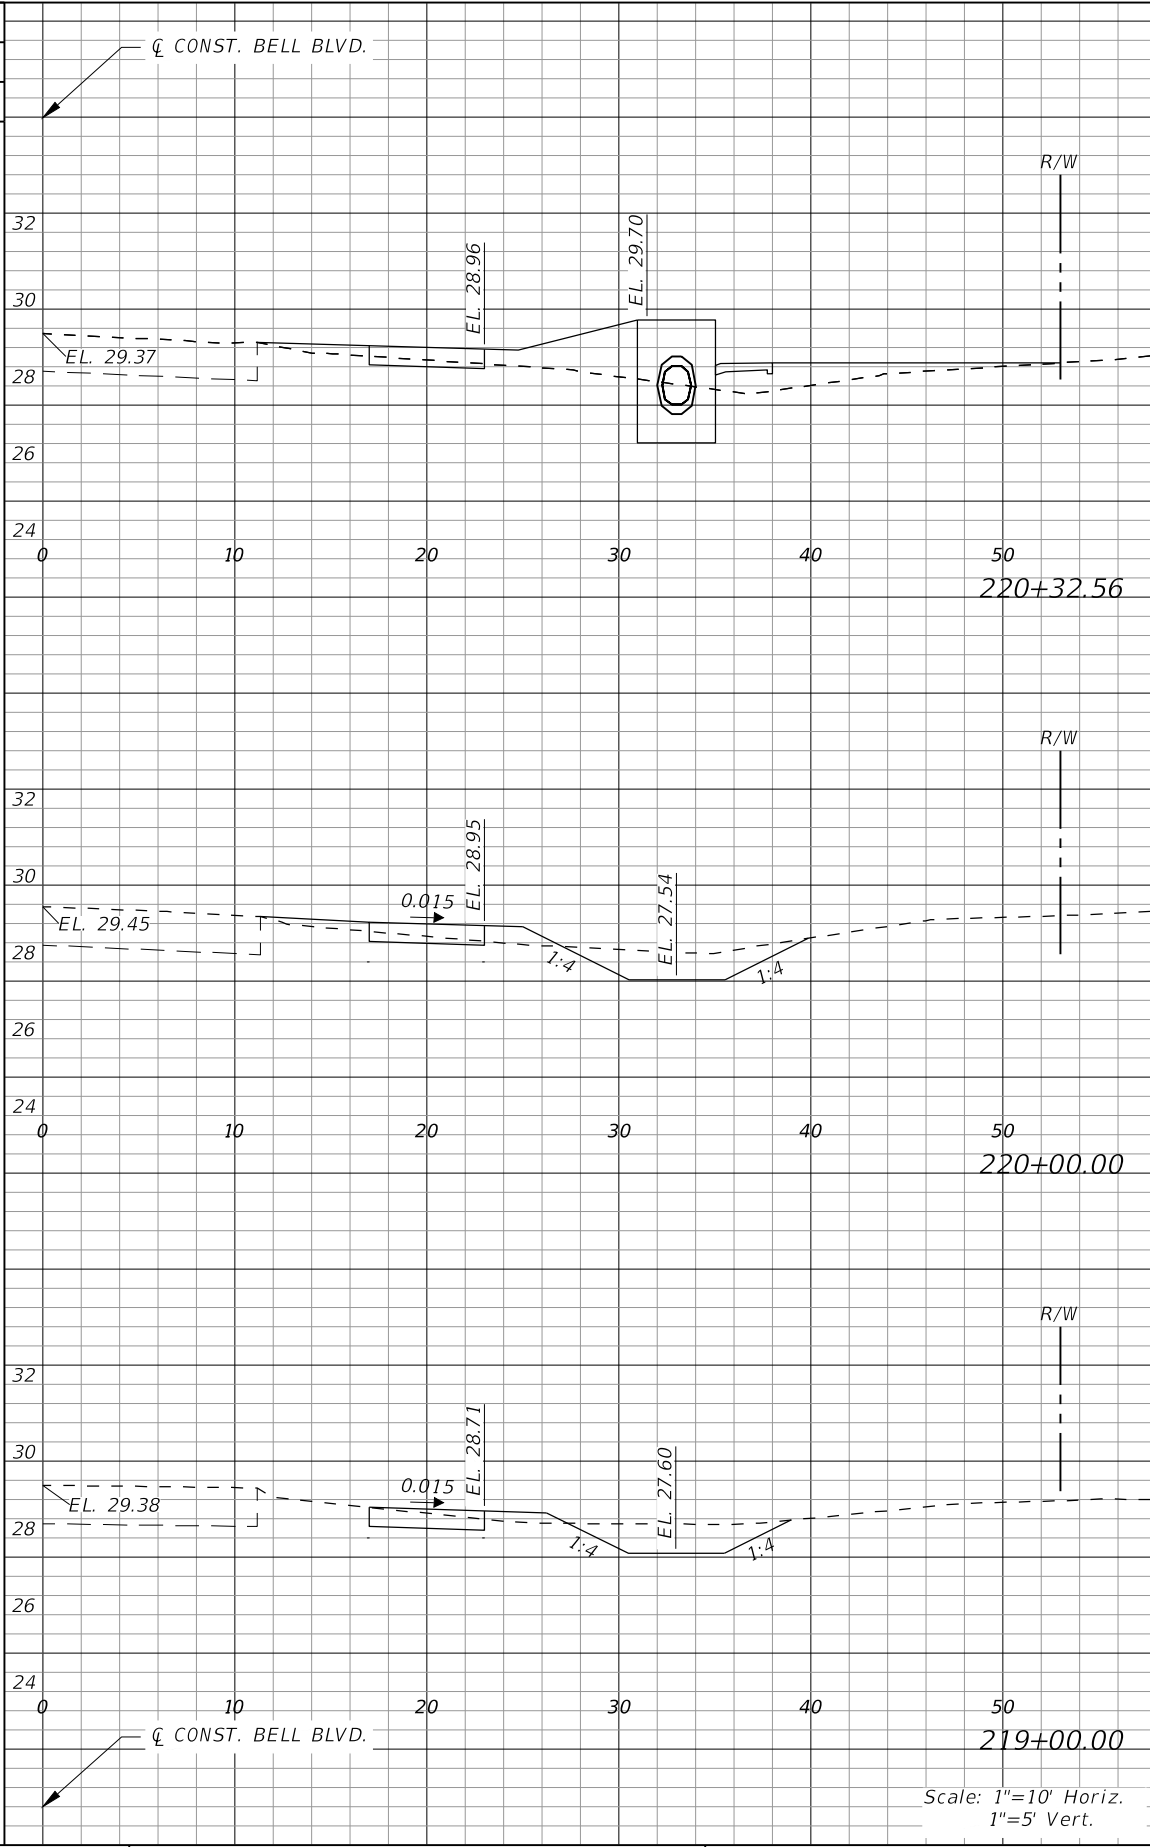

Regular		Exc.	Embankment	
AREA	VOL.		AREA	VOL.
SF	CY		SF	CY
1	16		20	
1			15	
8			12	
8			2	
9			30	
9			1	

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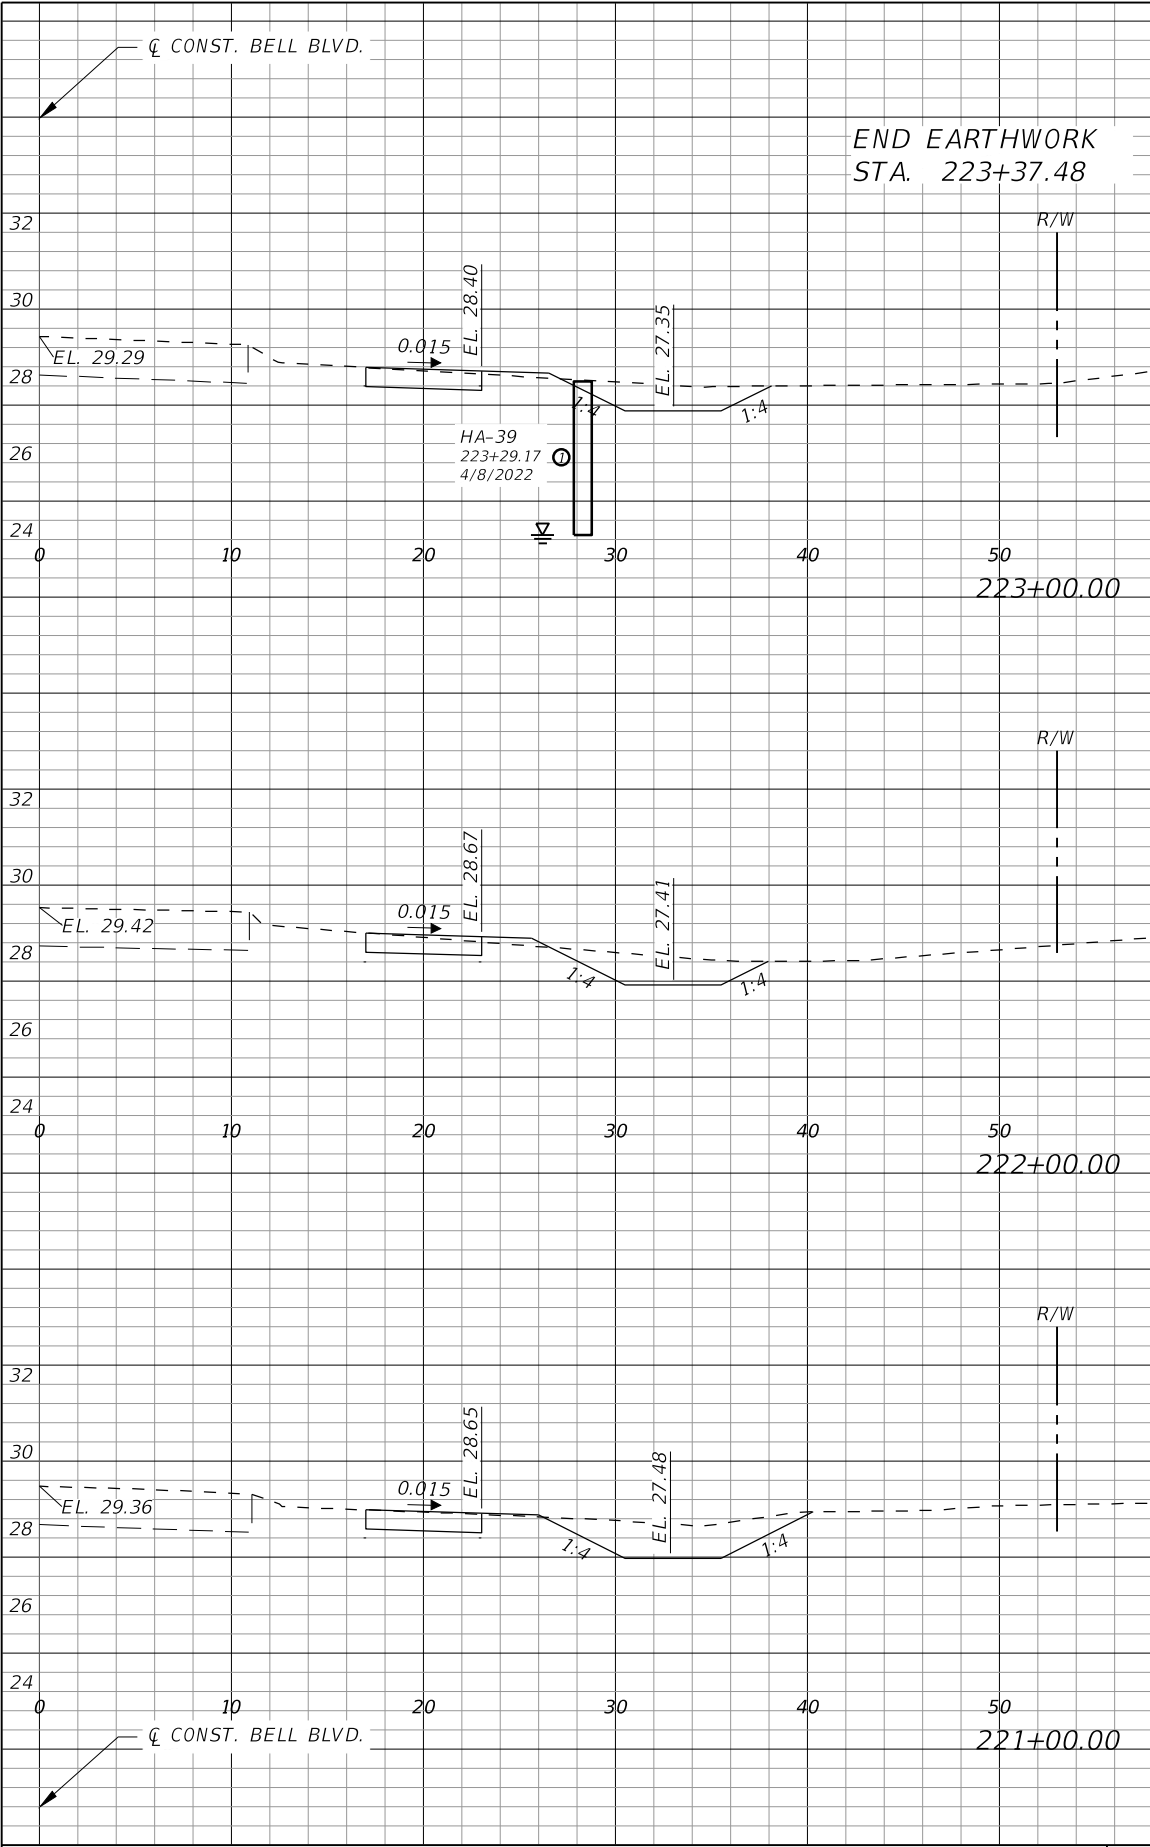
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Bonita Springs, Florida 34134  
Phone: 239.947.1144  
R. DANIEL FLYNN, P.E. NO. 76205

**LEE COUNTY**


ROAD NO.	COUNTY PROJECT NO.
BELL BLVD. SR 82 TO SUNRISE BLVD. SIDEWALK	6002

**CROSS SECTIONS  
BELL BOULEVARD (RT.)**

SHEET NO.  
**114**




Regular		Exc.	Embankment	
AREA	VOL.		AREA	VOL.
SF	CY		SF	CY
0	6		0	1
8			1	
	31		3	
9			1	
	38		3	
12			1	

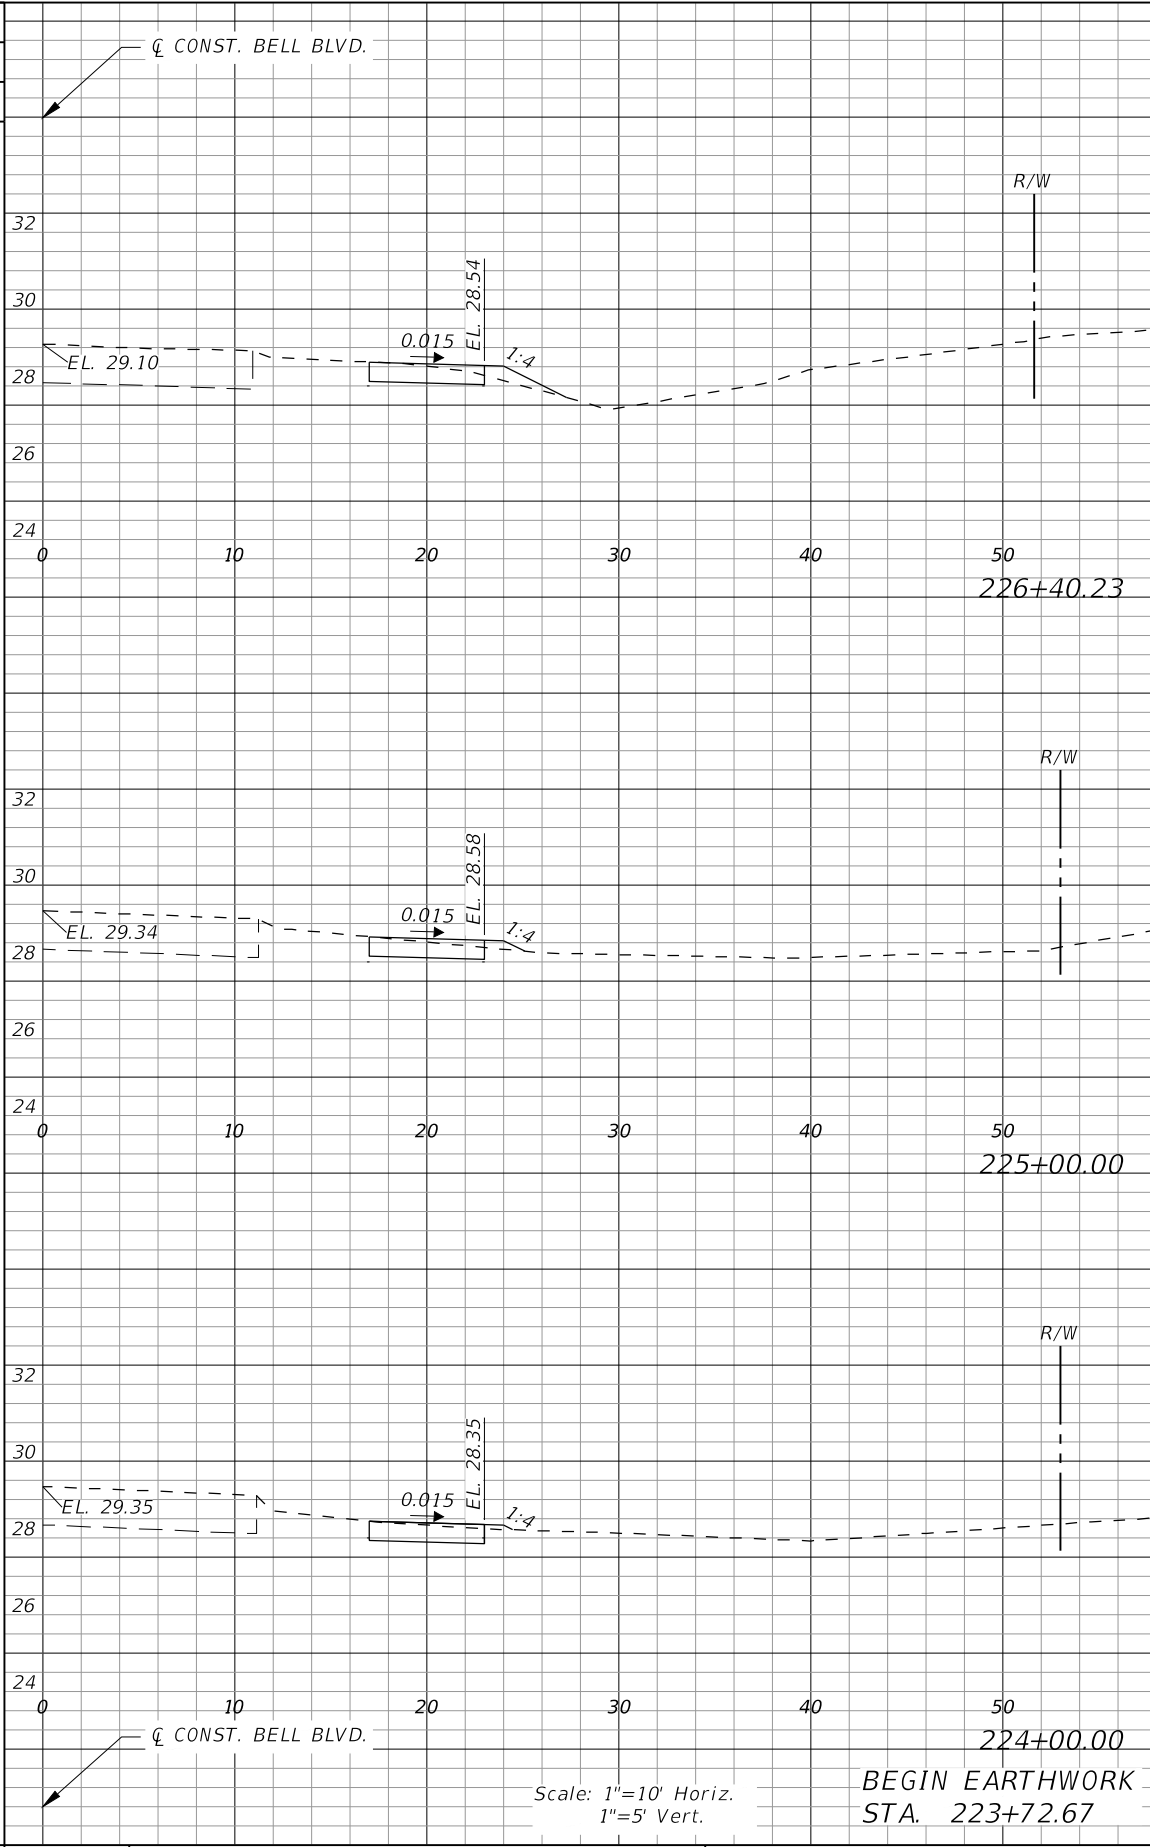

Regular		Exc.	Embankment	
AREA	VOL.		AREA	VOL.
SF	CY		SF	CY
	14			11
3			1	
	13			5
2			1	
	9			4
3			1	
0	1		0	1

REVISIONS			
DATE	DESCRIPTION	DATE	DESCRIPTION



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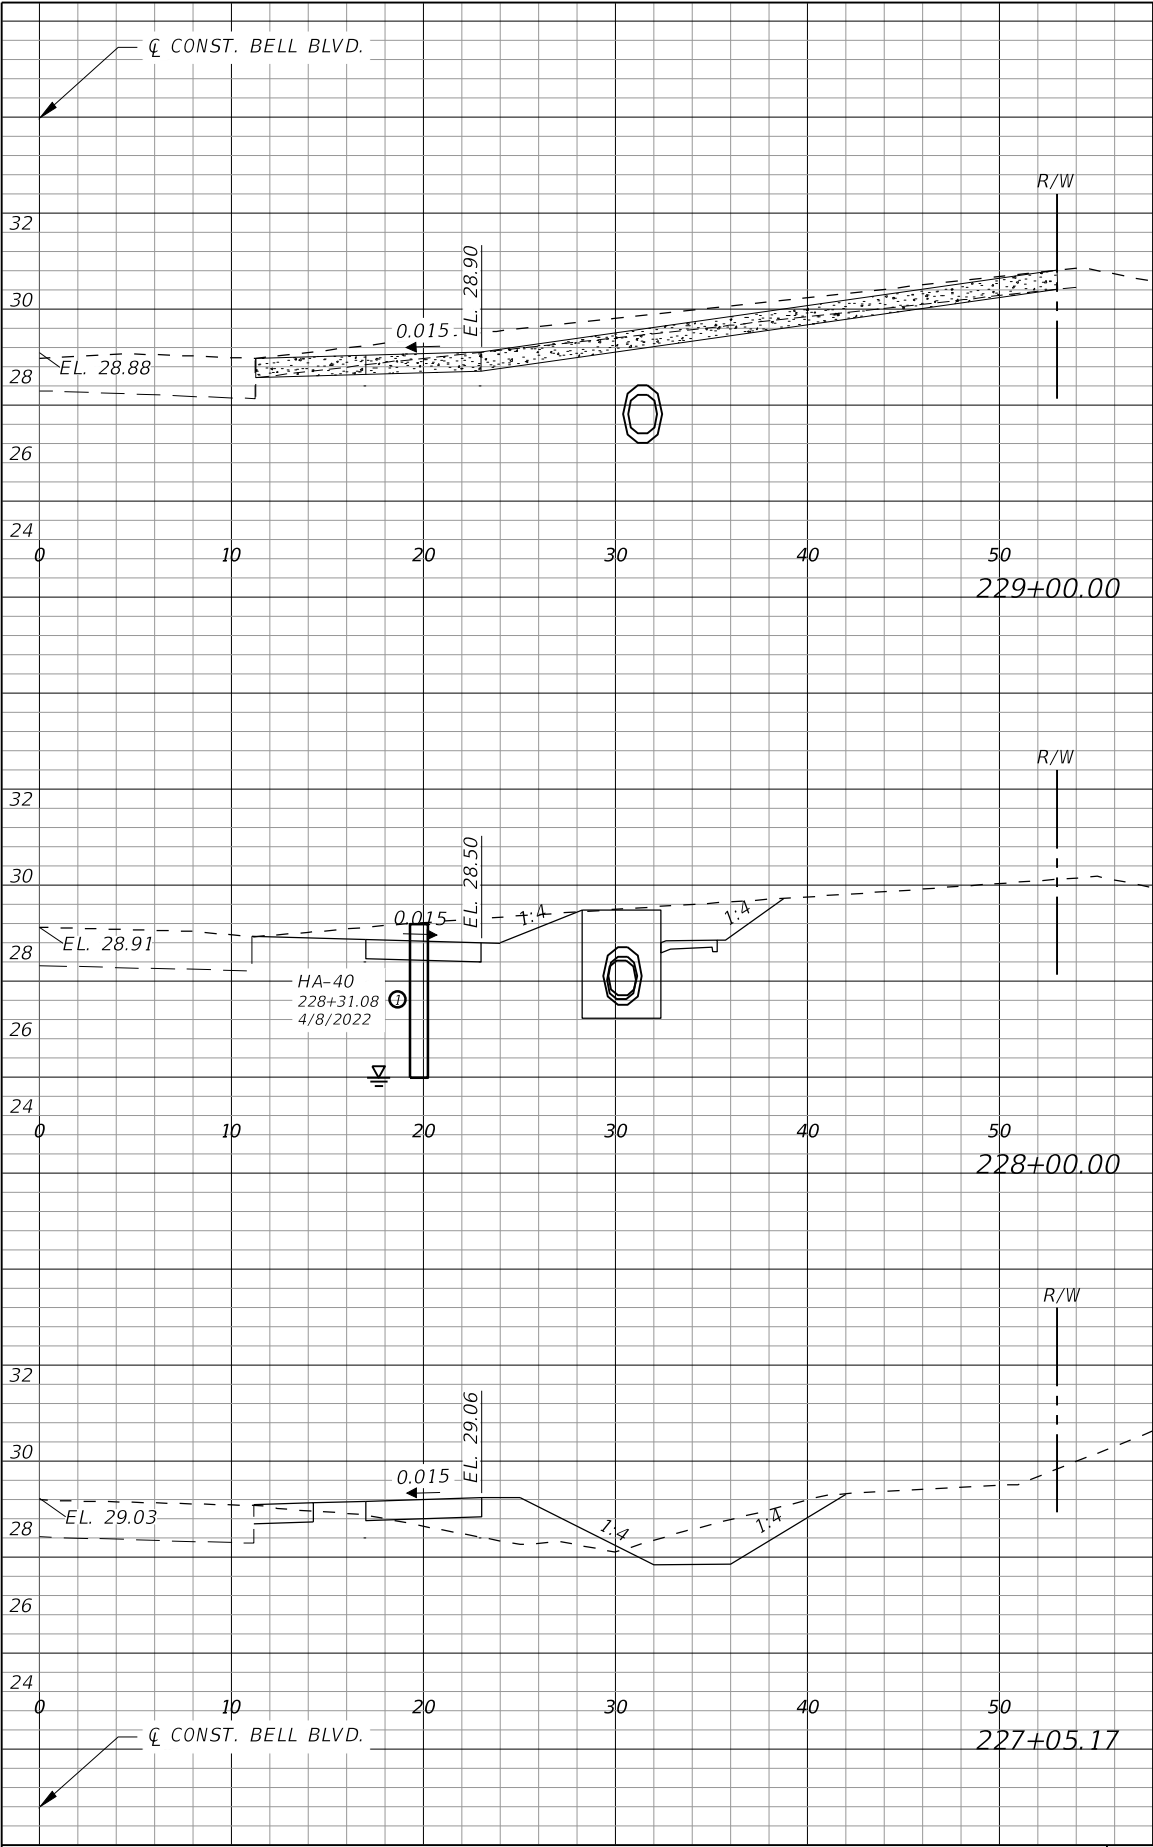
Q. Grady Minor and Associates, P.A.  
3800 Via Del Rey  
Bonita Springs, Florida 34134  
Phone: 239.947.1144  
R. DANIEL FLYNN, P.E. NO. 76205

**LEE COUNTY**


ROAD NO.	COUNTY PROJECT NO.
BELL BLVD. SR 82 TO SUNRISE BLVD. SIDEWALK	6002

**CROSS SECTIONS  
BELL BOULEVARD (RT.)**

SHEET NO.  
**115**




Regular		Exc.	Embankment	
AREA	VOL.		AREA	VOL.
SF	CY		SF	CY
0	4		0	2
24			0	
43			17	
10			9	

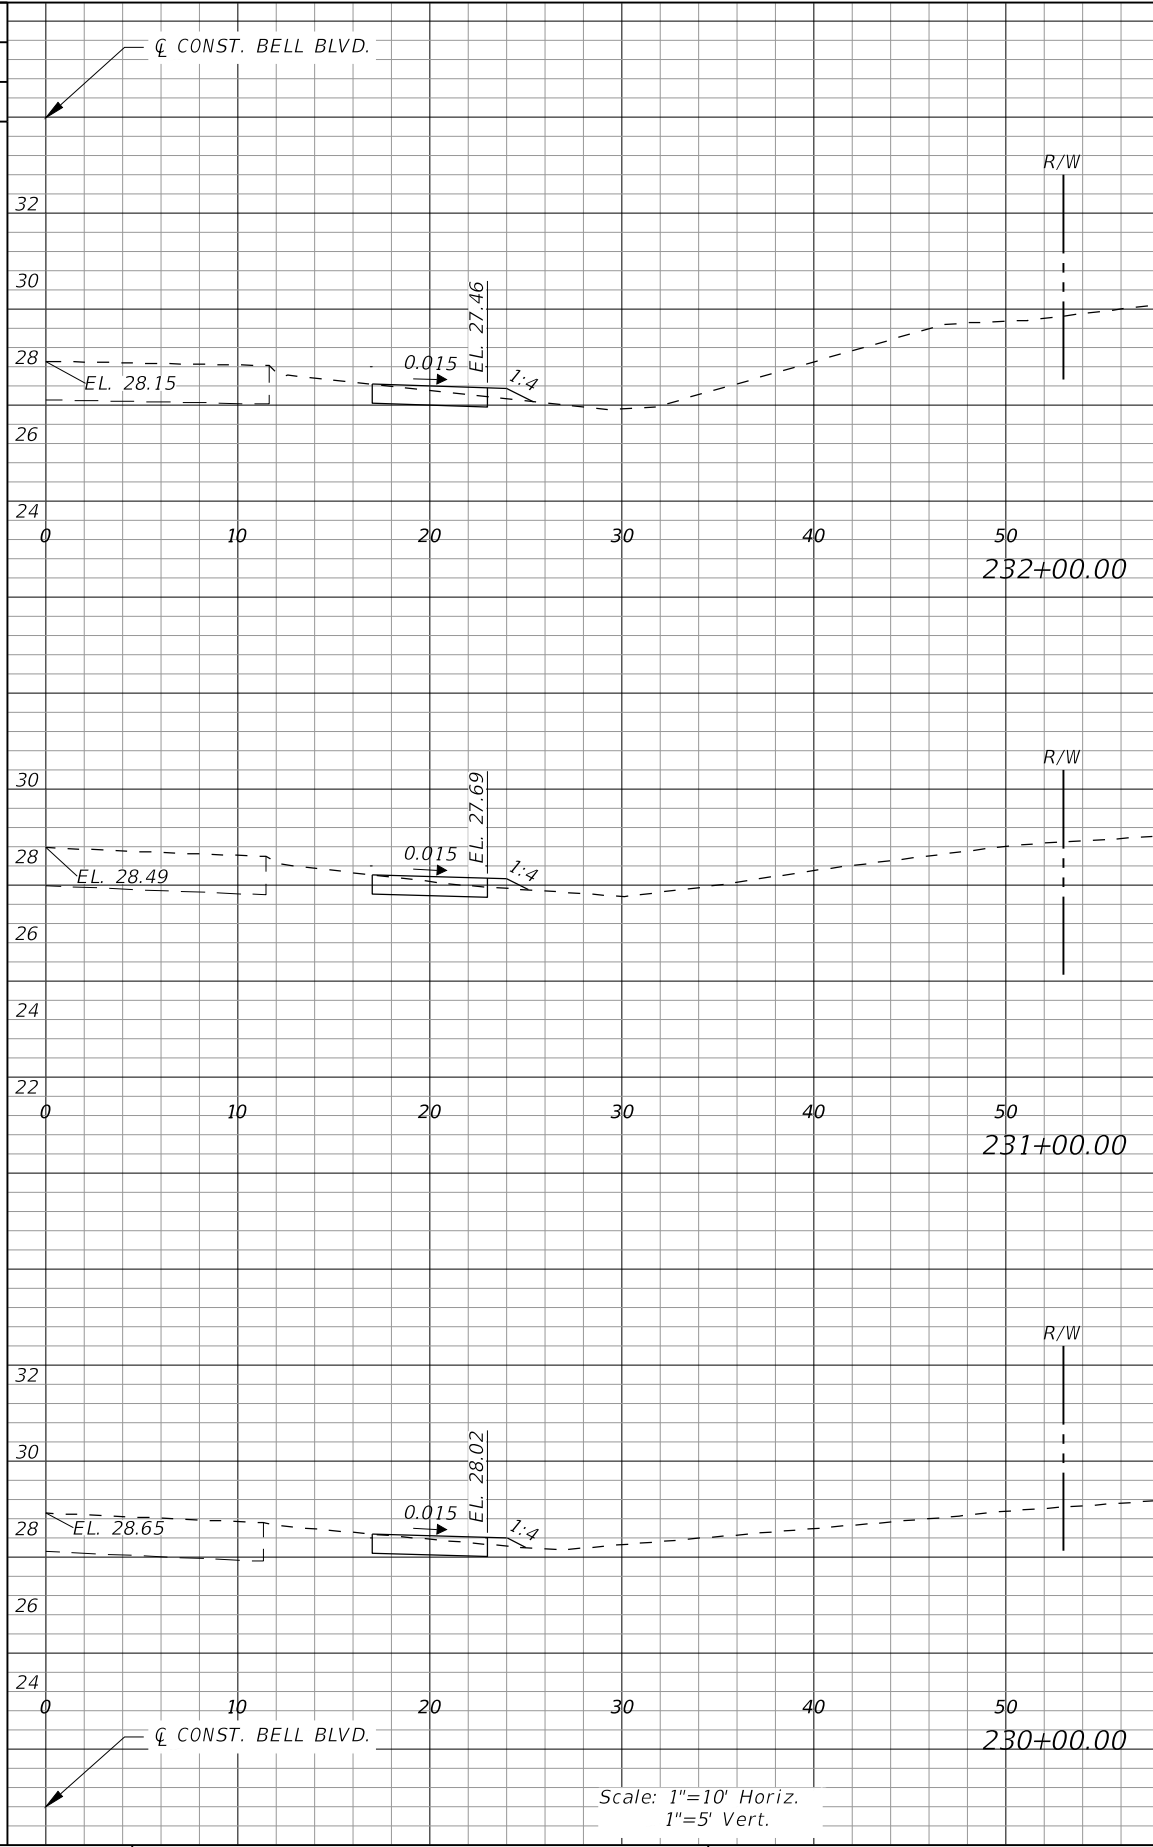

Regular		Exc.	Embankment	
AREA	VOL.		AREA	VOL.
SF	CY		SF	CY
2			1	
8			4	
2			1	
9			4	
2			1	

REVISIONS			
DATE	DESCRIPTION	DATE	DESCRIPTION



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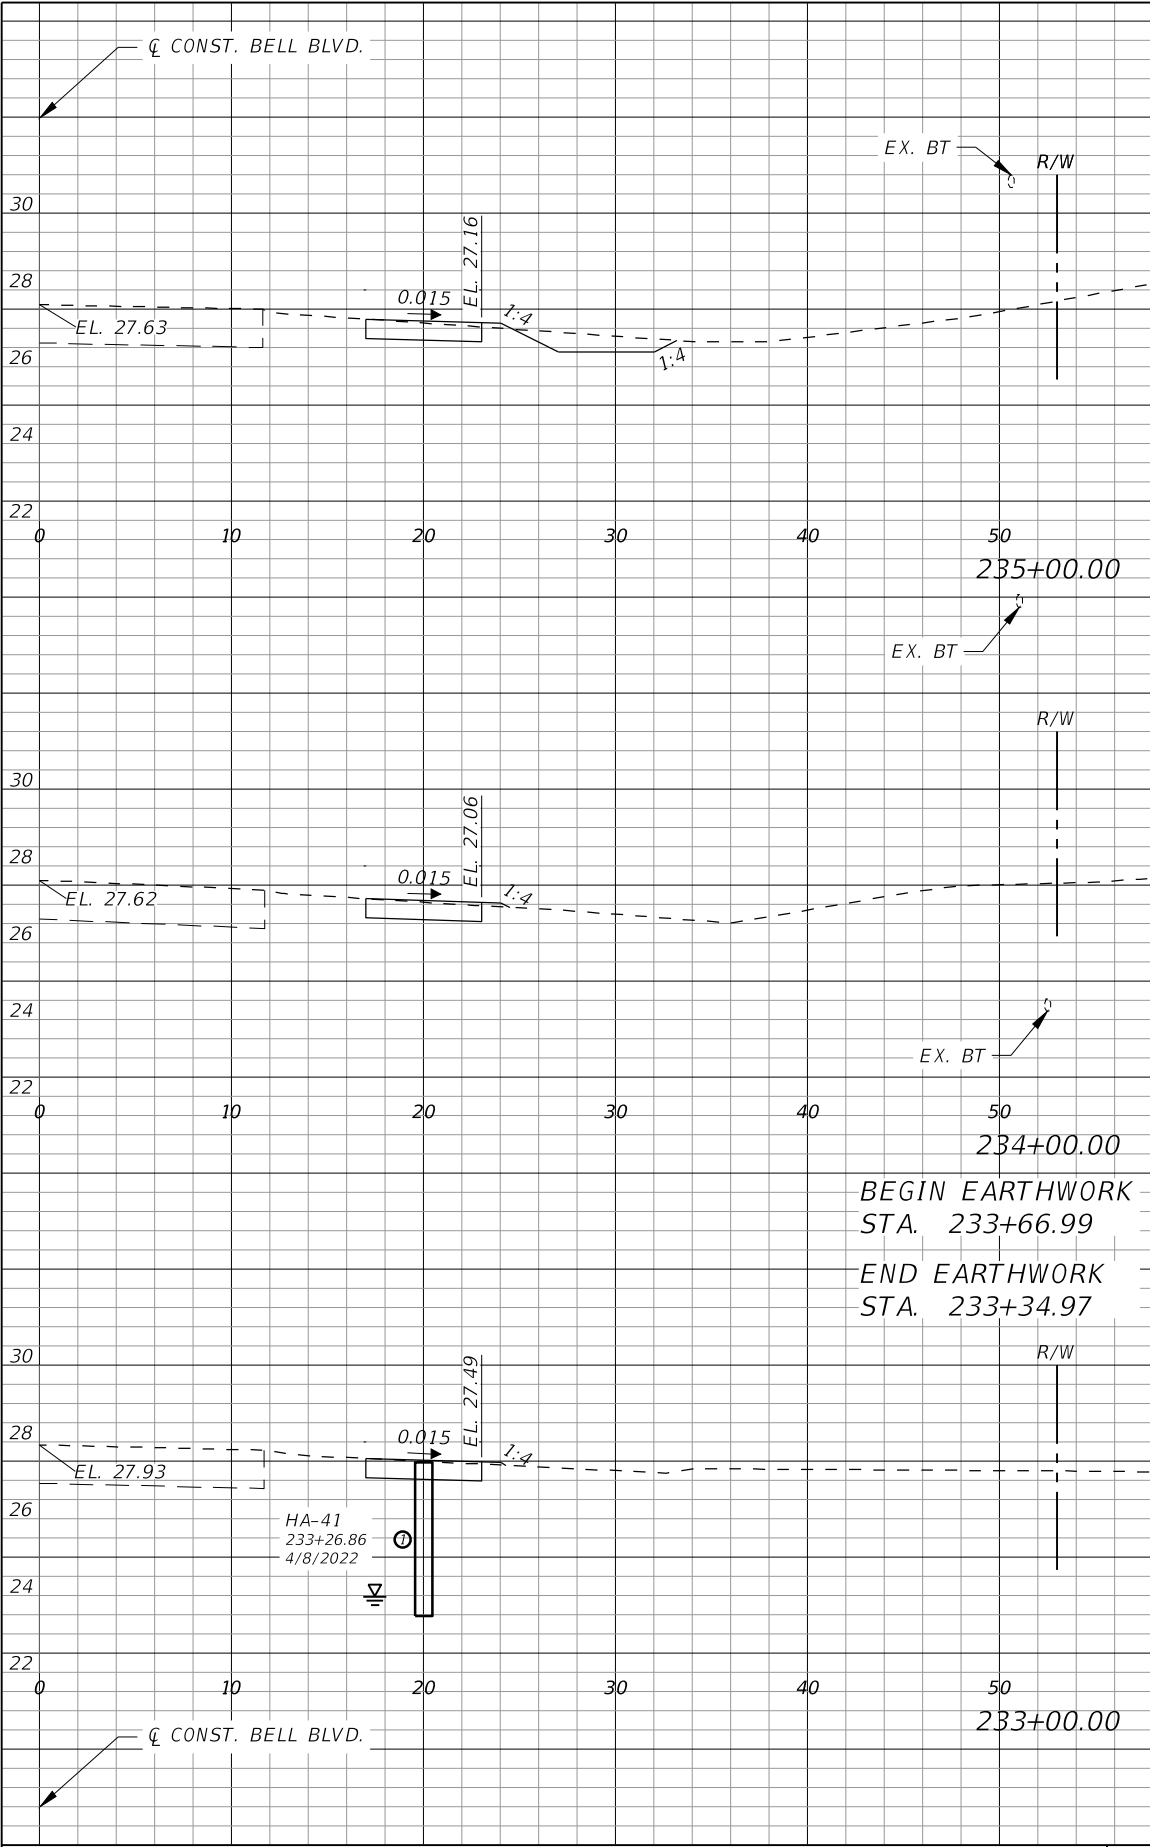
Q. Grady Minor and Associates, P.A.  
3800 Via Del Rey  
Bonita Springs, Florida 34134  
Phone: 239.947.1144  
R. DANIEL FLYNN, P.E. NO. 76205

**LEE COUNTY**


ROAD NO.	COUNTY PROJECT NO.
BELL BLVD. SR 82 TO SUNRISE BLVD. SIDEWALK	6002

**CROSS SECTIONS  
BELL BOULEVARD (RT.)**

SHEET NO.  
**116**



Regular		Exc.	Embankment	
AREA	VOL.		AREA	VOL.
SF	CY		SF	CY
6	15		1	4
15			4	
3	2		1	1
0			0	
0			0	
2			1	
3	1			

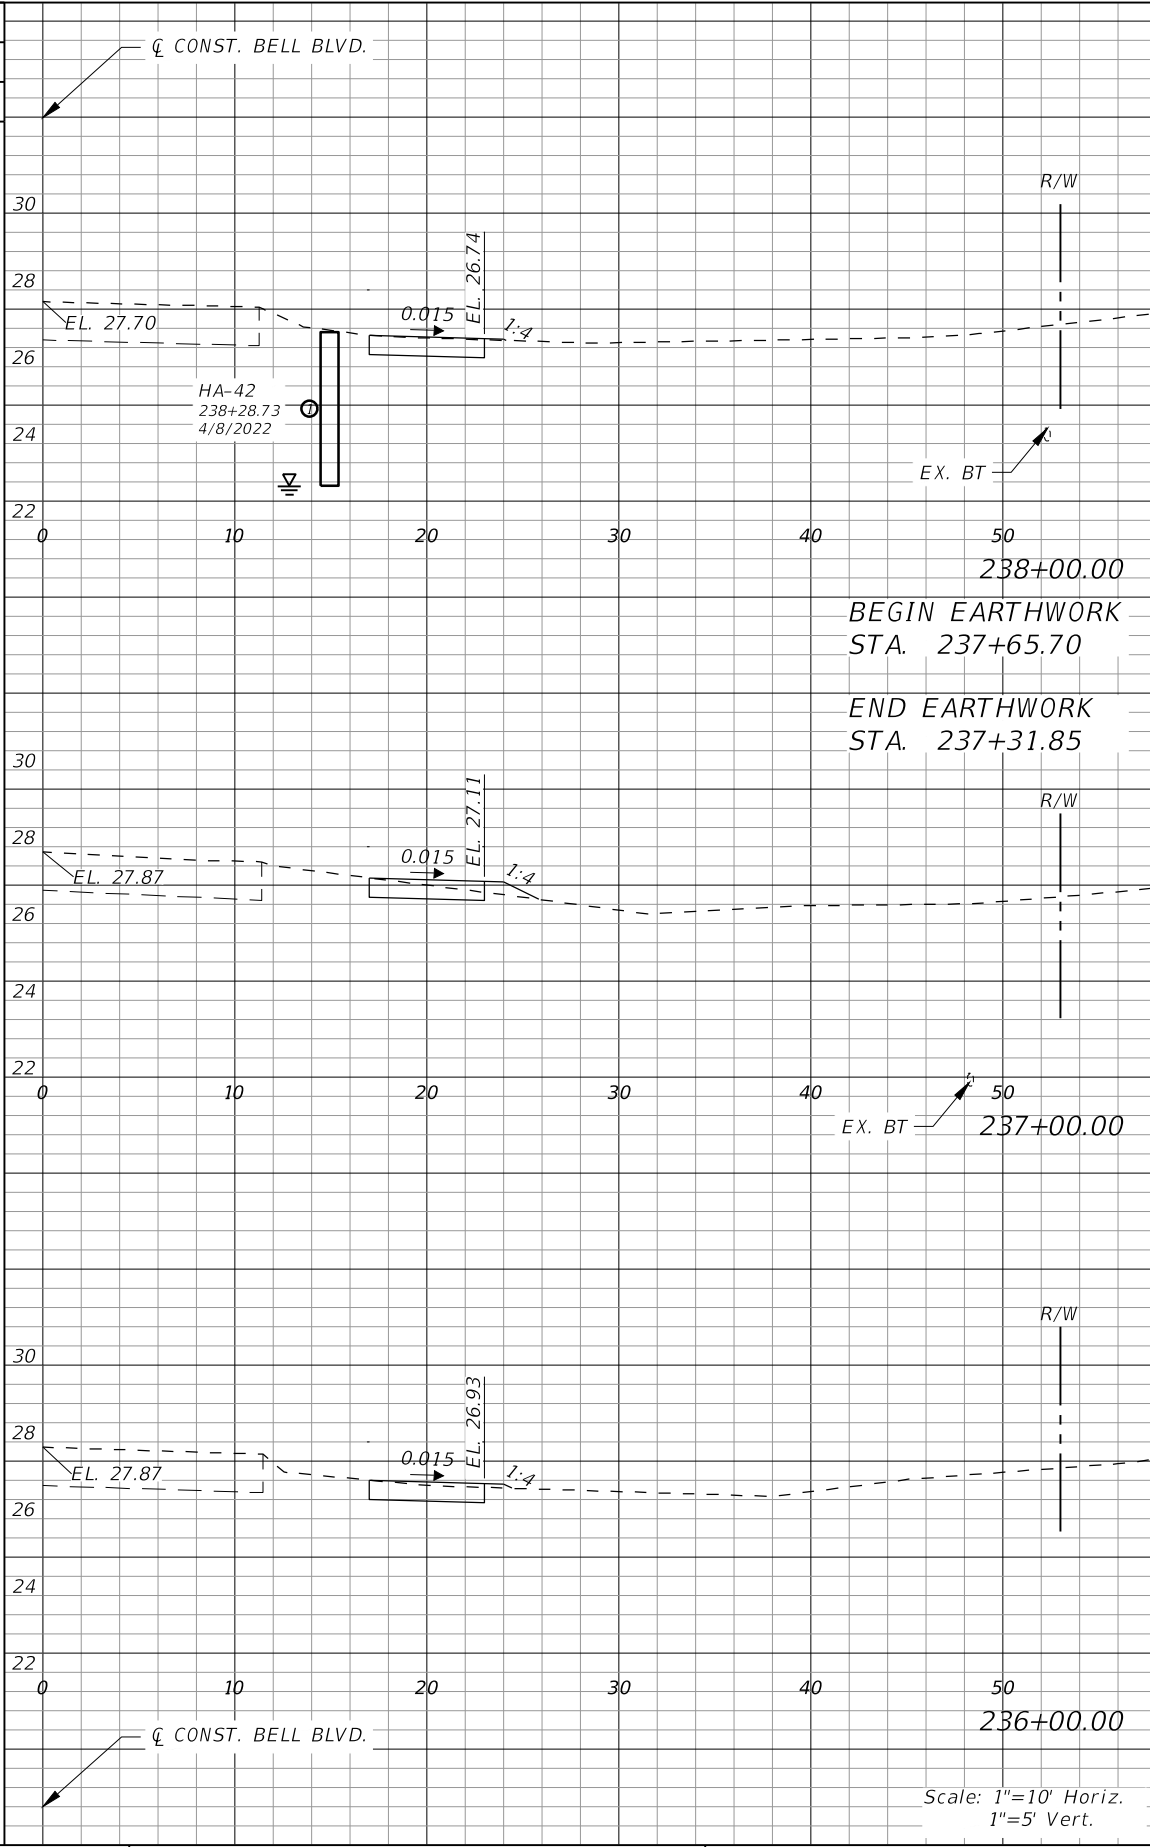

Regular		Exc.	Embankment	
AREA	VOL.		AREA	VOL.
SF	CY		SF	CY
3	11			4
0	2		1	1
0			0	
0			0	
1			0	
2			1	
3	9			3
3	1			

REVISIONS			
DATE	DESCRIPTION	DATE	DESCRIPTION



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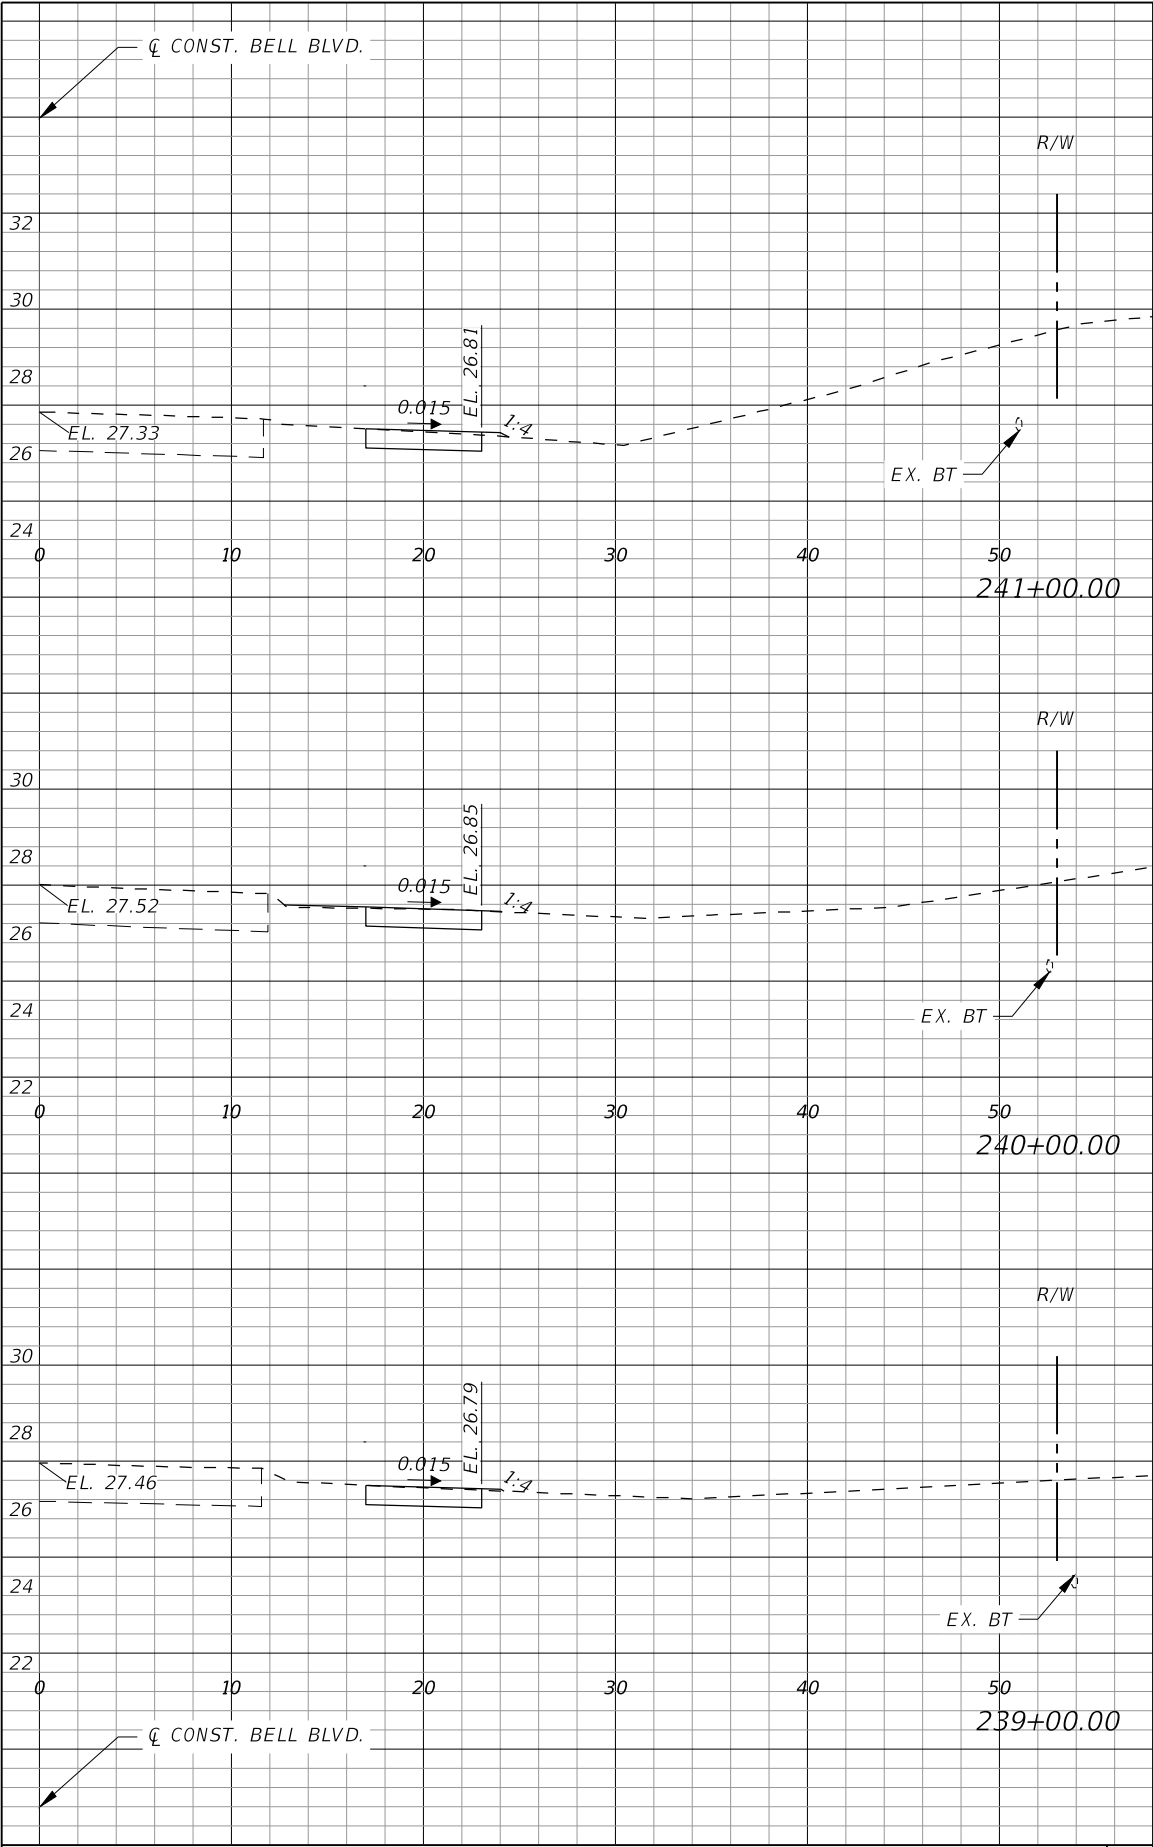
Q. Grady Minor and Associates, P.A.  
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Phone: 239.947.1144  
R. DANIEL FLYNN, P.E. NO. 76205

**LEE COUNTY**


ROAD NO.	COUNTY PROJECT NO.
BELL BLVD. SR 82 TO SUNRISE BLVD. SIDEWALK	6002

**CROSS SECTIONS  
BELL BOULEVARD (RT.)**

SHEET NO.  
**117**



Regular		Exc.	Embankment	
AREA	VOL.		AREA	VOL.
SF	CY		SF	CY
3	10		4	
11			4	
11			4	

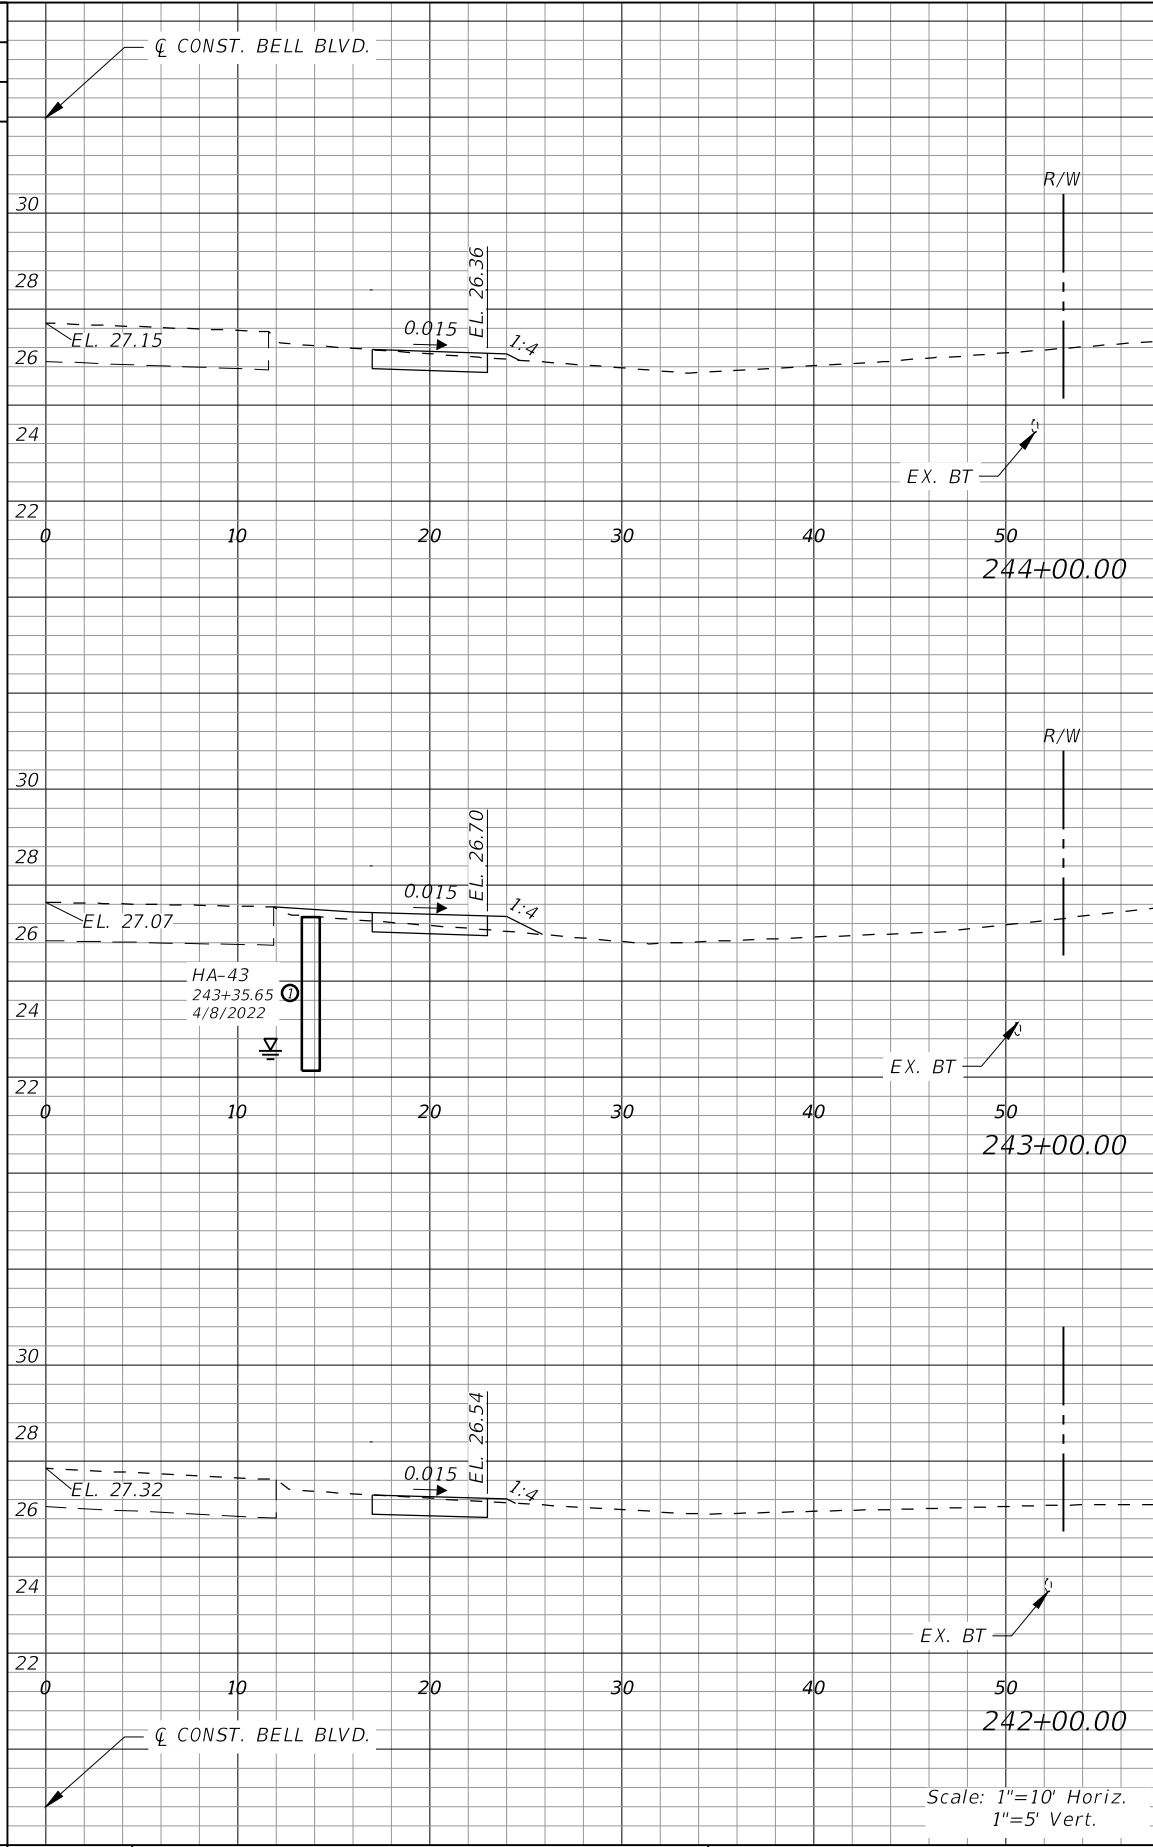

Regular		Exc.	Embankment	
AREA	VOL.		AREA	VOL.
SF	CY		SF	CY
3	10		4	
3			1	
1	7		5	
1			2	
3	7		5	
3			1	

REVISIONS			
DATE	DESCRIPTION	DATE	DESCRIPTION



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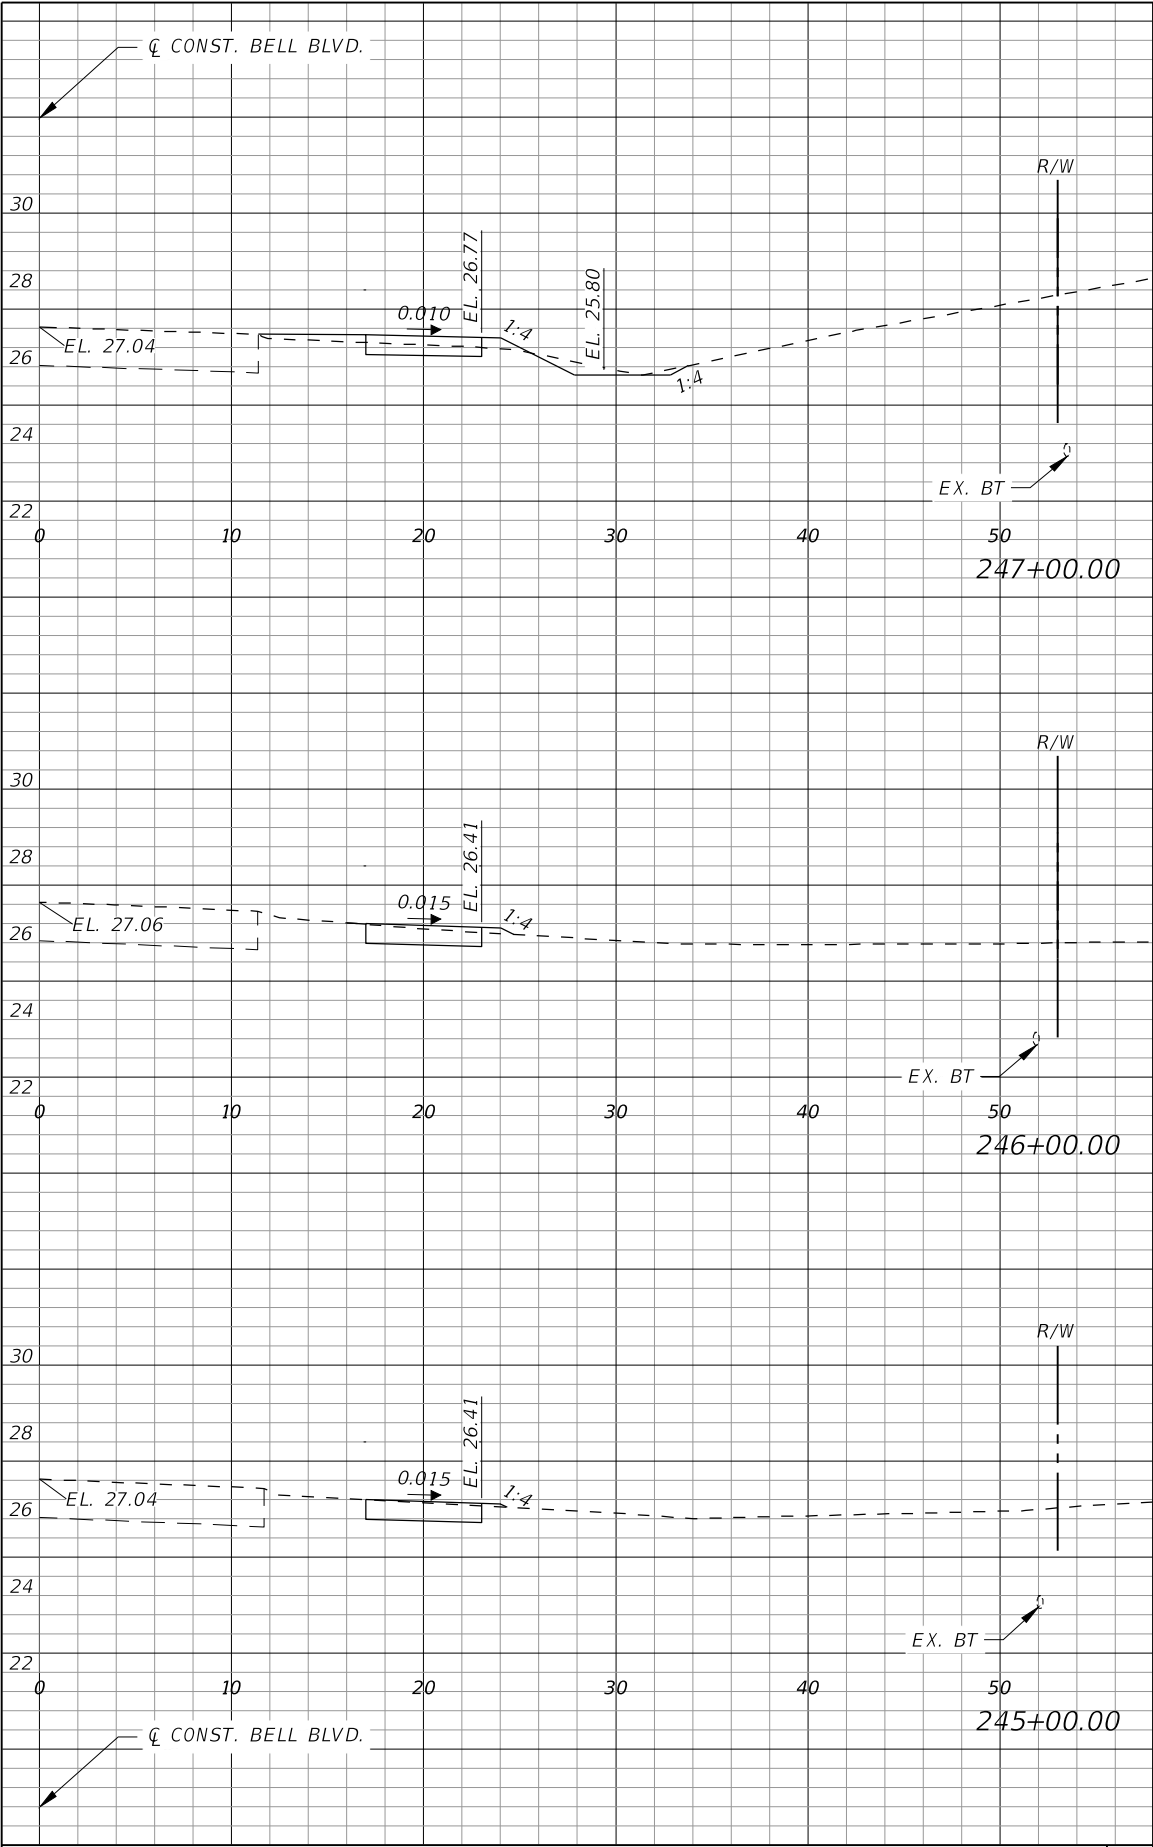
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Bonita Springs, Florida 34134  
Phone: 239.947.1144  
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**LEE COUNTY**

ROAD NO.	COUNTY PROJECT NO.
BELL BLVD. SR 82 TO SUNRISE BLVD. SIDEWALK	6002


**CROSS SECTIONS  
BELL BOULEVARD (RT.)**

SHEET NO.  
**118**



REVISIONS			
DATE	DESCRIPTION	DATE	DESCRIPTION

Regular		Exc.	Embankment	
AREA	VOL.		AREA	VOL.
SF	CY		SF	CY
3	9	1	4	
3	10	1	4	
3	10	1	4	

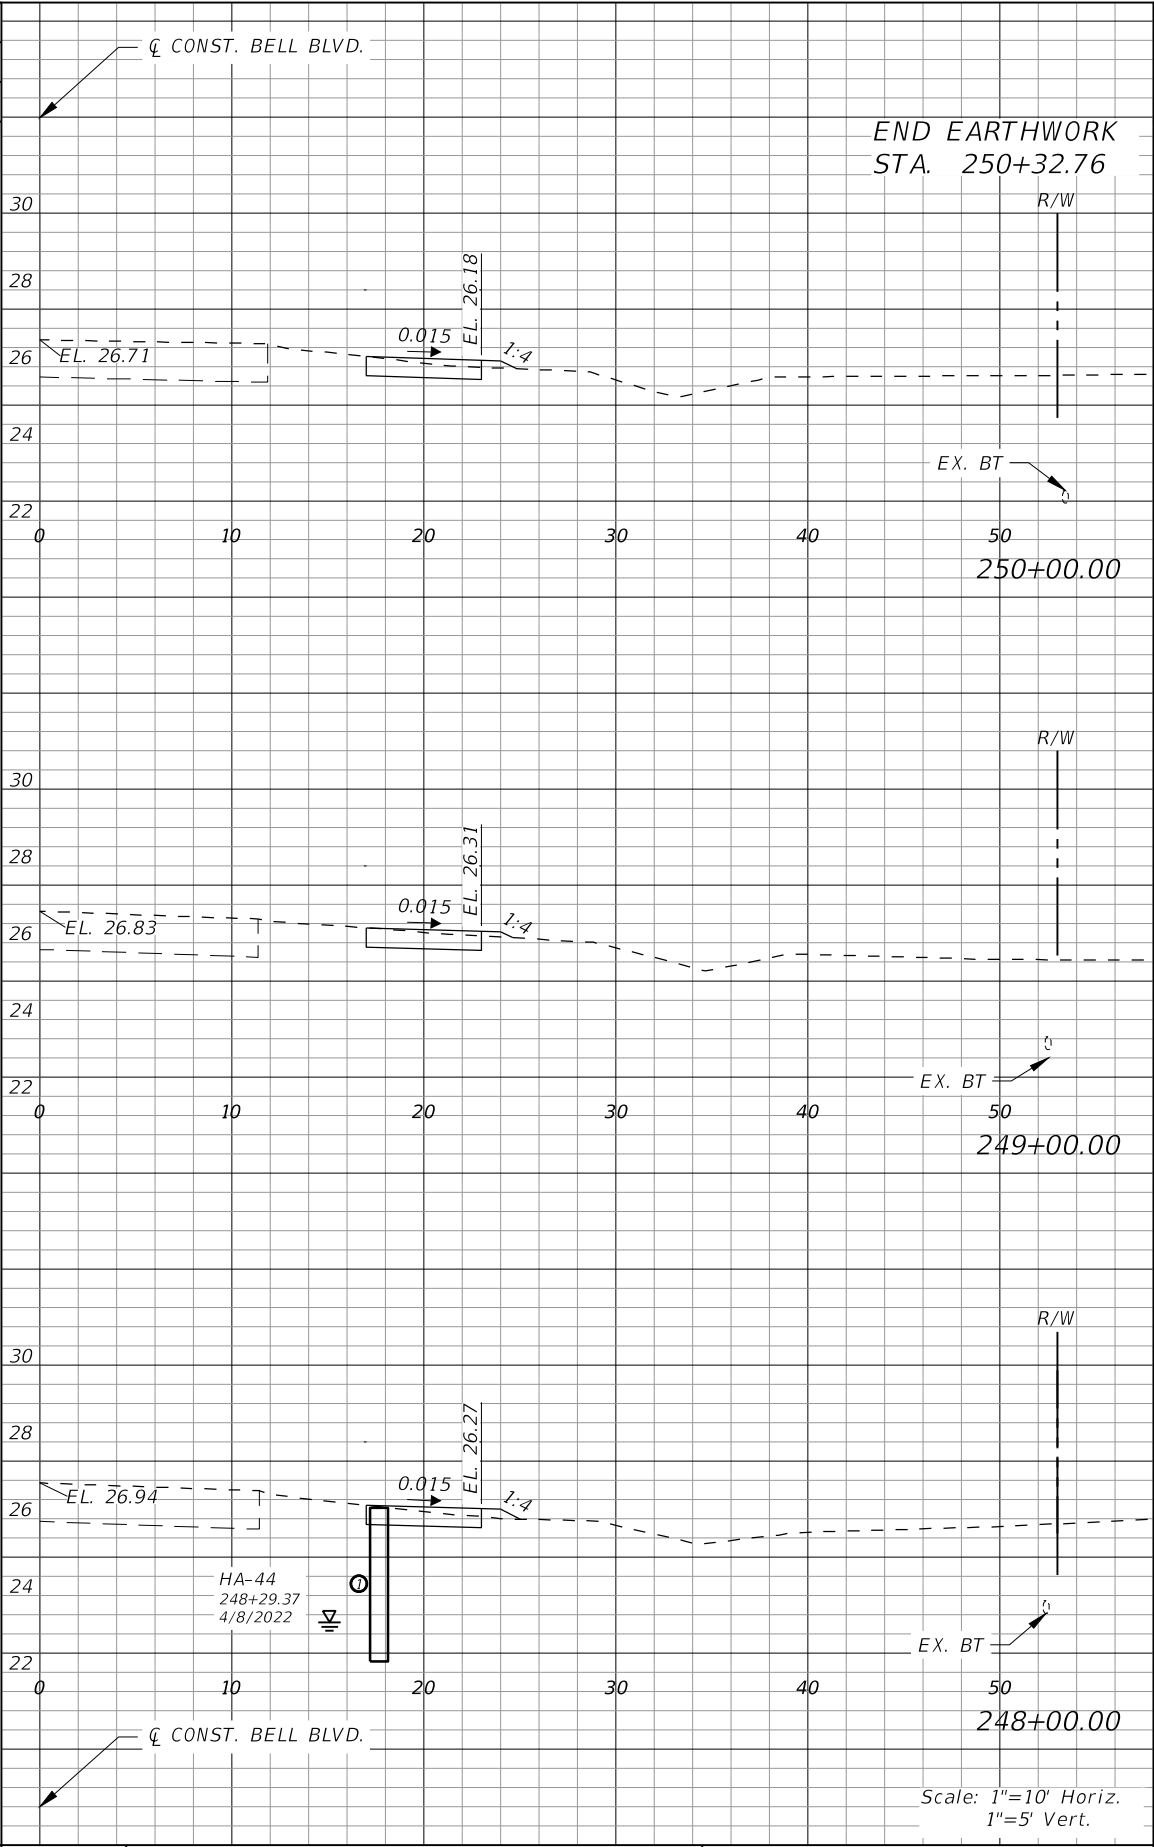

Regular		Exc.	Embankment	
AREA	VOL.		AREA	VOL.
SF	CY		SF	CY
2	1	1	1	
3	9	1	4	
2	1	1	4	

LEE COUNTY	
ROAD NO.	COUNTY PROJECT NO.
BELL BLVD. SR 82 TO SUNRISE BLVD. SIDEWALK	6002

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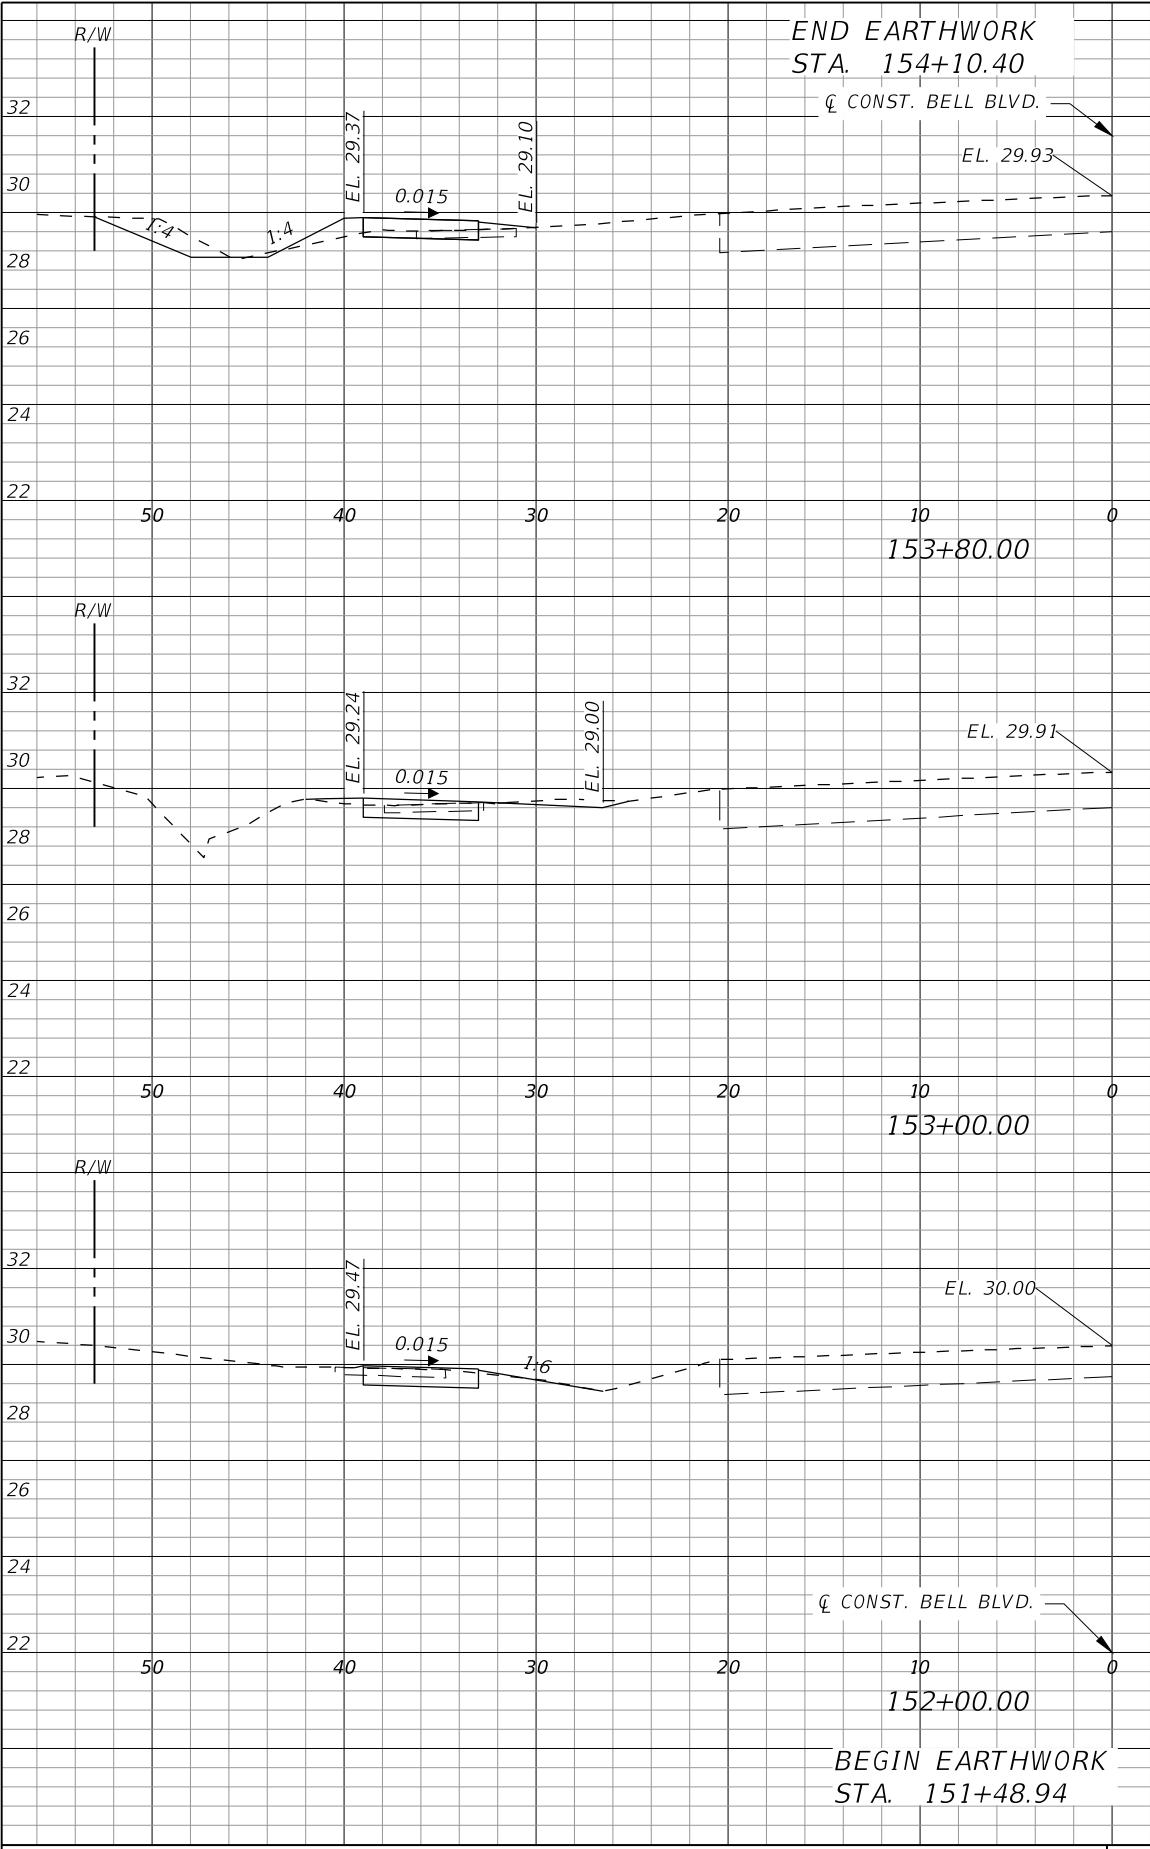
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CROSS SECTIONS  
BELL BOULEVARD (RT.)


SHEET NO.

119





Regular		Exc.	Embankment	
AREA	VOL.		AREA	VOL.
SF	CY		SF	CY
0	3		0	2
4	2			
10	10		10	10
1	3			
8	8		8	8
3	1			
3			1	
0	0			

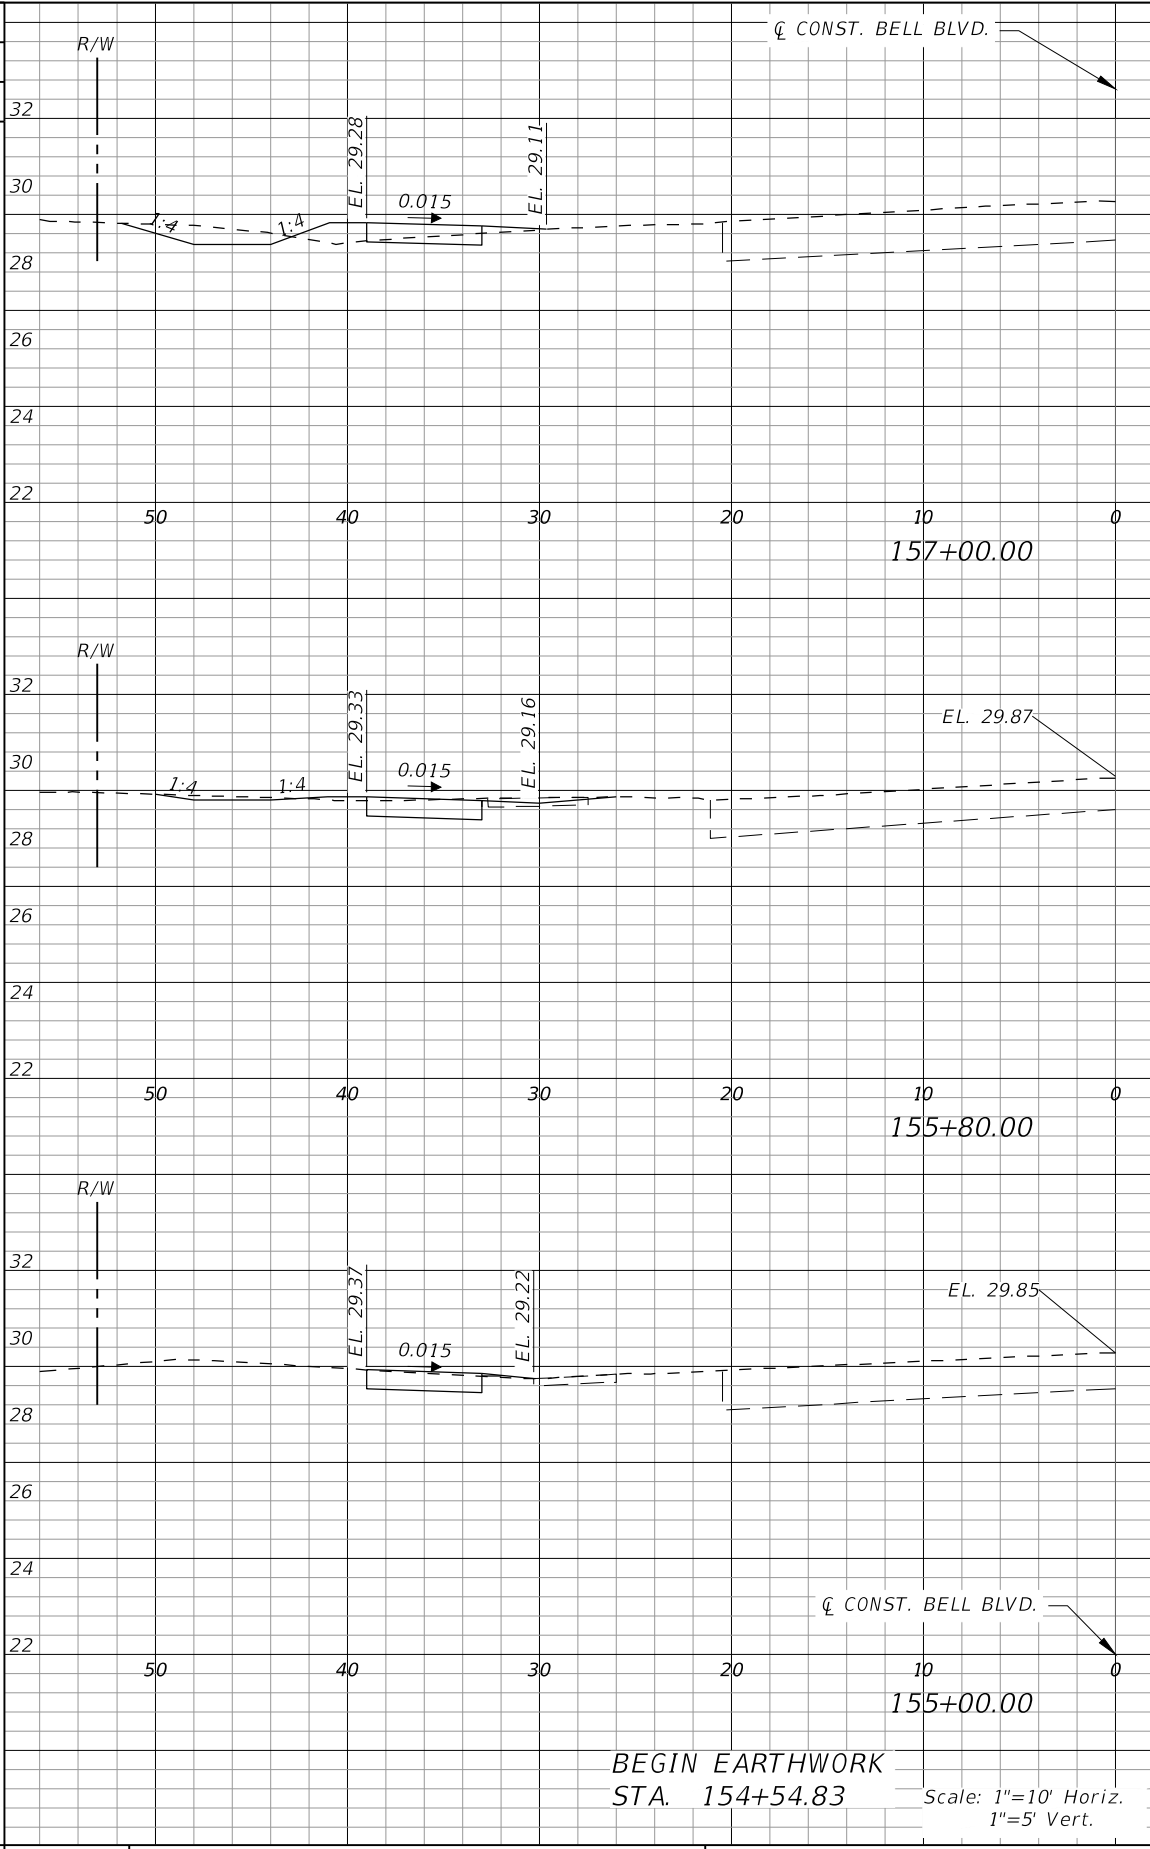

Regular		Exc.	Embankment	
AREA	VOL.		AREA	VOL.
SF	CY		SF	CY
	10			10
4	2			
	12			8
2	2			
	8		8	8
2	1			
	2			1
0	0			

REVISIONS			
DATE	DESCRIPTION	DATE	DESCRIPTION



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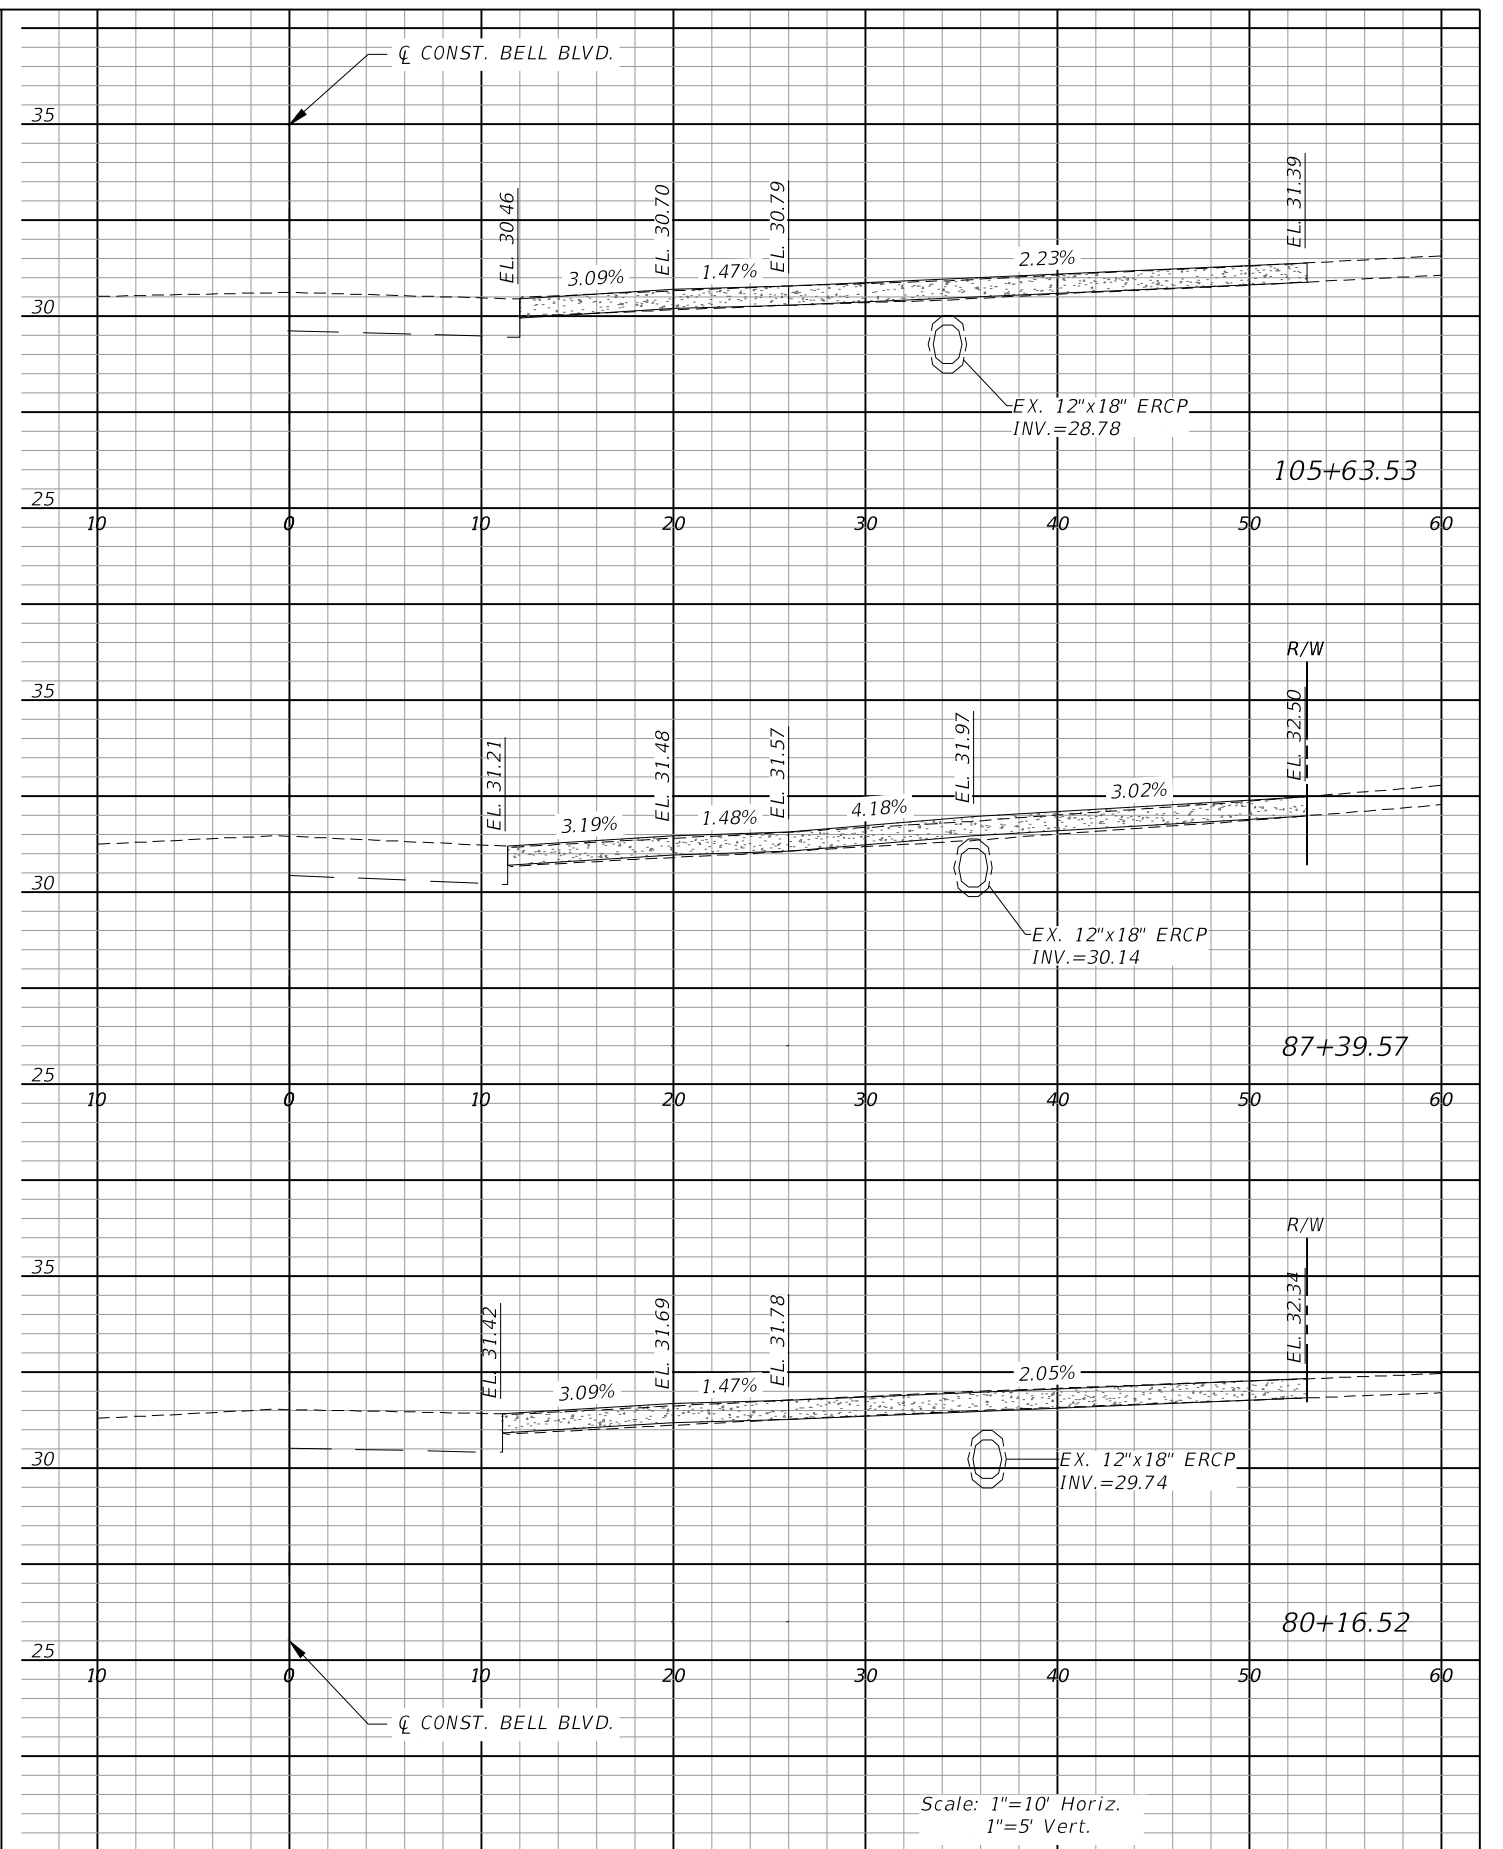
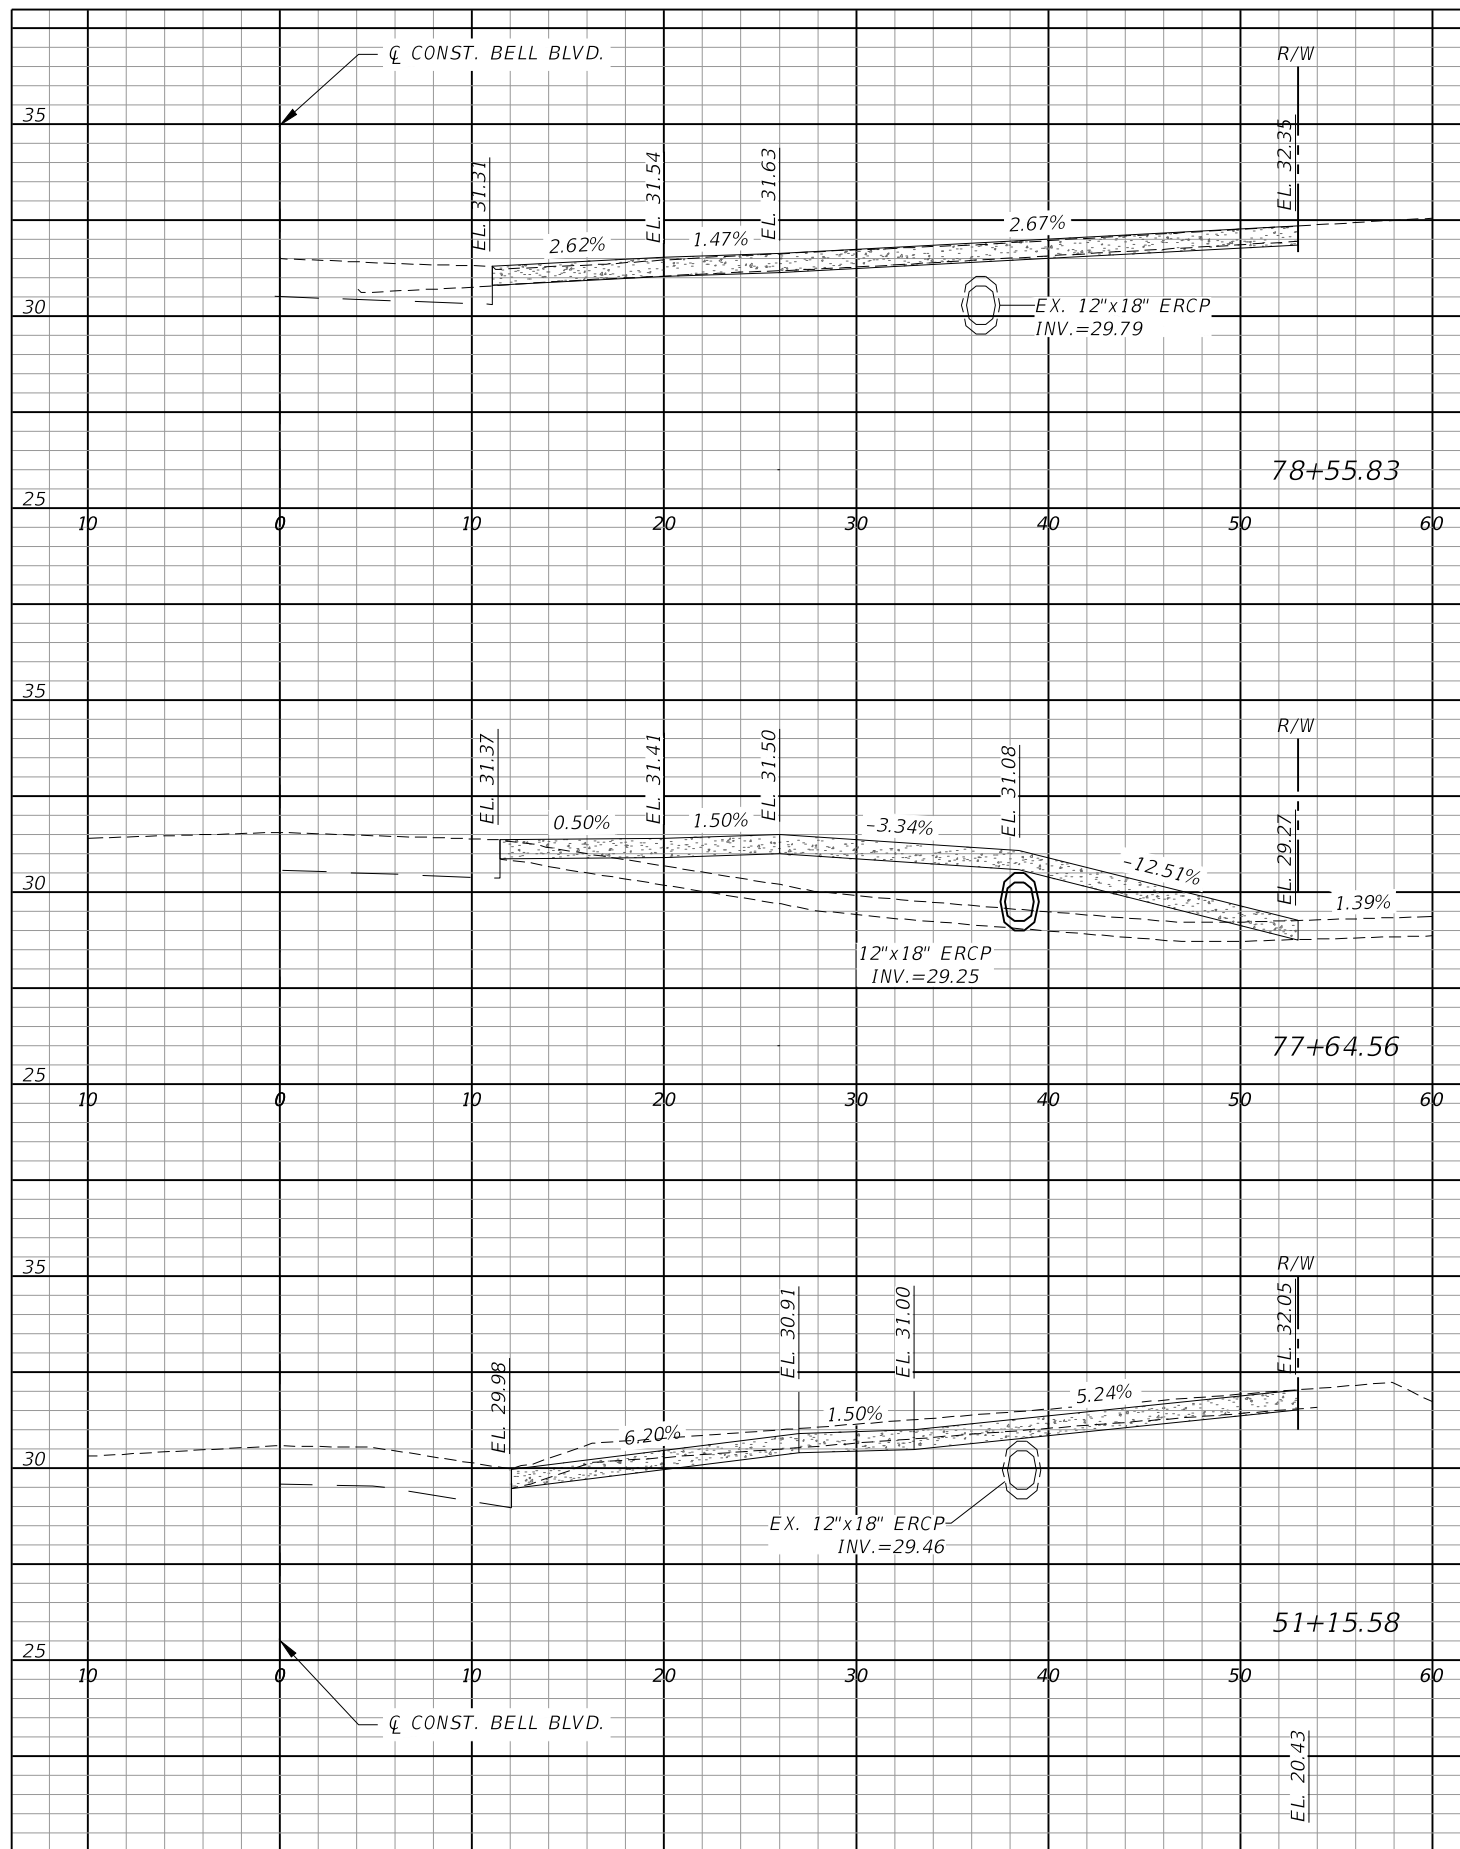
**LEE COUNTY**

ROAD NO.	COUNTY PROJECT NO.
BELL BLVD. SR 82 TO SUNRISE BLVD. SIDEWALK	6002

**CROSS SECTIONS  
BELL BOULEVARD (LT.)**

SHEET NO.  
**120**





Scale: 1"=10' Horiz.  
1"=5' Vert.



REVISIONS			
DATE	DESCRIPTION	DATE	DESCRIPTION

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R. DANIEL FLYNN, P.E. NO. 76205

LEE COUNTY	
ROAD NO.	COUNTY PROJECT NO.
BELL BLVD. SR 82 TO SUNRISE BLVD. SIDEWALK	6002

DRIVEWAY CROSS SECTIONS BELL BLVD. (1)	
SHEET NO.	122

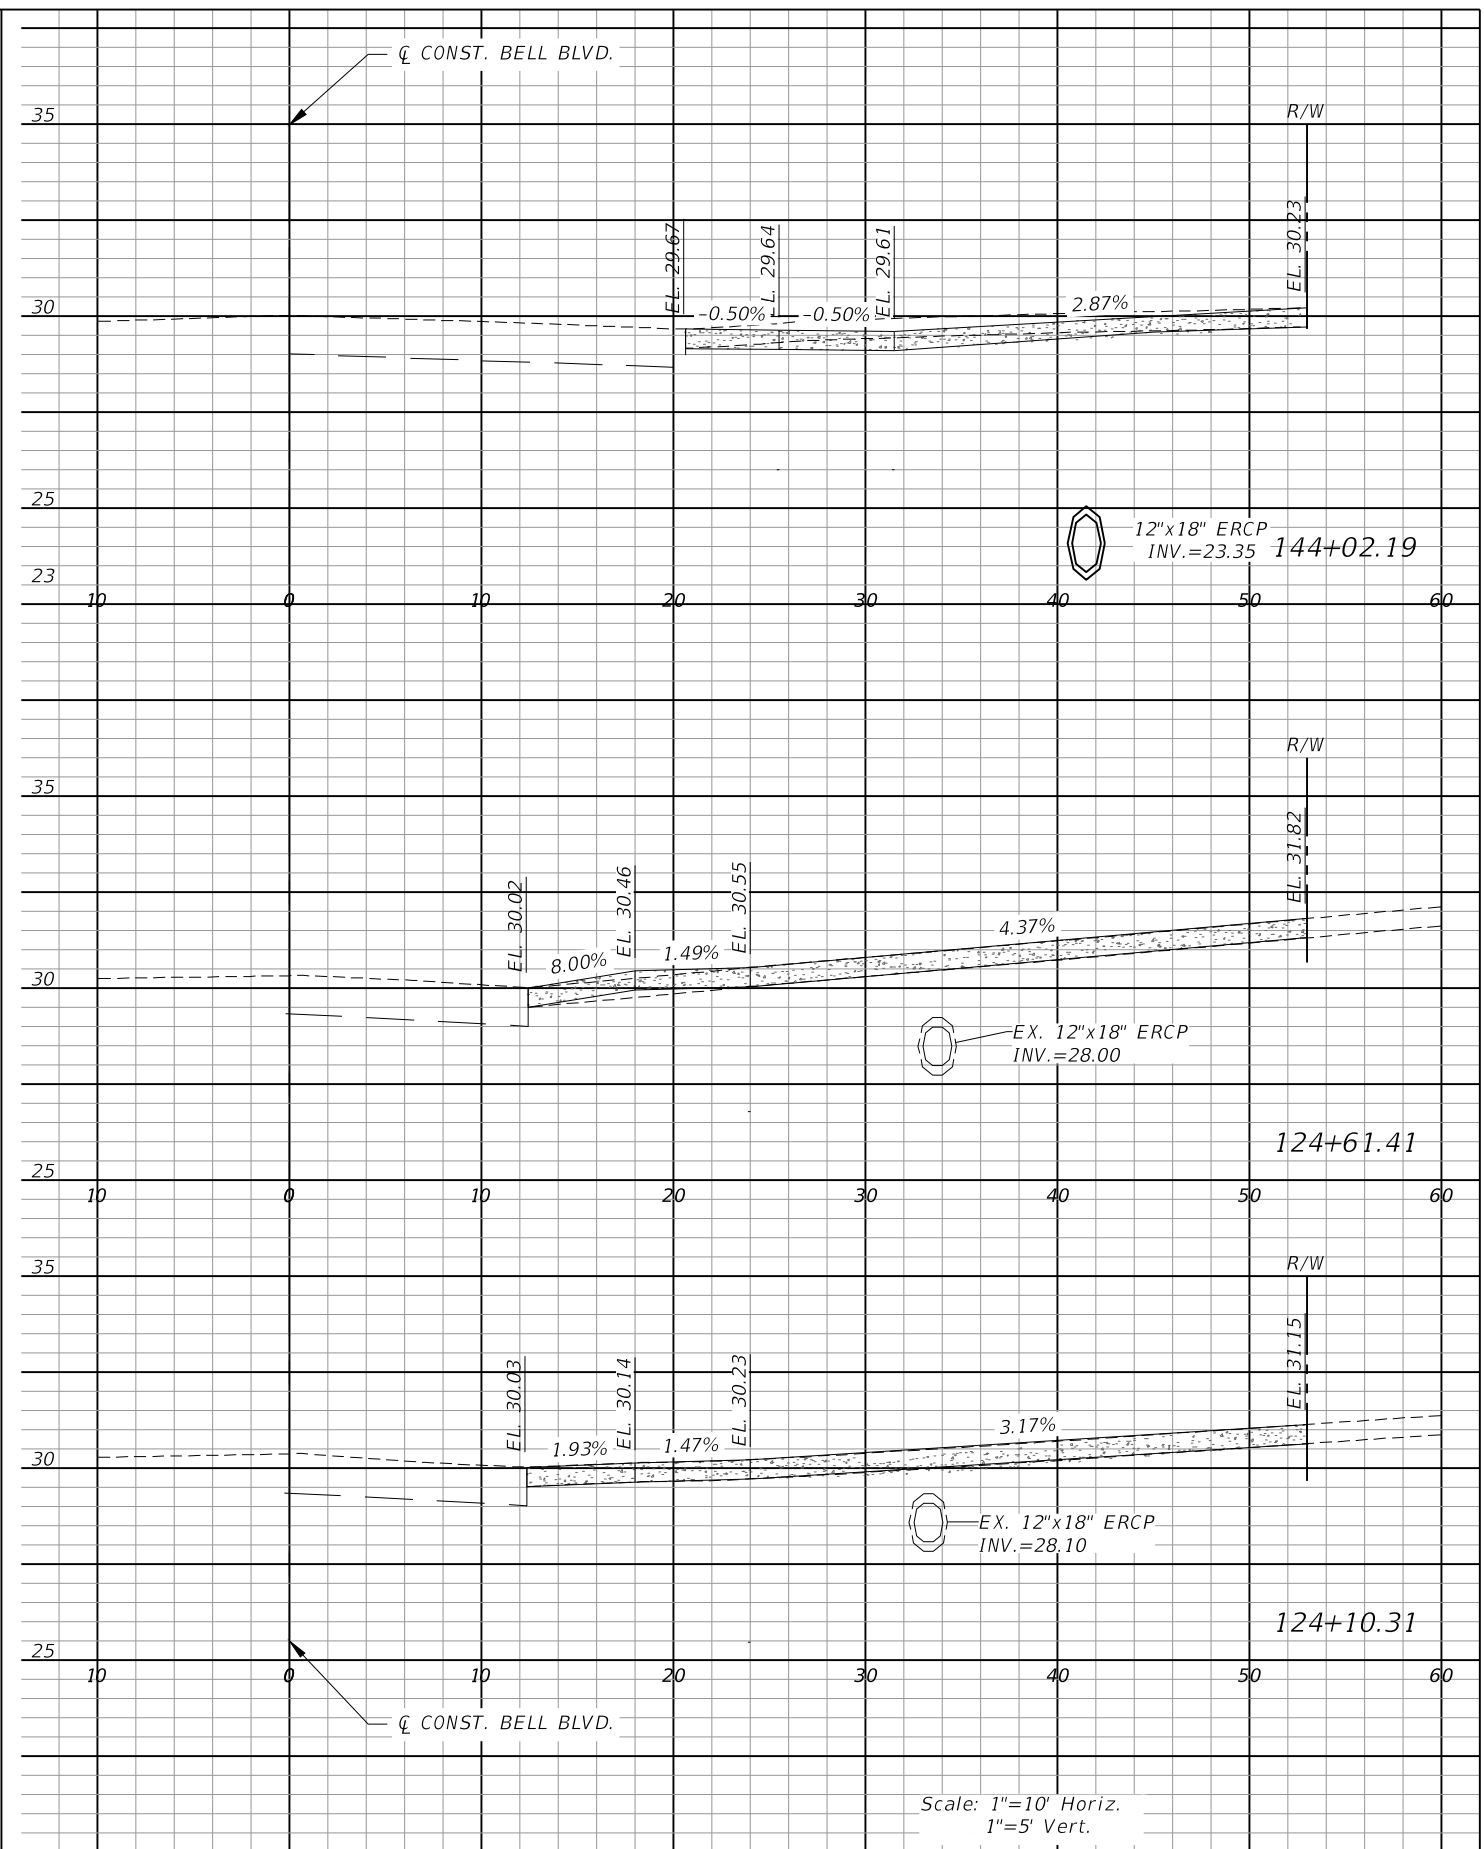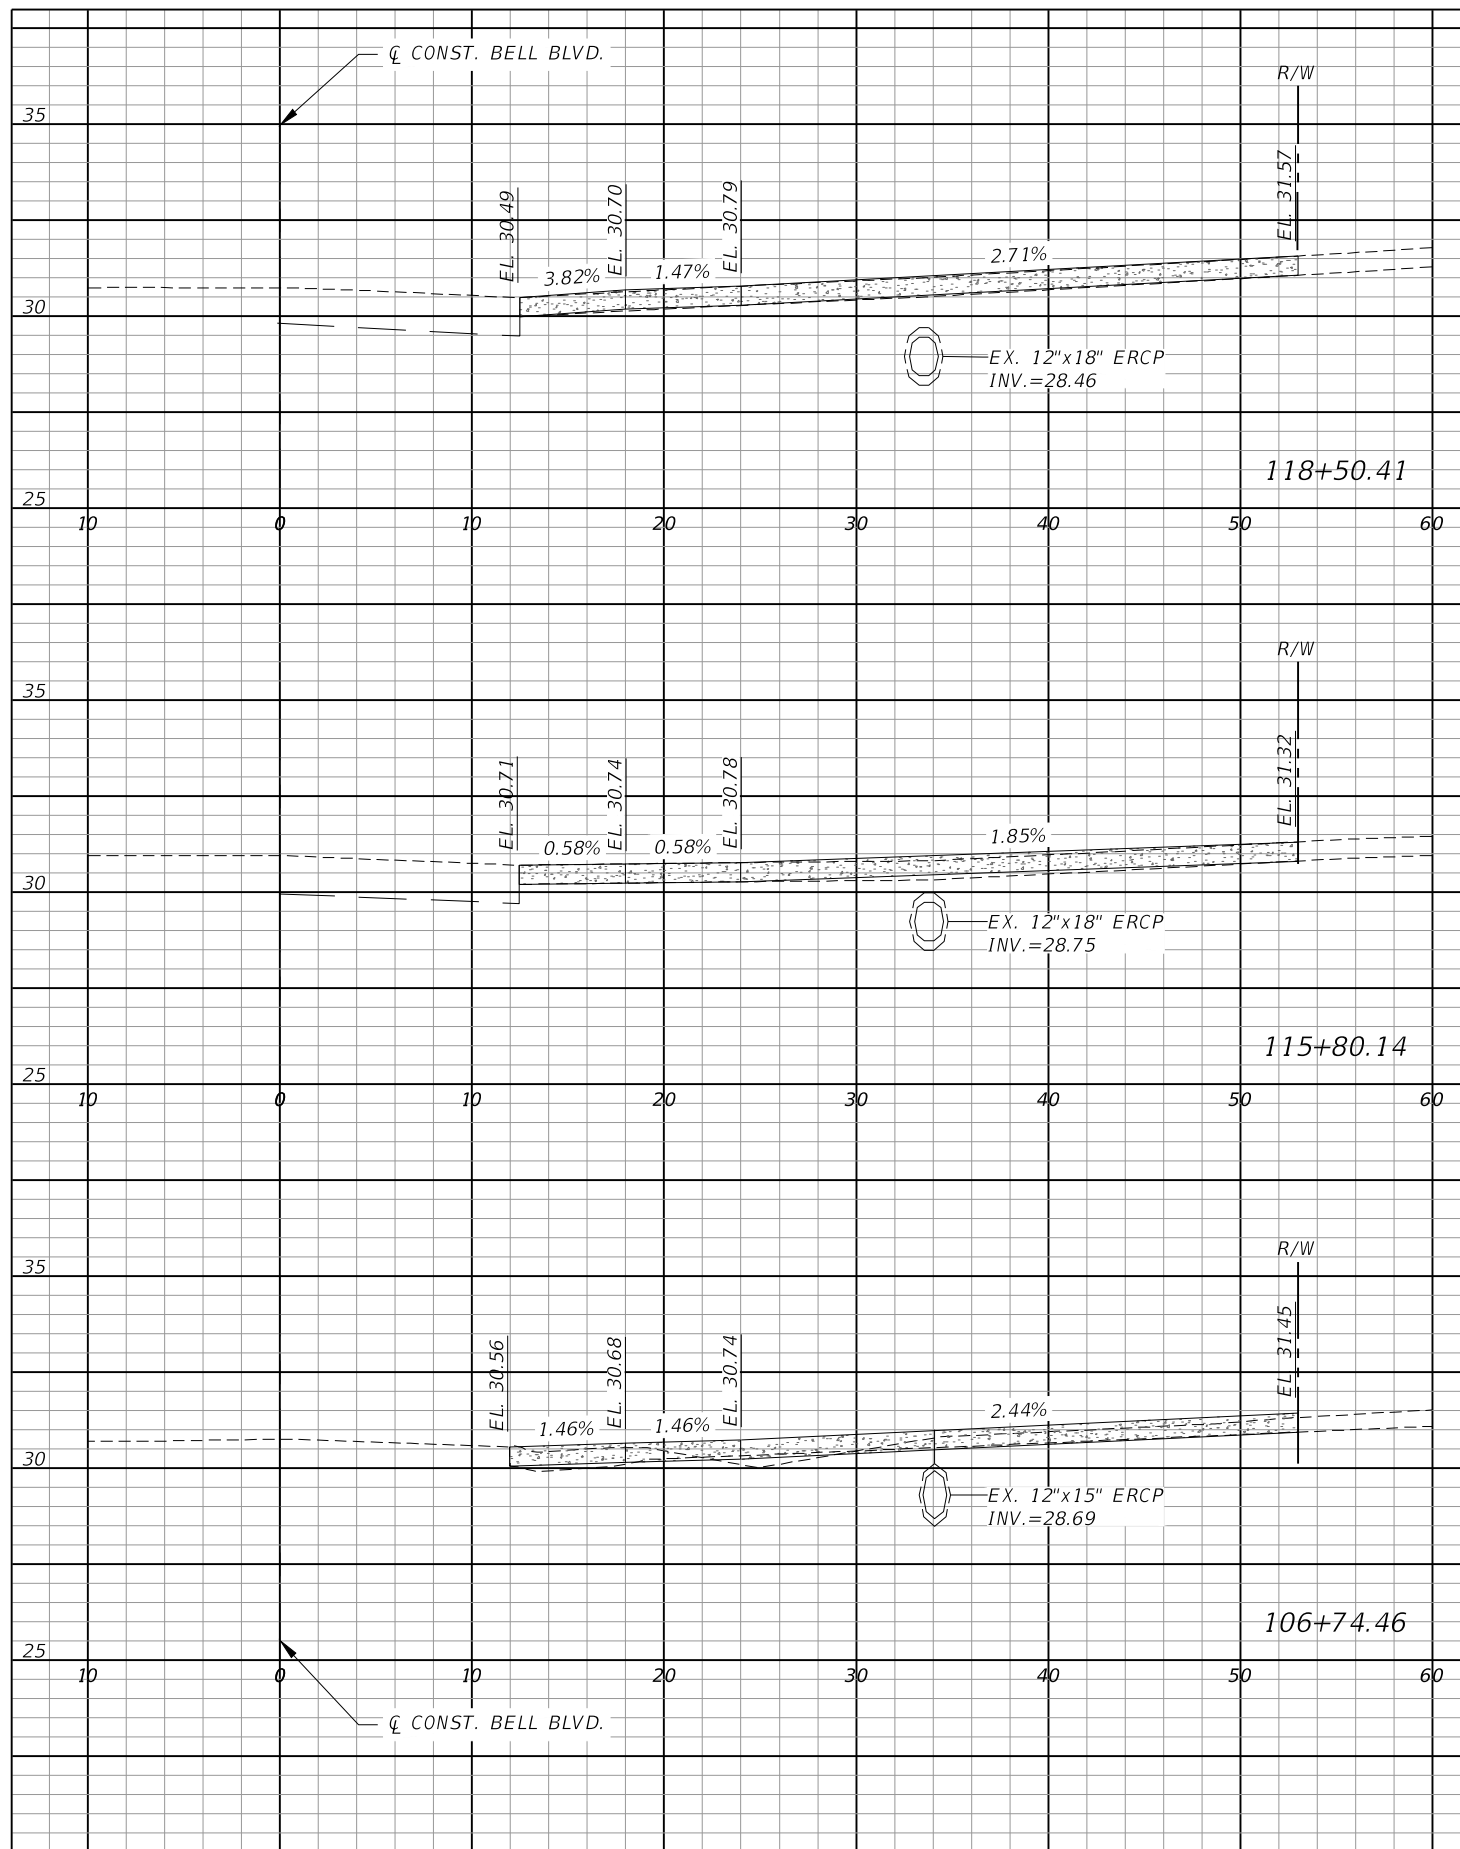

Scale: 1"=10' Horiz.  
1"=5' Vert.



REVISIONS			
DATE	DESCRIPTION	DATE	DESCRIPTION


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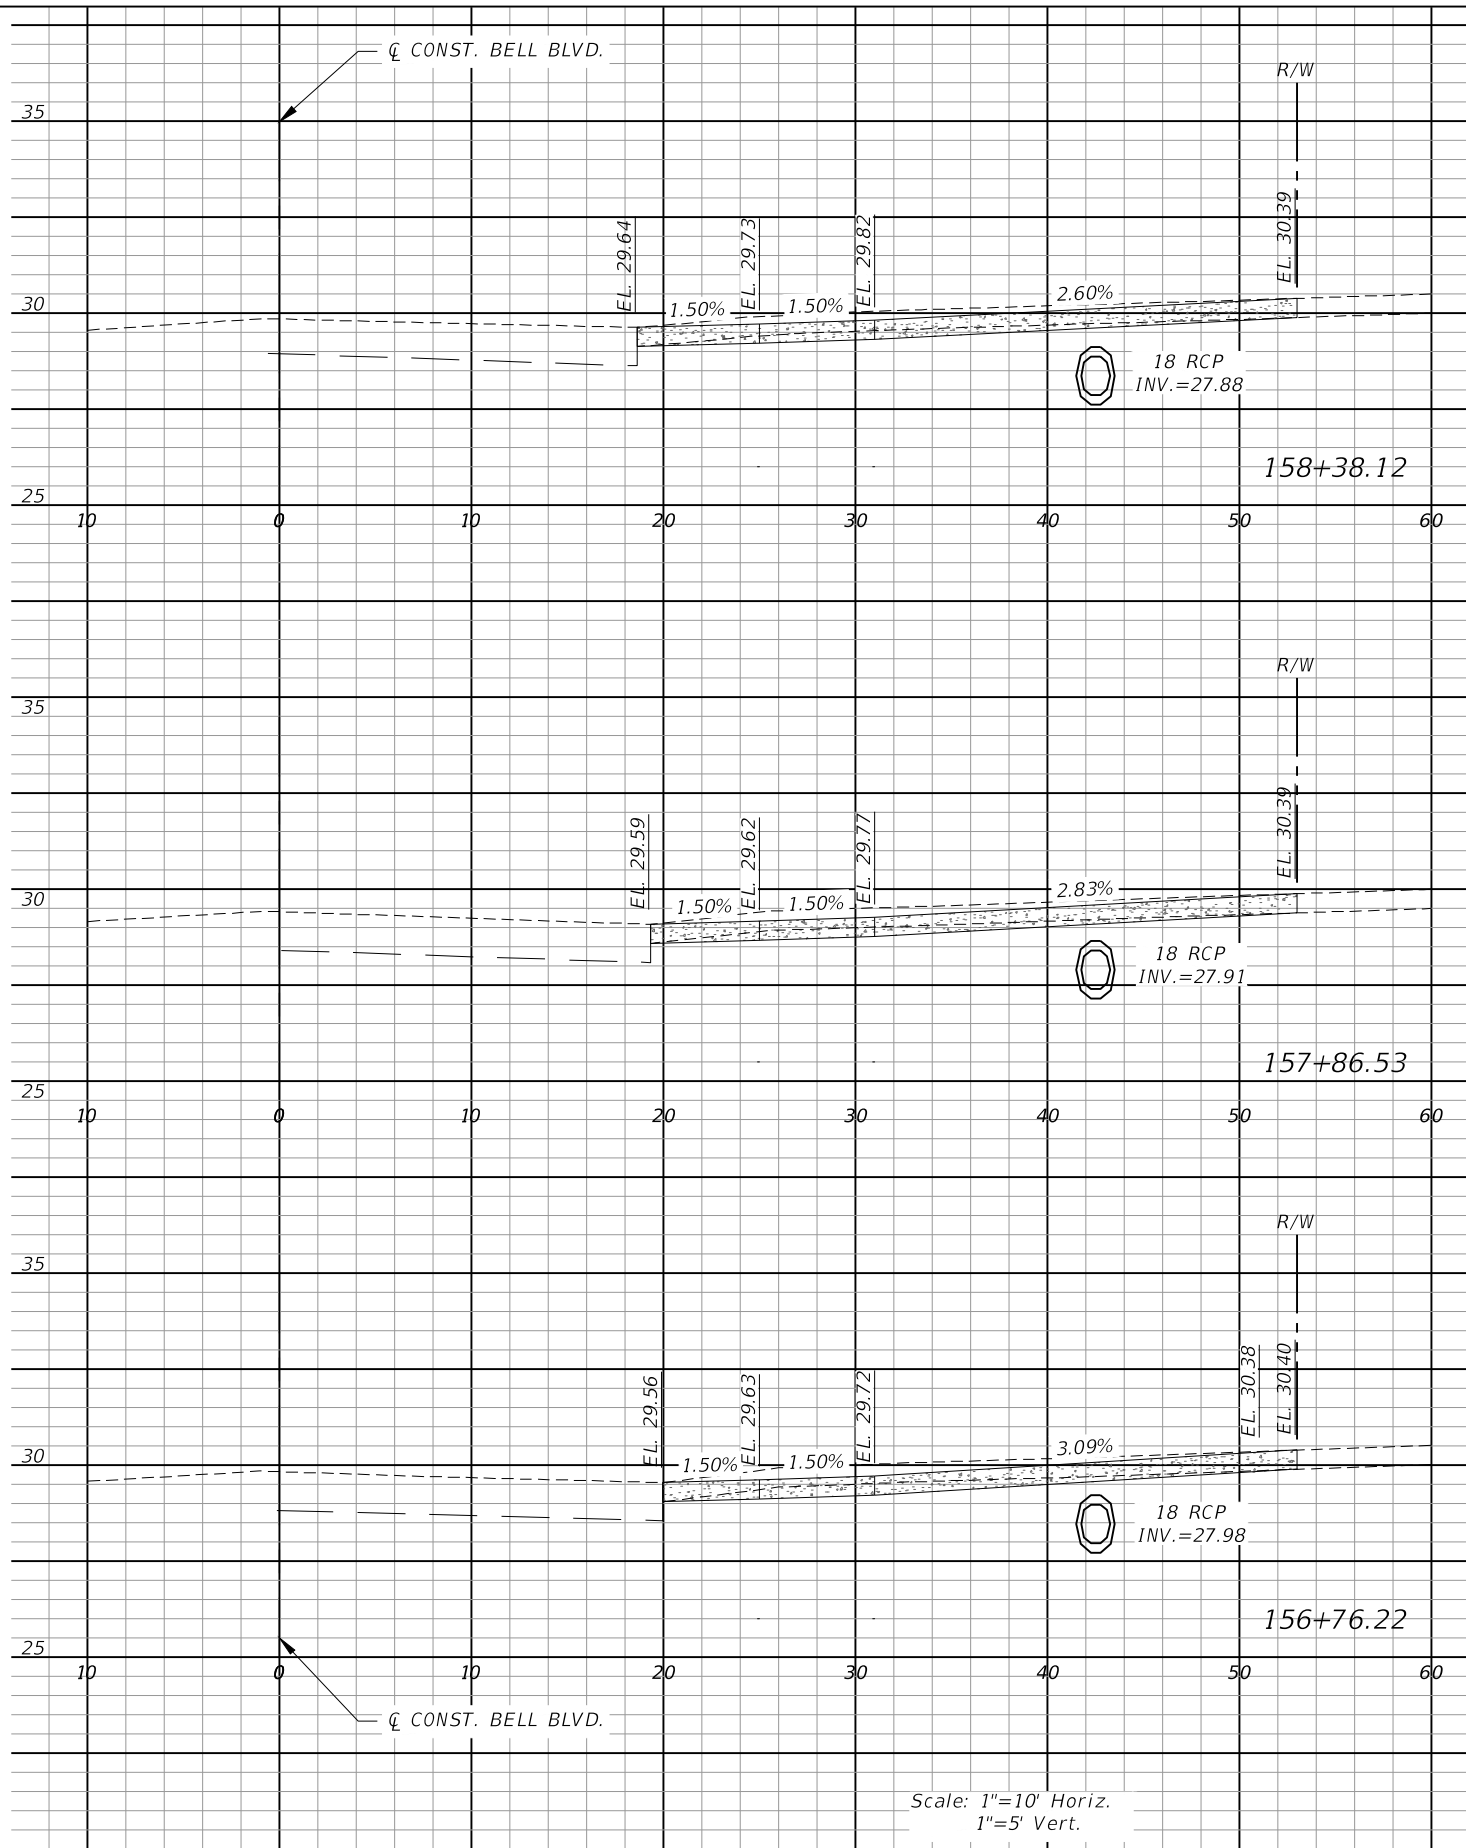
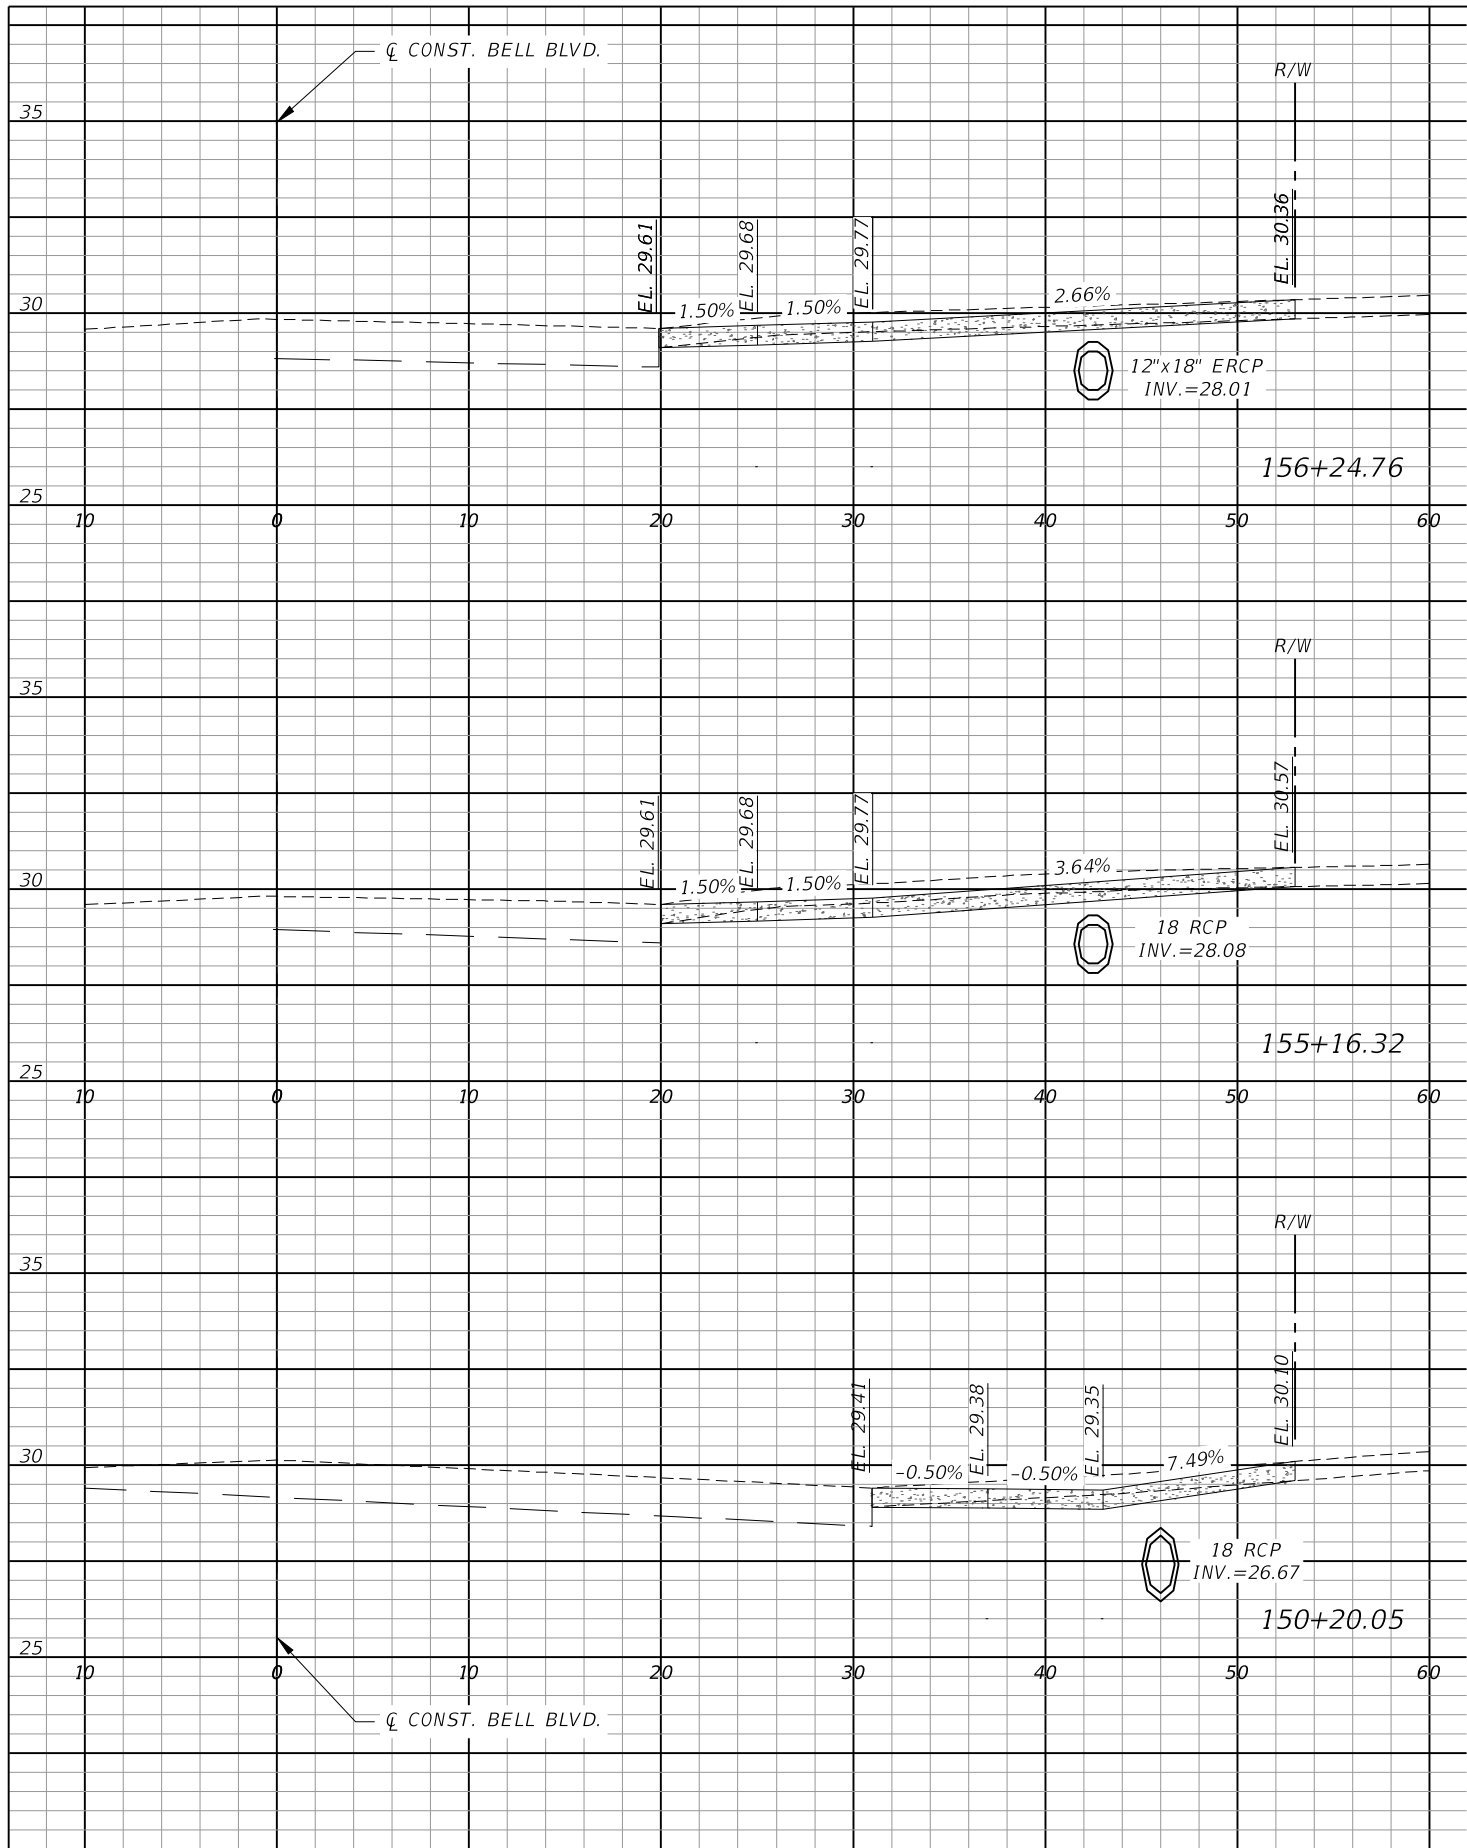
LEE COUNTY	
ROAD NO.	COUNTY PROJECT NO.
BELL BLVD. SR 82 TO SUNRISE BLVD. SIDEWALK	6002

DRIVEWAY CROSS SECTIONS BELL BLVD. (2)	
SHEET NO. 123	



Scale: 1"=10' Horiz.  
1"=5' Vert.

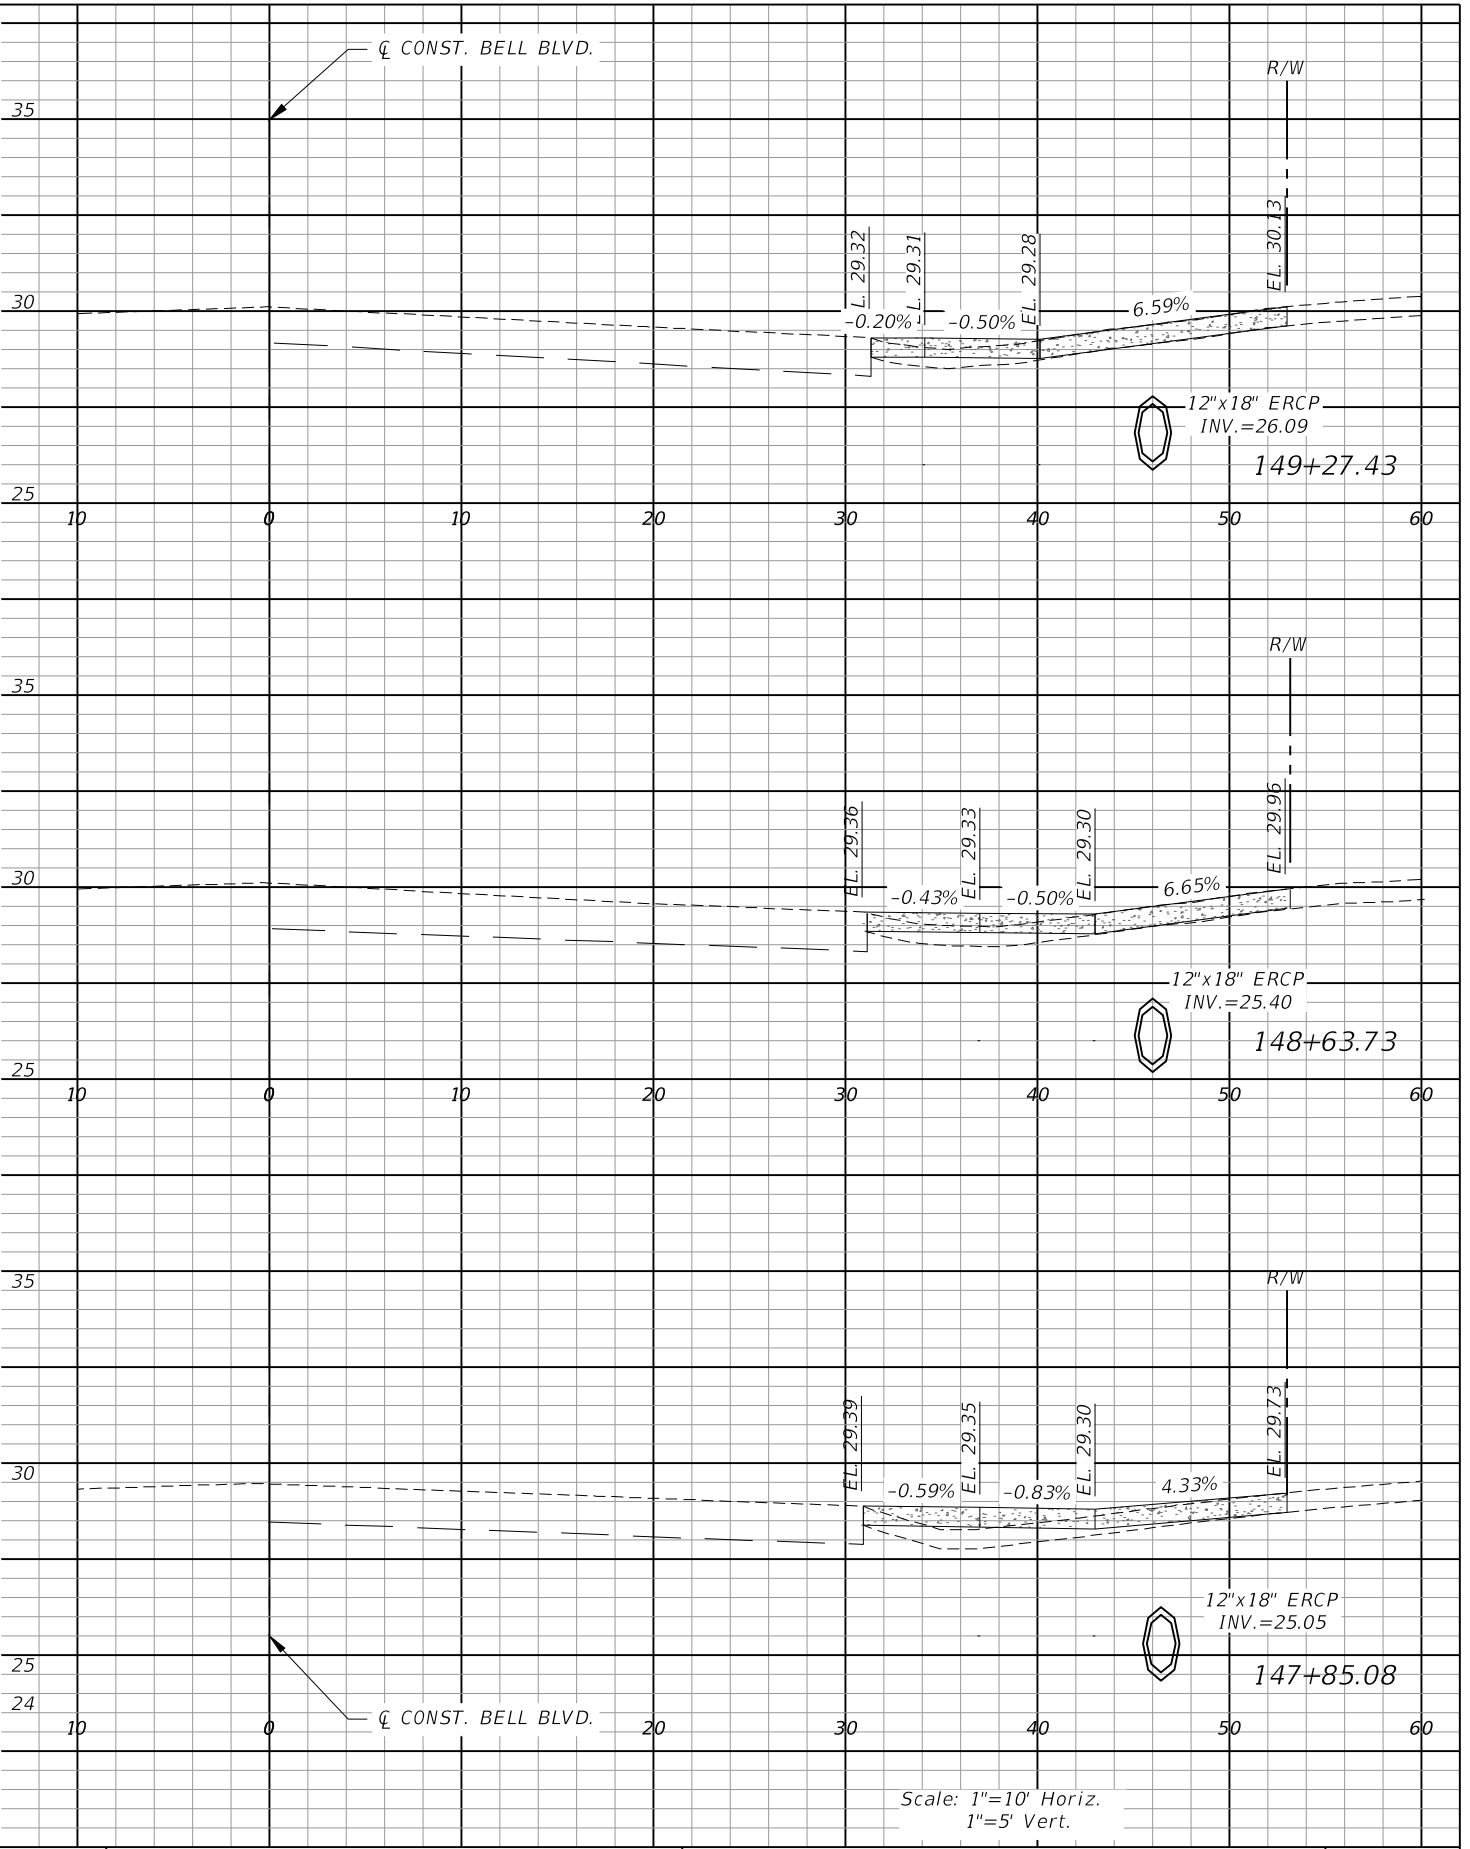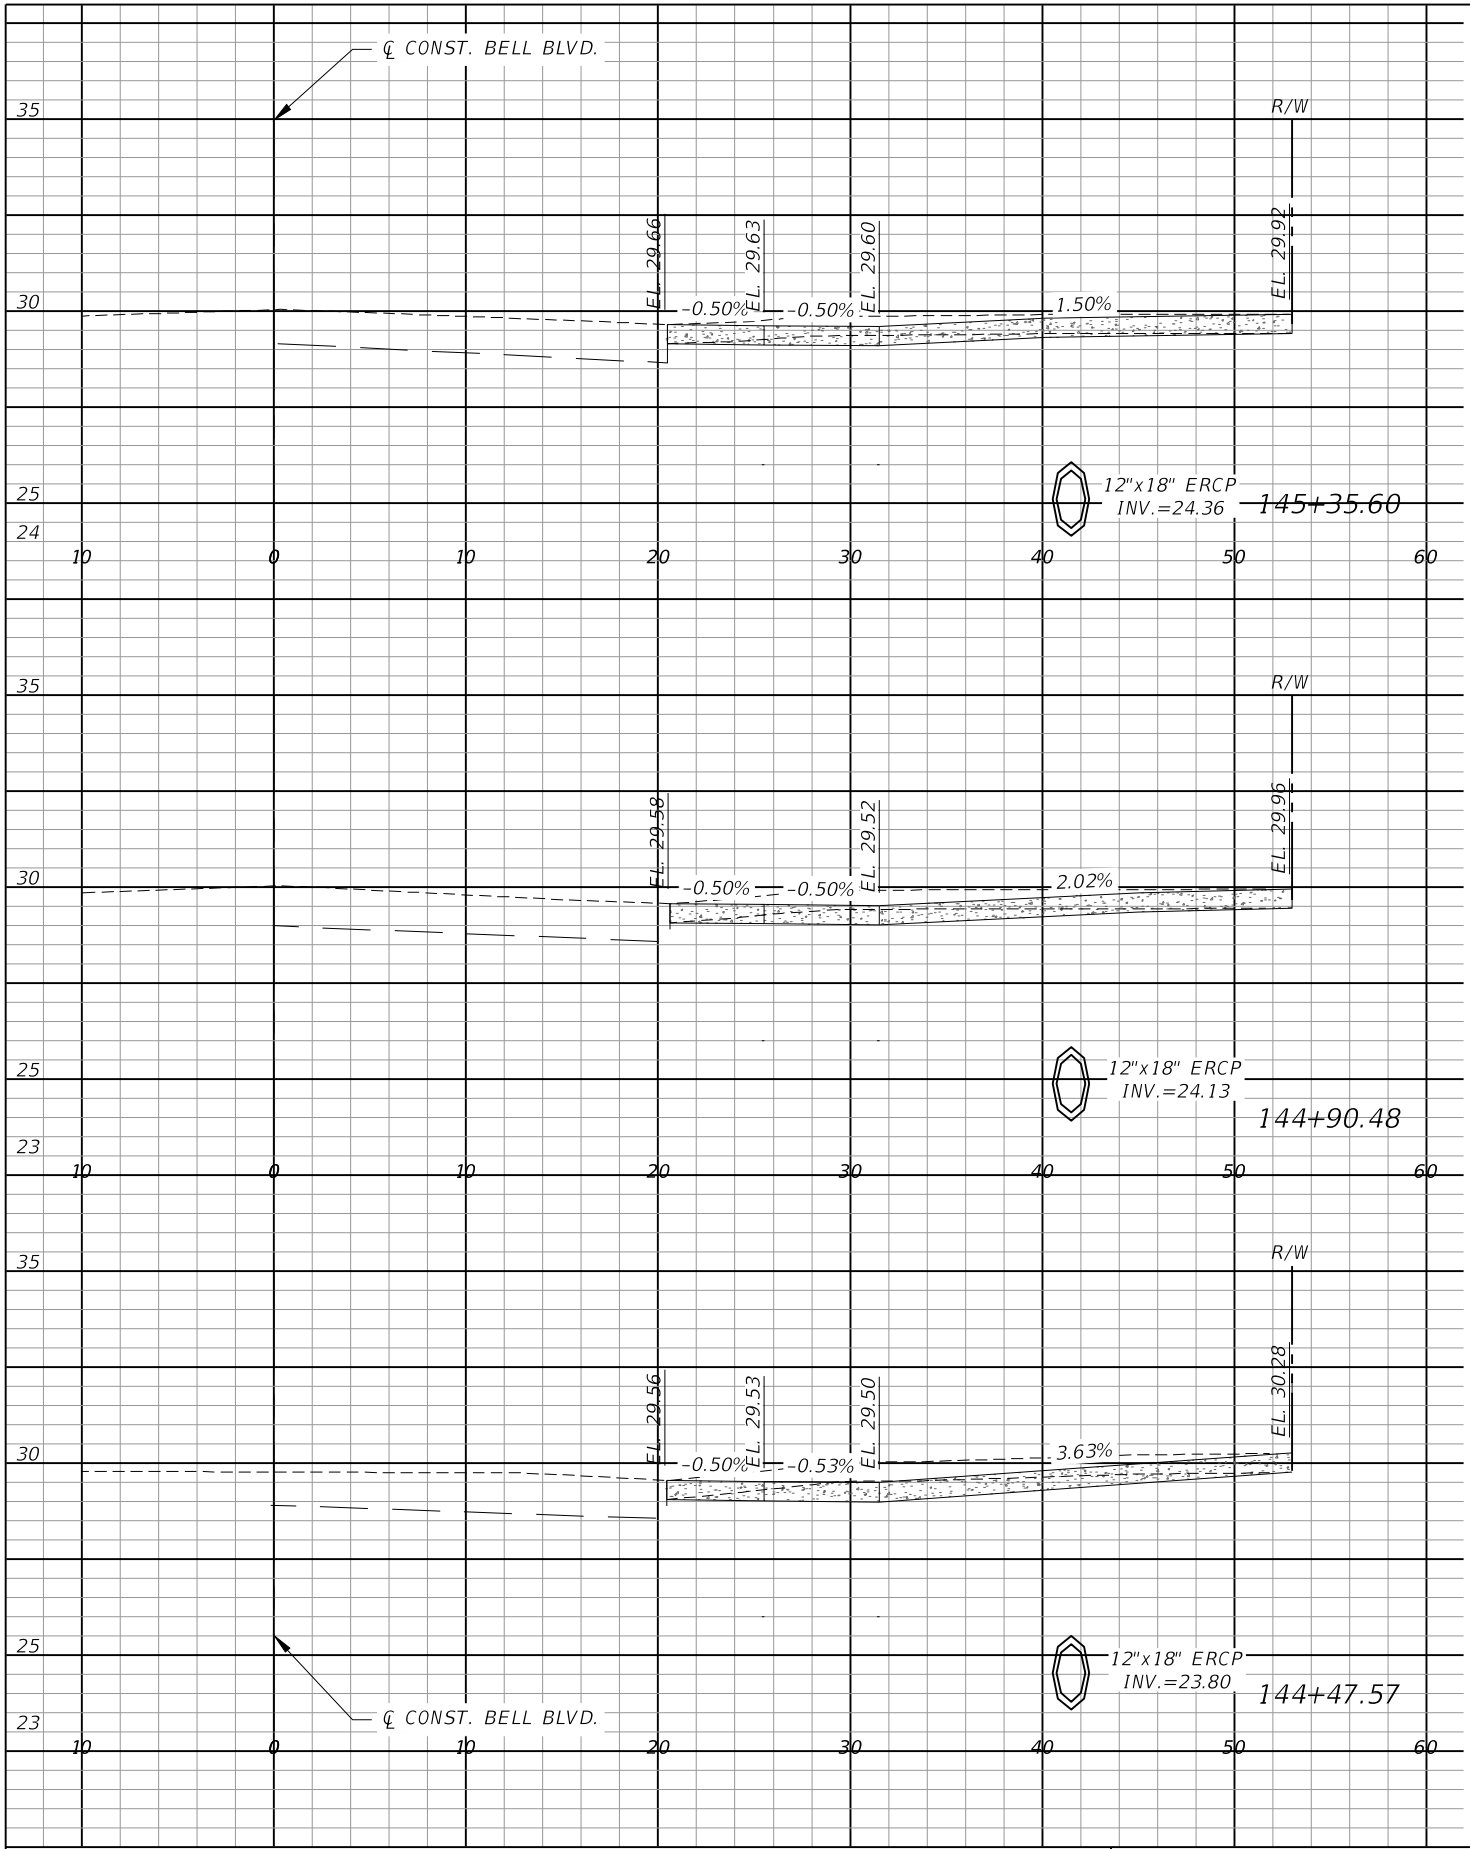REVISIONS				<div></div> <div>Q. Grady Minor and Associates, P.A. 3800 Via Del Rey Bonita Springs, Florida 34134 Phone: 239.947.1144 R. DANIEL FLYNN, P.E. NO. 76205</div> <div>GradyMinor</div> <div>Civil Engineers • Land Surveyors • Planners • Landscape Architects <small>Cert. of Auth. EB 0005151      Cert. of Auth. LB 0005151      Business Lic. 26000266</small></div>	LEE COUNTY		DRIVEWAY CROSS SECTIONS BELL BLVD. (3)	SHEET NO.
DATE	DESCRIPTION	DATE	DESCRIPTION		ROAD NO.	COUNTY PROJECT NO.		124
					BELL BLVD. SR 82 TO SUNRISE BLVD. SIDEWALK	6002		



Scale: 1"=10' Horiz.  
1"=5' Vert.

REVISIONS			
DATE	DESCRIPTION	DATE	DESCRIPTION



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LEE COUNTY	
ROAD NO.	COUNTY PROJECT NO.
BELL BLVD. SR 82 TO SUNRISE BLVD. SIDEWALK	6002


DRIVEWAY CROSS SECTIONS BELL BLVD. (4)	
SHEET NO.	125





Scale: 1"=10' Horiz.  
1"=5' Vert.

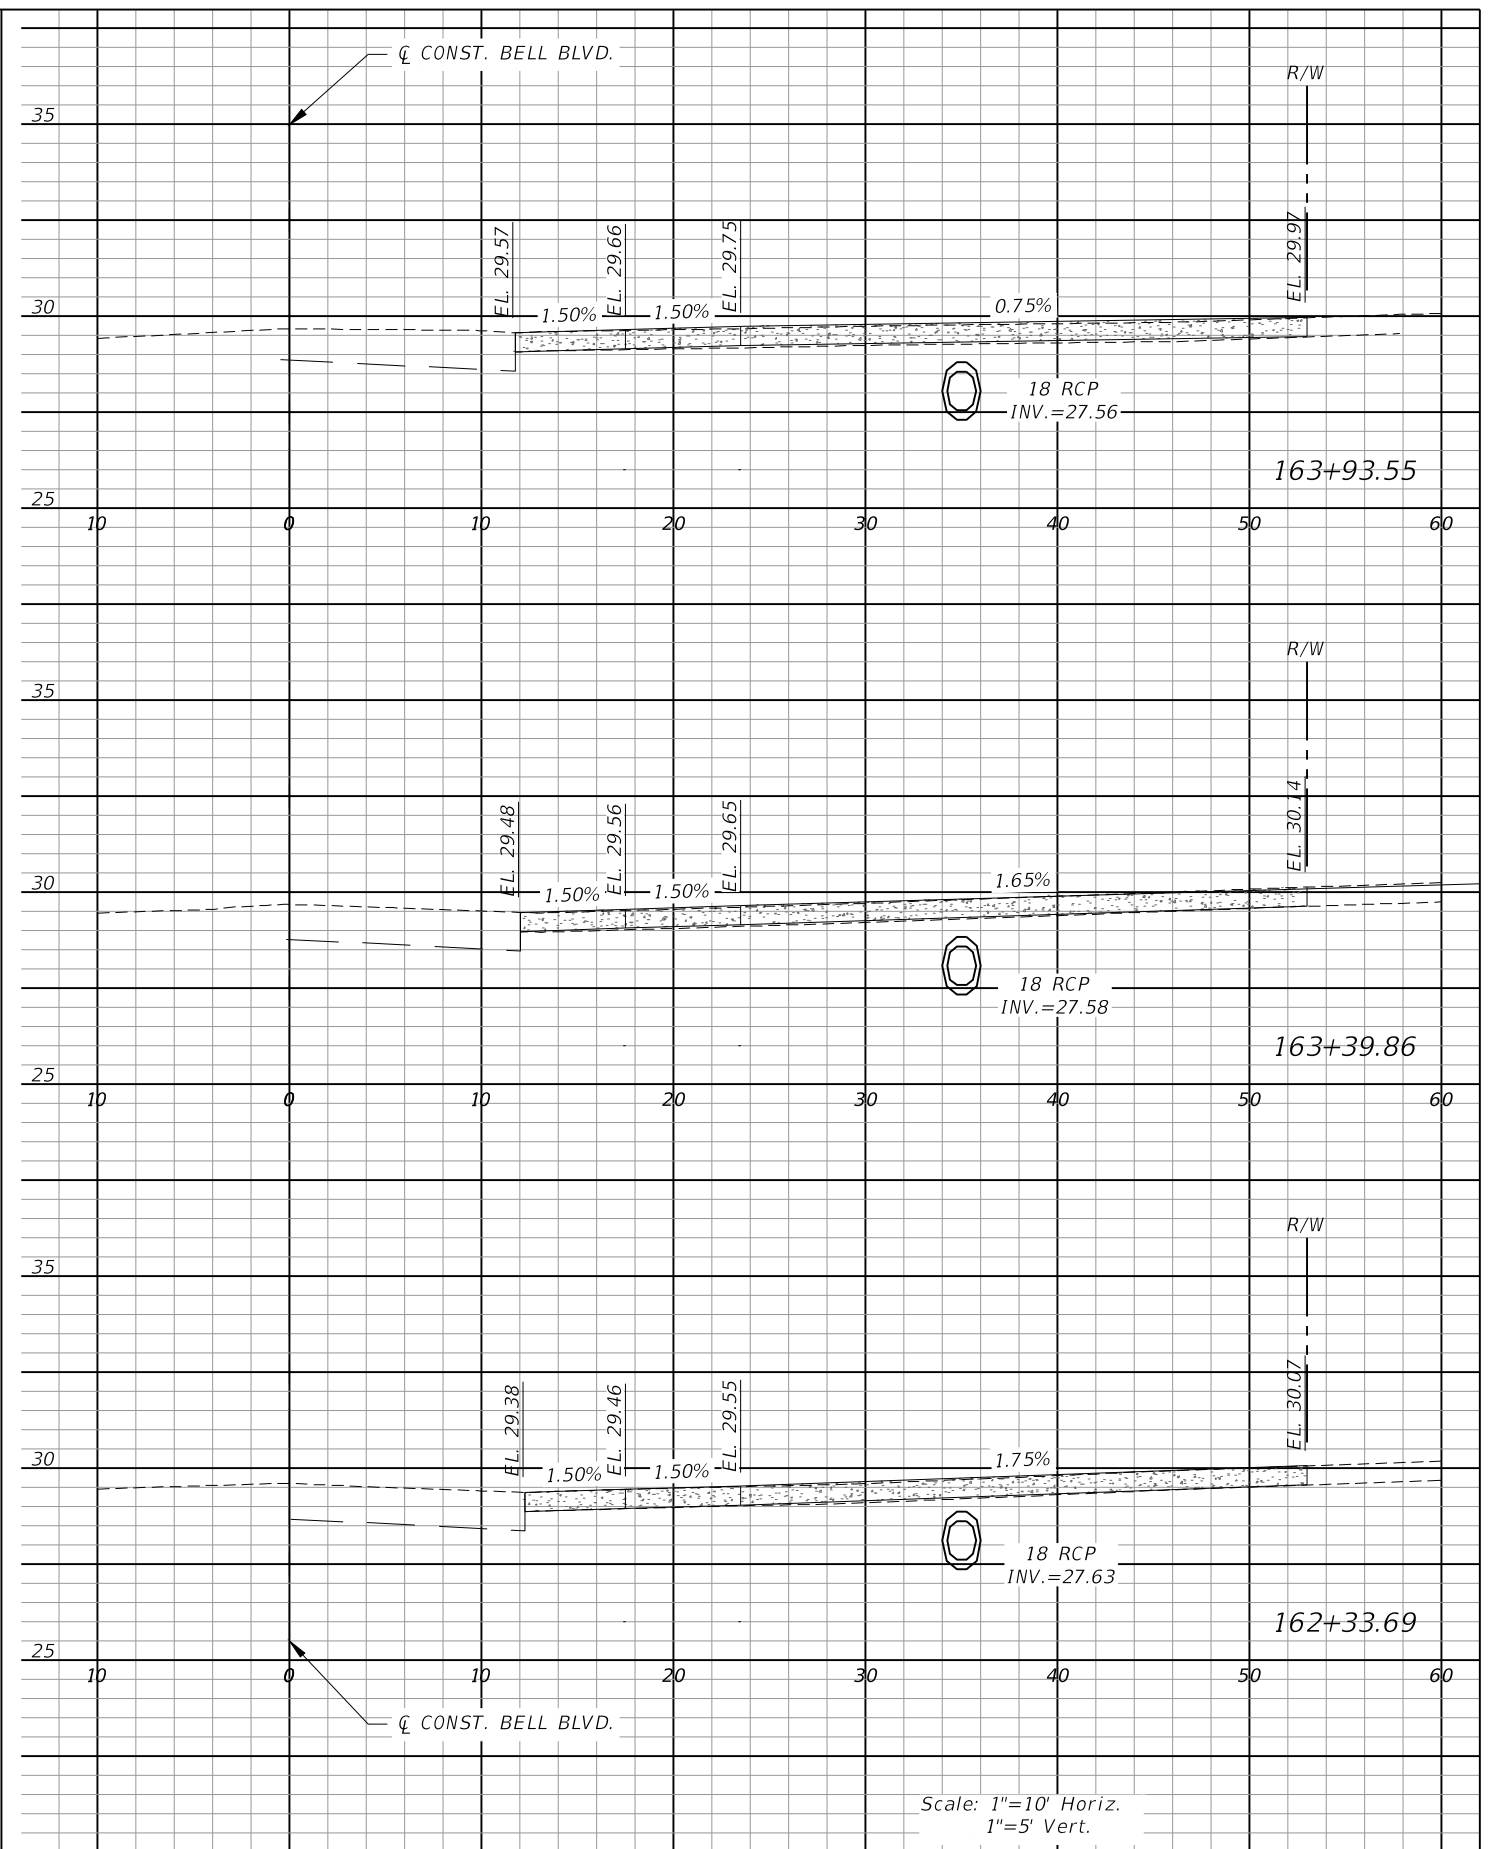
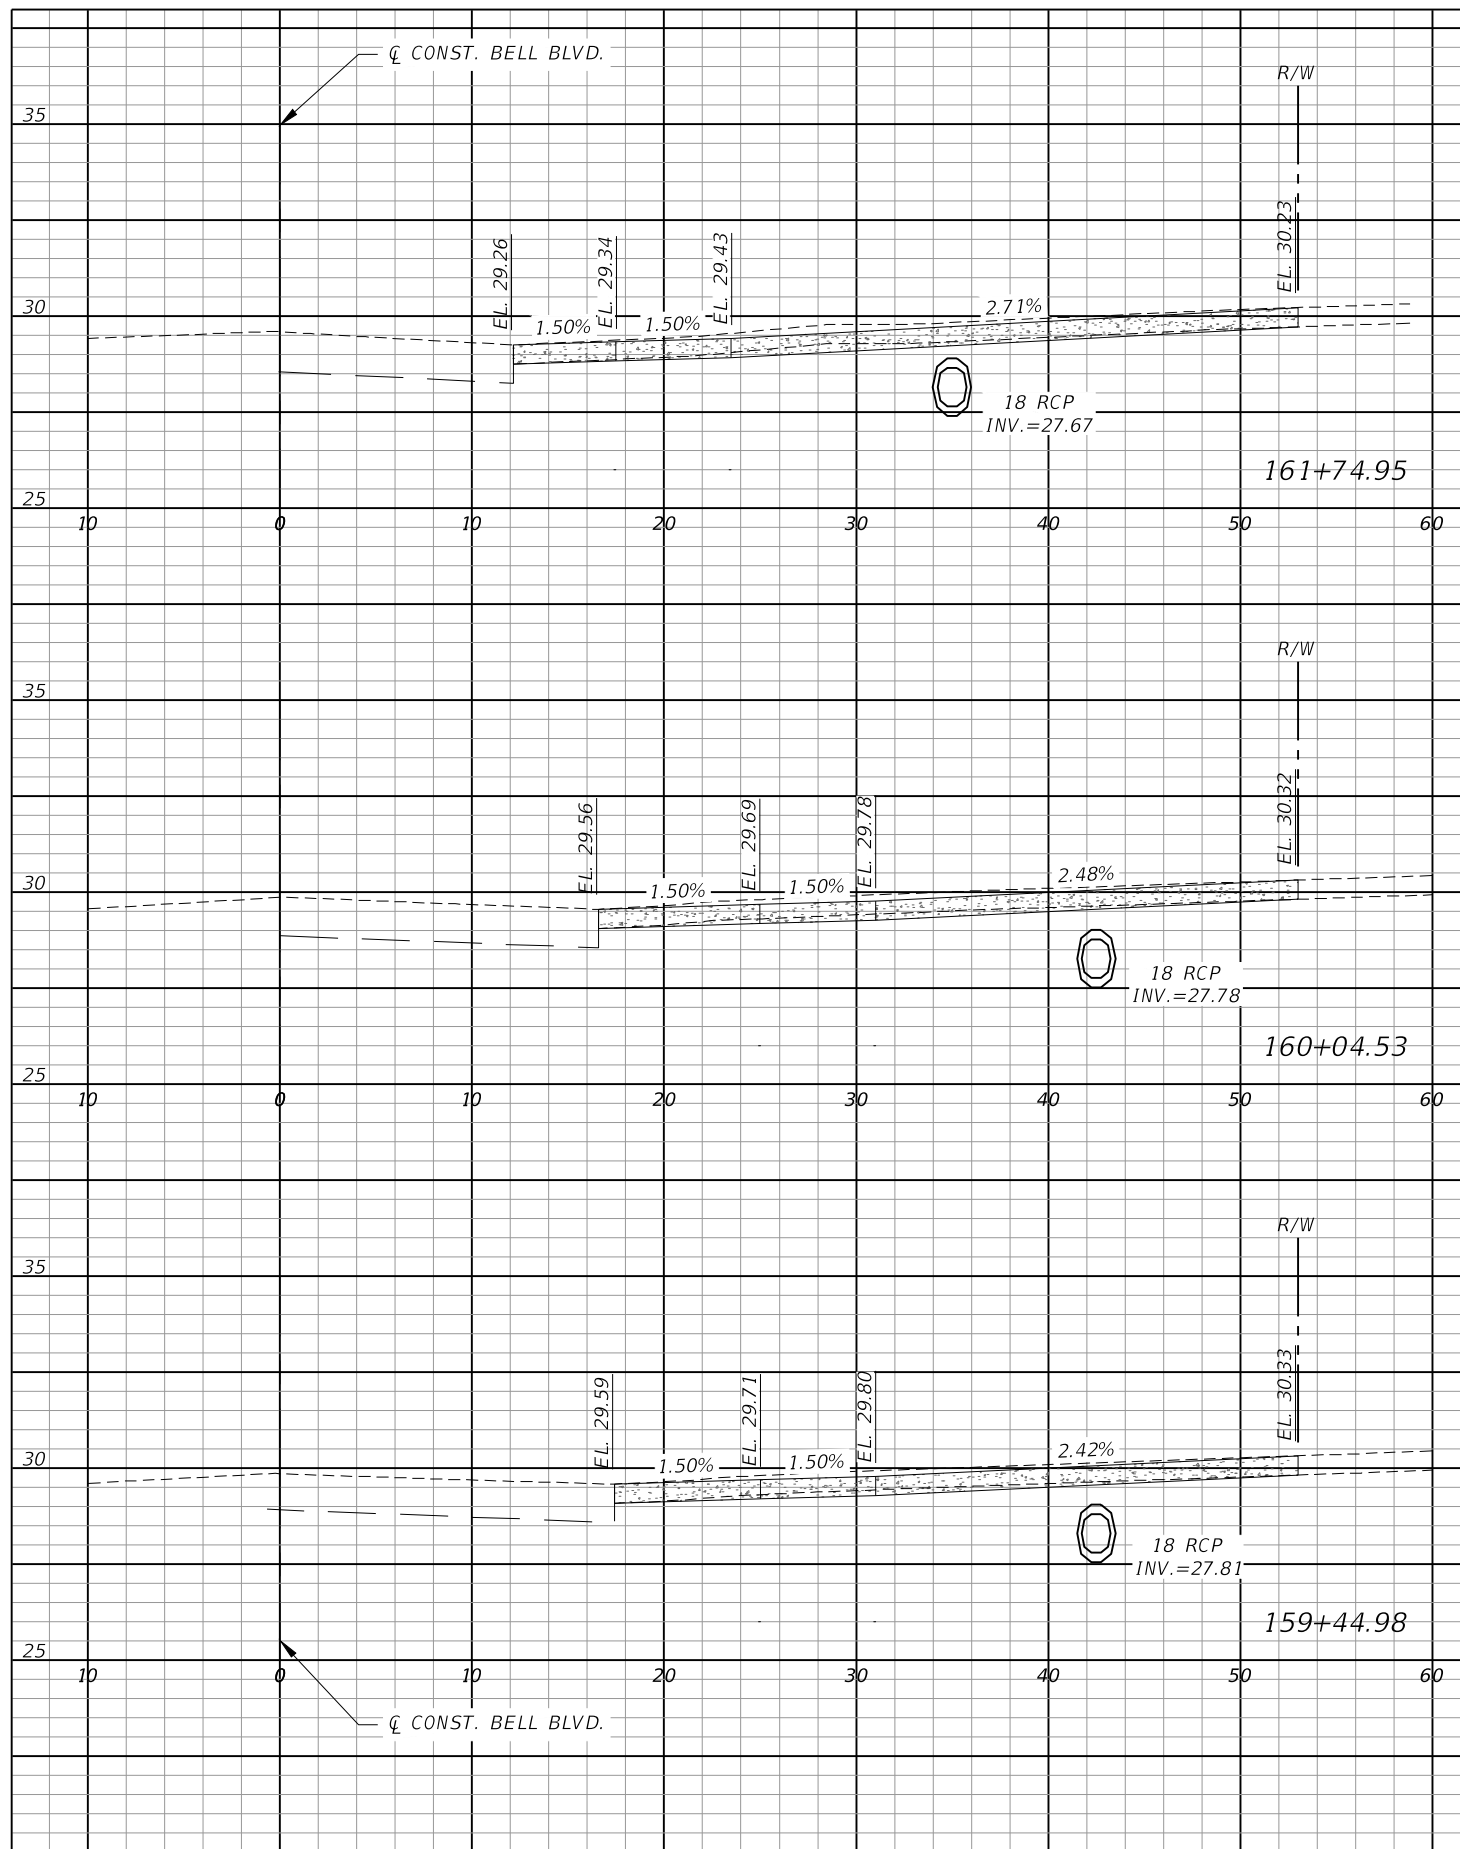
REVISIONS			
DATE	DESCRIPTION	DATE	DESCRIPTION


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LEE COUNTY	
ROAD NO.	COUNTY PROJECT NO.
BELL BLVD. SR 82 TO SUNRISE BLVD. SIDEWALK	6002

DRIVEWAY CROSS SECTIONS BELL BLVD. (5)	
SHEET NO.	126





REVISIONS			
DATE	DESCRIPTION	DATE	DESCRIPTION

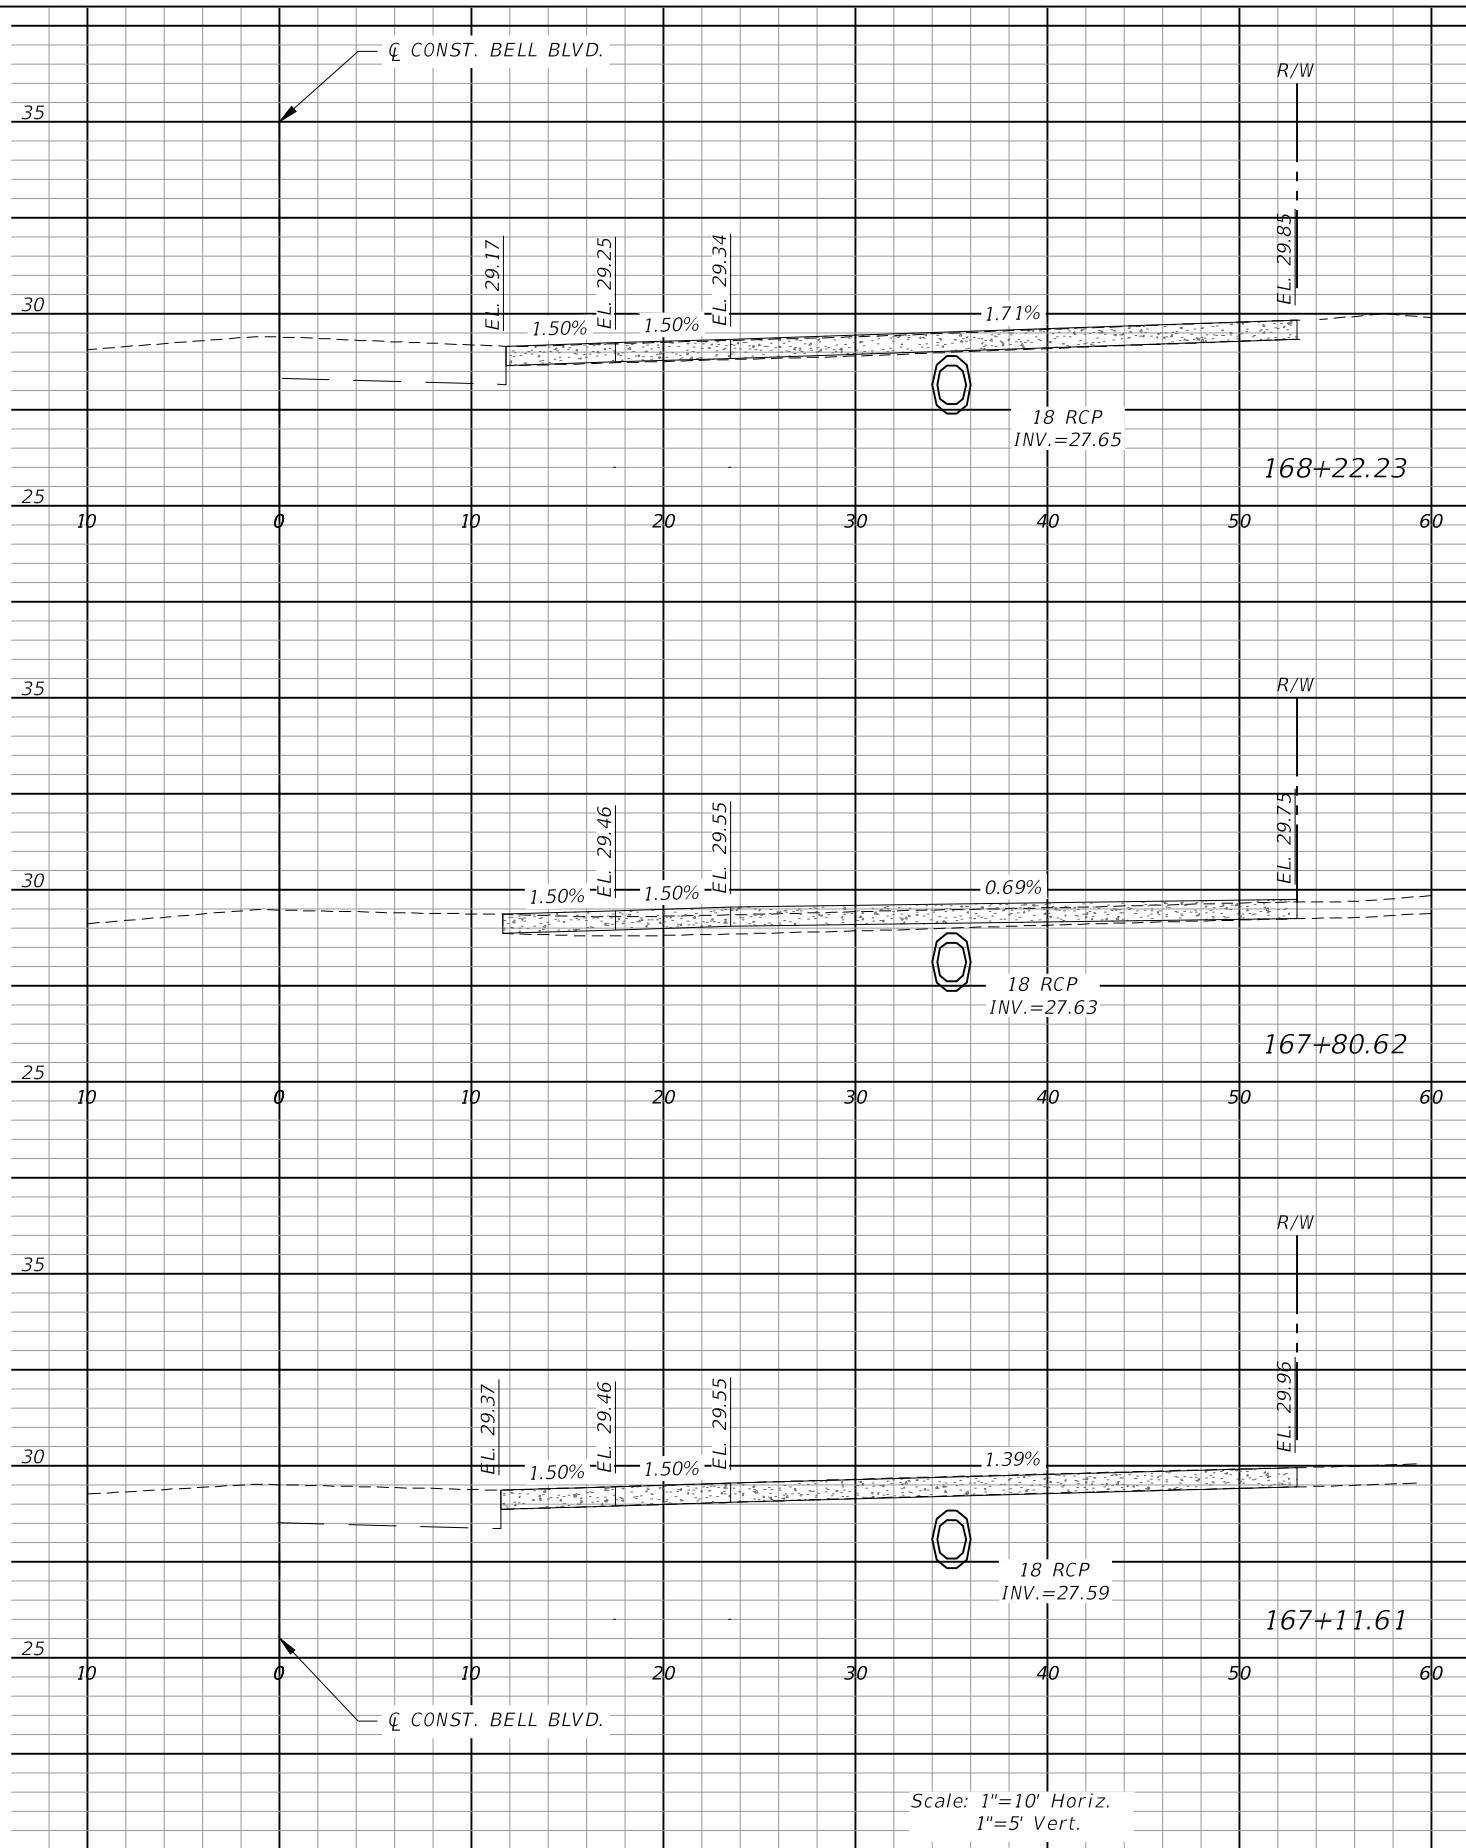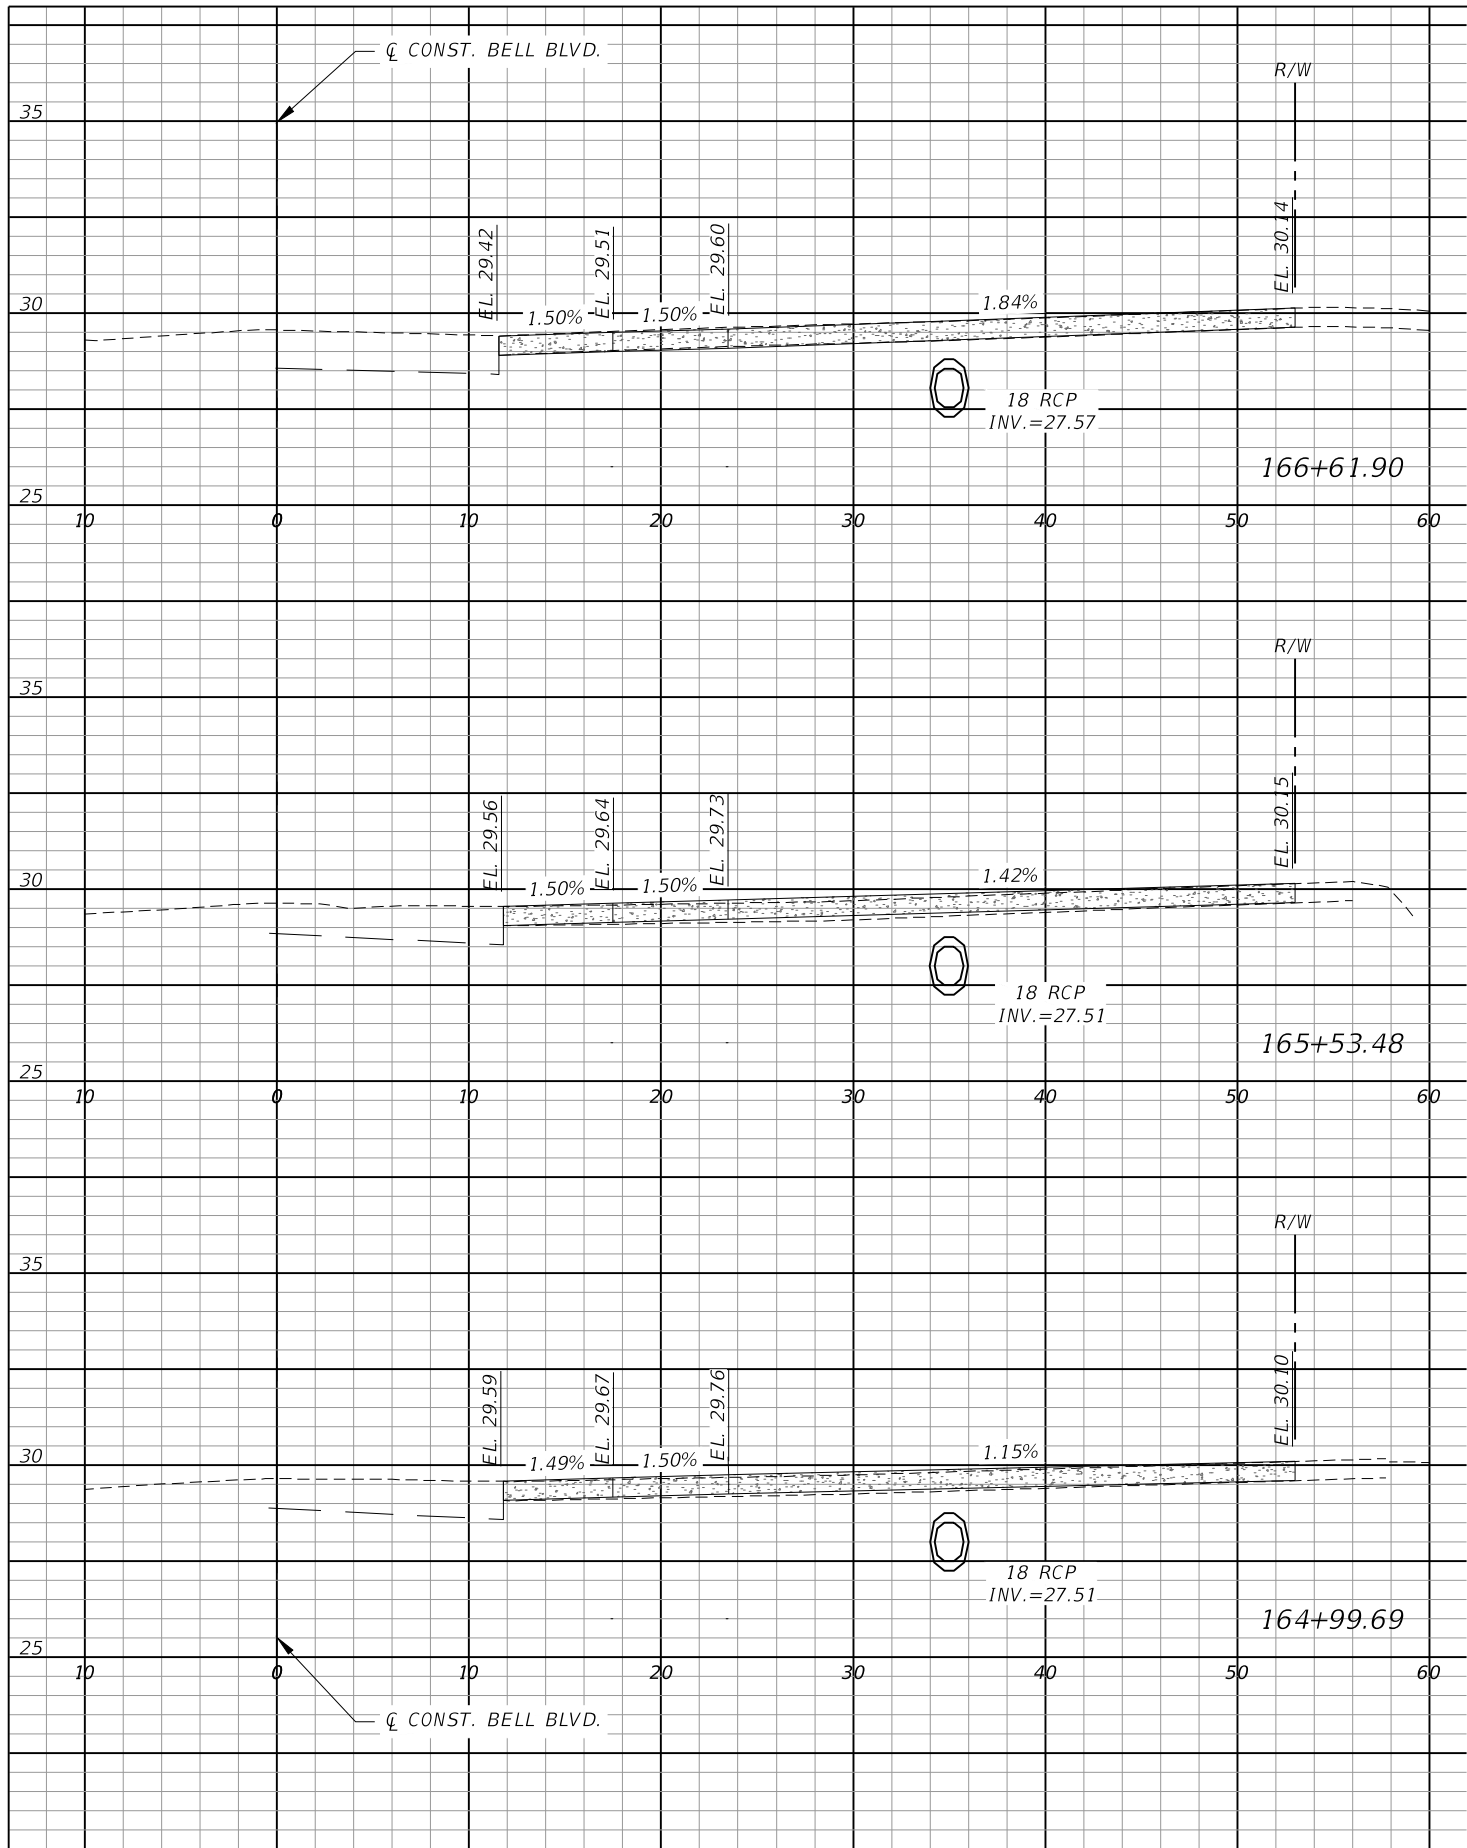
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
LEE COUNTY	
ROAD NO.	COUNTY PROJECT NO.
BELL BLVD. SR 82 TO SUNRISE BLVD. SIDEWALK	6002

DRIVEWAY CROSS SECTIONS BELL BLVD. (6)	
SHEET NO.	127



Scale:  $1''=10'$  Horiz.  
 $1''=5'$  Vert.

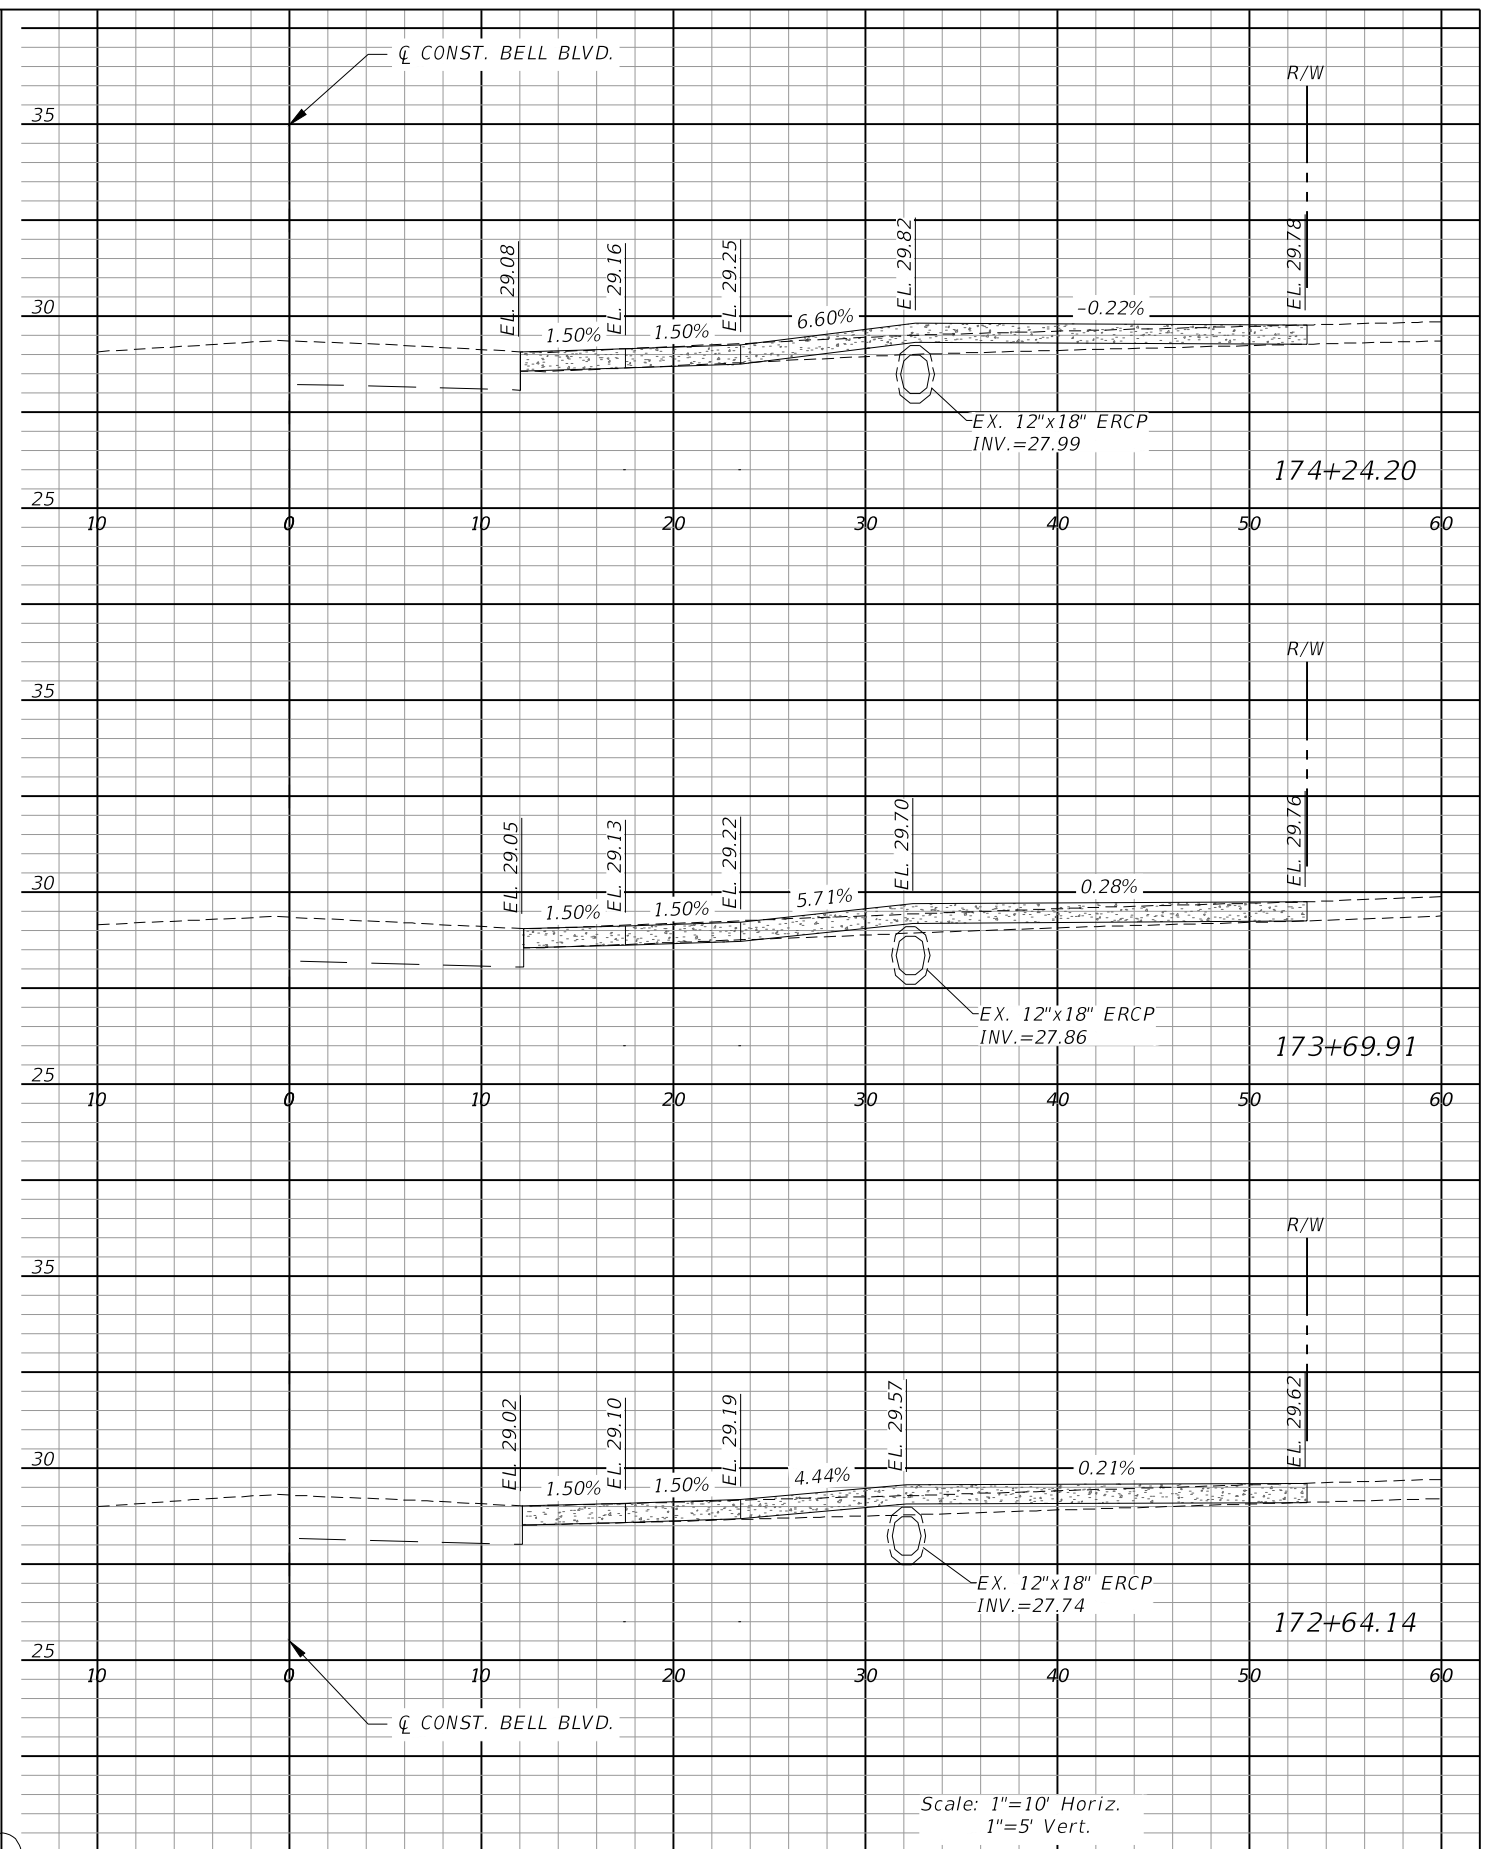
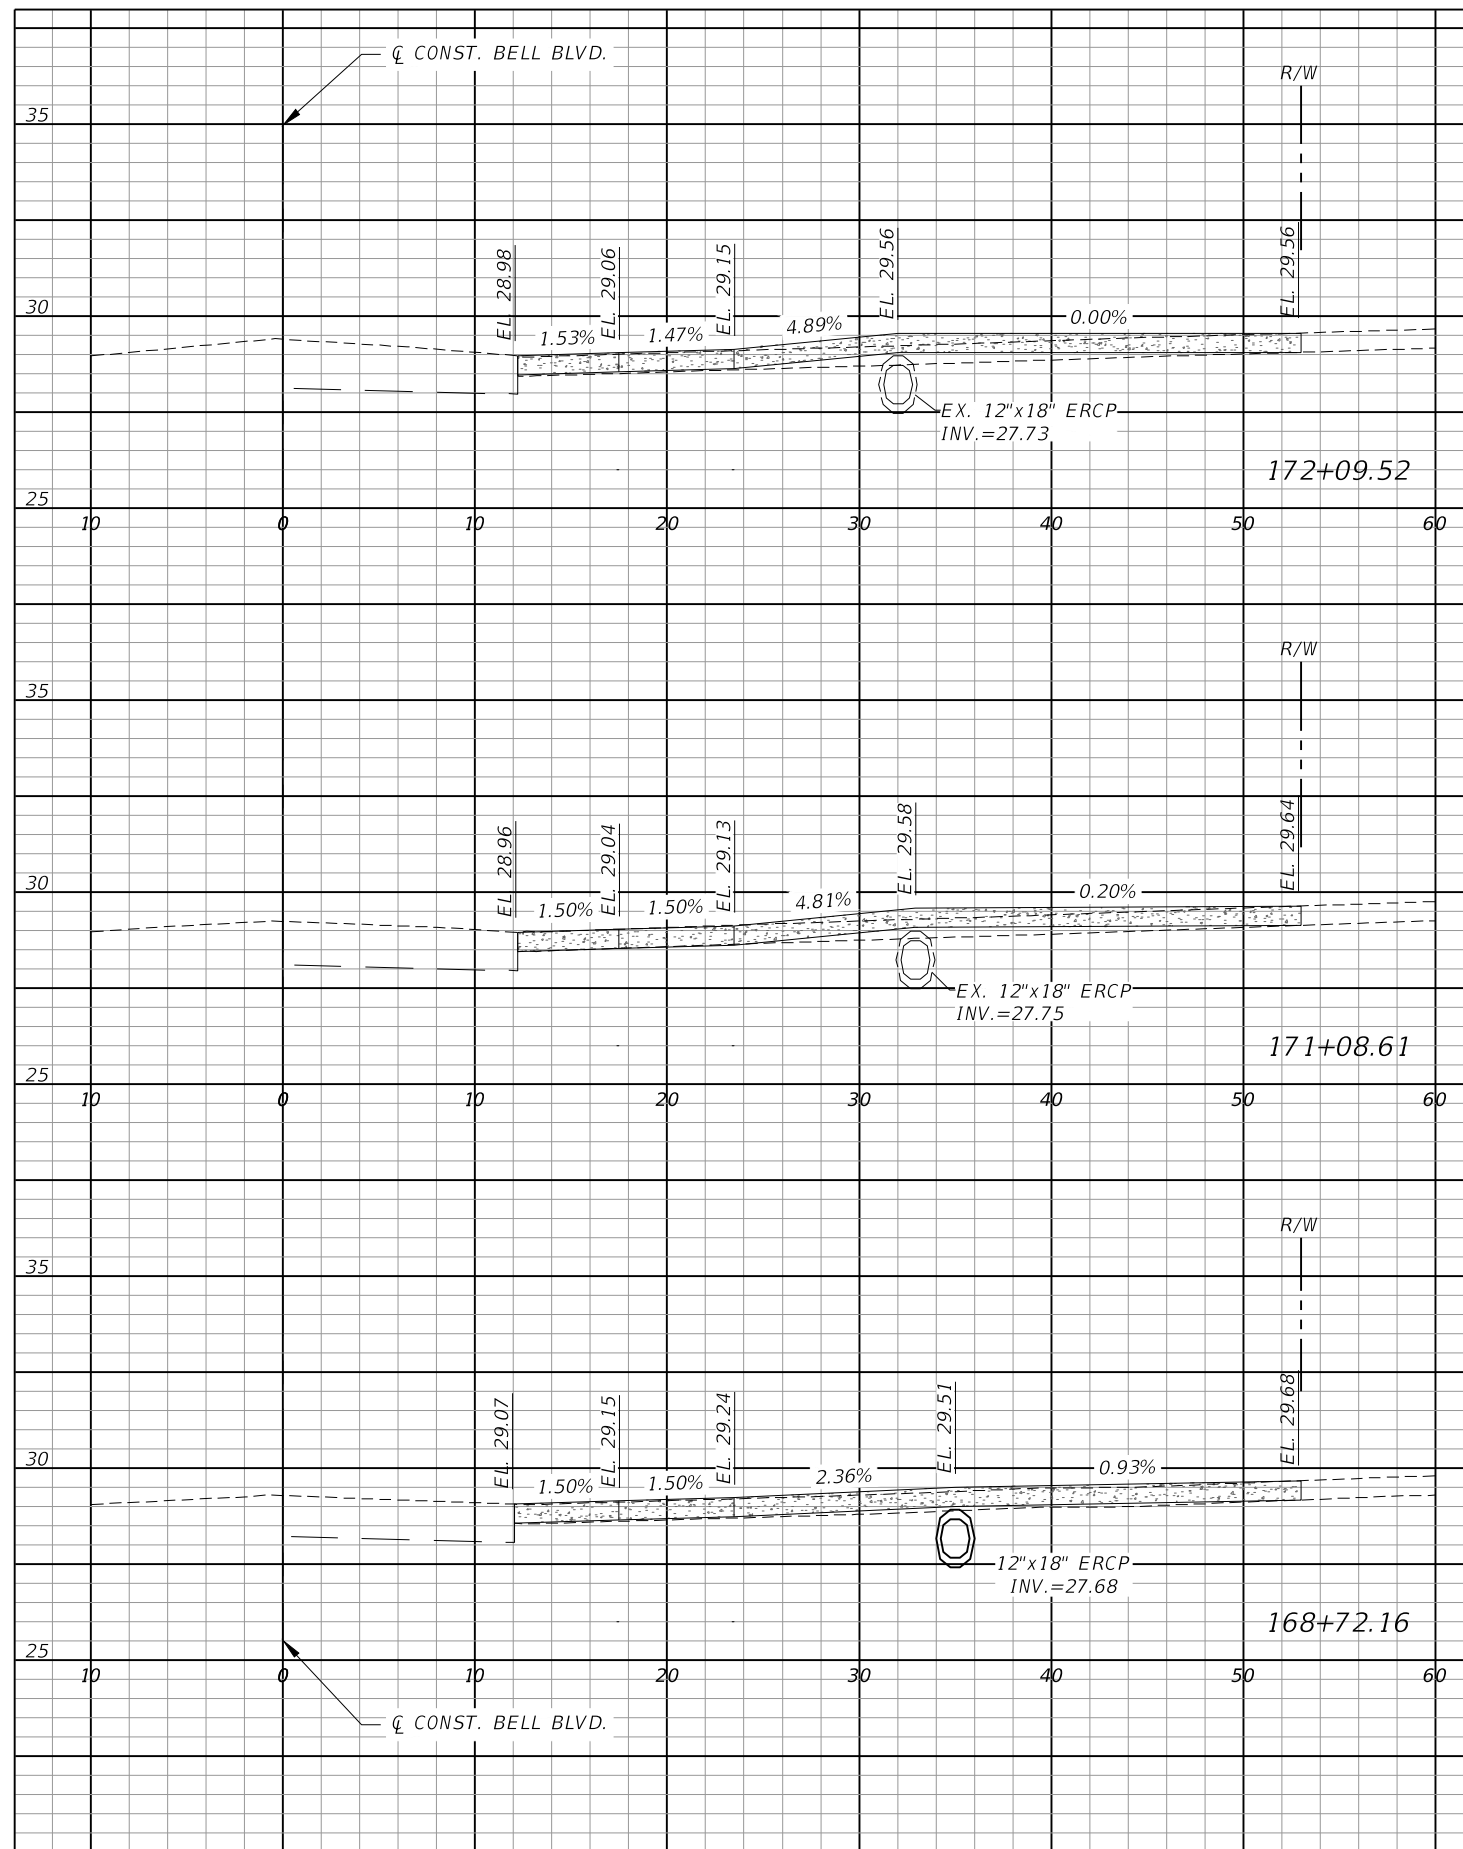
R E V I S I O N S			
DATE	DESCRIPTION	DATE	DESCRIPTION

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<i>LEE COUNTY</i>	
<i>ROAD NO.</i>	<i>COUNTY PROJECT NO.</i>
<i>BELL BLVD. SR 82 TO SUNRISE BLVD. SIDEWALK</i>	<i>6002</i>

<div style="text-align: center;"> <i>DRIVEWAY CROSS SECTIONS</i>  <i>BELL BLVD. (7)</i> </div>	<div style="text-align: center;"> <i>SHEET</i>  <i>NO.</i> </div>
	<div style="text-align: center;"> <i>128</i> </div>



Scale: 1"=10' Horiz.  
1"=5' Vert.

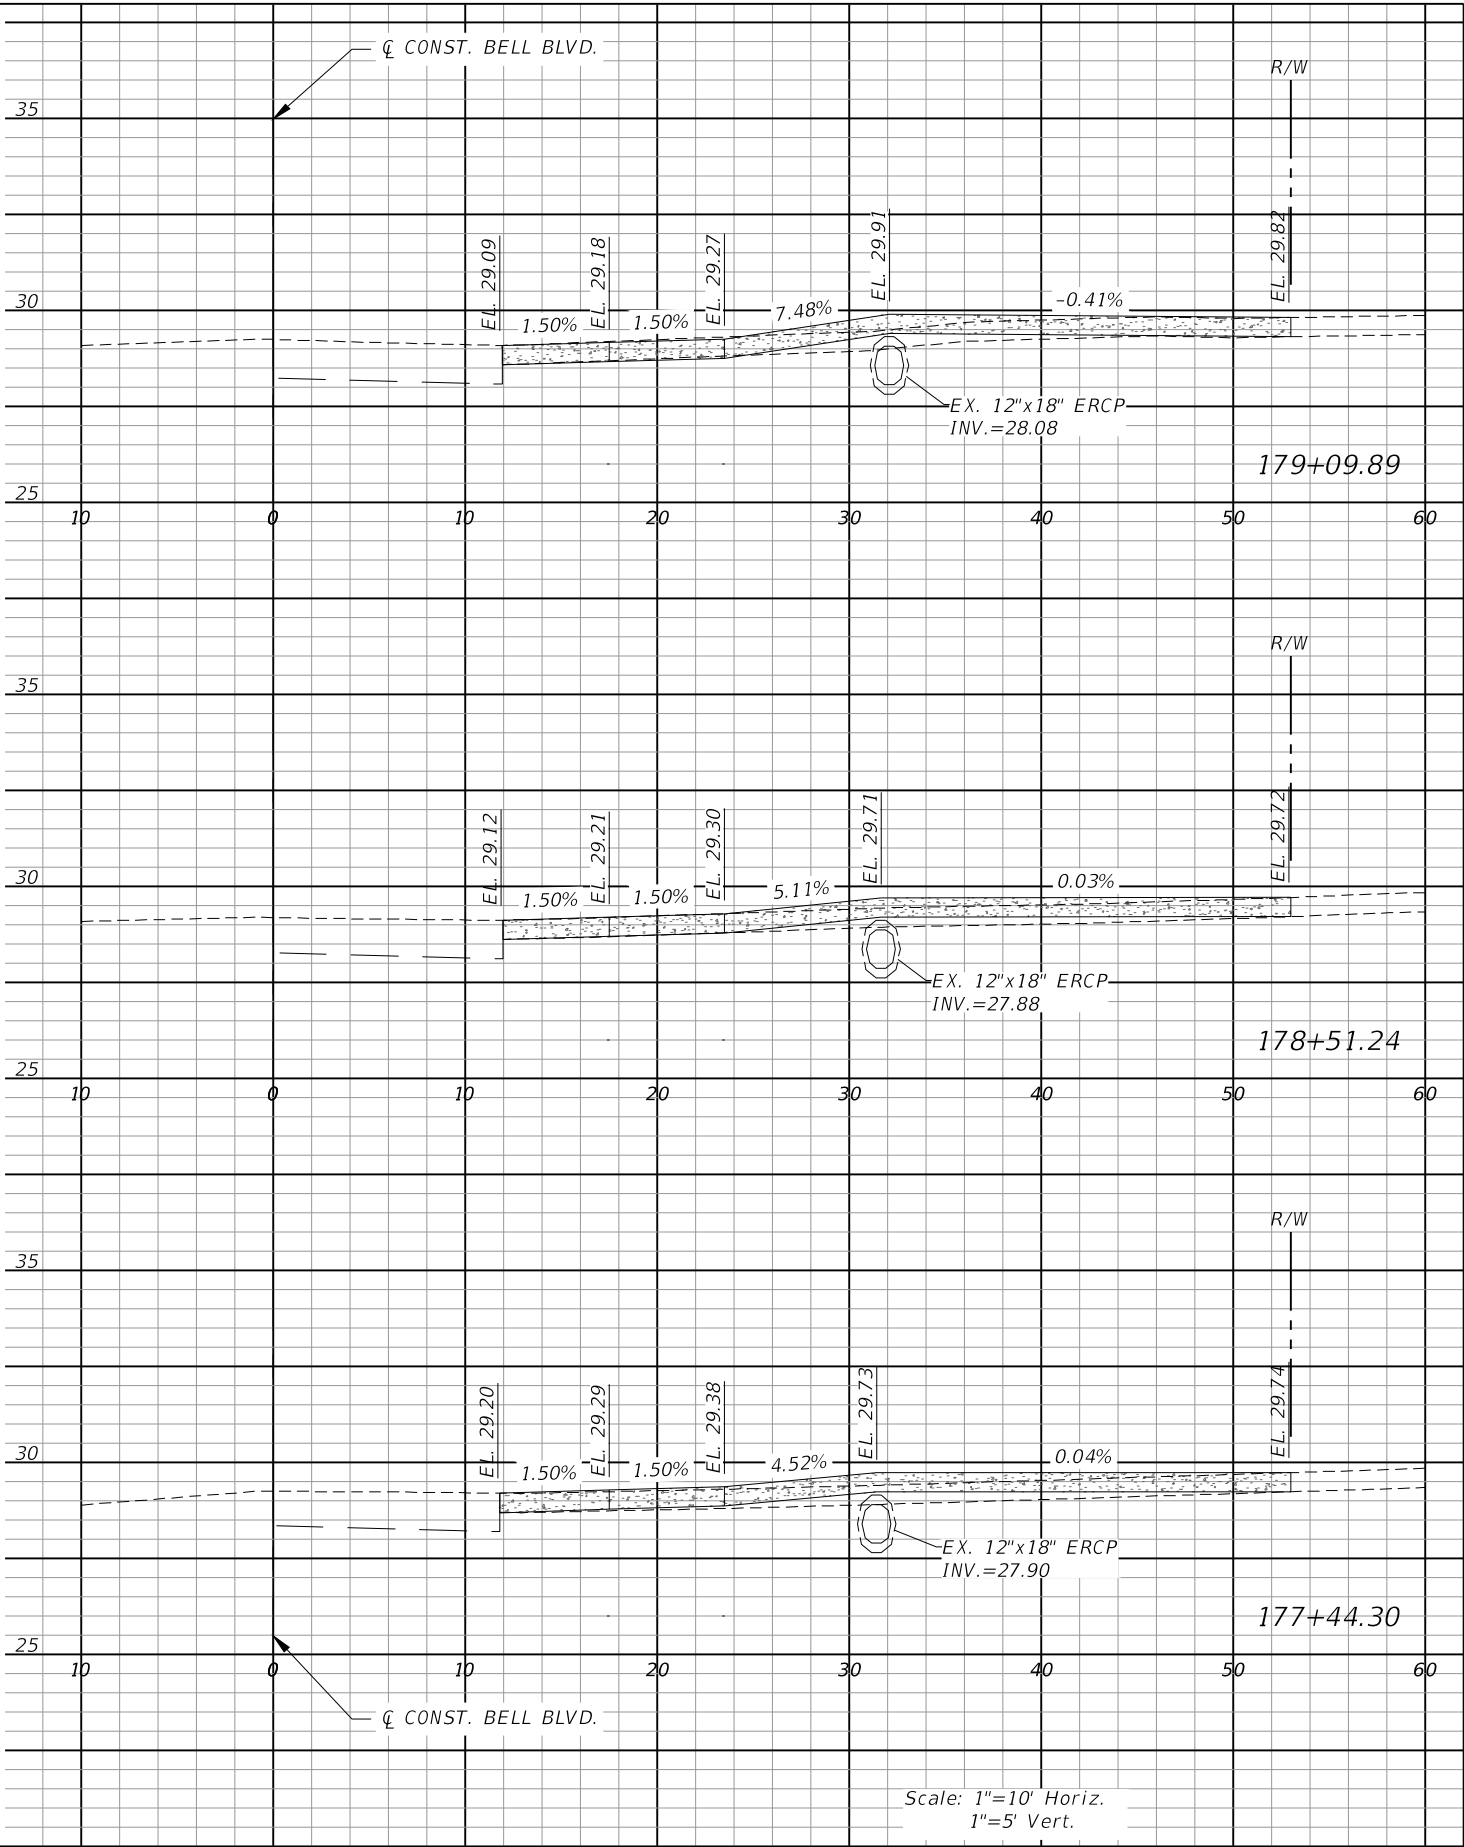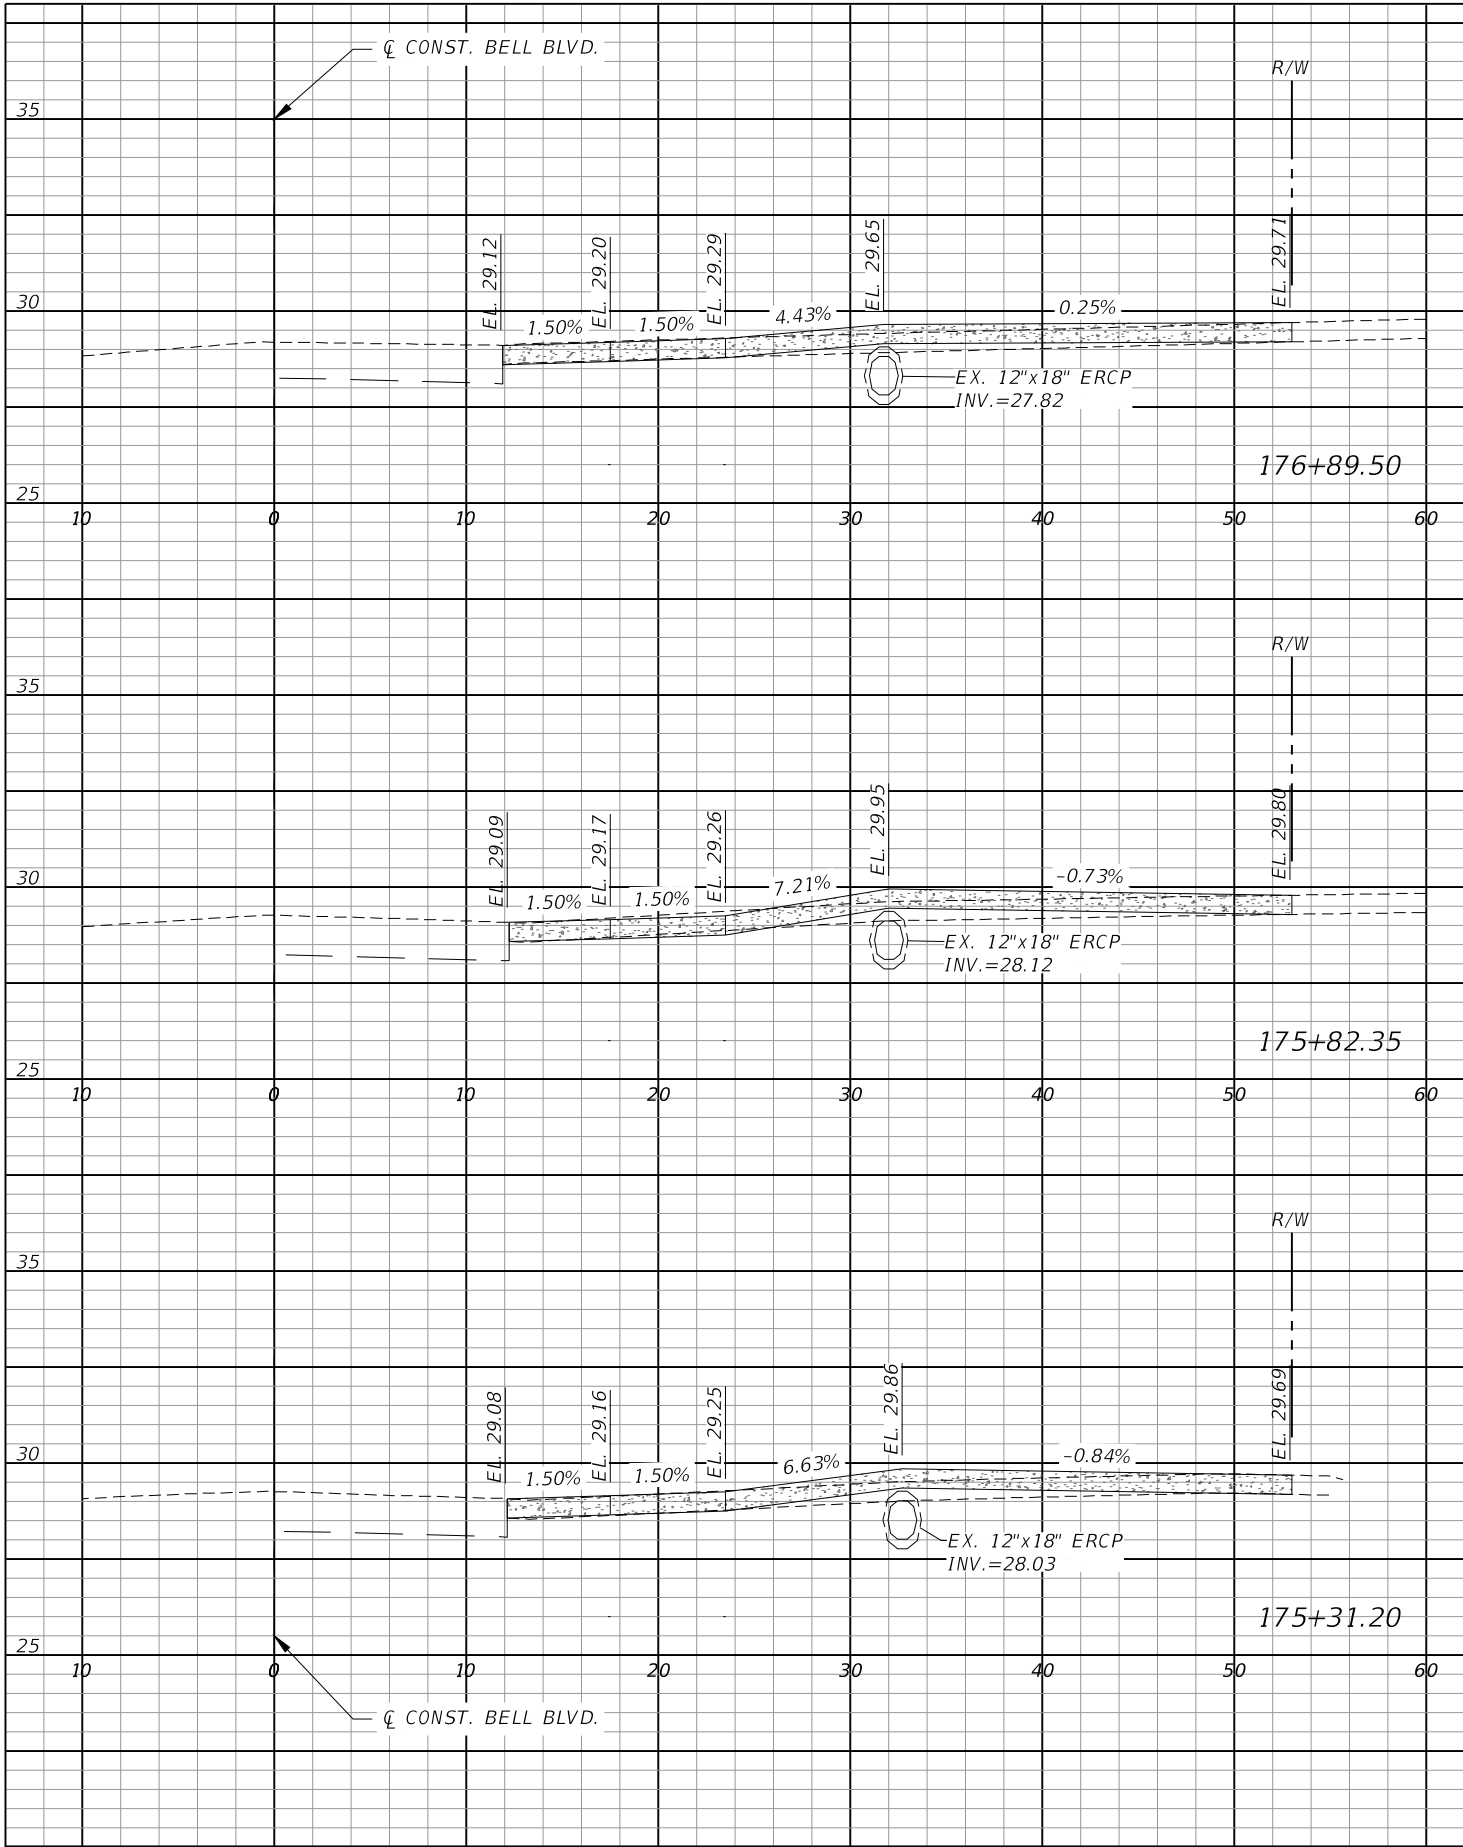REVISIONS			
DATE	DESCRIPTION	DATE	DESCRIPTION





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ROAD NO.	COUNTY PROJECT NO.
BELL BLVD. SR 82 TO SUNRISE BLVD. SIDEWALK	6002

DRIVEWAY CROSS SECTIONS	SHEET NO.
BELL BLVD. (8)	129





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REVISIONS			
DATE	DESCRIPTION	DATE	DESCRIPTION

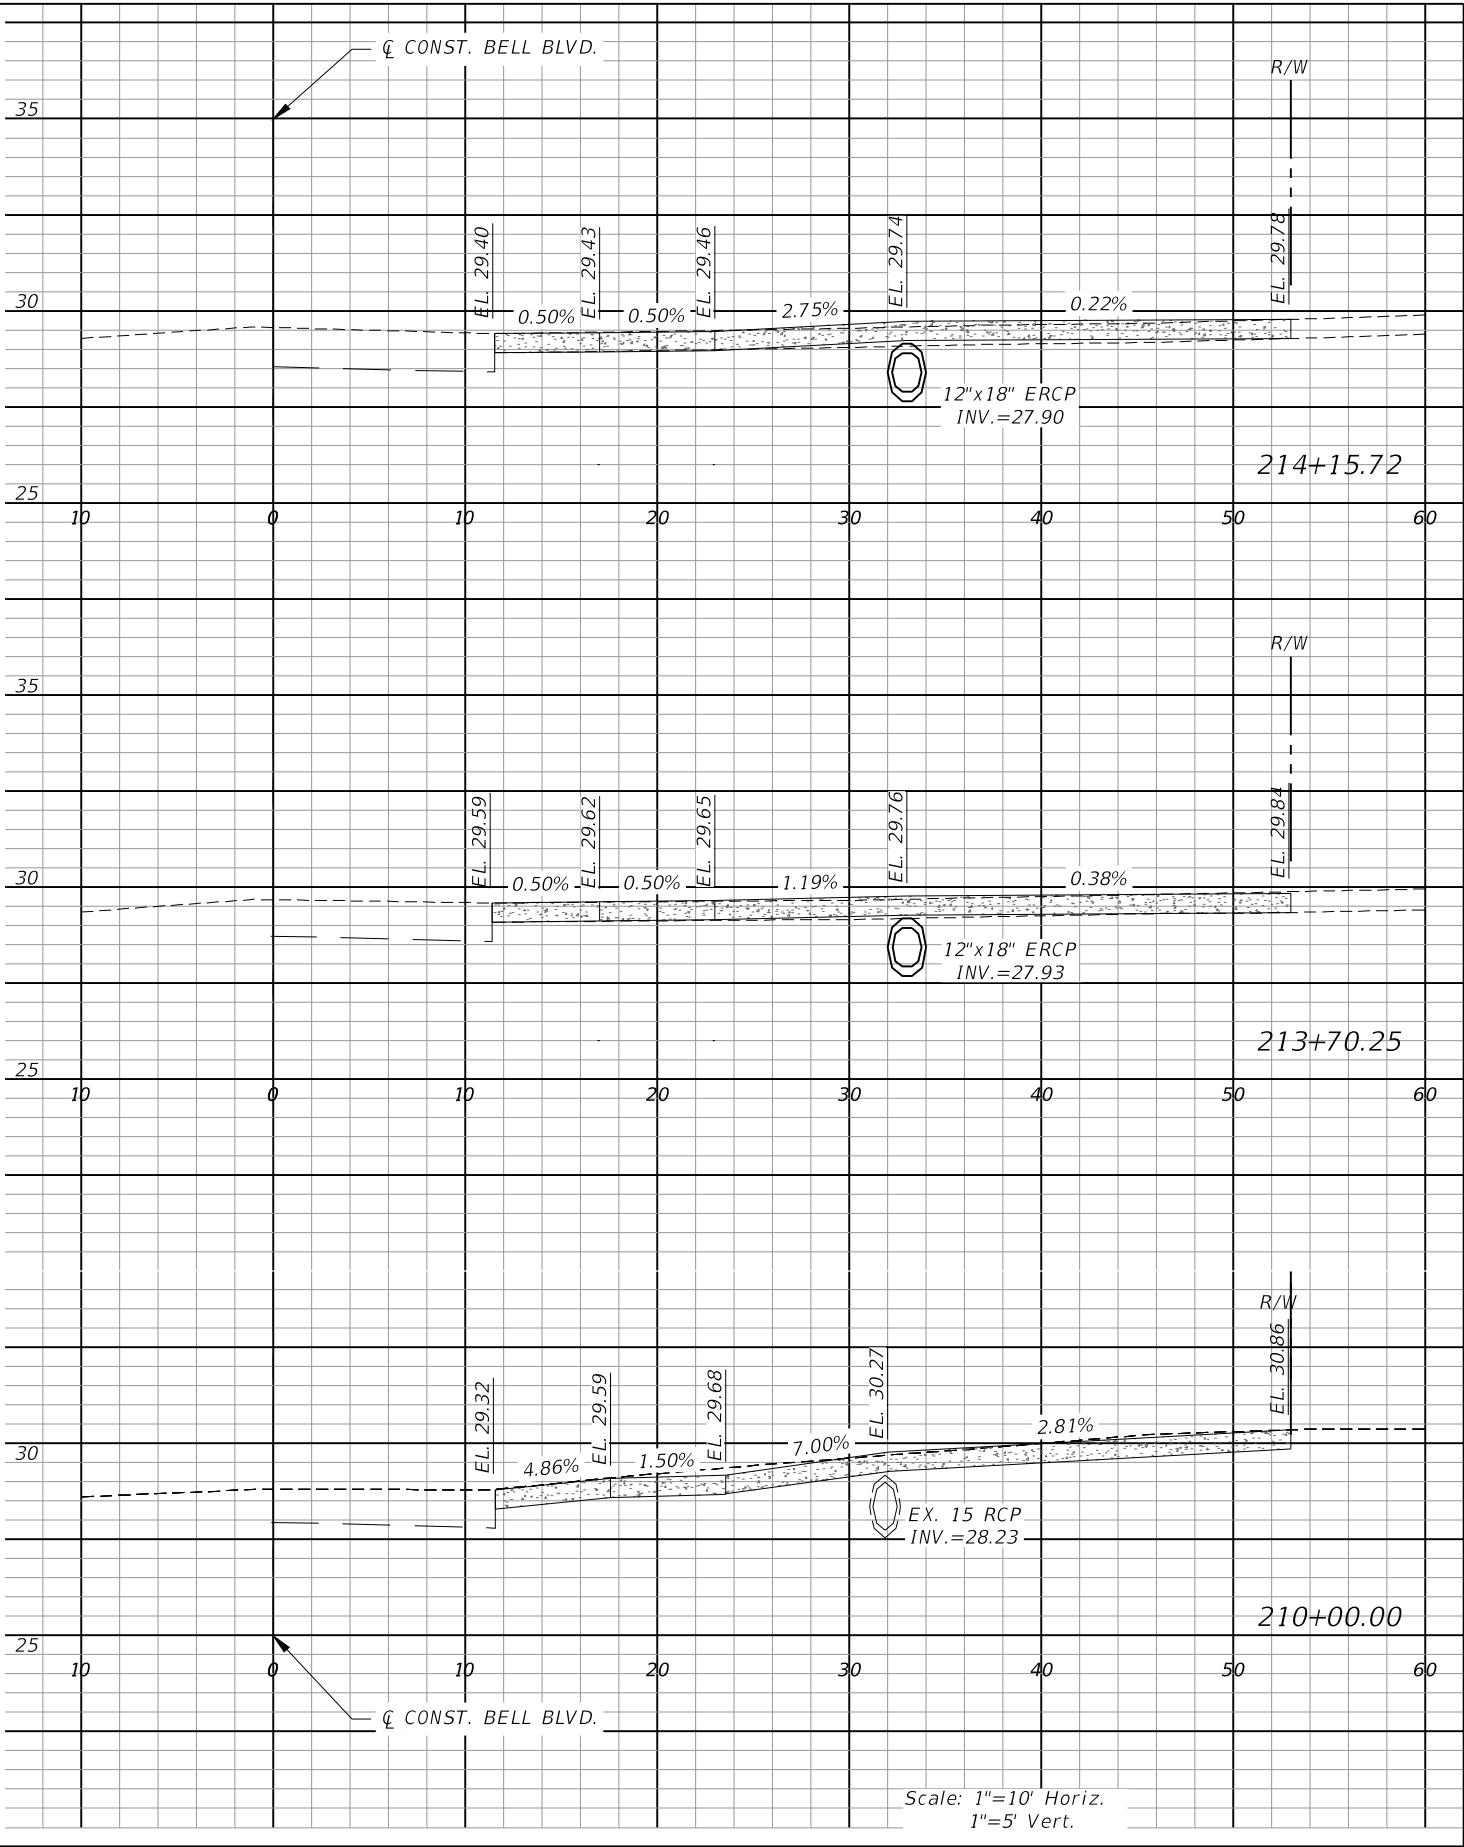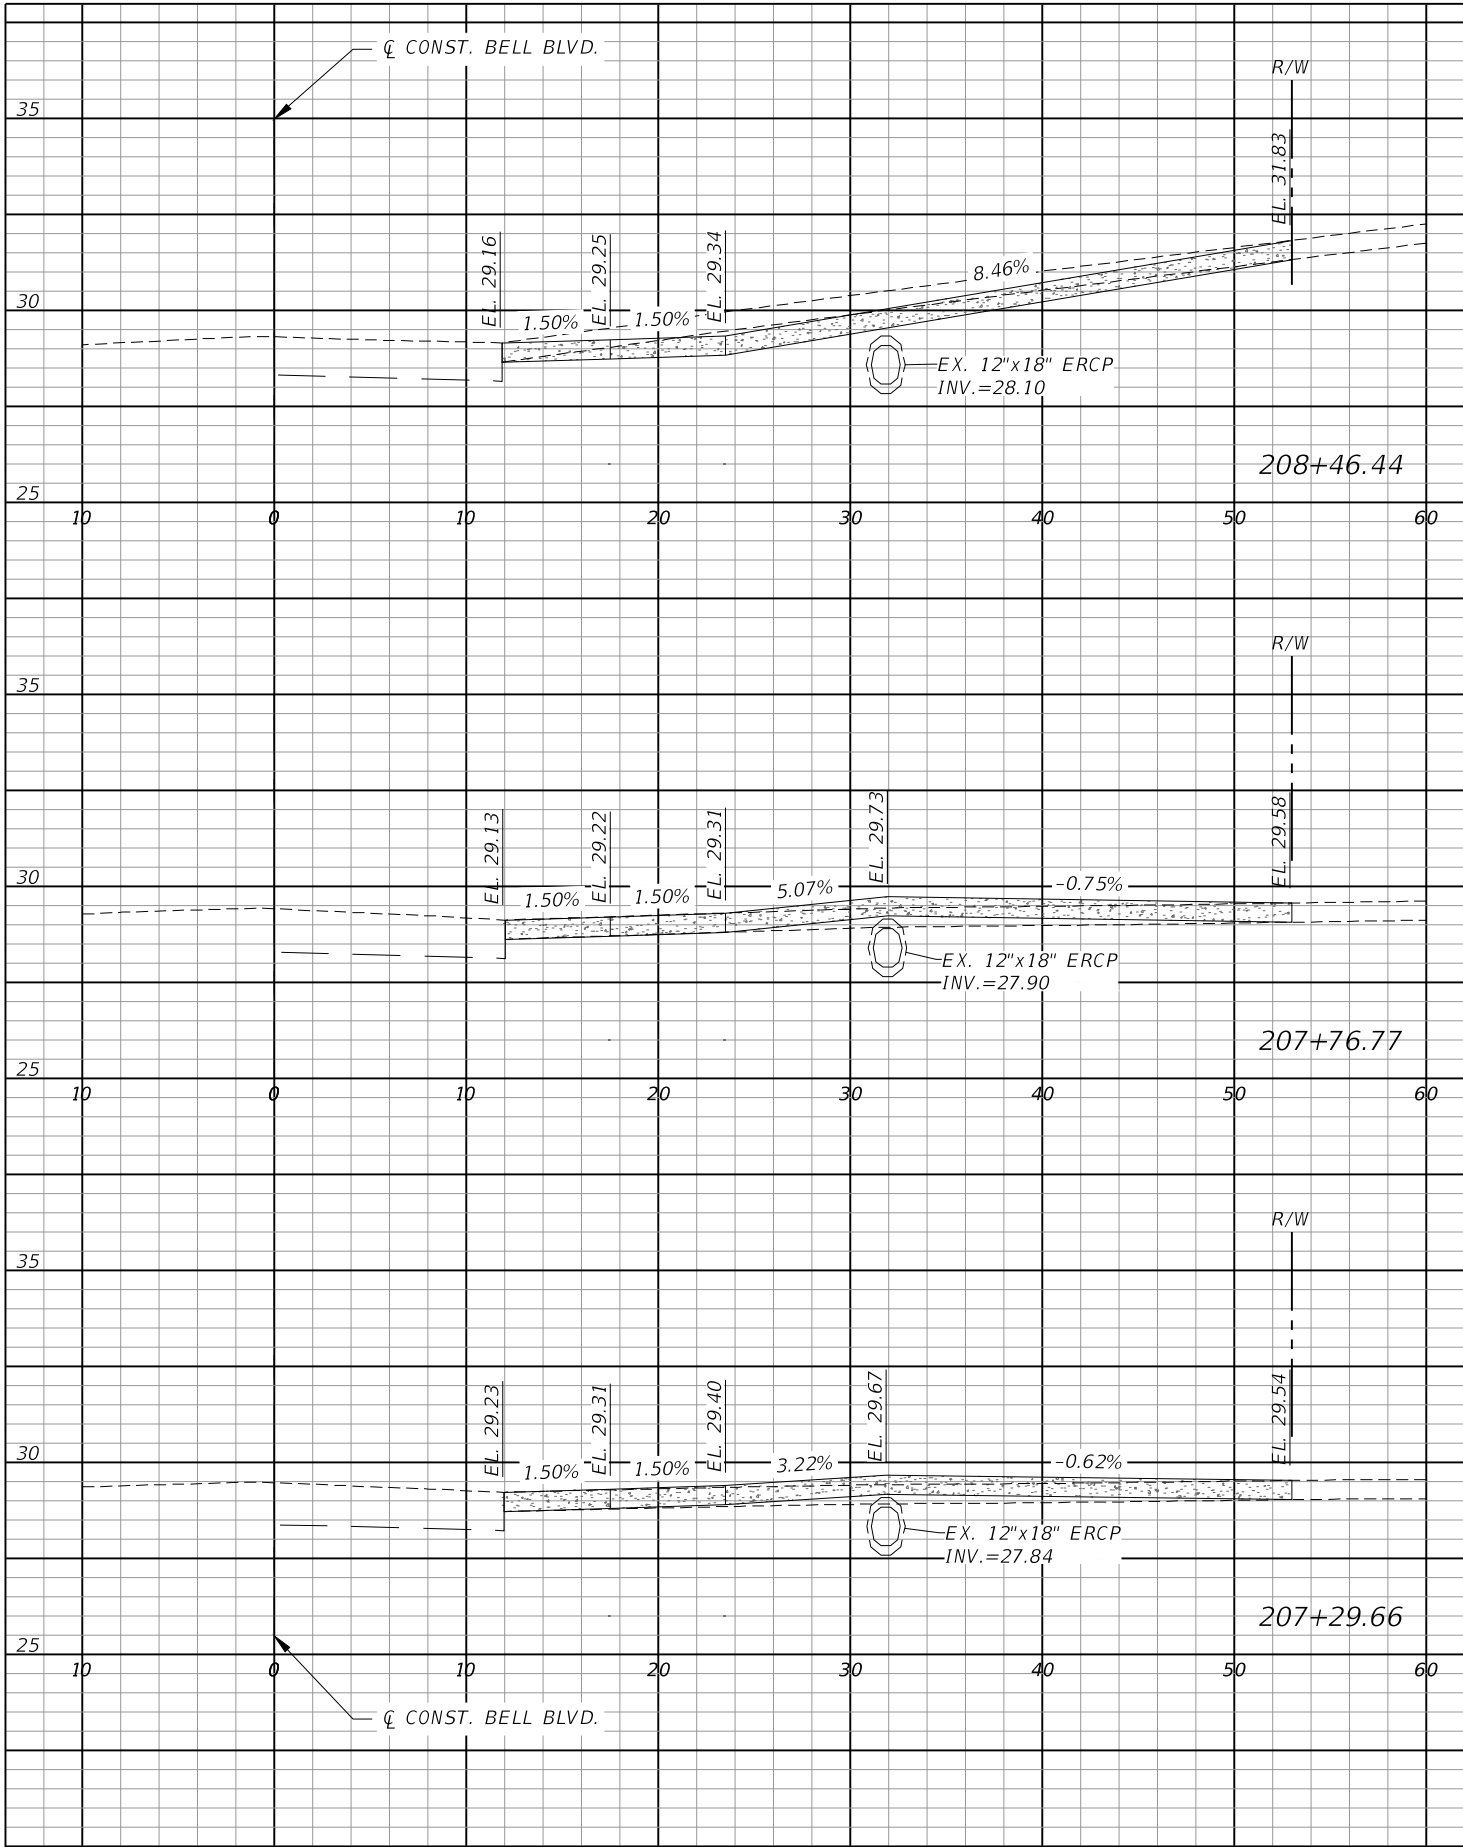

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LEE COUNTY	
ROAD NO.	COUNTY PROJECT NO.
BELL BLVD. SR 82 TO SUNRISE BLVD. SIDEWALK	6002

DRIVEWAY CROSS SECTIONS	SHEET NO.
BELL BLVD. (9)	130

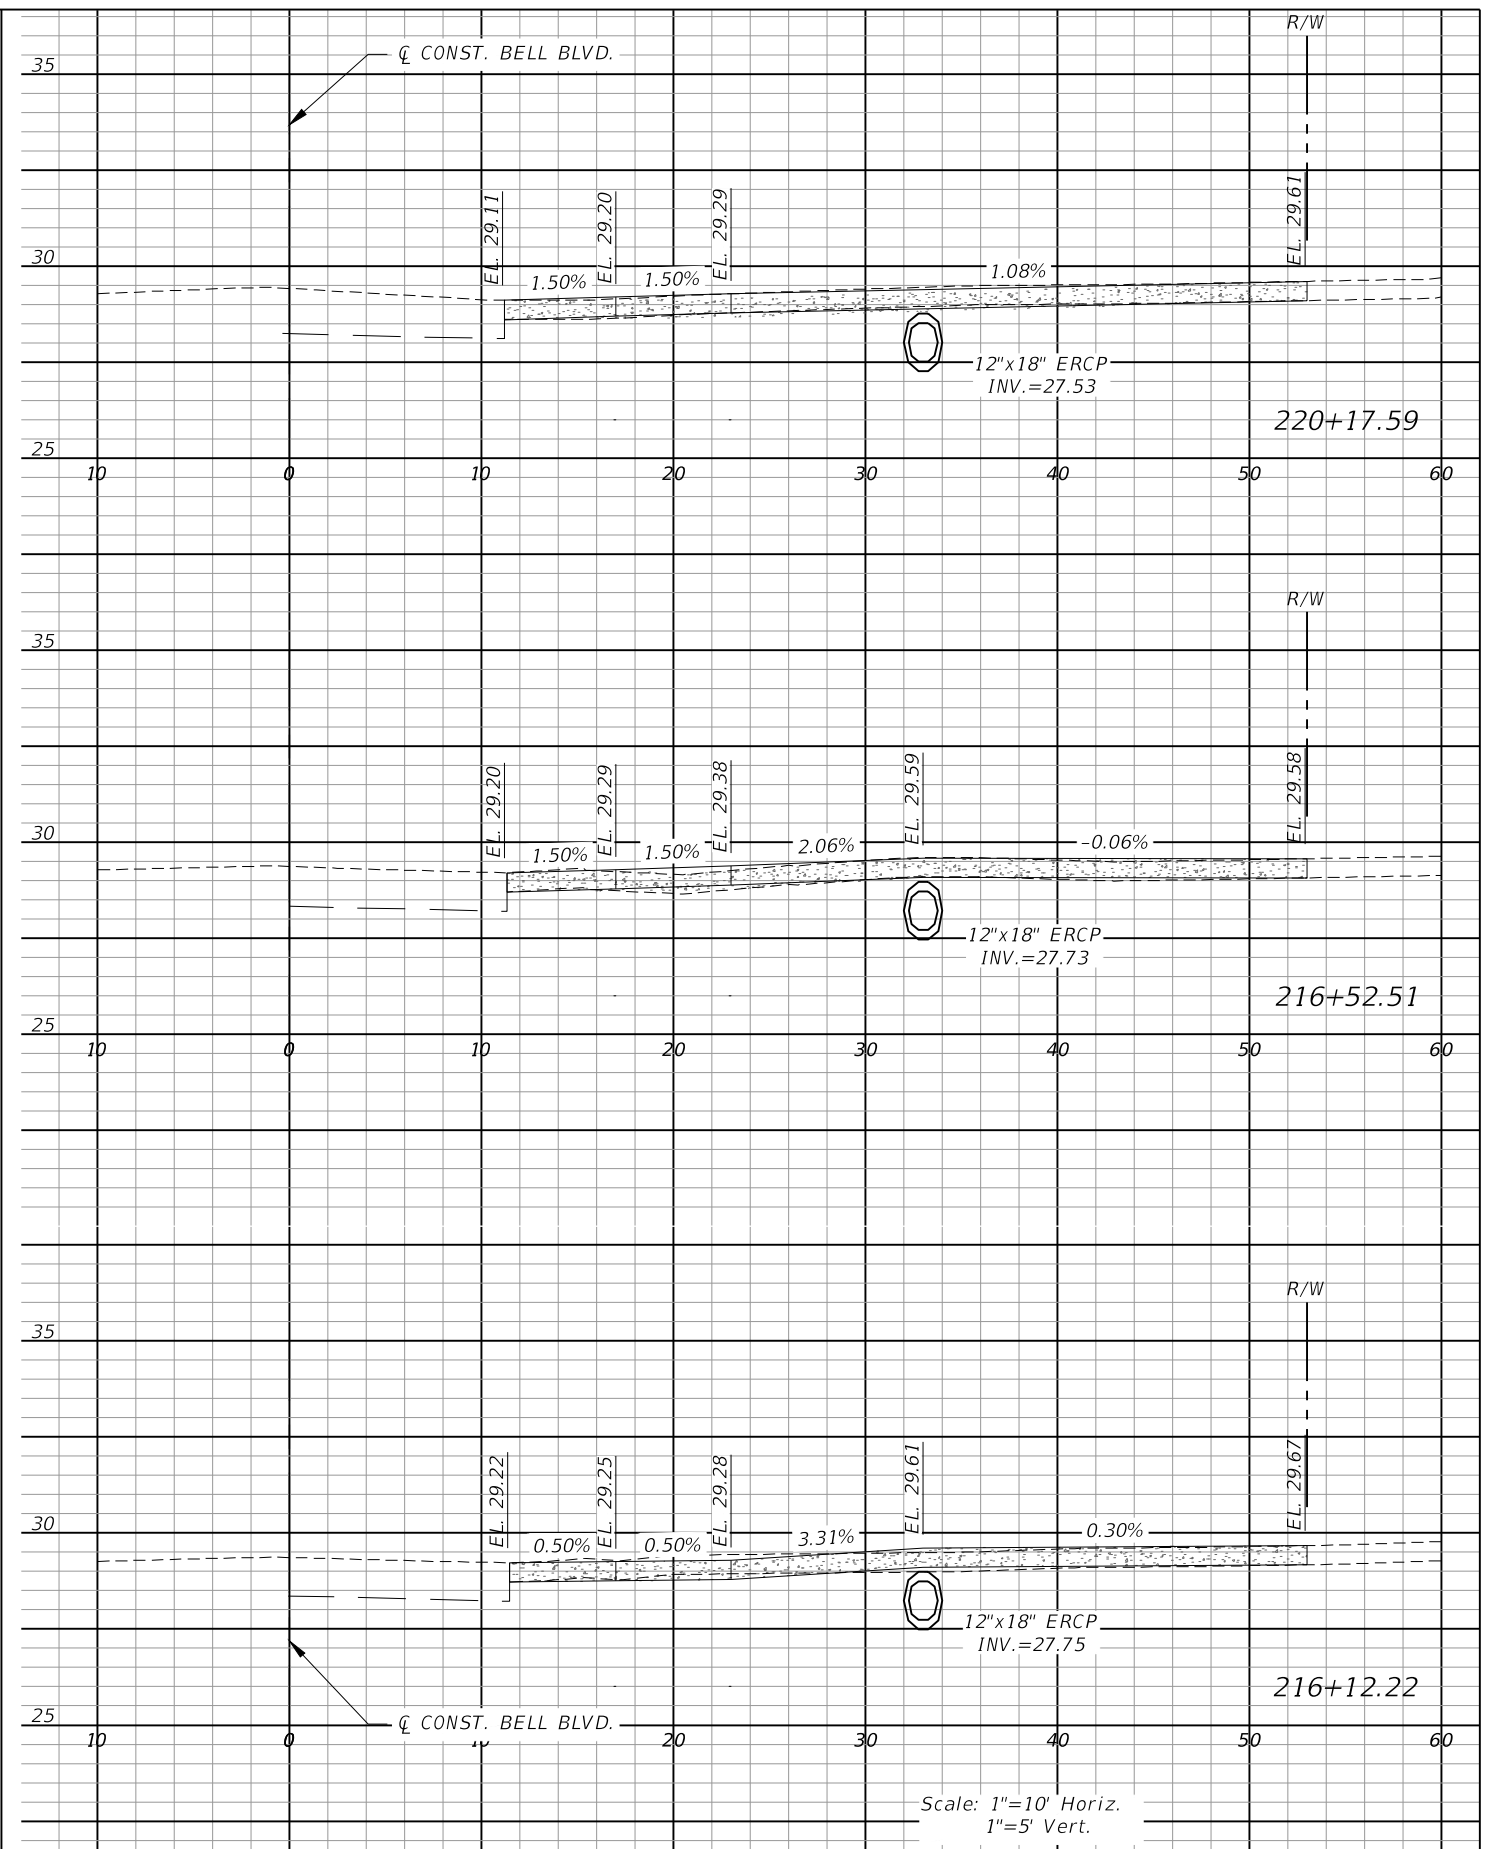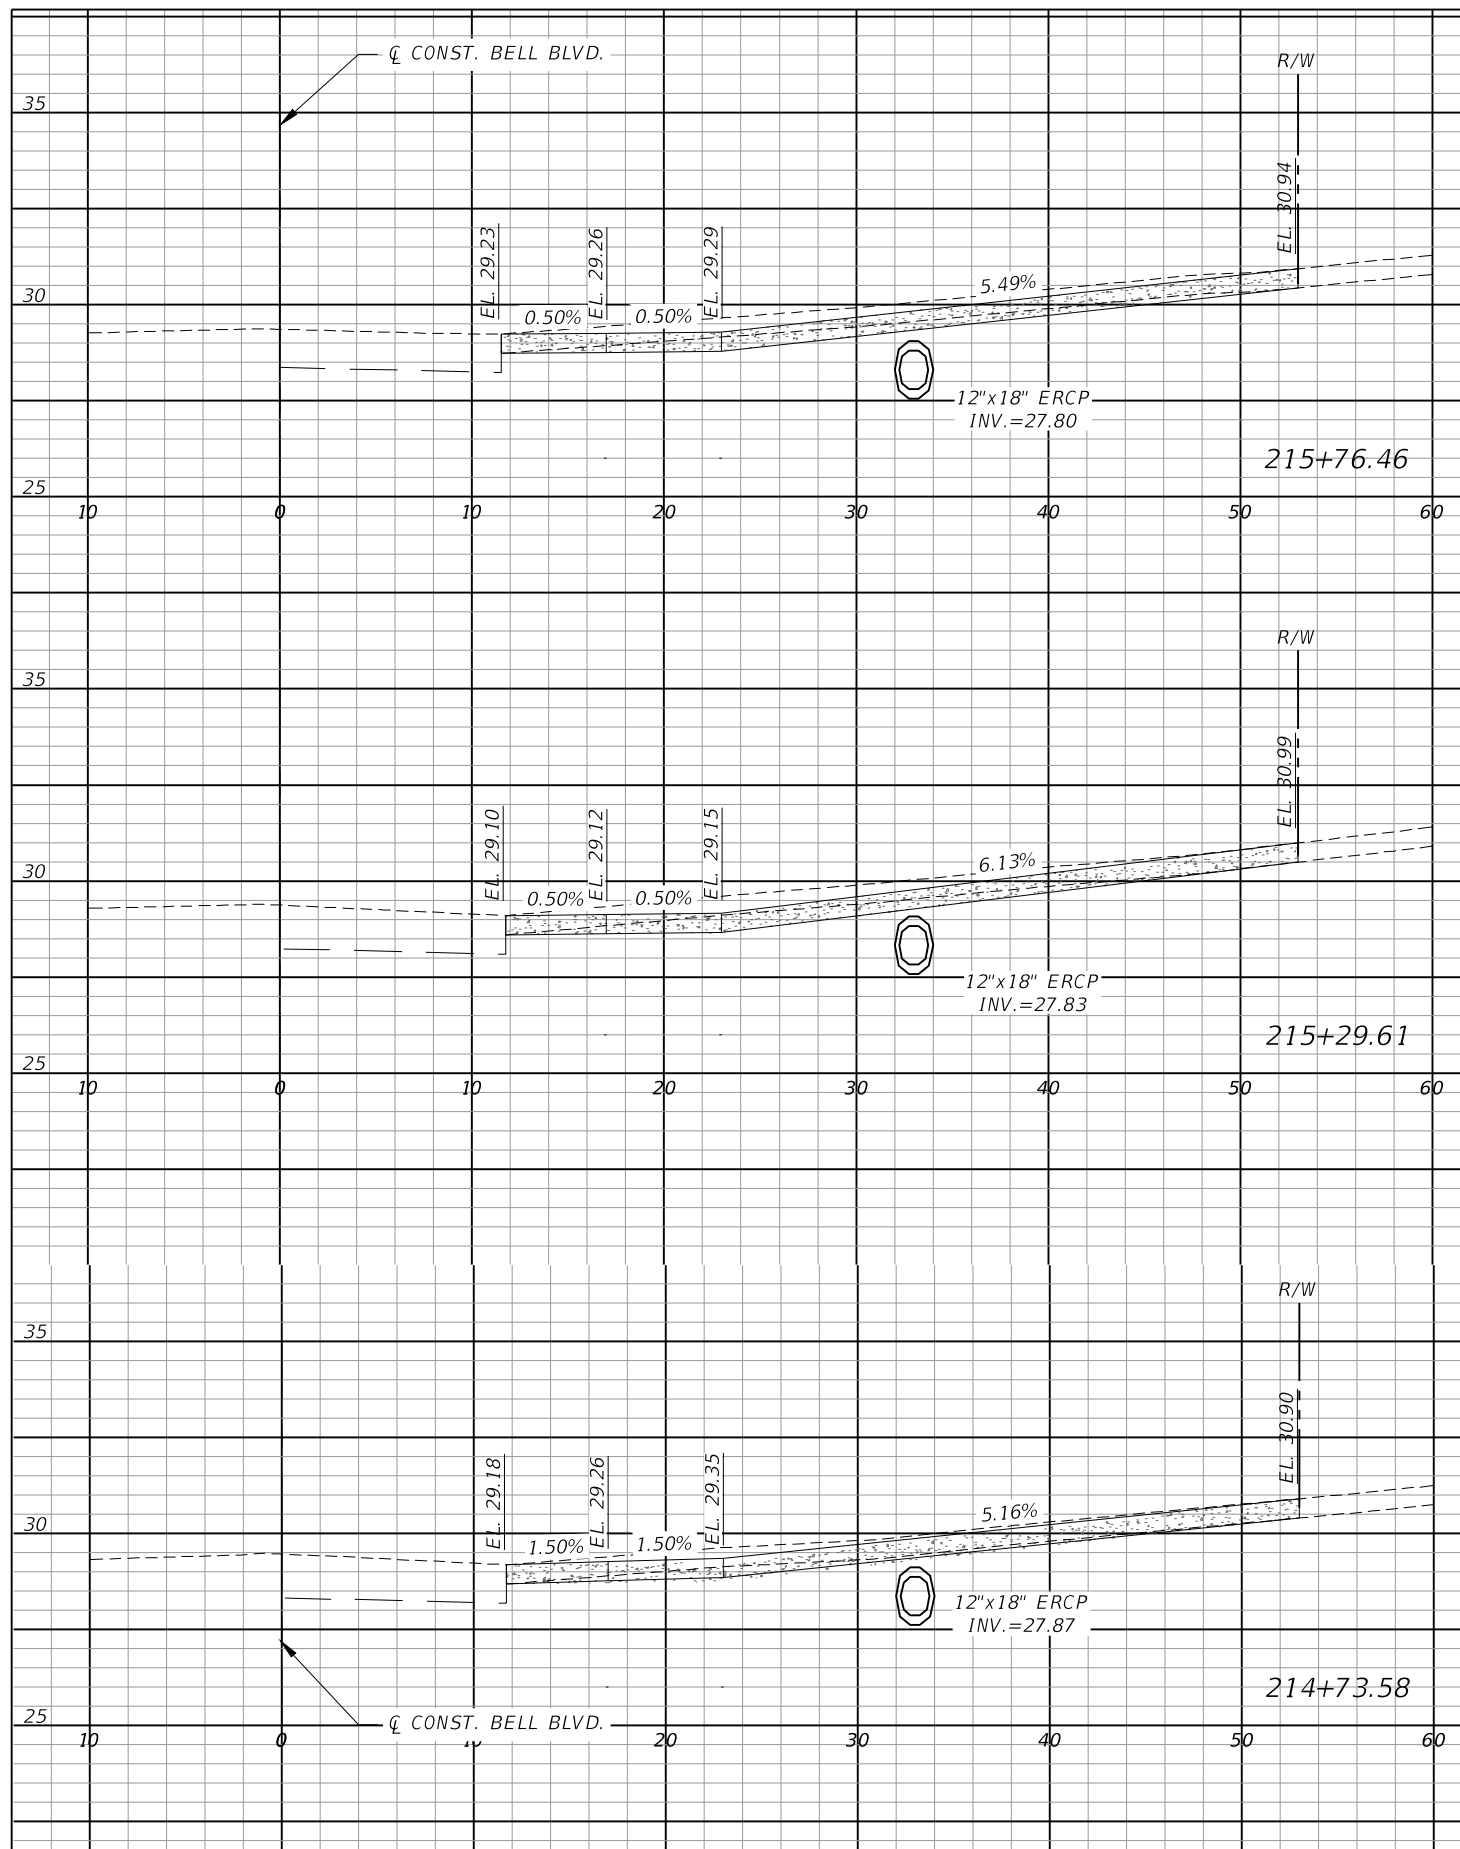

REVISIONS			
DATE	DESCRIPTION	DATE	DESCRIPTION




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 Bonita Springs, Florida 34134  
 Phone: 239.947.1144  
 R. DANIEL FLYNN, P.E. NO. 76205



LEE COUNTY	
ROAD NO.	COUNTY PROJECT NO.
BELL BLVD. SR 82 TO SUNRISE BLVD. SIDEWALK	6002

DRIVEWAY CROSS SECTIONS BELL BLVD. (10)	
SHEET NO.	131



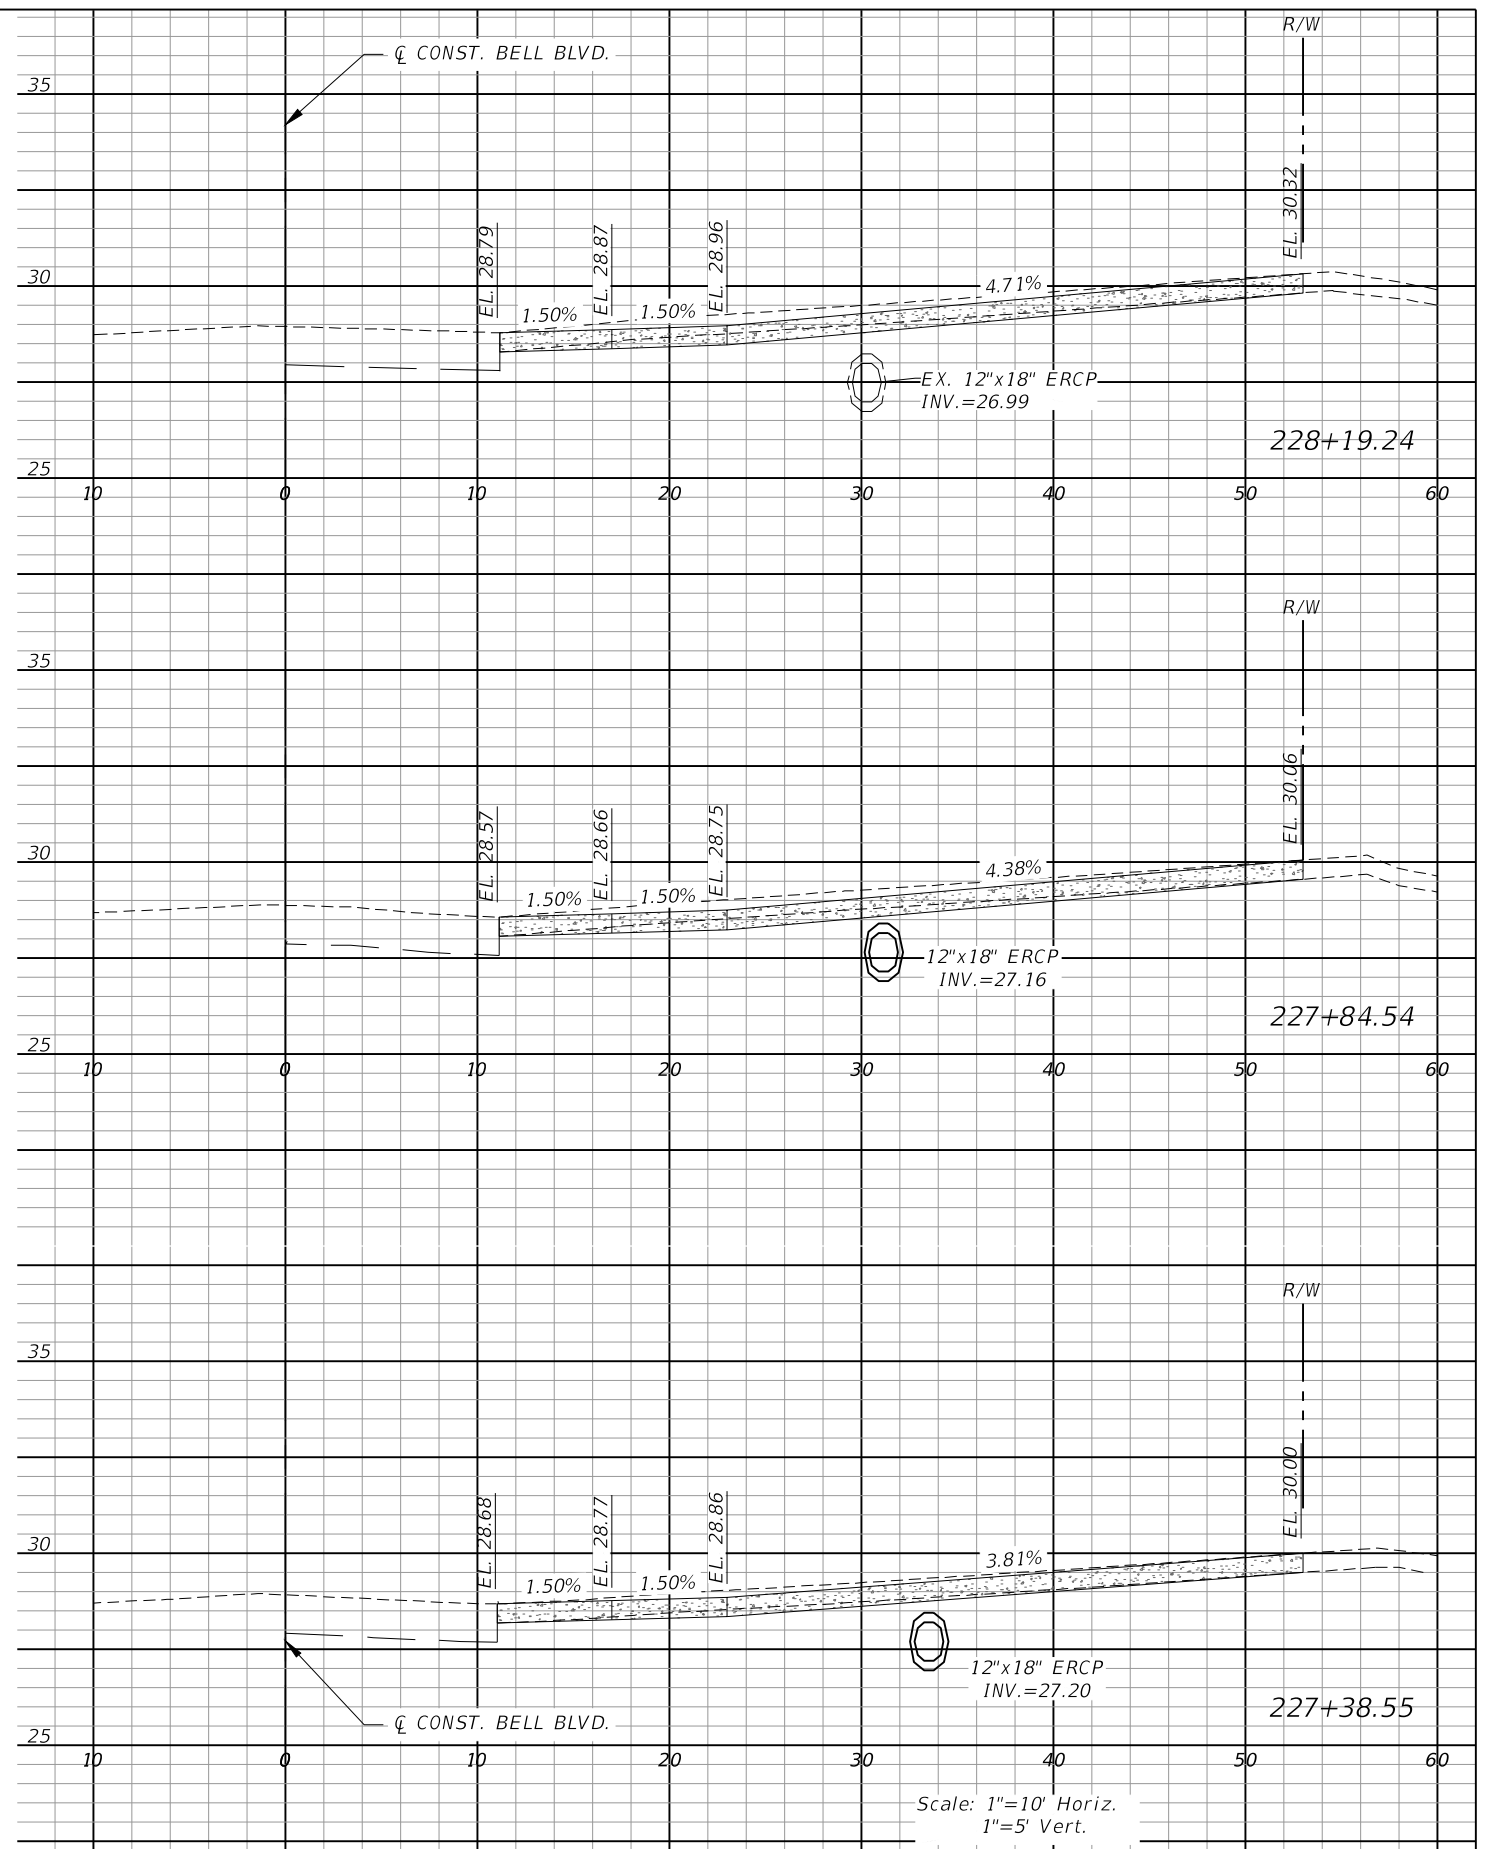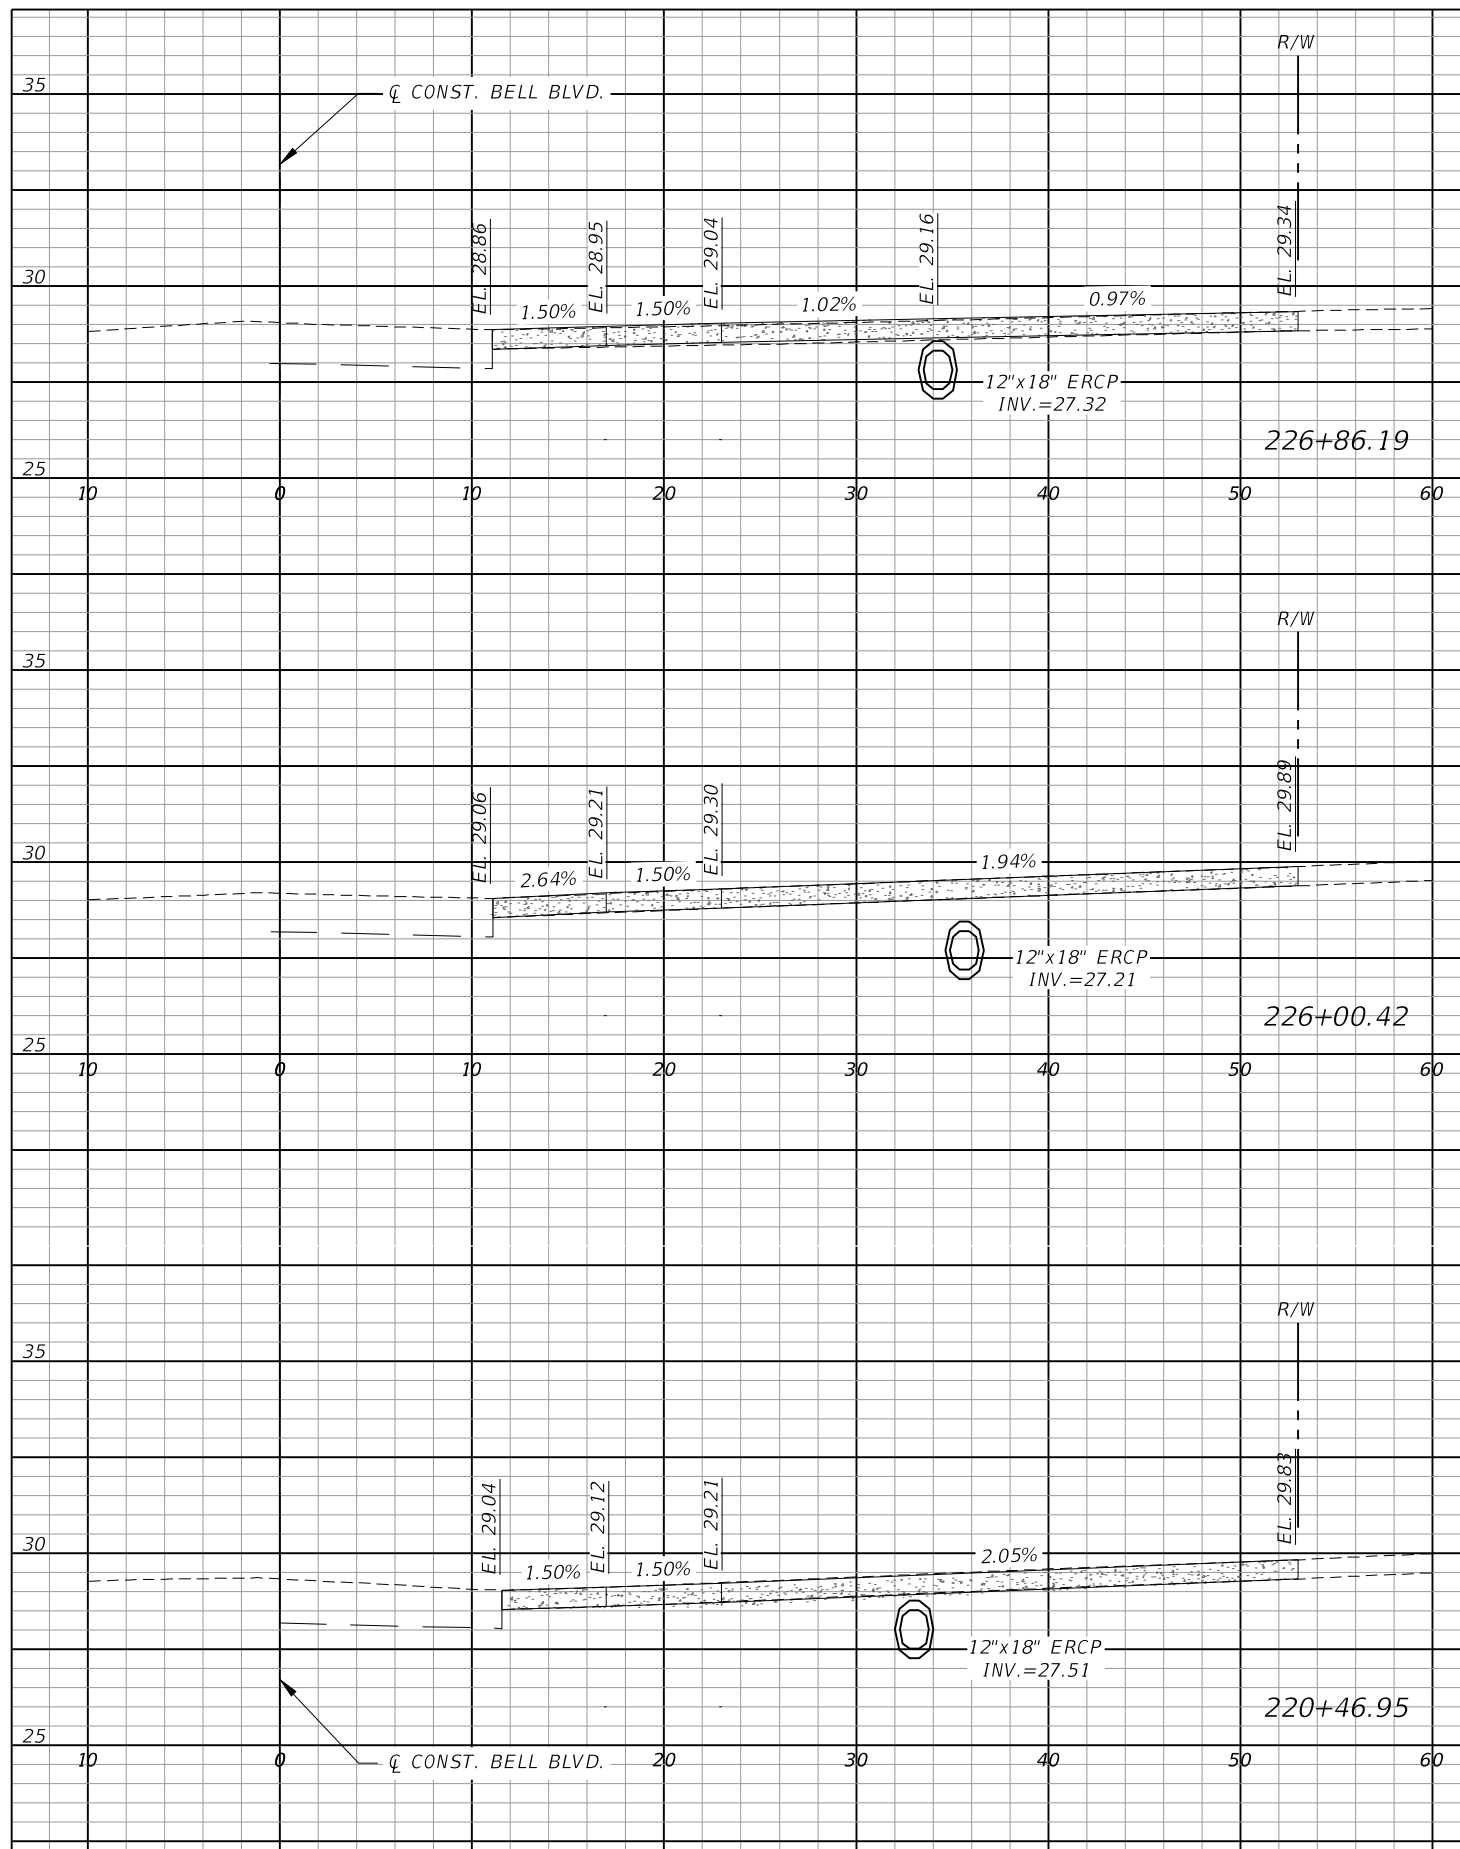


REVISIONS				 <b>Q. Grady Minor and Associates, P.A.</b> 3800 Via Del Rey Bonita Springs, Florida 34134 Phone: 239.947.1144 R. DANIEL FLYNN, P.E. NO. 76205	<b>LEE COUNTY</b> ROAD NO. COUNTY PROJECT NO. BELL BLVD. SR 82 TO SUNRISE BLVD. SIDEWALK 6002	<b>DRIVEWAY CROSS SECTIONS</b> <b>BELL BLVD. (11)</b>	SHEET NO. <b>132</b>
DATE	DESCRIPTION	DATE	DESCRIPTION				
				<small>Civil Engineers • Land Surveyors • Planners • Landscape Architects</small> <small>Cert. of Auth. EB 0005131 Cert. of Auth. LB 0005131 Business Lic. 26000266</small>			

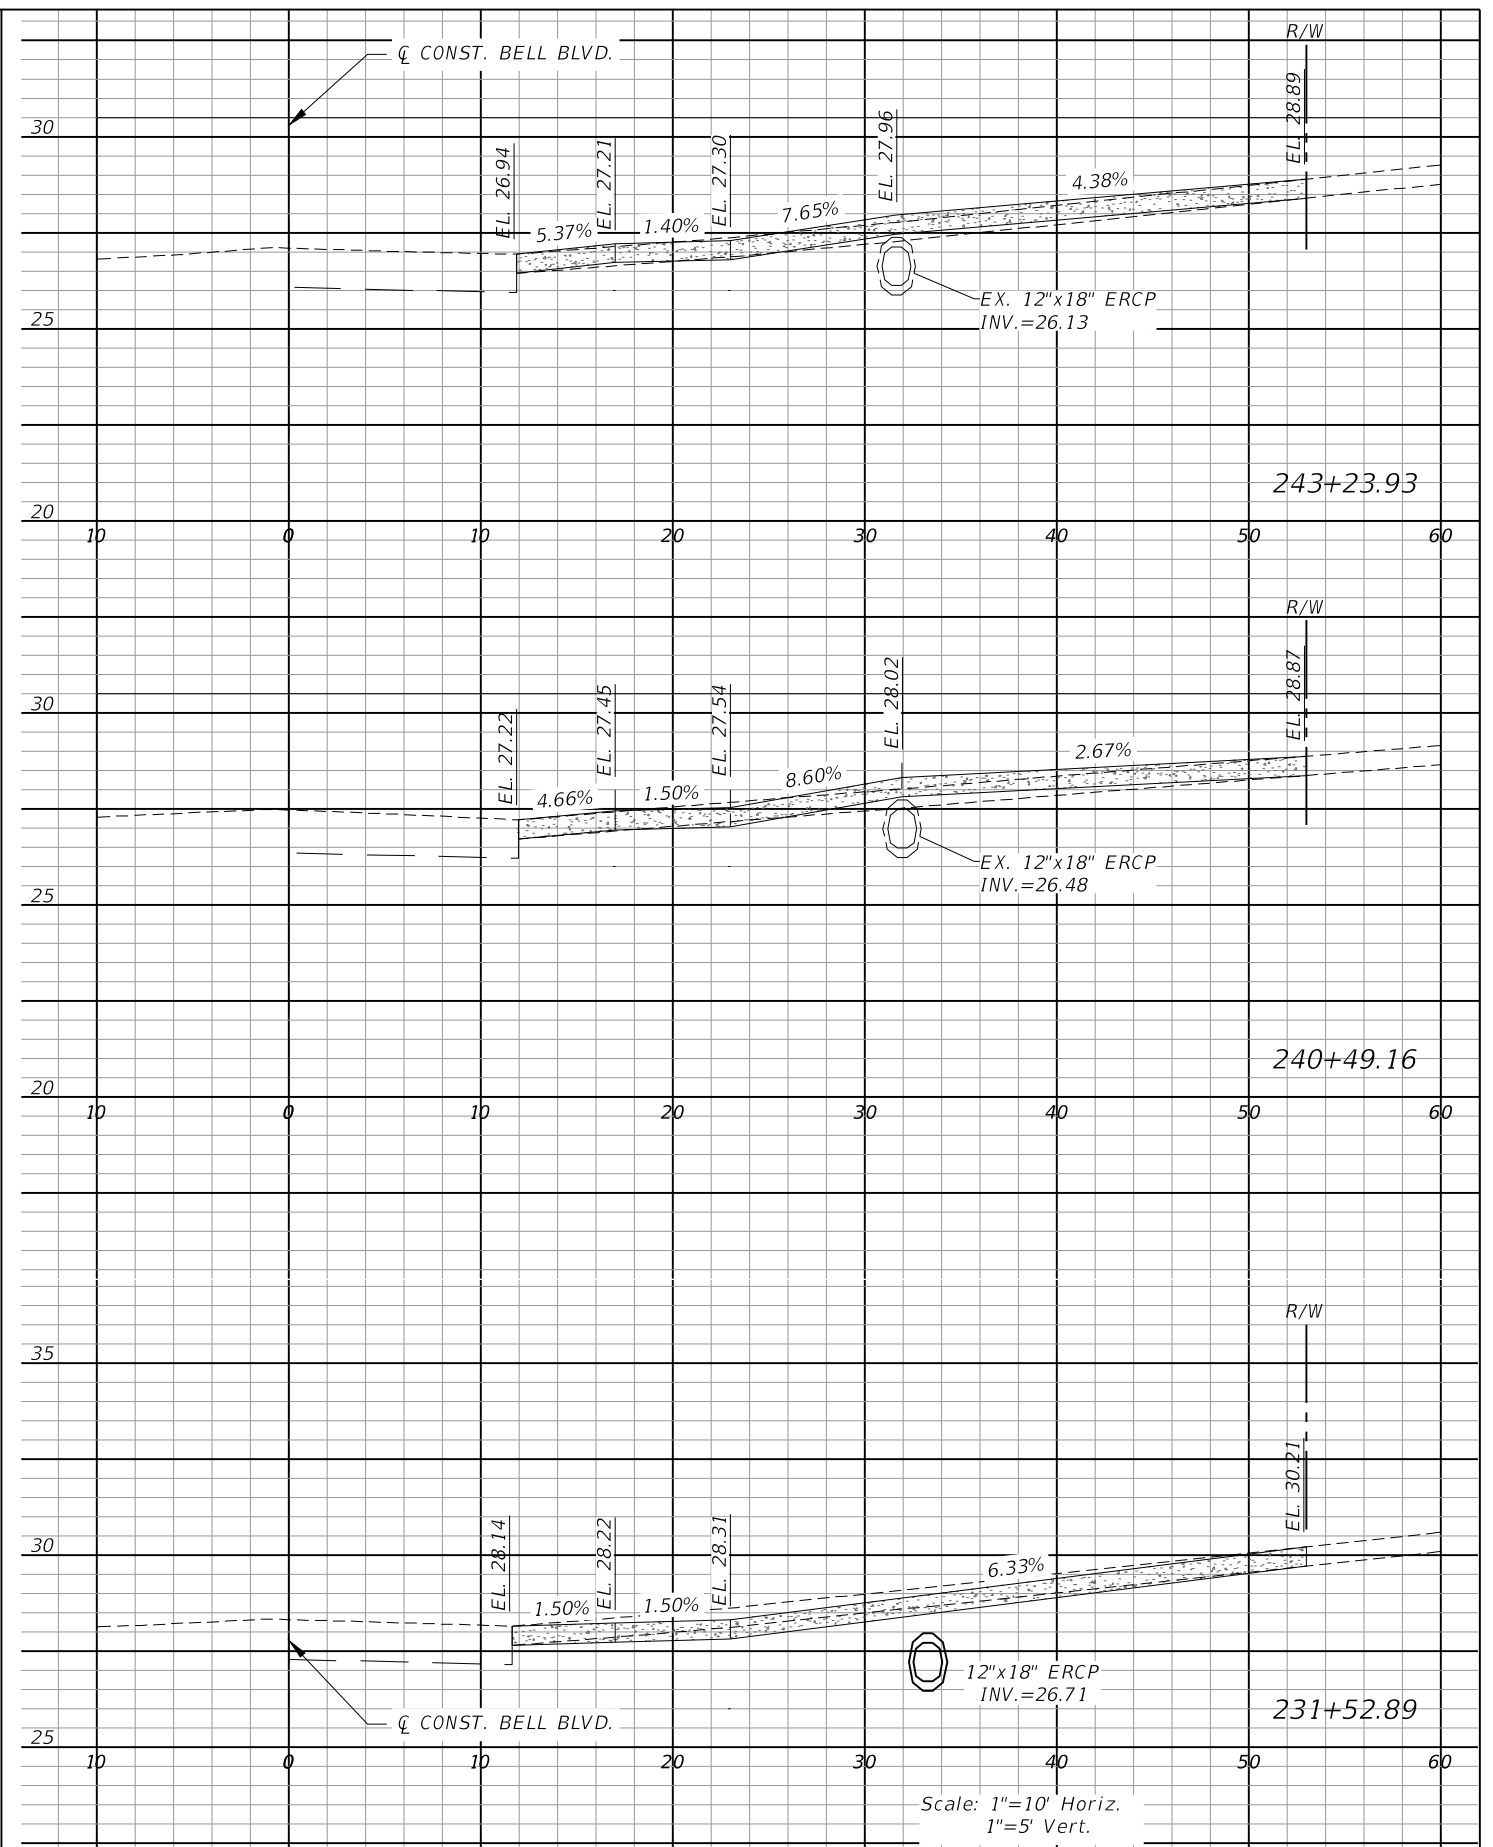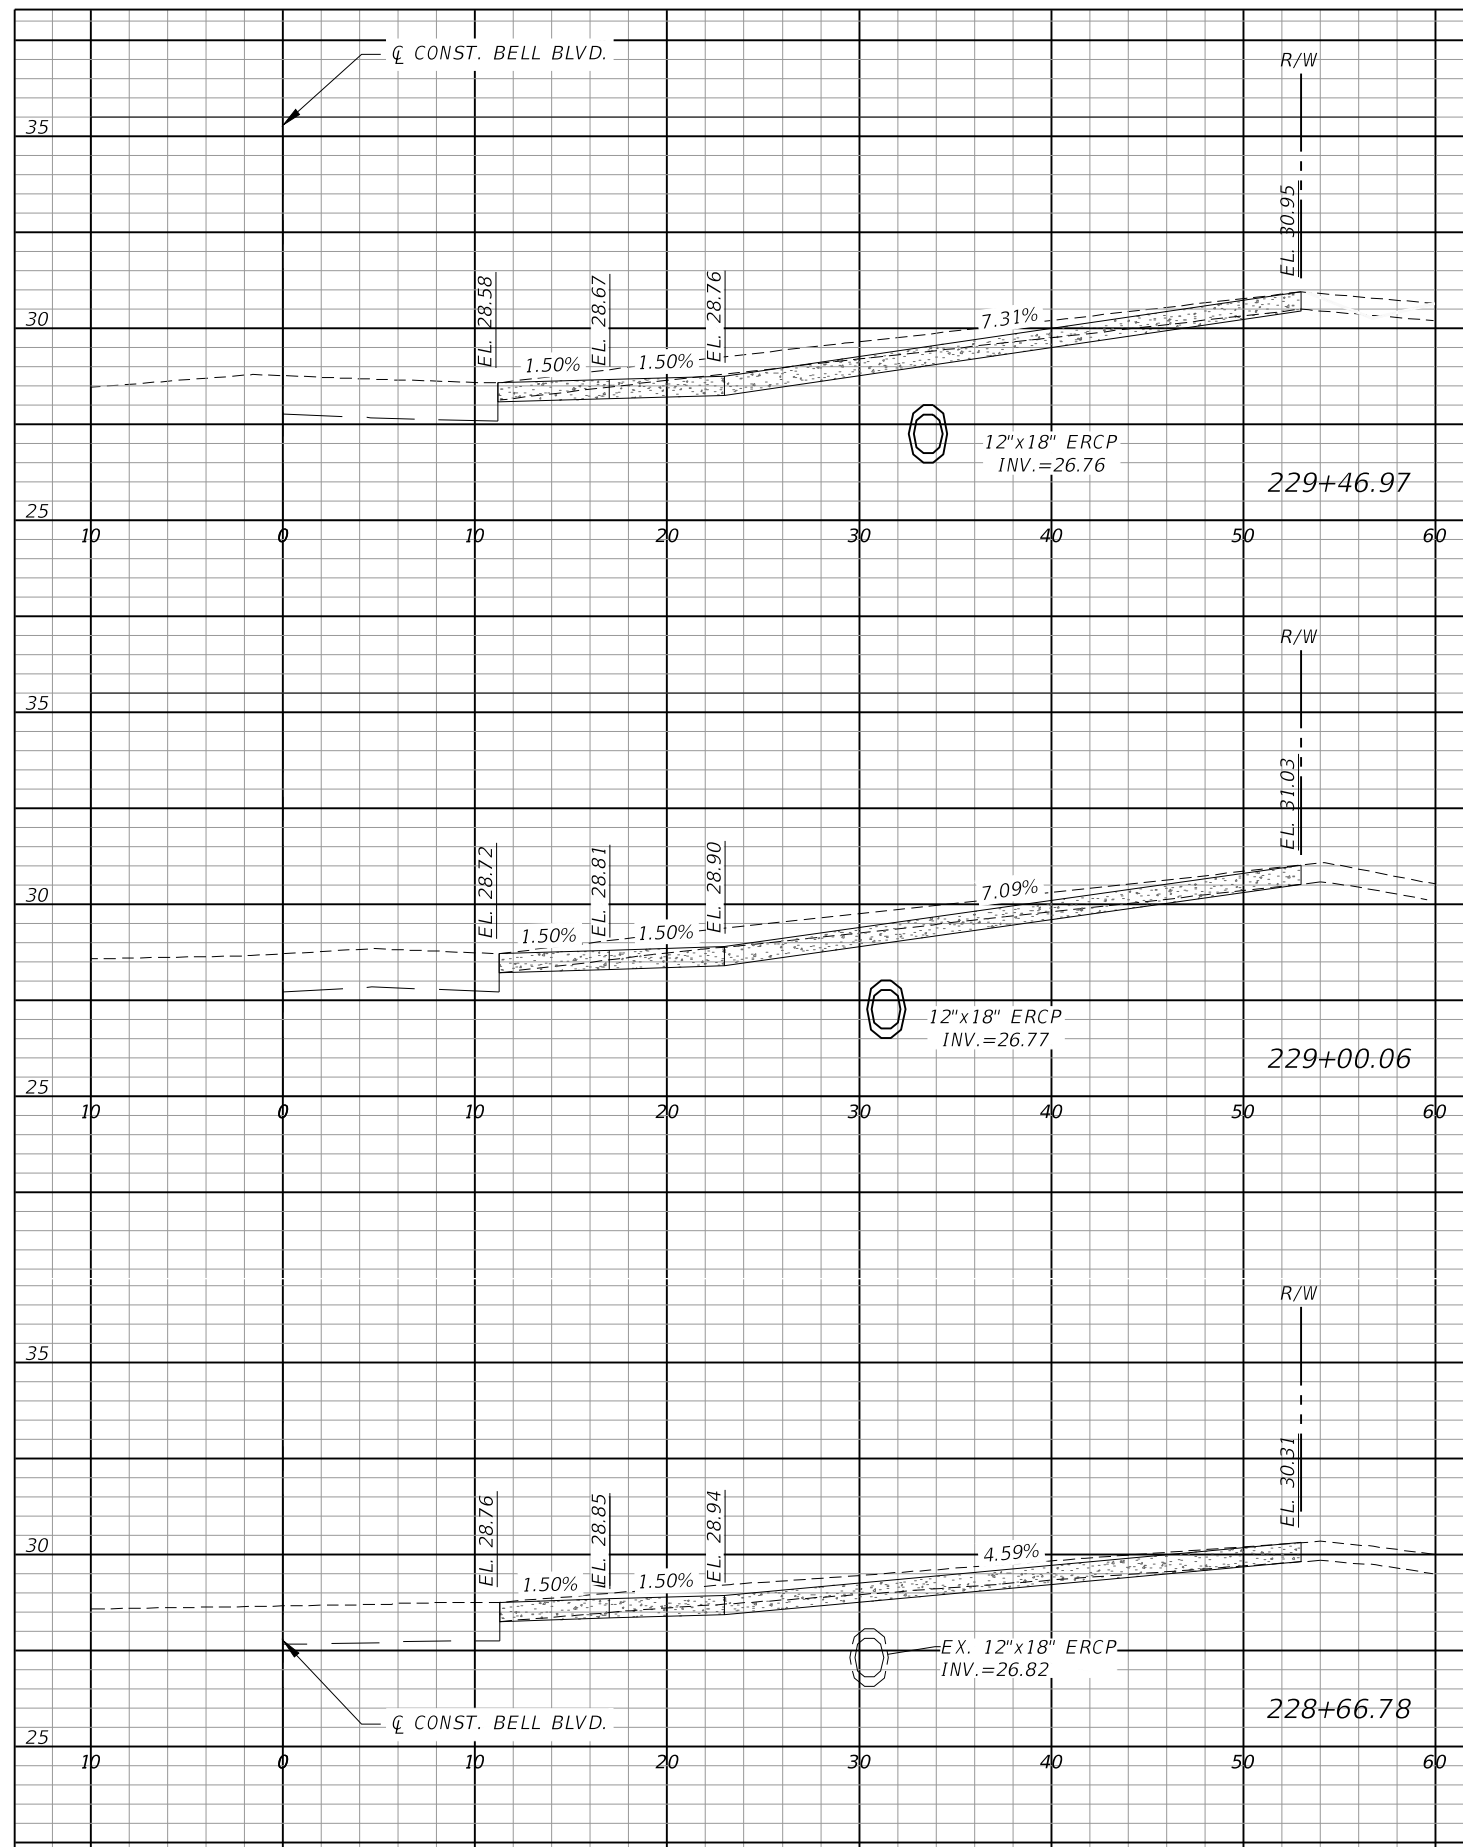



R E V I S I O N S			
DATE	DESCRIPTION	DATE	DESCRIPTION

 **Q. Grady Minor and Associates, P.A.**  
3800 Via Del Rey  
Bonita Springs, Florida 34134  
Phone: 239.947.1144  
**GradyMinor** R. DANIEL FLYNN, P.E. NO. 76205


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<i>LEE COUNTY</i>	
<i>ROAD NO.</i>	<i>COUNTY PROJECT NO.</i>
<i>BELL BLVD. SR 82 TO SUNRISE BLVD. SIDEWALK</i>	<i>6002</i>

<div style="text-align: center;"> <i>DRIVEWAY CROSS SECTIONS</i>  <i>BELL BLVD. (12)</i> </div>	<div style="text-align: center;"> <i>SHEET</i>  <i>NO.</i> </div>
	<div style="text-align: center;"> <b>133</b> </div>

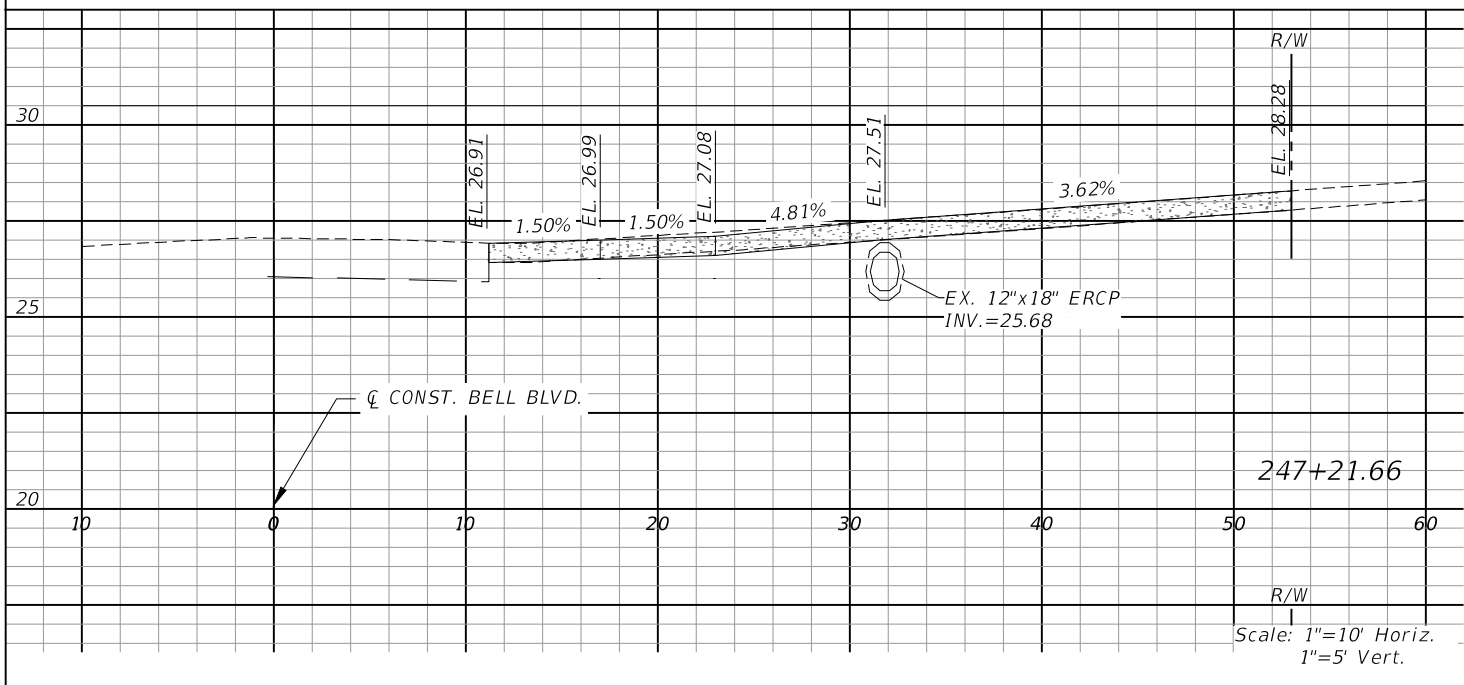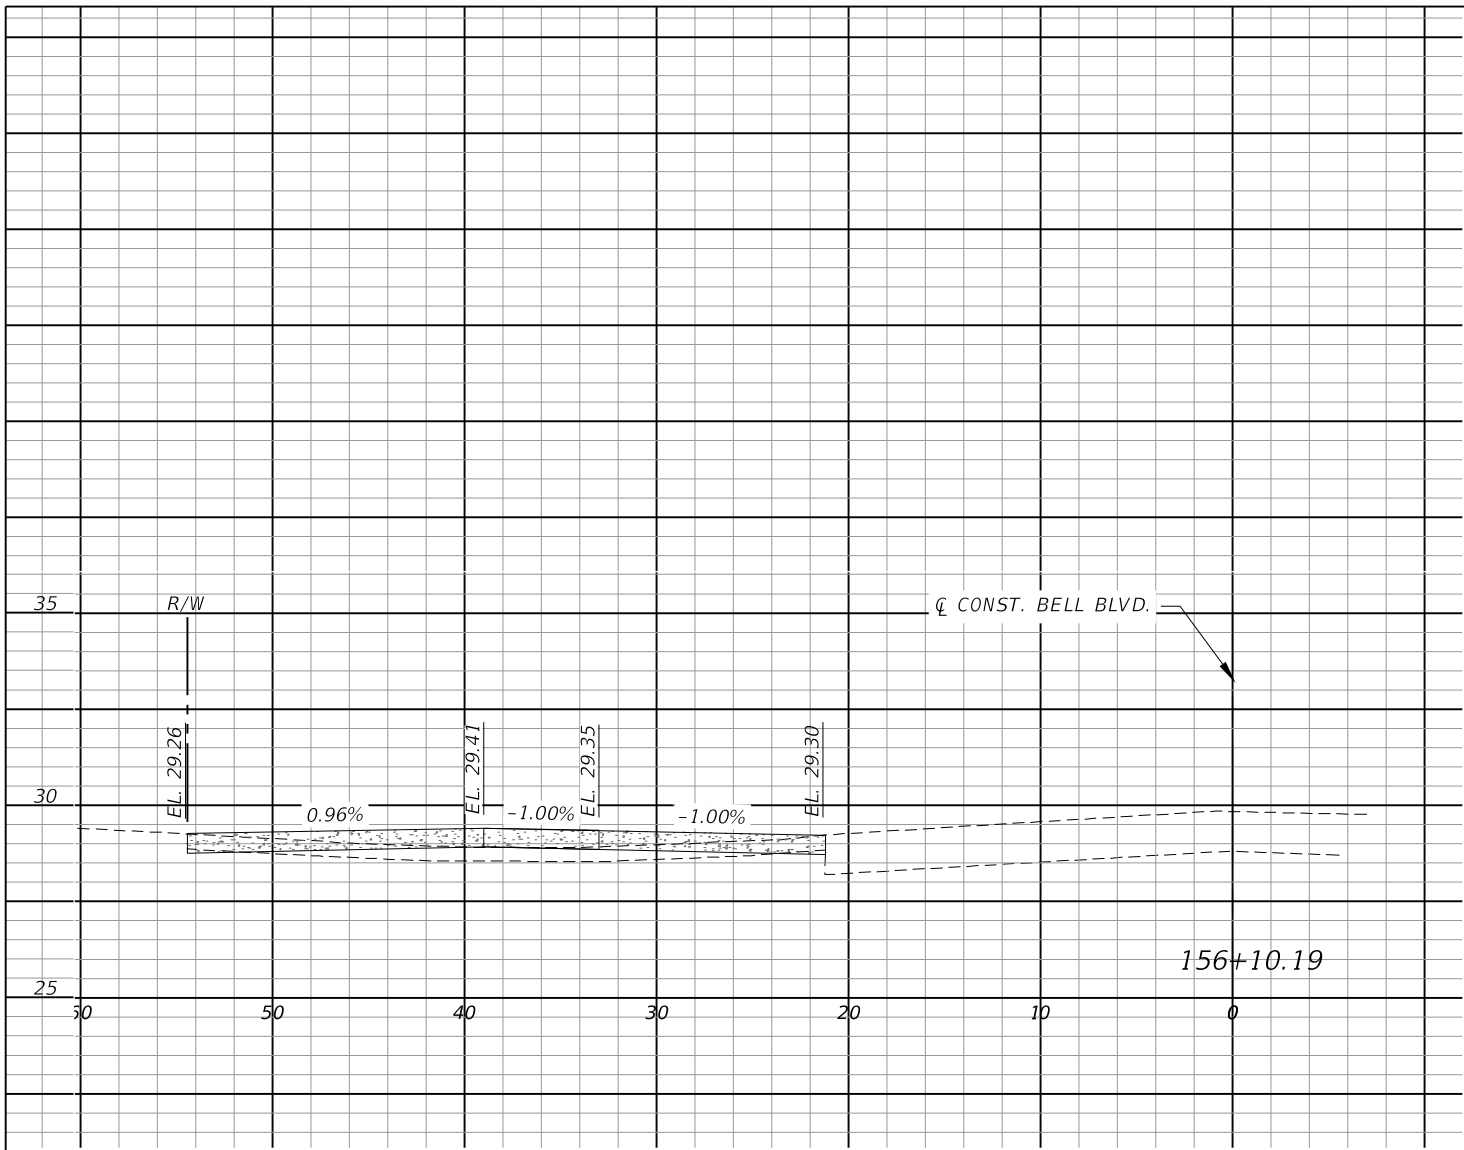

REVISIONS			
DATE	DESCRIPTION	DATE	DESCRIPTION


**GradyMinor**  
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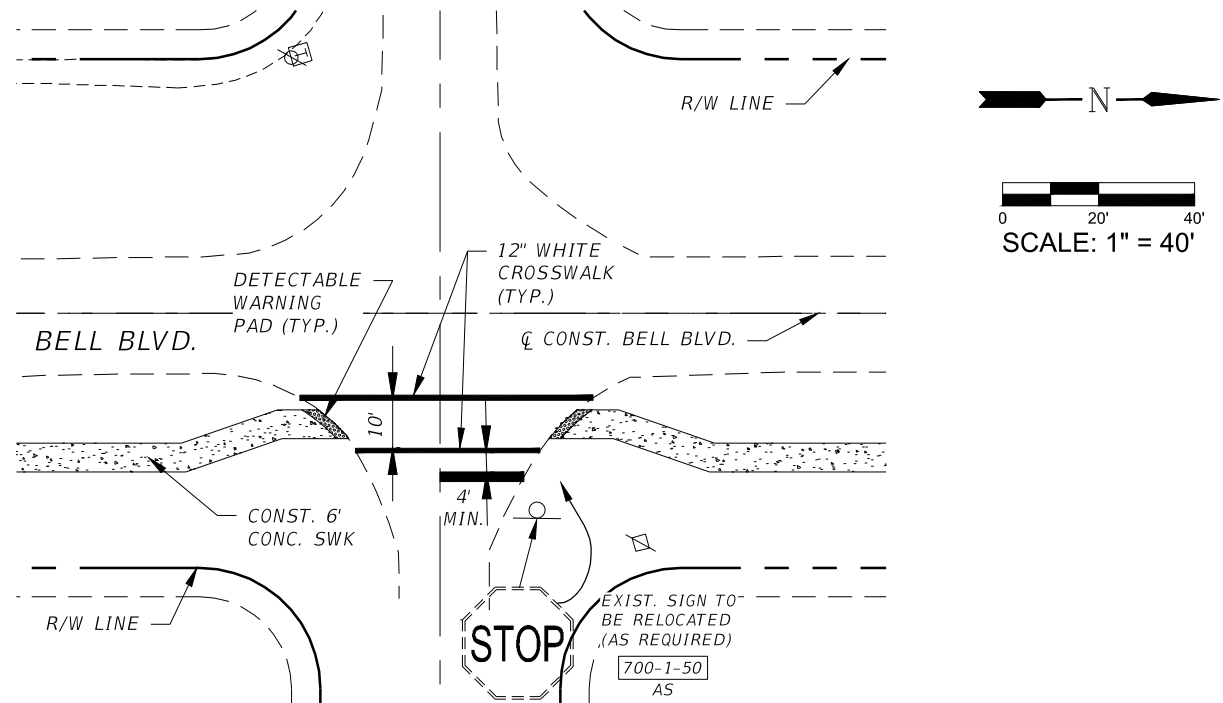
LEE COUNTY	
ROAD NO.	COUNTY PROJECT NO.
BELL BLVD. SR 82 TO SUNRISE BLVD. SIDEWALK	6002

DRIVEWAY CROSS SECTIONS	
BELL BLVD. (13)	


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134

SIDE STREETS


MEADOW RD.  
ANCHOR ST.  
ALAMO ST. E  
NIMITZ BLVD.  
ASHER ST. E  
FOXTAIL ST. E  
NEWELL ST. E  
LAMAR ST. E  
JAGUAR BLVD.  
COLYER ST. E  
BRAZOS ST. E  
BENTLEY ST. E  
CHARLES SISE ST. E  
CASPER YOST ST. E  
KINGSBURY CT.  
THEODORE VAIL ST. E  
CHEMSTRAND ST. E  
GRANT BLVD.  
CARBON ST. E  
CALUMET ST. E  
CADIS ST. E  
ASHLAND ST. E



TYPICAL INTERSECTION SIGNING AND STRIPING ALONG BELL BLVD.

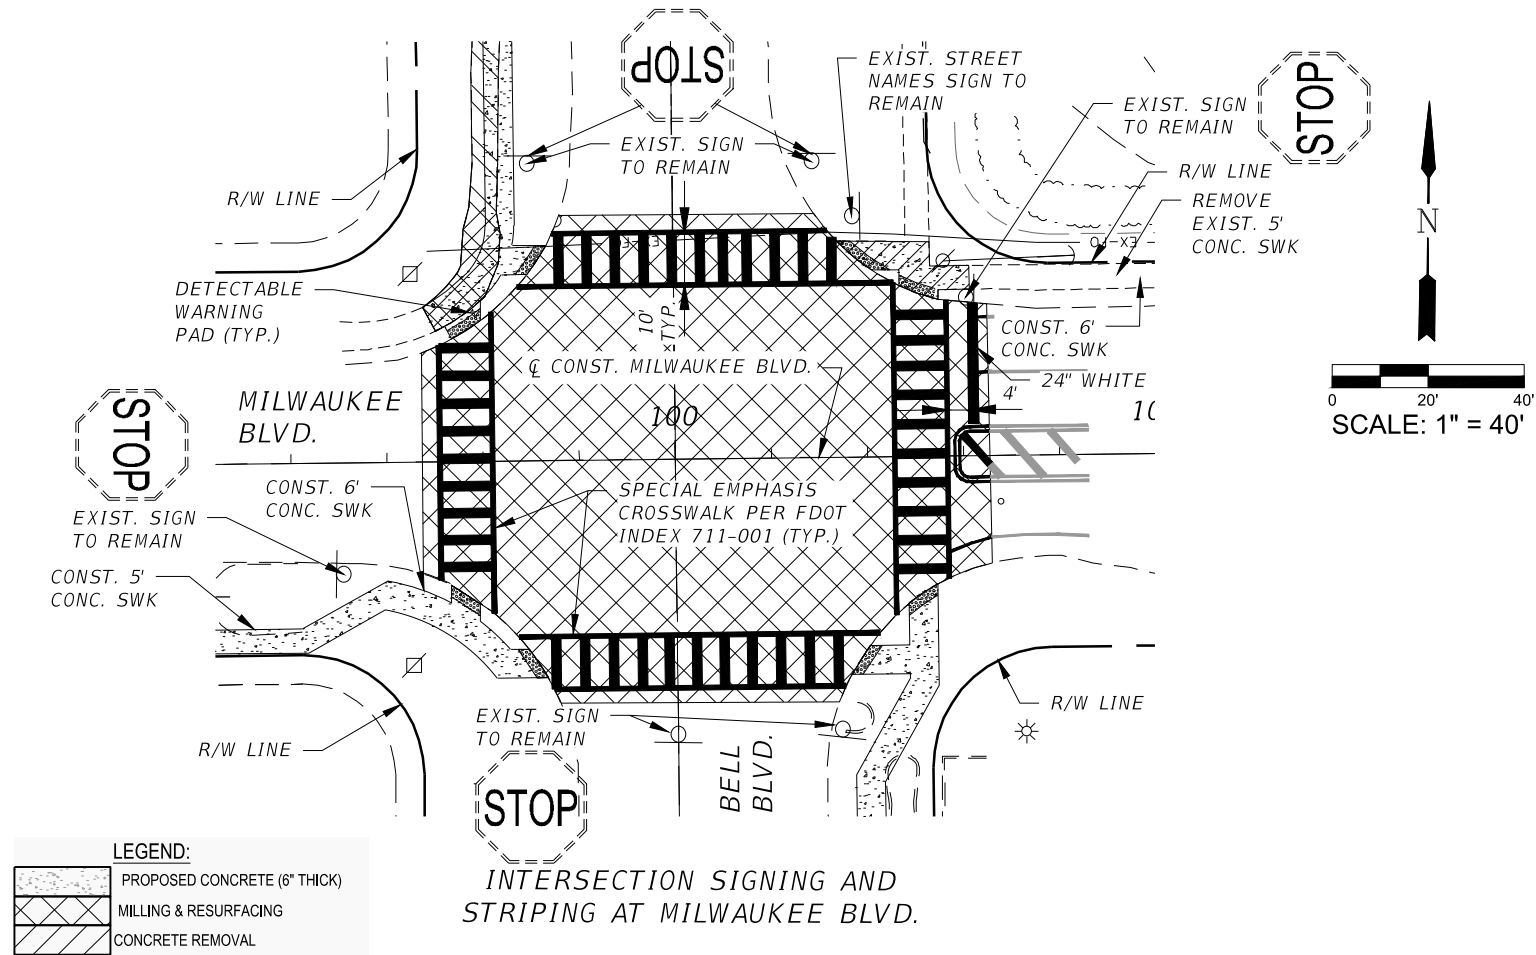

INTERSECTION SIGNING AND STRIPING AT MILWAUKEE BLVD.

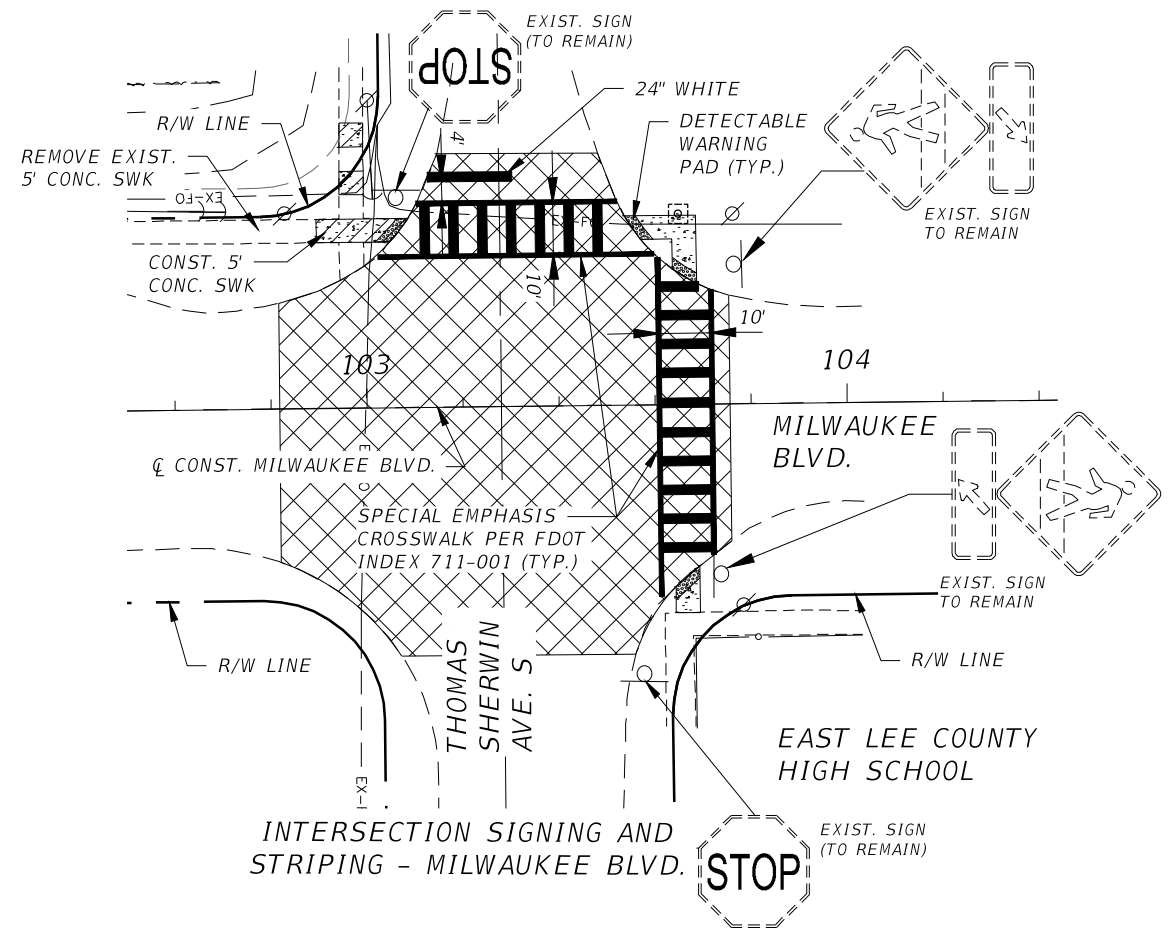

INTERSECTION SIGNING AND STRIPING - MILWAUKEE BLVD.

REVISIONS			
DATE	DESCRIPTION	DATE	DESCRIPTION



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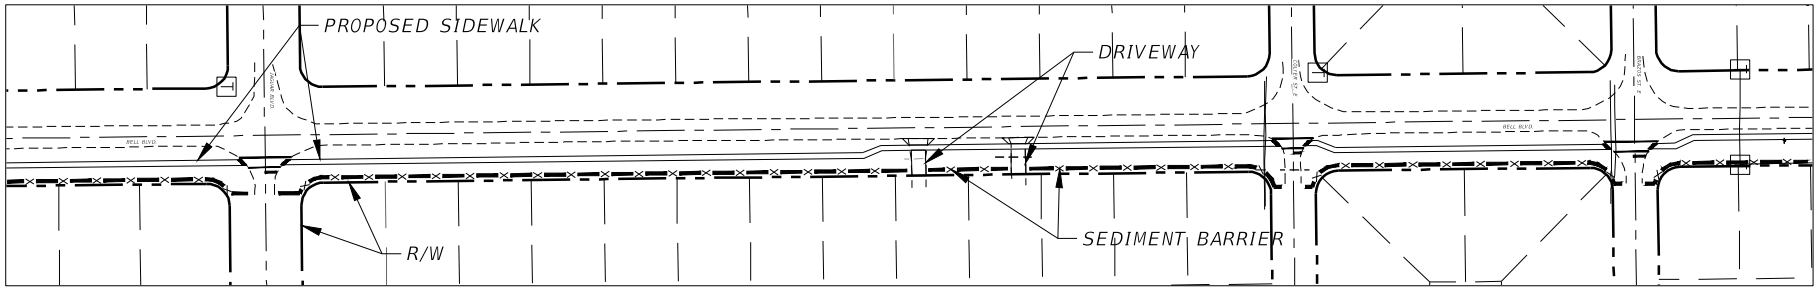
LEE COUNTY	
ROAD NO.	COUNTY PROJECT NO.
BELL BLVD. SR 82 TO SUNRISE BLVD. SIDEWALK	6002

**INTERSECTION SIGNING AND PAVEMENT MARKING TYPICAL DETAILS**

SHEET NO.
135



TYPICAL EROSION CONTROL WITH ROADSIDE DITCH SYSTEM  
1" = 40'

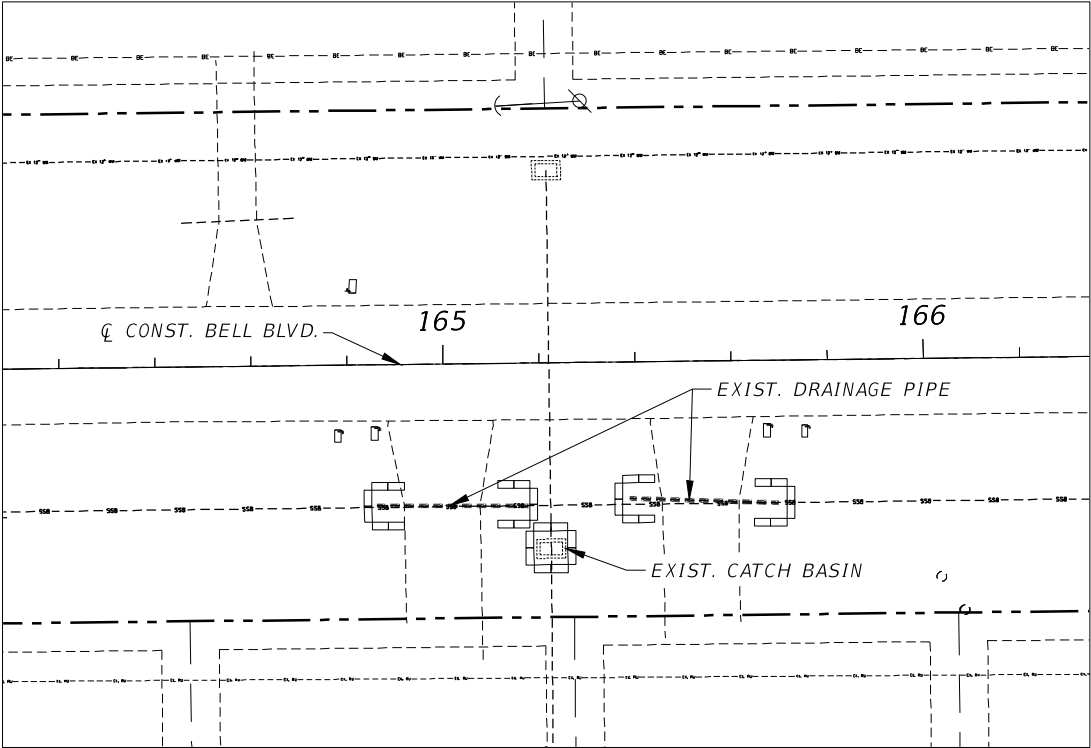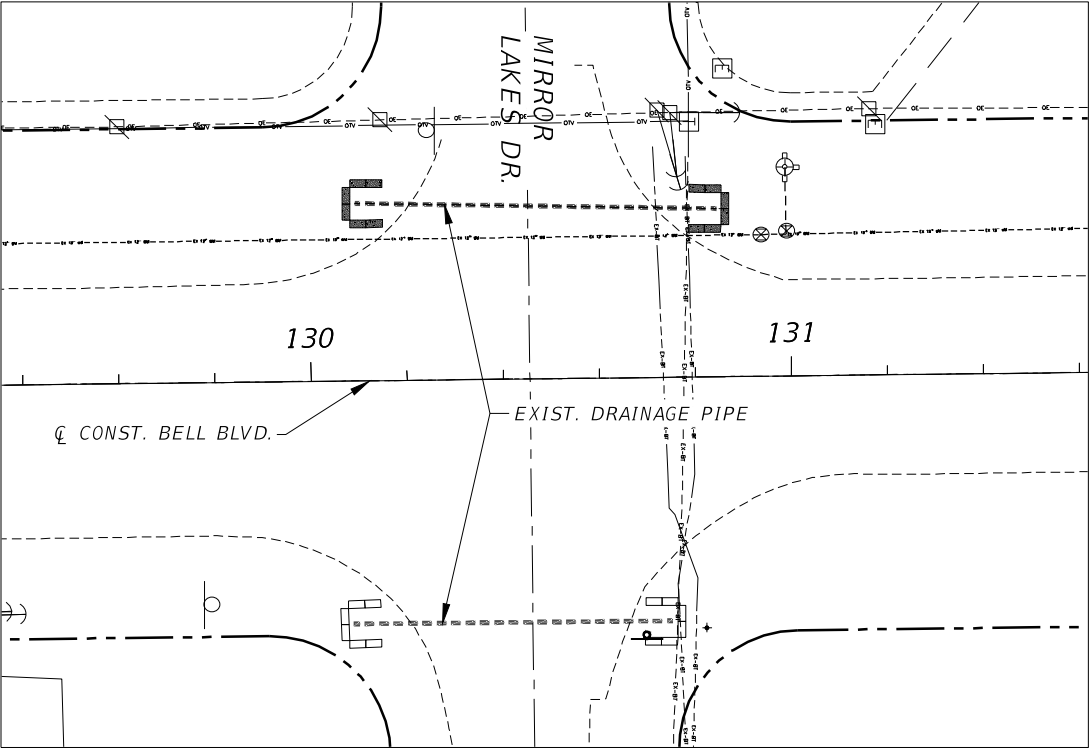

TYPICAL SEDIMENT BARRIER INSTALLATION  
NTS

STRUCTURE TYPE	INLET PROTECTION SYSTEM PAY ITEM 104-18 (EA)	SEDIMENT BARRIER PAY ITEM 104-10-3 (LF)
DITCH BOTTOM INLETS AND MITERED END SECTIONS	66	21,158

NOTE:  
TYPICAL EROSION CONTROL FOR DBI AND UNPAVED DITCHES  
REFER TO THE "STATE OF FLORIDA EROSION AND SEDIMENT  
CONTROL DESIGNER AND REVIEWER MANUAL

- LEGEND
- INLET PROTECTION SYSTEM
  - SEDIMENT BARRIER

REVISIONS				<div><p>Q. Grady Minor and Associates, P.A. 3800 Via Del Rey Bonita Springs, Florida 34134 Phone: 239.947.1144 R. DANIEL FLYNN, P.E. NO. 76205</p><p><b>GradyMinor</b></p><p>Civil Engineers • Land Surveyors • Planners • Landscape Architects <small>Cert. of Auth. EB 0005151    Cert. of Auth. LB 0005151    Business LC 26000266</small></p></div>	LEE COUNTY		EROSION CONTROL PLAN	SHEET NO.
DATE	DESCRIPTION	DATE	DESCRIPTION		ROAD NO.	COUNTY PROJECT NO.		136
					BELL BLVD. SR 82 TO SUNRISE BLVD. SIDEWALK	6002		

THE FOLLOWING NARRATIVE OF THE STORMWATER POLLUTION PREVENTION PLAN CONTAINS REFERENCES TO THE STANDARD SPECIFICATIONS ROAD AND BRIDGE CONSTRUCTION, THE DESIGN STANDARDS, AND OTHER SHEETS OF THESE CONSTRUCTION PLANS. THE FIRST SHEET OF THE CONSTRUCTION PLANS (CALLED THE KEY SHEET) CONTAINS AN INDEX TO THE OTHER SHEETS. THE COMPLETE STORMWATER POLLUTION PREVENTION PLAN INCLUDES SEVERAL ITEMS: THIS NARRATIVE DESCRIPTION, THE DOCUMENTS REFERENCED IN THIS NARRATIVE, THE CONTRACTOR'S APPROVED EROSION CONTROL PLAN REQUIRED BY SPECIFICATION SECTION 104, AND REPORTS OF INSPECTIONS MADE DURING CONSTRUCTION.

1.0 SITE DESCRIPTION:

1.A. NATURE OF CONSTRUCTION ACTIVITY:

THIS PROJECT CONSIST OF THE CONSTRUCTION OF NEW 6 FOOT SIDEWALK ALONG THE EASTERN SIDE OF ALEXANDER GRAHAM BELL BLVD. FOR APPROXIMATELY 4 MILES. THE PROJECT BEGINS ON THE NORTH SIDE OF SR-82 AT THE INTERSECTION OF ALEXANDER GRAHAM BELL BLVD. AND EXTENDS NORTH TO SUNRISE BOULEVARD.

1.B. SEQUENCE OF MAJOR SOIL DISTURBING ACTIVITIES:

IN THE SEDIMENT AND EROSION CONTROL PLAN, THE CONTRACTOR SHALL PROVIDE A DETAILED SEQUENCE OF CONSTRUCTION FOR ALL CONSTRUCTION ACTIVITIES. THE CONTRACTOR SHALL FOLLOW THE SEQUENCE OF MAJOR ACTIVITIES DESCRIBED BELOW, UNLESS THE CONTRACTOR PROPOSED A DIFFERENT SEQUENCE THAT IS EQUAL OR BETTER AT CONTROLLING EROSION AND TRAPPING SEDIMENT AND IS APPROVED BY THE ENGINEER.

FOR EACH CONSTRUCTION PHASE, INSTALL PERIMETER CONTROLS AFTER CLEARING AND GRUBBING NECESSARY FOR INSTALLATION OF CONTROLS BUT BEFORE BEGINNING OTHER WORK FOR THE CONSTRUCTION PHASE. REMOVE PERIMETER CONTROLS ONLY AFTER ALL UPSTREAM AREAS ARE STABILIZED.

- CLEARING AND GRUBBING, EARTHWORK, AND STORM DRAIN CONSTRUCTION.
- STORM DRAIN. CONSTRUCT THE STORM DRAIN PIPE IN THE UPSTREAM DIRECTION.
- EARTHWORK ASSOCIATED WITH THE CONSTRUCTION OF SIDEWALK AND DRIVEWAYS.

1.C. AREA ESTIMATES:

TOTAL SITE AREA: 89.64 ACRES.  
TOTAL AREA TO BE DISTURBED: 19.68 ACRES.

1.D. RUNOFF DATA:

RUNOFF COEFFICIENTS:  
BEFORE: 0.35  
DURING: VARIES FROM 0.35 TO 0.38  
AFTER: 0.38

SOILS DATA: THE RESULTS OF THE SOIL BORINGS ALONG THE PROPOSED MULTI-USE TRAIL ARE SHOWN IN THE FINAL GEOTECHNICAL ENGINEERING SERVICES REPORT. IN GENERAL, THE SUBSURFACE SOILS ENCOUNTERED AT THE HAND AUGER BORING LOCATIONS CONSISTED OF POORLY-GRADED FINE SAND TO FINE SAND WITH SILT (A-3). LAYERS AND POCKETS OF CLAYEY AND SILTY SANDS (A-2+4, A-2-6) WERE ALSO ENCOUNTERED ALONG THE ALIGNMENT OF THE 6 FT SIDEWALK.

OUTFALL INFORMATION:

THERE ARE 10 OUTFALLS.

- #1

DESCRIPTION: EXISTING DRAINAGE SWALE OUT FALLING TO PALMETTO CANAL  
STATION - 49+00  
LOCATION: LATITUDE 26° 32' 2.36" N, LONGITUDE, 81° 36' 18.36" W.  
EST. DRAINAGE AREA SIZE: 10.10 ACRES.  
RECEIVING WATER NAME: PALMETTO CANAL
- #2

DESCRIPTION: EXISTING DRAINAGE SWALE OUT FALLING TO BLUE HERON CANAL  
STATION - 74+00  
LOCATION: LATITUDE 26° 32' 27.52" N, LONGITUDE, 81° 36' 13.72" W.  
EST. DRAINAGE AREA SIZE: 13.33 ACRES.  
RECEIVING WATER NAME: BLUE HERON CANAL
- #3

DESCRIPTION: EXISTING DRAINAGE SWALE OUT FALLING TO GALLINULE CANAL  
STATION - 91+00  
LOCATION: LATITUDE 26° 32' 44.58" N, LONGITUDE, 81° 36' 12.79" W.  
EST. DRAINAGE AREA SIZE: 6.45 ACRES.  
RECEIVING WATER NAME: GALLINULE CANAL
- #4

DESCRIPTION: EXISTING DRAINAGE SWALE OUT FALLING TO KINGFISCHER CANAL  
STATION - 111+00  
LOCATION: LATITUDE 26° 33' 4.55" N, LONGITUDE, 81° 36' 14.80" W.  
EST. DRAINAGE AREA SIZE: 6.23 ACRES.  
RECEIVING WATER NAME: KINGFISCHER CANAL
- #5

DESCRIPTION: EXISTING DRAINAGE STRUCTURE OUT FALLING TO IBIS CANAL  
STATION - 128+50  
LOCATION: LATITUDE 26° 33' 24.48" N, LONGITUDE, 81° 36' 15.34" W.  
EST. DRAINAGE AREA SIZE: 16.59 ACRES.  
RECEIVING WATER NAME: IBIS CANAL
- #6

DESCRIPTION: EXISTING DRAINAGE SWALE OUT FALLING TO COCPLUM CANAL  
STATION - 165+25  
LOCATION: LATITUDE 26° 33' 57.37" N, LONGITUDE, 81° 36' 19.84" W.  
EST. DRAINAGE AREA SIZE: 8.99 ACRES.  
RECEIVING WATER NAME: COCPLUM CANAL
- #7

DESCRIPTION: EXISTING DRAINAGE SWALE OUT FALLING TO ANHINGA CANAL  
STATION - 182+00  
LOCATION: LATITUDE 26° 34' 14.48" N, LONGITUDE, 81° 36' 16.04" W.  
EST. DRAINAGE AREA SIZE: 5.98 ACRES.  
RECEIVING WATER NAME: ANHINGA CANAL

- #8

DESCRIPTION: EXISTING DRAINAGE SWALE OUT FALLING TO HACKBERRY CANAL  
STATION - 208+00  
LOCATION: LATITUDE 26° 34' 40.94" N, LONGITUDE, 81° 36' 12.26" W.  
EST. DRAINAGE AREA SIZE: 5.87 ACRES.  
RECEIVING WATER NAME: HACKBERRY CANAL
- #9

DESCRIPTION: EXISTING DRAINAGE SWALE OUT FALLING TO OYSTER CATCHER CANAL  
STATION - 221+50  
LOCATION: LATITUDE 26° 34' 53.58" N, LONGITUDE, 81° 36' 11.87" W.  
EST. DRAINAGE AREA SIZE: 5.23 ACRES.  
RECEIVING WATER NAME: OYSTER CATCHER CANAL
- #10

DESCRIPTION: EXISTING DRAINAGE SWALE OUT FALLING TO OSPREY CANAL  
STATION - 236+00  
LOCATION: LATITUDE 26° 35' 7.42" N, LONGITUDE, 81° 36' 12.44" W.  
EST. DRAINAGE AREA SIZE: 10.87 ACRES.  
RECEIVING WATER NAME: OSPREY CANAL

- 1.E. SITE MAP:  
THE CONSTRUCTION PLANS ARE BEING USED AS THE SITE MAPS. THE LOCATION OF THE REQUIRED INFORMATION IS DESCRIBED BELOW. THE SHEET NUMBERS FOR THE PLAN SHEETS REFERENCED ARE IDENTIFIED ON THE KEY SHEET OF THESE CONSTRUCTION PLANS.
- \*

DRAINAGE PATTERNS: THE DRAINAGE BASIN DIVIDES AND FLOW DIRECTIONS ARE SHOWN ON THE DRAINAGE MAPS. THE ARROWS WITHIN THE RIGHT-OF-WAY AND FOR THE PROPERTIES ABUTTING THE RIGHT-OF-WAY REPRESENT THE FLOW DIRECTION. ARROWS ALONG THE EXISTING OUTFALL PIPES REPRESENT THE FLOW TO EACH CANAL FROM EACH BASIN.
- \*

APPROXIMATE SLOPES: THE SLOPES OF THE SITE CAN BE SEEN IN THE CROSS SECTION SHEETS AND THE PLAN-PROFILE SHEETS.
- \*

AREAS OF SOIL DISTURBANCE: THE AREAS TO BE DISTURBED ARE INDICATED ON THE PLAN-PROFILE SHEETS AND THE CROSS SECTION SHEETS. ANY AREAS WHERE PERMANENT FEATURES ARE SHOWN TO BE CONSTRUCTED ABOVE OR BELOW GROUND WILL BE DISTURBED.
- \*

AREAS NOT TO BE DISTURBED: AREAS THAT ARE OUTSIDE THE PROPOSED IMPROVEMENTS ARE SHOWN ON THE PLANS TO REMAIN AS EXISTING.
- \*

LOCATIONS OF TEMPORARY CONTROLS: THESE ARE SHOWN ON THE EROSION CONTROL SHEETS. TABLES PROVIDING SUMMARIES OF TEMPORARY EROSION AND SEDIMENT CONTROL ITEMS ARE PROVIDED ON THE SAME
- 1.F. RECEIVING WATERS:

SEE ITEM 1.D FOR THE OUTFALL LOCATIONS AND RECEIVING WATER NAMES. THERE ARE NO WETLAND AREAS ON THE PROJECT SITE.

R E V I S I O N S				<div><div><div></div></div><div>Q. Grady Minor and Associates, P.A. 3800 Via Del Rey Bonita Springs, Florida 34134 Phone: 239.947.1144 R. DANIEL FLYNN, P.E. NO. 76205</div><div>GradyMinor</div><div><div>Civil Engineers</div><div>Land Surveyors</div><div>Planners</div><div>Landscape Architects</div></div><div><div>Cert. of Auth. EB 0005151</div><div>Cert. of Auth. LB 0005151</div><div>Business LC 26000266</div></div></div>	LEE COUNTY		STORMWATER POLLUTION PREVENTION PLAN	SHEET NO.
DATE	DESCRIPTION	DATE	DESCRIPTION		ROAD NO.	COUNTY PROJECT NO.		137
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2.0. CONTROLS:

2.A. EROSION AND SEDIMENT

IN THE SEDIMENT AND EROSION CONTROL PLAN, THE CONTRACTOR SHALL DESCRIBE THE PROPOSED STABILIZATION AND STRUCTURAL PRACTICES BASED ON THE CONTRACTOR'S PROPOSED TEMPORARY TRAFFIC CONTROL (TTC) PLAN.

FOR EACH CONSTRUCTION PHASE, INSTALL PERIMETER CONTROLS AFTER CLEARING AND GRUBBING NECESSARY FOR INSTALLATION OF CONTROLS BUT BEFORE BEGINNING OTHER WORK FOR THE CONSTRUCTION PHASE. REMOVE PERIMETER CONTROLS ONLY AFTER ALL UPSTREAM AREAS ARE STABILIZED.

2.A.I STABILIZATION PRACTICES:

IN THE SEDIMENT AND EROSION CONTROL PLAN, THE CONTRACTOR SHALL DESCRIBE THE STABILIZATION PRACTICES PROPOSED TO CONTROL EROSION. THE CONTRACTOR SHALL INITIATE ALL STABILIZATION MEASURES AS SOON AS PRACTICAL, BUT IN NO CASE MORE THAN 7 DAYS AFTER CONSTRUCTION ACTIVITIES HAVE TEMPORARILY OR PERMANENTLY CEASED. THE STABILIZATION PRACTICES SHALL INCLUDE AT LEAST THE FOLLOWING, UNLESS OTHERWISE APPROVED BY THE ENGINEER.

TEMPORARY:

- \* ARTIFICIAL COVERINGS IN ACCORDANCE WITH SPECIFICATION SECTION 104.
- \* TURF AND SOD IN ACCORDANCE WITH SPECIFICATION SECTION 104.

PERMANENT:

- \* ASPHALT OR CONCRETE SURFACE.
- \* SOD IN ACCORDANCE WITH SPECIFICATION SECTION 570.

2.A.II STRUCTURAL PRACTICES:

IN THE SEDIMENT AND EROSION CONTROL PLAN, THE CONTRACTOR SHALL DESCRIBE THE PROPOSED STRUCTURAL PRACTICES TO CONTROL OR TRAP SEDIMENT AND OTHERWISE PREVENT THE DISCHARGE OF POLLUTANTS FROM EXPOSED AREAS OF THE SITE. SEDIMENT CONTROLS SHALL BE IN PLACE BEFORE DISTURBING SOIL UPSTREAM OF THE CONTROL. THE STRUCTURAL PRACTICES SHALL INCLUDE AT LEAST THE FOLLOWING, UNLESS OTHERWISE APPROVED BY THE ENGINEER:

TEMPORARY:

\*INLET PROTECTION IN ACCORDANCE WITH FDEP EROSION AND SEDIMENT CONTROL DESIGNER AND REVIEWER MANUAL, AND SPECIAL DETAILS SHOWN IN THE TTC PLAN.

PERMANENT:

- \* SOD

2.B. STORMWATER MANAGEMENT:

2.C. OTHER CONTROLS:

2.C.I WASTE DISPOSAL:

IN THE SEDIMENT AND EROSION CONTROL PLAN, THE CONTRACTOR SHALL DESCRIBE THE PROPOSED METHODS TO PREVENT THE DISCHARGE OF SOLID MATERIALS, INCLUDING BUILDING MATERIALS, TO WATERS OF THE UNITED STATES. THE PROPOSED METHODS SHALL INCLUDE AT LEAST THE FOLLOWING, UNLESS OTHERWISE APPROVED BY THE ENGINEER:

- \* PROVIDING LITTER CONTROL AND COLLECTION WITHIN THE PROJECT DURING CONSTRUCTION ACTIVITIES.
- \* DISPOSING OF ALL FERTILIZER OR OTHER CHEMICAL CONTAINERS ACCORDING TO EPA'S STANDARD PRACTICES AS DETAILED BY THE MANUFACTURER.
- \* DISPOSING OF SOLID MATERIALS INCLUDING BUILDING AND CONSTRUCTION MATERIALS OFF THE PROJECT SITE BUT NOT IN SURFACE WATERS, OR WETLANDS.

2.C.II OFF-SITE VEHICLE TRACKING & DUST CONTROL:

IN THE SEDIMENT AND EROSION CONTROL PLAN, THE CONTRACTOR SHALL DESCRIBE THE PROPOSED METHODS FOR MINIMIZING OFFSITE VEHICLE TRACKING OF SEDIMENTS AND GENERATING DUST. THE PROPOSED METHODS SHALL INCLUDE AT LEAST THE FOLLOWING, UNLESS OTHERWISE APPROVED BY THE ENGINEER:

- \* COVERING LOADED HAUL TRUCKS WITH TARPULINS.
- \* REMOVING EXCESS DIRT FROM ROADS DAILY.
- \* STABILIZING CONSTRUCTION ENTRANCES ACCORDING TO THE FDEP EROSION AND SEDIMENT CONTROL DESIGNER AND REVIEWER MANUAL.
- \* USING ROADWAY SWEEPERS DURING DUST GENERATING ACTIVITIES SUCH AS EXCAVATION AND MILLING OPERATIONS.

2.C.III STATE AND LOCAL REGULATIONS FOR WASTE DISPOSAL, SANITARY SEWER, OR SEPTIC TANK REGULATIONS.

IN THE SPECIFICATION SECTION 104, EROSION CONTROL PLAN, THE CONTRACTOR SHALL DESCRIBE THE PROPOSED PROCEDURES TO COMPLY WITH APPLICABLE STATE AND LOCAL REGULATIONS FOR WASTE DISPOSAL, AND SANITARY SEWER OR SEPTIC SYSTEMS.

2.C.IV FERTILIZERS AND PESTICIDES:

IN THE SEDIMENT AND EROSION CONTROL PLAN, THE CONTRACTOR SHALL DESCRIBE THE PROCEDURES FOR APPLYING FERTILIZERS AND PESTICIDES. THE PROPOSED PROCEDURES SHALL COMPLY WITH APPLICABLE SUBSECTIONS OF SECTION 982 OF THE SPECIFICATIONS.

2.C.V TOXIC SUBSTANCES:

IN THE SEDIMENT AND EROSION CONTROL PLAN, THE CONTRACTOR SHALL

PROVIDE A LIST OF TOXIC SUBSTANCES THAT ARE LIKELY TO BE USED ON THE JOB AND PROVIDE A PLAN ADDRESSING THE GENERATION, APPLICATION, MIGRATION, STORAGE, AND DISPOSAL OF THESE SUBSTANCES.

2.D. APPROVED STATE AND LOCAL PLANS AND PERMITS:

SFWMD - EXEMPTION NO. 36-108620  
FDEP - AUTHORIZATION NO. 428834-001 SFG, LEE COUNTY  
FDOT GENERAL USE PERMIT - 2024-K-192-00015

3.0 MAINTENANCE:

IN THE SEDIMENT AND EROSION CONTROL PLAN, THE CONTRACTOR SHALL PROVIDE A PLAN FOR MAINTAINING ALL EROSION AND SEDIMENT CONTROLS THROUGHOUT CONSTRUCTION. THE MAINTENANCE PLAN SHALL AT MINIMUM, COMPLY WITH THE FOLLOWING:

- \* SILT FENCE: MAINTAIN PER SPECIFICATION SECTION 104. THE CONTRACTOR SHOULD ANTICIPATE REPLACING SILT FENCE ON 12 MONTH INTERVALS.
- \* SEDIMENT BARRIERS: REMOVE SEDIMENT AS PER MANUFACTURER'S RECOMMENDATIONS OR WHEN WATER PONDS IN UNACCEPTABLE AMOUNTS OR AREAS.

4.0 INSPECTIONS:

QUALIFIED PERSONNEL SHALL INSPECT THE FOLLOWING ITEMS AT LEAST ONCE EVERY SEVEN CALENDAR DAYS AND WITHIN 24 HOURS OF THE END OF A STORM THAT IS 0.50 INCHES OR GREATER. TO COMPLY, THE CONTRACTOR SHALL INSTALL AND MAINTAIN RAIN GAUGES AND RECORD THE DAILY RAINFALL. WHERE SITES HAVE BEEN PERMANENTLY STABILIZED, INSPECTIONS SHALL BE CONDUCTED AT LEAST ONCE EVERY MONTH. THE CONTRACTOR SHALL ALSO INSPECT THAT CONTROLS INSTALLED IN THE FIELD AGREE WITH THE LATEST STORMWATER POLLUTION PREVENTION PLAN.

- \* POINTS OF DISCHARGE TO THE CAPE CORAL CANAL SYSTEM
- \* DISTURBED AREAS OF THE SITE THAT HAVE NOT BEEN FINALLY STABILIZED.
- \* AREAS USED FOR STORAGE OF MATERIALS THAT ARE EXPOSED TO PRECIPITATION.
- \* LOCATIONS WHERE VEHICLES ENTER OR EXIT THE SITE.

THE CONTRACTOR SHALL INITIATE REPAIRS WITHIN 24 HOURS OF INSPECTIONS THAT INDICATE ITEMS ARE NOT IN GOOD WORKING ORDER.

IF INSPECTIONS INDICATE THAT THE INSTALLED STABILIZATION AND STRUCTURAL PRACTICES ARE NOT SUFFICIENT TO MINIMIZE EROSION, RETAIN SEDIMENT, AND PREVENT DISCHARGING POLLUTANTS, THE CONTRACTOR SHALL PROVIDE ADDITIONAL MEASURES, AS APPROVED BY THE ENGINEER.

5.0 NON-STORMWATER DISCHARGES:

IN THE SPECIFICATION SECTION 104 EROSION CONTROL PLAN, THE CONTRACTOR SHALL IDENTIFY ALL ANTICIPATED NON-STORMWATER DISCHARGES (EXCEPT FLOWS FROM FIRE FIGHTING ACTIVITIES). THE CONTRACTOR SHALL DESCRIBE THE PROPOSED MEASURES TO PREVENT POLLUTION OF THESE NON-STORMWATER DISCHARGES. IF THE CONTRACTOR ENCOUNTERS CONTAMINATED SOIL OR GROUNDWATER, CONTACT DAVE LETTERMAN, DISTRICT HAZARDOUS MATERIALS COORDINATOR AT (305) 63B-R549.

REVISIONS				<div><div>Q. Grady Minor and Associates, P.A. 3800 Via Del Rey Bonita Springs, Florida 34134 Phone: 239.947.1144 R. DANIEL FLYNN, P.E. NO. 76205</div></div> <div><div>Civil Engineers</div><div>• Land Surveyors • Planners • Landscape Architects</div><div><small>CERT. OF AUTH. EB 0005151    CERT. OF AUTH. LB 0005151    BUSINESS LIC 26000266</small></div></div>	<div>LEE COUNTY</div> <table><tr><td>ROAD NO.</td><td>COUNTY PROJECT NO.</td></tr><tr><td>BELL BLVD. SR 82 TO SUNRISE BLVD. SIDEWALK</td><td>6002</td></tr></table>		ROAD NO.	COUNTY PROJECT NO.	BELL BLVD. SR 82 TO SUNRISE BLVD. SIDEWALK	6002	STORMWATER POLLUTION PREVENTION PLAN	SHEET NO.
ROAD NO.	COUNTY PROJECT NO.											
BELL BLVD. SR 82 TO SUNRISE BLVD. SIDEWALK	6002											
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TRAFFIC CONTROL PLAN GENERAL NOTES

1. TRAFFIC SHALL BE MAINTAINED IN ACCORDANCE WITH FDOT STANDARD PLANS, INDEX 102-600 SERIES.

A. INDEX 102-603 SHALL BE USED DURING CONSTRUCTION ACTIVITIES CLOSER THAN 2' FROM THE TRAVELED WAY.

B. INDEX 102-602 SHALL BE USED DURING SHOULDER GRADING & CONSTRUCTION ACTIVITIES BETWEEN 2' AND 15' FROM THE TRAVELED WAY.

C. INDEX 102-601 SHALL BE USED FOR CONSTRUCTION ACTIVITIES 15' OR MORE FROM THE TRAVELED WAY.
2. CONSTRUCTION OPERATIONS SHALL COMPLY WITH ALL LOCAL CITY, COUNTY AND STATE NOISE ORDINANCES.
3. THREE (3) PORTABLE CHANGEABLE (VARIABLE) MESSAGE SIGNS (PCMS) WILL BE REQUIRED FOR THIS PROJECT.

A. TWO (2) PORTABLE CHANGEABLE (VARIABLE) MESSAGE SIGNS (PCMS) FOR BOTH EASTBOUND AND WESTBOUND SR 82 SHALL BE PLACED 500 FT IN ADVANCE OF THE FIRST WORK ZONE SIGN AND DISPLAY THE FOLLOWING SEQUENCE:

TO BE USED 14 DAYS PRIOR TO BEGINNING OF CONSTRUCTION:

1. BELL

2. CONST.

3. "DATE"

B. ONE (1) PORTABLE CHANGEABLE (VARIABLE) MESSAGE SIGNS (PCMS) FOR SOUTHBOUND BELL BLVD SHALL BE PLACED 500 FT IN ADVANCE OF THE FIRST WORK ZONE SIGN AND DISPLAY THE FOLLOWING SEQUENCE:

TO BE USED 14 DAYS PRIOR TO BEGINNING OF CONSTRUCTION:

1. BELL


2. CONST.

3. "DATE"
4. ALL LANES MUST BE OPEN FOR TRAFFIC DURING AN EVACUATION NOTICE OF A HURRICANE OR OTHER CATASTROPHIC EVENT AND SHALL REMAIN OPEN FOR THE DURATION OF THE EVACUATION OR EVENT AS DIRECTED BY THE PROJECT ENGINEER..
5. THE ROADWAY MUST BE OPEN TO TWO-WAY TRAFFIC AT THE END OF EACH CONSTRUCTION DAY. TEMPORARY STRIPING SHALL BE USED AT THE END OF EACH CONSTRUCTION DAY AND SHALL BE INCLUDED IN THE PAY ITEM 102-1 MAINTENANCE OF TRAFFIC (LS).
6. FDOT STANDARD PLANS INDEX 102-600 WORK ZONE SIGNS SHALL BE ADJUSTED TO THE PROPOSED WORK ZONE PRIOR TO THE START OF WORK FOR EACH DAY DURING THE DURATION OF THE PROJECT.
7. ACCESS SHALL BE CONTINUOUSLY MAINTAINED AT ALL SIDE STREETS AND DRIVEWAYS FOR THE DURATION OF THE PROJECT, UNLESS PREVIOUSLY APPROVED BY THE COUNTY.
8. REGULATORY SPEED ALONG BELL BLVD. IS 45 MPH.
9. THE COST OF MAINTENANCE OF TRAFFIC OPERATIONS, INCLUDING ALL PCMS BOARDS, SHALL BE INCLUDED UNDER THE LUMP SUM PAY ITEM FOR MAINTENANCE OF TRAFFIC.
10. THE CONTRACTOR SHALL NOTIFY LEE COUNTY PUBLIC WORKS A MINIMUM OF 7 DAYS PRIOR TO A LANE CLOSURE THAT WILL EXCEED TWO HOURS.
11. THE SEQUENCE OF CONSTRUCTION AND METHODS DESCRIBED IN THIS PLAN SET IS A SUGGESTED MAINTENANCE OF TRAFFIC SCHEME. A MOT PLAN IS NOT INCLUDED IN THE PLANS AND SHALL NOT BE PROVIDED BY THE ENGINEER. THE CONTRACTOR SHALL SUBMIT A MOT PLAN FOR REVIEW/APPROVAL PRIOR TO THE COMMENCEMENT OF CONSTRUCTION. SEE EXHIBIT I - SUPPLEMENTAL SPECIFICATIONS FOR TCP SUBMITTAL REQUIREMENTS.



12. NO LANE CLOSURES ALLOWED BETWEEN 6:00 A.M. TO 9:00 A.M. AND FROM 4:00 P.M. TO 7:00 P.M., UNLESS OTHERWISE DIRECTED BY THE COUNTY ENGINEER. DURING PEAK SEASON (THANKSGIVING - EASTER), DAYTIME LANE CLOSURES WILL NOT BE PERMITTED ON ARTERIAL AND COLLECTOR ROADWAYS. DURING THIS TIME PERIOD, ALL LANE CLOSURES WILL BE ALLOWED TO COMMENCE AFTER 7:00 P.M. AND ALL LANES RE-OPENED AT 6:00 A.M. LANE CLOSURES MAY BE DONE ON WEEKENDS OR DURING DAYTIME HOURS WITH PRIOR APPROVAL OF THE LEE COUNTY DIRECTOR OF TRANSPORTATION OR DESIGNEE.
13. TRAFFIC CONDITIONS, ACCIDENTS AND OTHER UNFORESEEN EMERGENCY CONDITIONS MAY REQUIRE THE ENGINEER TO RESTRICT OR REMOVE LANE CLOSURE OR CHANNELIZATION. UNDER THESE CONDITIONS, THE CONTRACTOR SHALL RESPOND AND PROVIDE ADJUSTMENTS AS DIRECTED BY THE ENGINEER WITHOUT DELAY. THE CONTRACTOR SHALL ALSO RESPOND WITHIN THE CONSTRAINTS OUTLINED IN THE STANDARD SPECIFICATIONS UPON NOTIFICATION BY THE ENGINEER OF ANY REQUESTS FOR CORRECTION, IMPROVEMENT, OR MODIFICATION TO THE TRAFFIC CONTROL PLAN AND/OR DEVICES. THE COST OF THIS SERVICE AND THE MAINTENANCE OF THE TEMPORARY PAVEMENT SHALL BE INCLUDED IN THE LUMP SUM PRICE FOR MAINTENANCE OF TRAFFIC.
14. FDOT RIGHT OF WAY: LANE CLOSURE RESTRICTIONS APPLY, NO LANE CLOSURES BETWEEN 6:00 A.M. TO 7:00 P.M.

PHASING NOTES

- CONSTRUCT DRAINAGE CULVERTS & DRAINAGE STRUCTURES
- EARTHWORK
- PLACE CONCRETE (DRIVEWAYS & SIDEWALK)
- MILLING & RESURFACING
- FINAL STRIPING AND SIGNAGE

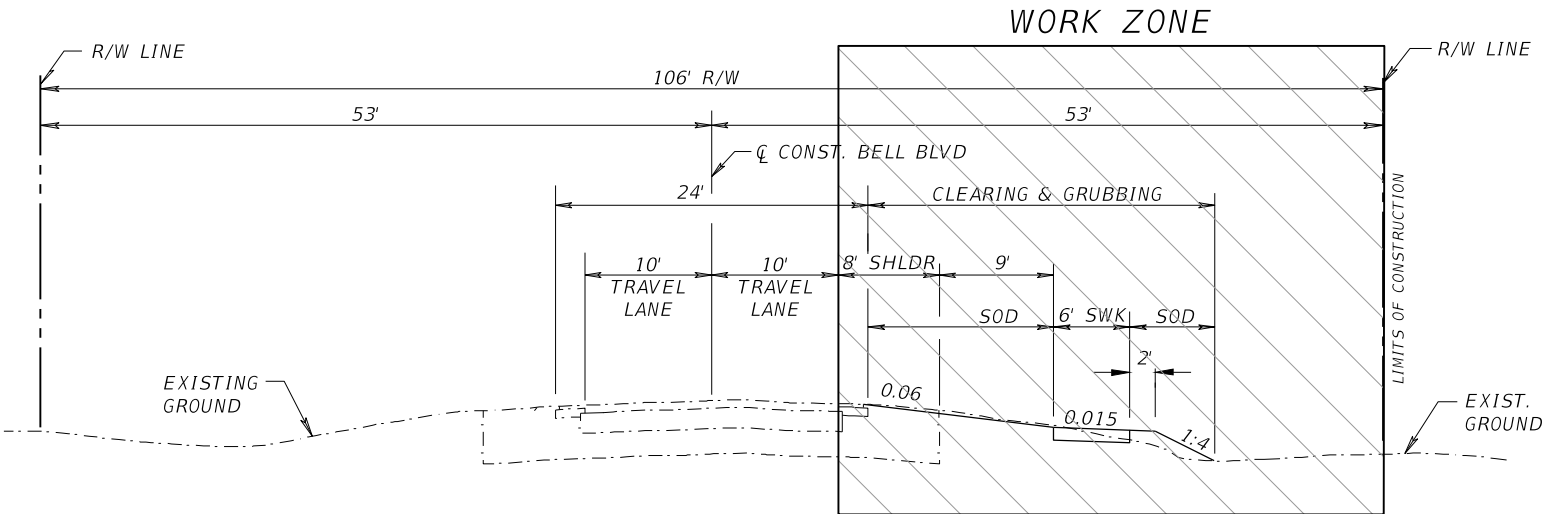

REVISIONS				<div><div><div><div></div><div>GradyMinor</div><div><div>Civil Engineers</div><div>• Land Surveyors • Planners • Landscape Architects</div><div><small>CERT. OF AUTH. EB 0005151</small><div>CERT. OF AUTH. LB 0005151</div><div><small>BUSINESS LIC. 26000266</small></div></div></div></div><div><div>Q. Grady Minor and Associates, P.A.</div><div>3800 Via Del Rey</div><div>Bonita Springs, Florida 34134</div><div>Phone: 239.947.1144</div><div>R. DANIEL FLYNN, P.E. NO. 76205</div></div></div></div>	LEE COUNTY		TEMPORARY TRAFFIC CONTROL	SHEET NO.
DATE	DESCRIPTION	DATE	DESCRIPTION		ROAD NO.	COUNTY PROJECT NO.		139
					BELL BLVD. SR 82 TO SUNRISE BLVD. SIDEWALK	6002		

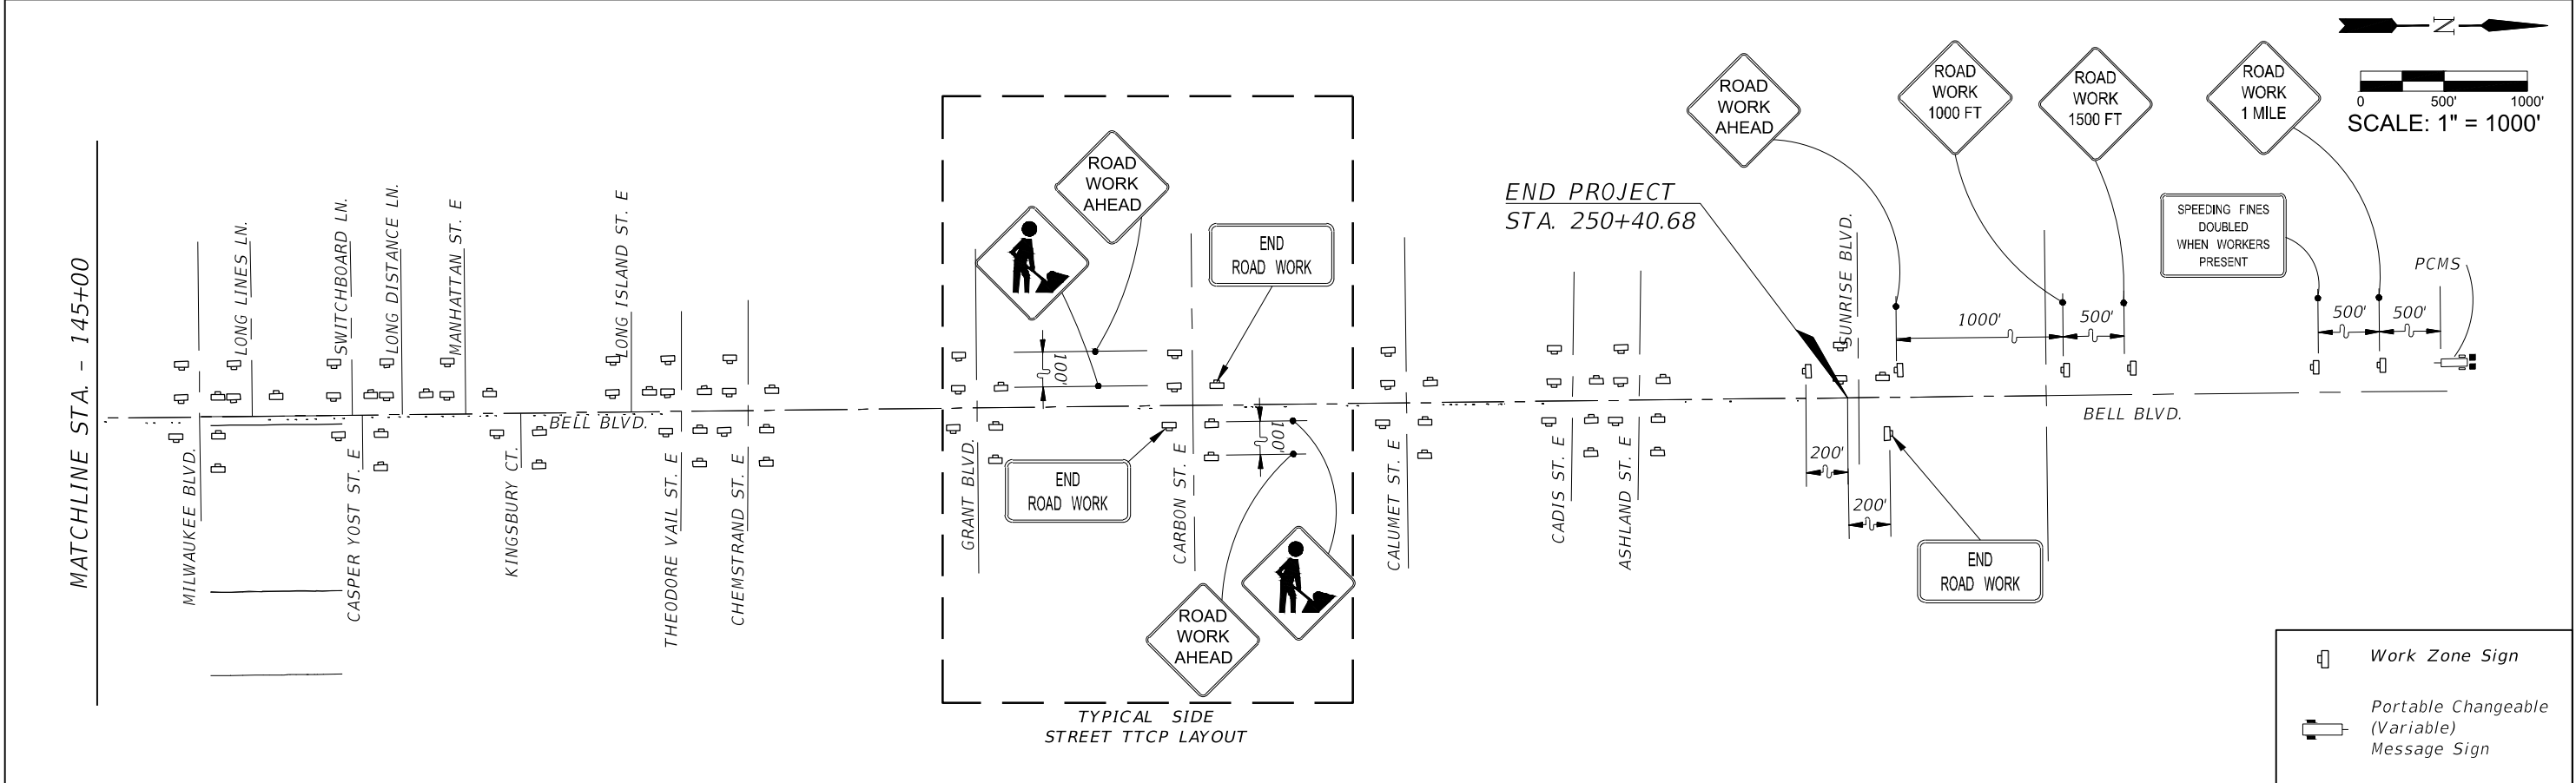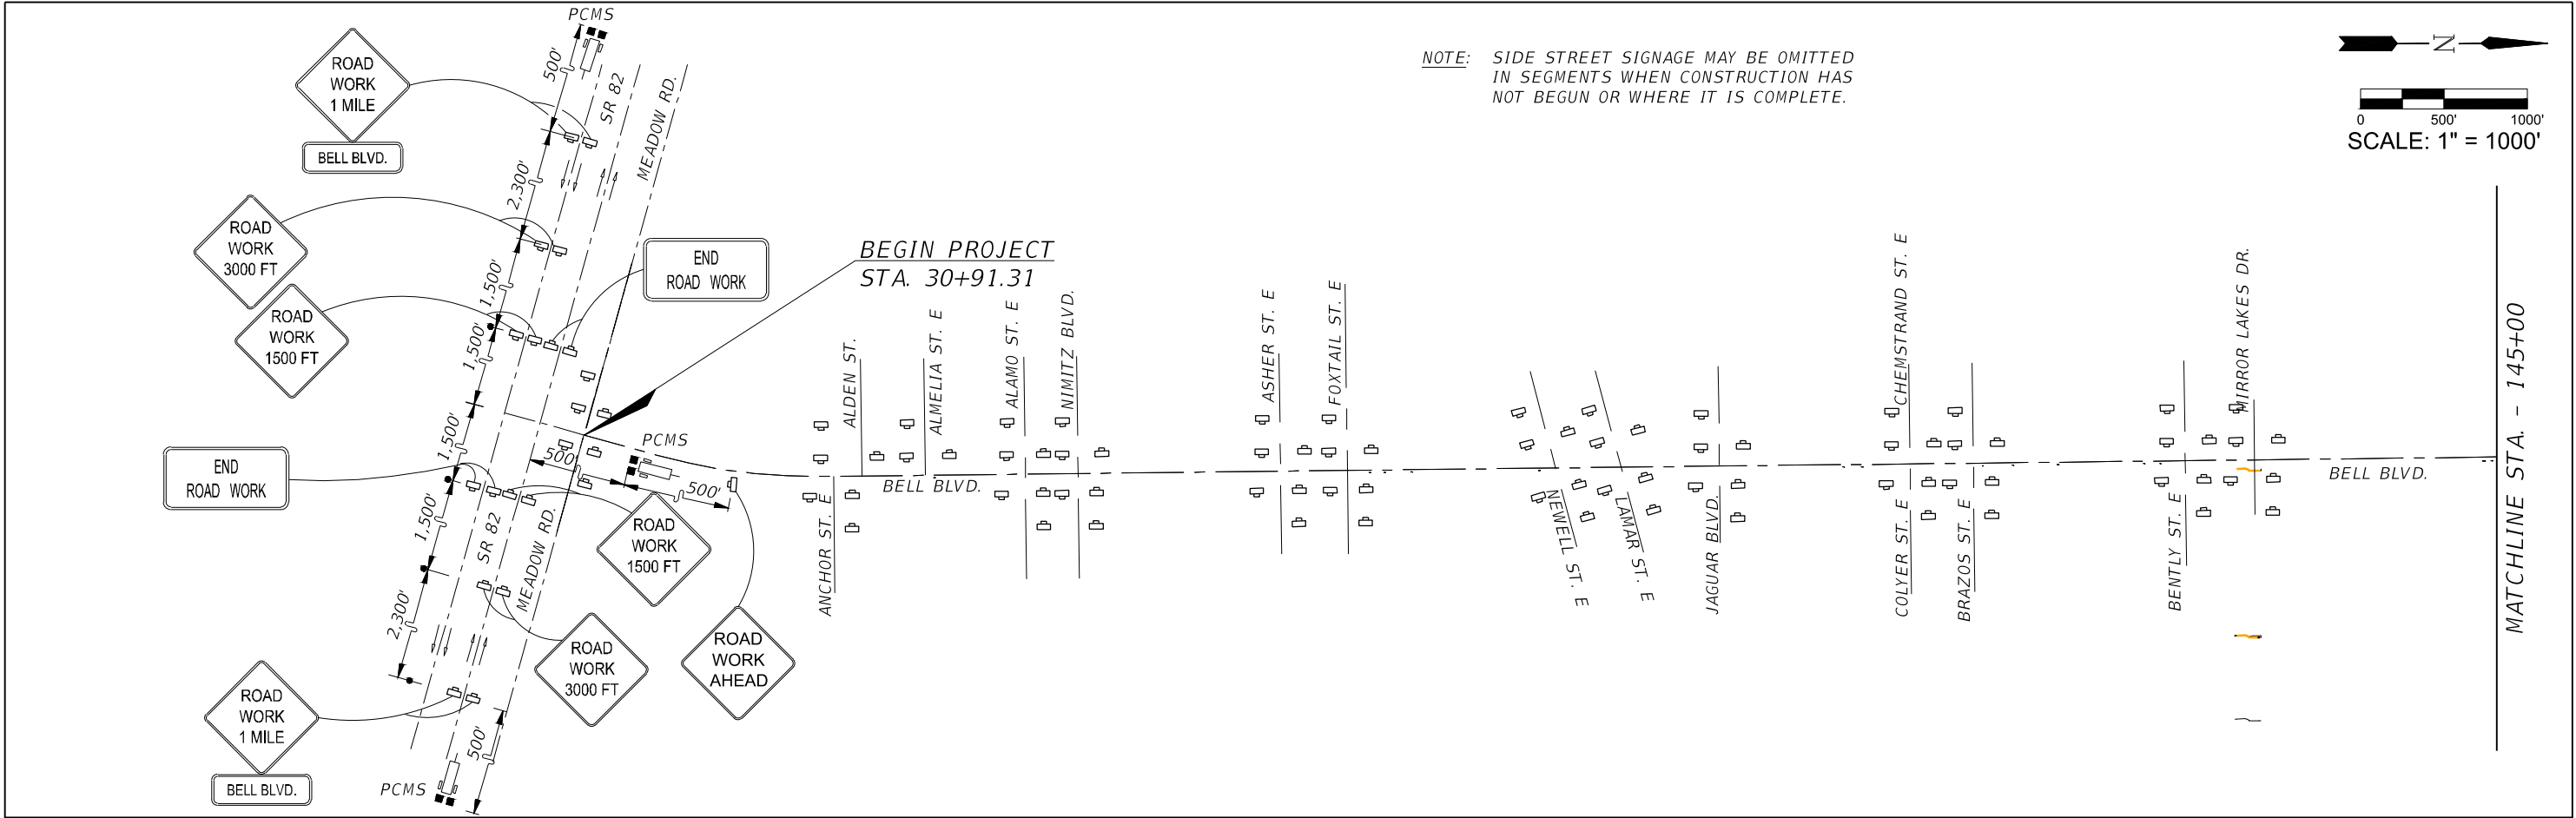

REVISIONS				 <div>Q. Grady Minor and Associates, P.A. 3800 Via Del Rey Bonita Springs, Florida 34134 Phone: 239.947.1144 R. DANIEL FLYNN, P.E. NO. 76205</div>	LEE COUNTY		TEMPORARY TRAFFIC CONTROL ADVANCED WARNING SIGNING	SHEET NO.  140
DATE	DESCRIPTION	DATE	DESCRIPTION		ROAD NO.	COUNTY PROJECT NO.		
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