

RSW TRANSMISSION LINE
- BEN HILL/TREELINE

FOR

# LEE COUNTY UTILITIES

LOCATED IN

SECTIONS 25 & 35, TOWNSHIP 45 SOUTH, RANGE 24 EAST


# LEE COUNTY, FLORIDA

JANUARY 27, 2021

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## LOCATION MAP

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LEE COUNTY BOARD OF COUNTY COMMISSIONERS:

DISTRICT 1: JOHN E. MANNING

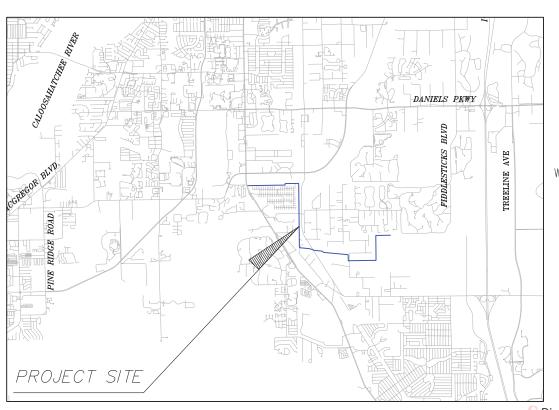DISTRICT 2: CECIL L. PENDERGRASS

DISTRICT 3: RAY SANDELLI

DISTRICT 4: BRIAN HAMMAN

DISTRICT 5: FRANK MANN

For Information Regarding This Project, Contact: DAVID BRICE TROUTEAUD, PE



DAVID BRICE TROUTEAUD, PE FL License No. 69783

Digitally signed by David Brice Trouteaud, P.E. 69783 STATE OF FLORIDA Date: 2021.01.28 14:03:53 -05'00'

100% Construction Plans

THIS IS TO CERTIFY THAT THESE PLANS AND ASSOCIATED CONSTRUCTION PROJECTS ARE IN SUBSTANTIAL COMPLIANCE WITH THE LEE COUNTY LAND DEVELOPMENT CODE:

DESIGN ENGINEER

PAM KEYES, P.E.

DEVELOPMENT ORDER APPROVED: PUBLIC WORKS ADMINISTRATION

# **DESIGN CONSULTANT**



ALLAHASSEE

LOCATION OF PROJECT

2122 JOHNSON STREET P.O. BOX 1550 FORT MYERS, FLORIDA 33902-1550 PHONE (239) 334-0046 FAX (239) 334-3661 E.B. #642 & L.B. #642 ENGINEERING
2122 JOHNSON STREET
P.O. BOX 1550
FORT MYERS, FLORIDA 33902-1550
PHONE (239) 334-3046
FAX (239) 334-3661
E.B. #642 & L.B. #642

LEE COUNTY

SSW TRANSMISSION LIN - BEN HILL/TREELINE Lee County, Florida



DATE: JANUARY 27, 2021
PROJECT NO. 20192277-000
FILE NO. 25-45-24

AS SHOWN

100% Construction Plans Cover

SHEET NUMBER

01

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## LEE COUNTY UTILITIES STANDARD PLAN NOTES

- ALL WORK SHALL CONFORM TO LATEST REVISION OF THE LCU DESIGN MANUAL WHICH IS AVAILABLE ON OUR WEB-PAGE VIA THE FOLLOWING LINK: HTTPS://WWW.LEEGOV.COM/UTILITIES/DESIGN-MANUAL
- ALL REGULATORY AND PERMITTING AGENCIES' REQUIREMENTS SHALL BE COMPLIED WITH AS WELL.
- ANY QUANTITIES SHOWN ON PLANS ARE NOT VERIFIED BY LCU.
- THE INFORMATION PROVIDED IN THESE PLANS IS SOLELY TO ASSIST THE CONTRACTOR IN ASSESSING THE NATURE AND EXTENT OF CONDITIONS THAT MAY BE ENCOUNTERED DURING THE COURSE OF WORK. ALL CONTRACTORS ARE DIRECTED, PRIOR TO BIDDING, TO CONDUCT WHATEVER INVESTIGATIONS THEY MAY DEEM NECESSARY TO ARRIVE AT THEIR OWN CONCLUSION REGARDING THE ACTUAL CONDITIONS THAT WILL BE ENCOUNTERED, AND UPON WHICH THEIR BIDS WILL BE BASED.
- ALL CONSTRUCTION WORK PERFORMED MUST BE DONE BY A CONTRACTOR LICENSED IN THE STATE OF FLORIDA TO DO THE WORK
- A PRE-CONSTRUCTION MEETING IS REQUIRED BEFORE WORK MAY BEGIN. REQUIRED ATTENDEES INCLUDE BUT ARE NOT LIMITED TO; THE ENGINEER OF RECORD OR HIS DESIGNEE, THE UNDERGROUND CONTRACTOR, THE LCU PROJECT MANAGER, AND THE LCU INSPECTOR ASSIGNED TO THE PROJECT, LCU IS TO BE NOTIFIED TWO (2) WORKING DAYS PRIOR TO THE PRE-CONSTRUCTION MEETING.
- ONE COPY OF THE LCU APPROVED/STAMPED CONSTRUCTION PLANS, ALL CONTRACT DOCUMENTS, REFERENCE DOCUMENTS AND TECHNICAL DOCUMENTS SUBMITTED MUST BE KEPT AT THE SITE AND MAINTAINED IN GOOD ORDER.
- ALL WORK AND MATERIALS, WHICH DO NOT CONFORM TO LCU SPECIFICATIONS, ARE SUBJECT TO REMOVAL AND REPLACEMENT AT THE CONTRACTOR'S EXPENSE
- ANY WORK PERFORMED WITHOUT THE KNOWLEDGE OF LCU IS SUBJECT TO RE-EXCAVATION, REMOVAL AND REPLACEMENT OF SAME TO BE DONE AT THE CONTRACTOR'S EXPENSE
- 10. LCU INSPECTION STAFF IS TO BE PRESENT FOR ALL HOT TAPS, PRESSURE TESTS, LIFT STATION START-UPS AND FOR ANY NECESSARY INSPECTION. THE CONTRACTOR IS TO PROVIDE A MINIMUM OF TWO (2) WORKING DAYS NOTICE PRIOR TO SCHEDULING ANY OF THE ABOVE WITH THE EXCEPTION OF THE LIFT STATION START-UP WHICH REQUIRES ONE-WEEK NOTICE.
- 11. TRAFFIC MUST BE MAINTAINED AT ALL TIMES AS PER LEE COUNTY DEPARTMENT OF TRANSPORTATION (LCDOT) AND PER FLORIDA DEPARTMENT OF TRANSPORTATION (FDOT) STANDARD SPECIFICATIONS FOR ROAD AND BRIDGE CONSTRUCTION, LATEST
- 12. THE CONTRACTOR IS TO UNCOVER ALL EXISTING LINES BEING TIED INTO AND VERIFY GRADES BEFORE BEGINNING CONSTRUCTION.
- 13. LOCATIONS, ELEVATIONS, AND DIMENSIONS OF EXISTING UTILITIES, STRUCTURES AND OTHER FEATURES ARE SHOWN ACCORDING TO THE BEST INFORMATION AVAILABLE AT THE TIME OF PREPARATION OF THESE PLANS, BUT DO NOT PURPORT TO BE ABSOLUTELY CORRECT. LCU WILL NOT GUARANTEE ANY LOCATIONS AS SHOWN ON THESE PLANS OR THOSE OMITTED FROM THESE PLANS.
- 14. THE CONTRACTOR SHALL VERIFY ALL UTILITIES AND PROVIDE AT LEAST TWO (2) WORKING DAYS NOTICE TO THE INDIVIDUAL UTILITY COMPANIES, FDOT AND LCDOT PRIOR TO CONSTRUCTION
- 15. IT IS THE CONTRACTOR'S RESPONSIBILITY TO LOCATE AND TAKE ALL POSSIBLE PRECAUTIONS TO AVOID ANY DAMAGE TO ALL UNDERGROUND PIPELINES, TELEPHONE, CABLE TV, ELECTRIC LINES/CONDUITS AND STRUCTURES IN ADVANCE OF ANY CONSTRUCTION. THE CONTRACTOR SHALL BE FULLY RESPONSIBLE FOR ANY AND ALL DAMAGES THAT MAY OCCUR DUE TO HIS FAILURE TO EXACTLY LOCATE AND PROTECT EXISTING UTILITIES AND STRUCTURES
- 16. ANYTHING NOT SHOWN ON THESE DRAWINGS SHOULD BE BROUGHT TO THE ATTENTION OF THE ENGINEER AND SHALL NOT CONSTITUTE AN EXTRA, UNLESS APPROVED BY THE ENGINEER OF RECORD.
- 17. THE CONTRACTOR SHALL CONTACT THE ENGINEER AND LCU IMMEDIATELY CONCERNING ANY CONFLICTS WITH LCU UTILITIES/STRUCTURES ARISING DURING CONSTRUCTION OF ANY FACILITIES SHOWN ON THESE DRAWINGS.

- 18. THE CONTRACTOR SHALL VERIFY ALL QUANTITIES SHOWN ON THE PLANS. IF ANY DISCREPANCIES IN QUANTITIES ARE FOUND, THE CONTRACTOR SHALL NOTIFY THE ENGINEER OF RECORD AND LCU.
- 19. THE CONTRACTOR SHALL REPLACE ALL PAVEMENT, CURBS, DRIVEWAYS, SIDEWALKS, FENCES, ETC., WITH THE SAME TYPE OF MATERIAL THAT WAS REMOVED DURING CONSTRUCTION OR AS DIRECTED BY THE ENGINEER. THE CONTRACTOR SHALL RESTORE ALL AREAS AFFECTED BY THE CONSTRUCTION TO ITS ORIGINAL CONDITION, OR BETTER.
- 20. WITHIN THE FDOT AND LCDOT RIGHT-OF-WAY, ALL DISTURBED AREAS SHALL RECEIVE GRASSING (SEEDING) OR SODDING MATERIALS IN ACCORDANCE WITH FDOT SPECIFICATIONS. THOSE AREAS THAT ARE CLASSIFIED AS DRAINAGE DITCHES SHALL RECEIVE FULL SOLID SOD
- 21. ALL FRAMES, COVERS VALVE BOXES, METER BOXES AND MANHOLES SHALL BE ADJUSTED TO FINISHED GRADE UPON COMPLETION OF PAVING OR RELATED CONSTRUCTION. ALL VALVE PADS SHALL BE POURED IN PLACE, NO PRE-FORMED VALVE PADS WILL BE ALLOWED.
- 22. APPROPRIATE TURBIDITY CONTROL DEVICES (E.G. SILT FENCES, HAY BALES) WILL BE UTILIZED DURING ALL PHASES OF INSTALLATION AND GRADING. CONTRACTOR IS RESPONSIBLE FOR SUBMITTING THE NOTICE OF INTENT AND NOTICE OF TERMINATION TO THE EPA IN COMPLIANCE WITH LEE COUNTY'S NPDES PERMIT.
- 23. CONTRACTOR IS RESPONSIBLE FOR DEVELOPING AND MAINTAINING AN EFFECTIVE STORM WATER POLLUTION PREVENTION PLAN.
- 24. LCU REQUIRES 30" OF COVER FOR ALL UNDERGROUND PIPING EXCEPT UNDER PAVEMENT, WHERE 36" OF COVER IS REQUIRED. IF LCU REQUIRED COVER CANNOT BE MAINTAINED, THE CONTRACTOR SHALL PROVIDE OTHER METHODS OF CONSTRUCTION OR PIPE PROTECTION, WHICH SHALL FIRST BE APPROVED BY LCU AND THE ENGINEER, AT NO ADDITIONAL COST TO THE COUNTY, IF STATE AGENCIES REQUIRE ADDITIONAL COVER, MEETING THE REQUIREMENTS SHALL BE DONE AT NO ADDITIONAL COST TO THE **COUNTY**
- 25. LCU REQUIRES THERE TO BE A MINIMUM OF TEN (10) FEET HORIZONTAL AND 18" VERTICAL SEPARATION BETWEEN POTABLE WATER & SANITARY SEWER MAINS. LCU ALSO REQUIRES MINIMUM OF TEN (10) FEET HORIZONTAL SEPARATION BETWEEN OTHER PUBLIC AND/OR PRIVATE UTILITIES, STRUCTURE(S), BUILDING(S), WALL(S), FOUNTAIN(S), FENCE(S) AND LCU INFRASTRUCTURE UNLESS SPECIFICALLY APPROVED BY LCU.
- 26. LCU REQUIRES THERE TO BE A MINIMUM OF FIVE (5) FEET HORIZONTAL SEPARATION BETWEEN LCU INFRASTRUCTURE AND DRAINAGE INFRASTRUCTURE, MITERED END SECTIONS, INLETS, ETC. LCU ALSO REQUIRES MINIMUM OF FIVE (5) FEET HORIZONTAL SEPARATION BETWEEN LCU INFRASTRUCTURE AND ALL NEW LIGHT
- 27. THE ROOT BALL OF PALM TREES SHALL BE A MINIMUM OF FIVE (5) FEET AND THE ROOT BALL OF SHADE TREES SHALL BE A MINIMUM OF TEN (10) FEET FROM ANY EXISTING OR PROPOSED LCU OWNED AND MAINTAINED PIPE/INFRASTRUCTURE.
- 28. AS THE WORK PROGRESSES THE CONTRACTOR SHALL RECORD ALL CHANGES AND DEVIATIONS FROM THE LCU STAMPED/APPROVED CONSTRUCTION PLANS. IN ADDITION, HE SHALL RECORD THE EXACT LOCATION OF ALL CHANGES IN VERTICAL AND HORIZONTAL ALIGNMENT WITH COORDINATES WITH RESPECT TO THE NAVD 1988 STATE PLANE FLORIDA WEST COORDINATE SYSTEM AS WELL AS ALL REQUIREMENTS SET FORTH IN THE LCU DESIGN MANUAL. THIS INFORMATION IS TO BE FORWARDED TO THE ENGINEER OF RECORD WHO PREPARED, SIGNED AND SEALED THE APPROVED CONSTRUCTION PLANS SO THAT HE CAN PREPARE 'RECORD DRAWINGS' PER THE REQUIREMENTS SET FORTH IN THE LCU DESIGN MANUAL.

### DATUM NOTES:

- ALL ELEVATIONS ARE BASED ON NORTH AMERICAN VERTICAL DATUM OF 1988 (NAVD88).
- HORIZONTAL DATA IS BASED ON STATE PLANE COORDINATES FOR THE WEST ZONE OF FLORIDA.

### FIELD SURVEY NOTE

- TOPOGRAPHIC FIELD DATA WAS COLLECTED JANUARY 15th TO FEBRUARY 12th, 2020.
- TOPOGRAPHIC FIELD DATA AND S.U.E. DATA WAS COLLECTED OCTOBER 27th, 2008 TO APRIL 13th, 2009.

## **GEO-TECH NOTE**

**ABBREVIATIONS** 

ACCESS EASEMENT

AIR RELEASE VALVE

CORRUGATED METAL PIPE

ELLIPTICAL REINFORCED CONCRETE PIPE

DRAINAGE EASEMENT DUCTILE IRON PIPE

FLARED END SECTION

HIGH DENSITY POLY ETHYLENE

IRRIGATION CONTROL VALVE

MITERED END SECTION

MECHANICAL JOINT

NOT INCLUDED

PUMP STATION

RIGHT-OF-WAY

REUSE MAIN

STORM DRAIN

SPECIFICATION

SANITARY SEWER

SANITARY

STREET

STATION

TYPICAL

STANDARD

**TELEPHONE** 

STORM SEWER

UTILITY EASEMENT

CONC. VALVE VAULT

POLYVINYL CHLORIDE

REINFORCED CONCRETE PIPE

PLUG VALVE

ON CENTER
PAVEMENT

PARKWAY

ROAD

REQUIRED

FIRE HYDRANT

FLANGED

INVERT

IRRIGATION

MANHOLE

FORCE MAIN

FIBER OPTIC

GATE VALVE

EDGE OF PAVEMENT

CABLE TELEVISION

CATCH BASIN

CLEANOUT

ABANDONED

ALTERNATE

ASPHALT

BUILDING

ARV

ASPH

CATV

СВ

CO DE DIP

EOP

FE FH FLG FM

FO

ICV

INV IRR MH

ΜJ

NIC OC PAVT

PKWY

PS

PVC RCP

RD

REQ

R/W RU

SAN

SD

SPEC SS ST STA

STD

TEL TYP

UE WM

SUBSURFACE SOIL EXPLORATION WAS CONDUCTED IN MARCH 2009 AND DECEMBER 2020, SEE SHEETS 60 & 61 FOR REPORT

NOTICE TO ALL CONTRACTORS

IT'S THE LAW IN FLORIDA BUSINESS DAYS BEFORE YOU DIG CALL SUNSHINE 1-800-432-4770

STATE, COUNTIES & CITIES ARE "NOT" PART OF THE ONE CALL SYSTEM.
THEY MUST BE CALLED INDIVIDUALLY

STATE OF FLORIDA DOT ALL INTERSTATE RIGHT-OF-WAY HIGHMAST LIGHTING 7-DAY NOTICE REQUIRED 239-656-7811 239-656-7742 FAX



P.O. BOX 1550 PRT MYERS, FLORIDA 33902-1550 PHONE (239) 334-0046 FAX (239) 334-3661 E.B. #642 & L.B. #642



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LEGEND

FX XX" FM = EXISTING FORCE MAIN & PIPE SIZE = PROPOSED FORCE MAIN & PIPE SIZE XX" FM FX XX" WM = EXISTING POTABLE WATER MAIN & SIZE = PROPOSED WATER MAIN & PIPE SIZE XX" SS = PROPOSED SANITARY SEWER MAIN & SIZE EX XX" SS = EXISTING SANITARY SEWER MAIN & SIZE XX" RCWM = PROPOSED RECLAIMED WATER MAIN & SIZE = EXISTING RECLAIMED WATER MAIN & SIZE FX XX" RCWM = PROPOSED PLUG VALVE = EX PLUG VALVE  $\bowtie$ 

= EXISITNG FIRE HYDRANT = PROPOSED AUTOMATIC AIR RELEASE VALVE = PROPOSED REDUCER

= EXISTING SANITARY MANHOLE = EXISTING PUMP STATION = PROPOSED PLUG

SB XX⊕ = SOIL BORING = CATCH BASIN

 $\neg$ 

EX. MH XX

— Е —

ESB

500

9 = WOOD POWER POLE  $\rightarrow$ = CONCRETE POWER POLE

= EXISTING WATER METER

= EXISTING CLEANOUT = UNDERGROUND ELECTRIC = UNDERGROUND GAS MAIN = OVERHEAD POWER LINES

= STREET SIGN = ELECTRIC SERVICE BOX = GUY ANCHOR

= SEWER VALVE

= WOOD POWER POLE

= PROPOSED CONSTRUCTION SIGN = PROPOSED SIDEWALK

= EXISTING SAN, SEWER AND WATER MAIN OUTSIDE OF PAVEMENT TO BE GROUTED AND ABANDONED

= FXISTING SAN, SEWER AND WATER MAIN UNDER PAVEMENT TO BE REMOVED

= PROPOSED JACK AND BORE = TEMPORARY BLOW-OFF

= FLOW ARROW

= PROPOSED UTILITY ROLLDOWN

= EXISTING MH TO BE REHABBED

<u>N</u> § REVISI DATE: JANUARY 27, 2021


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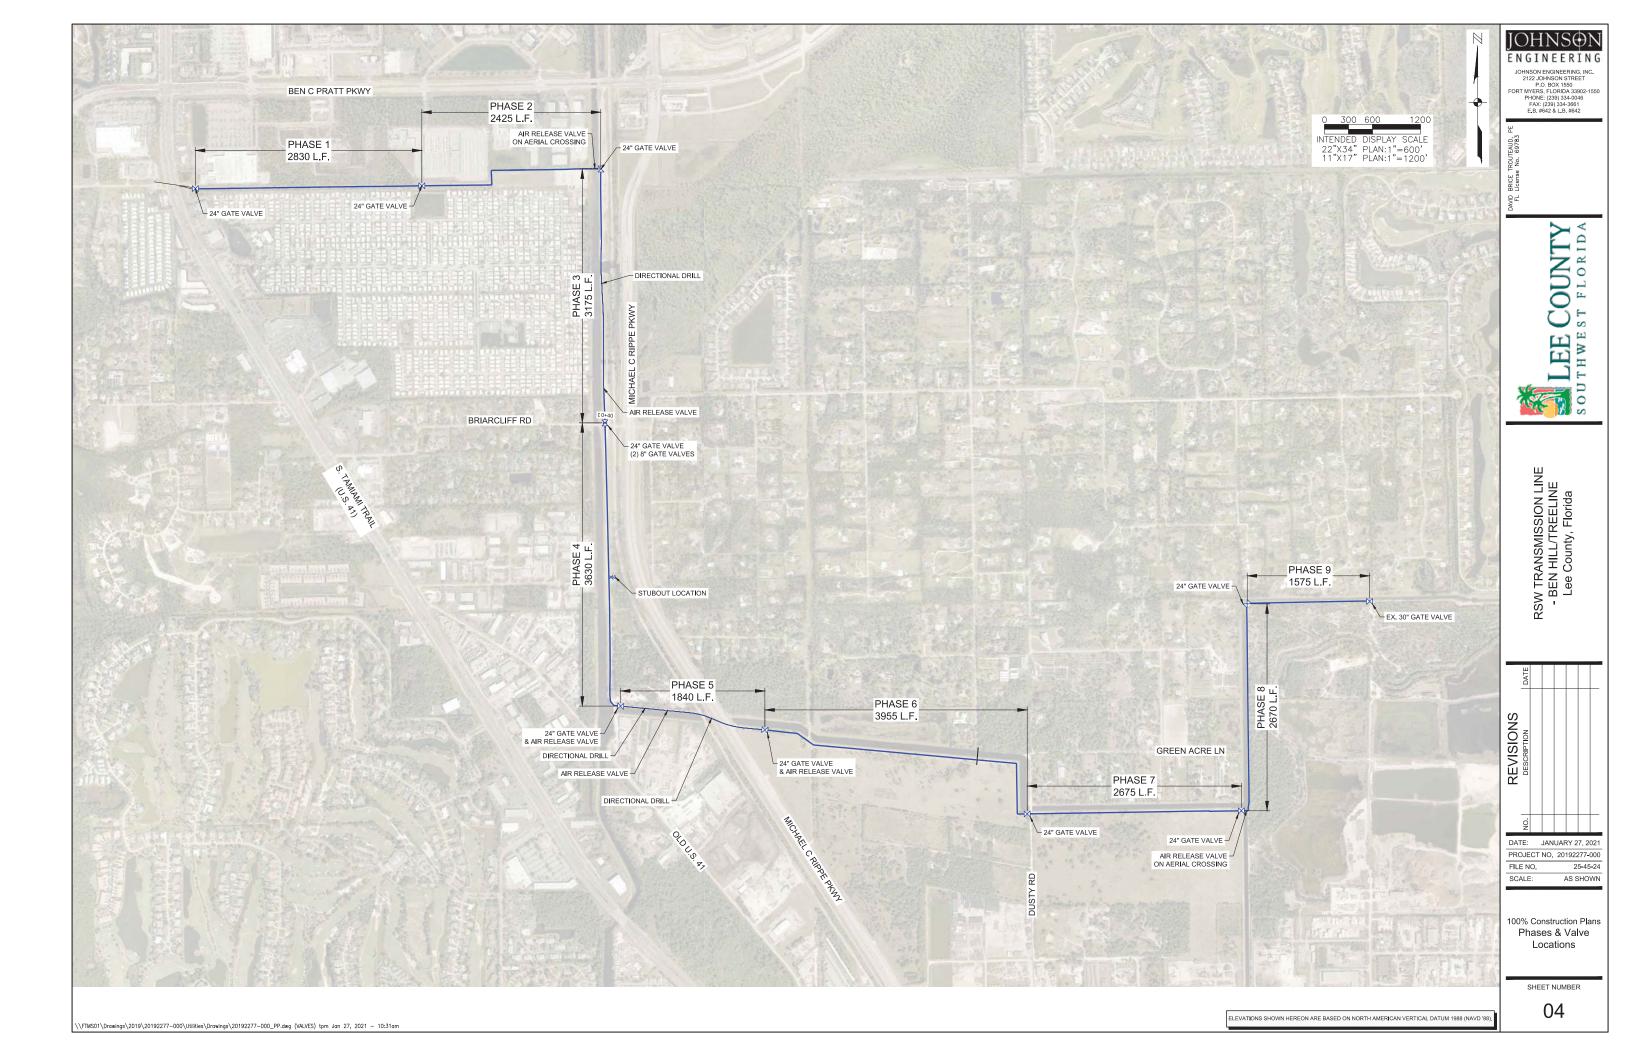
100% Construction Plans Notes & Legends


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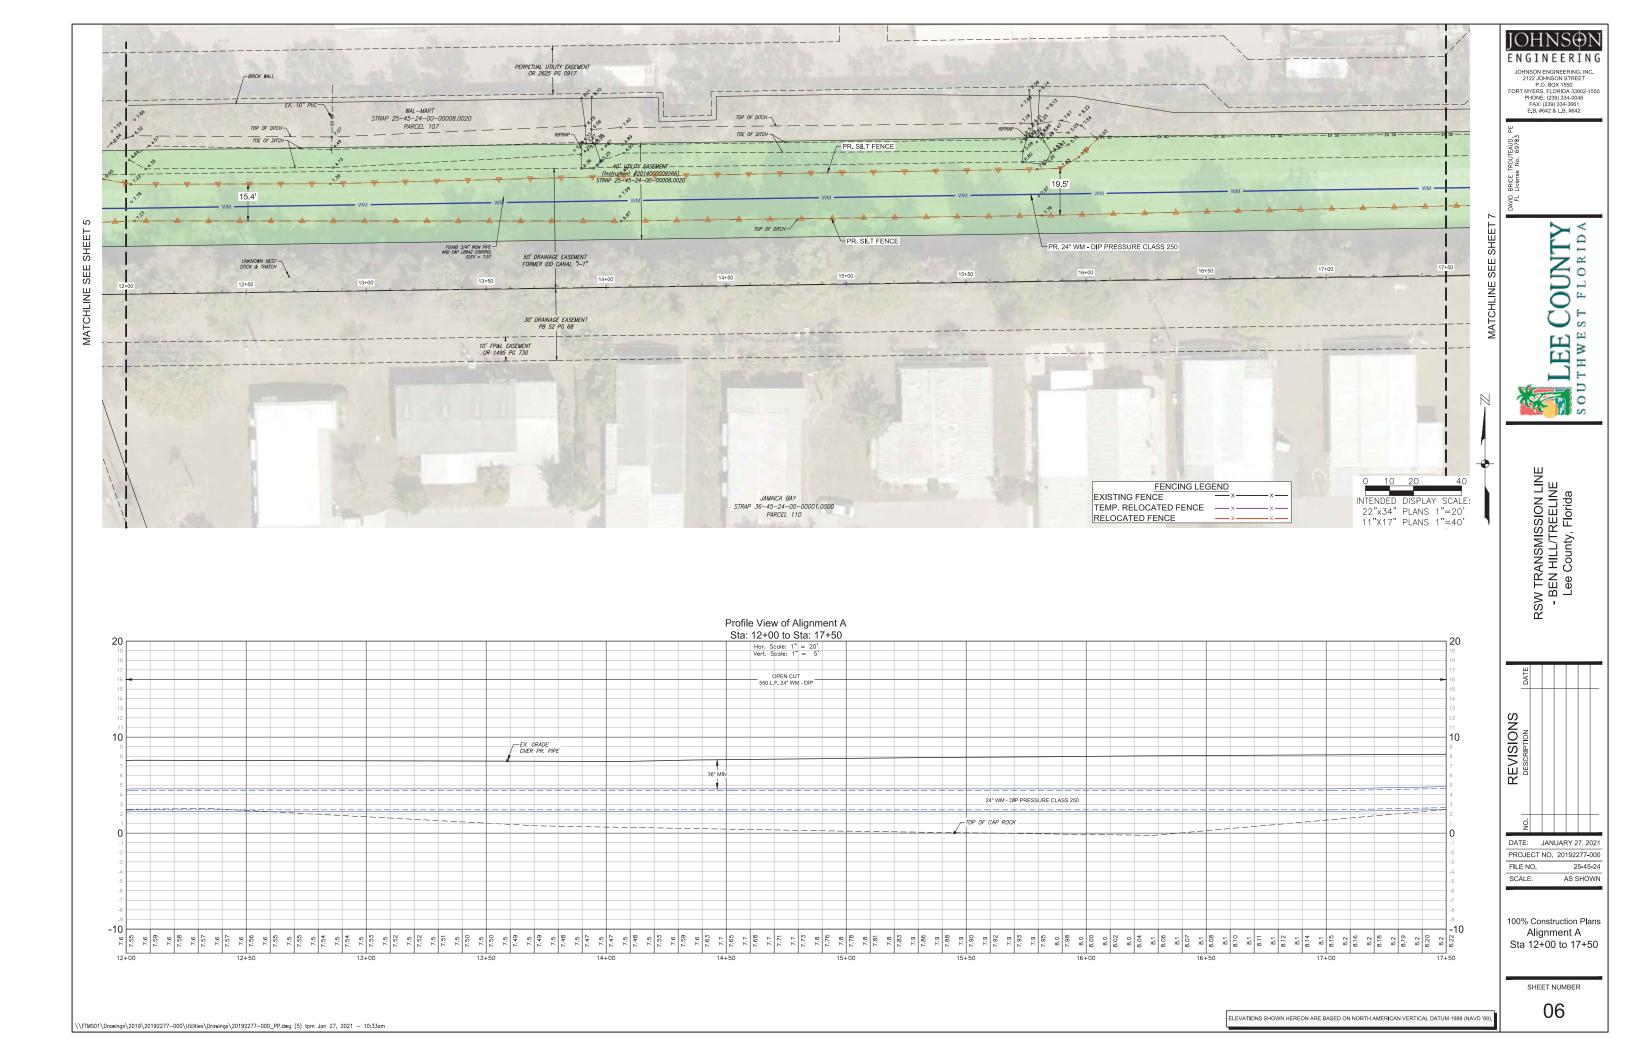
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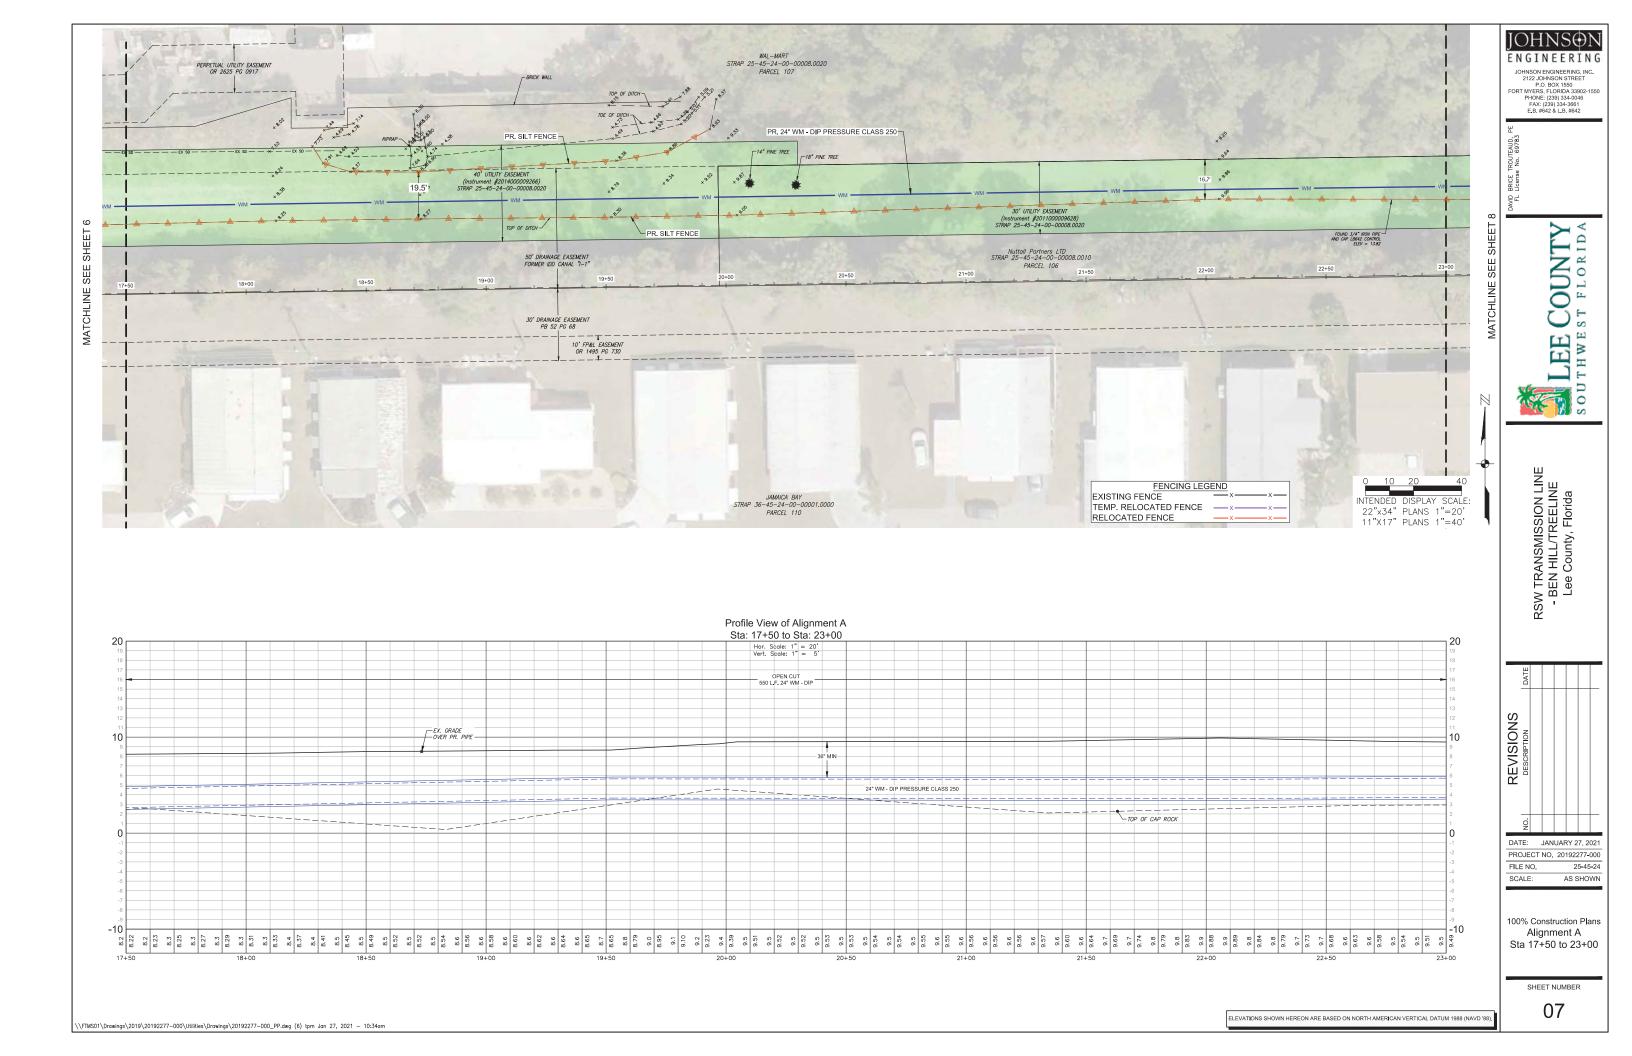
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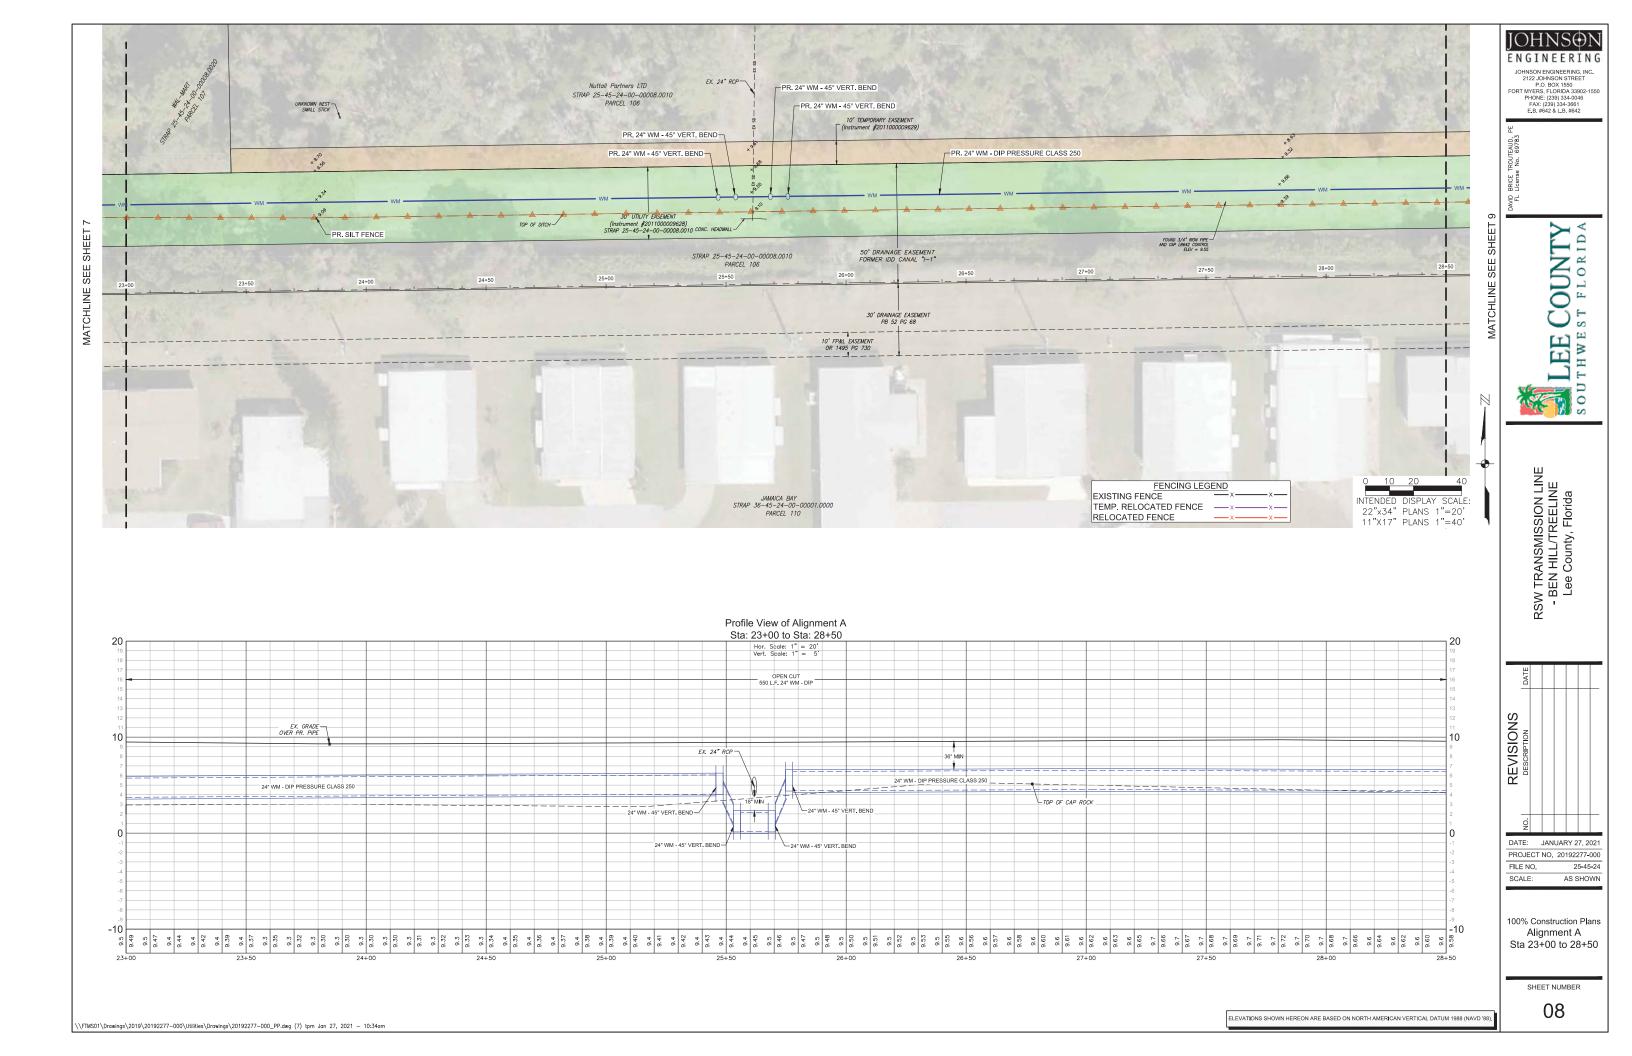











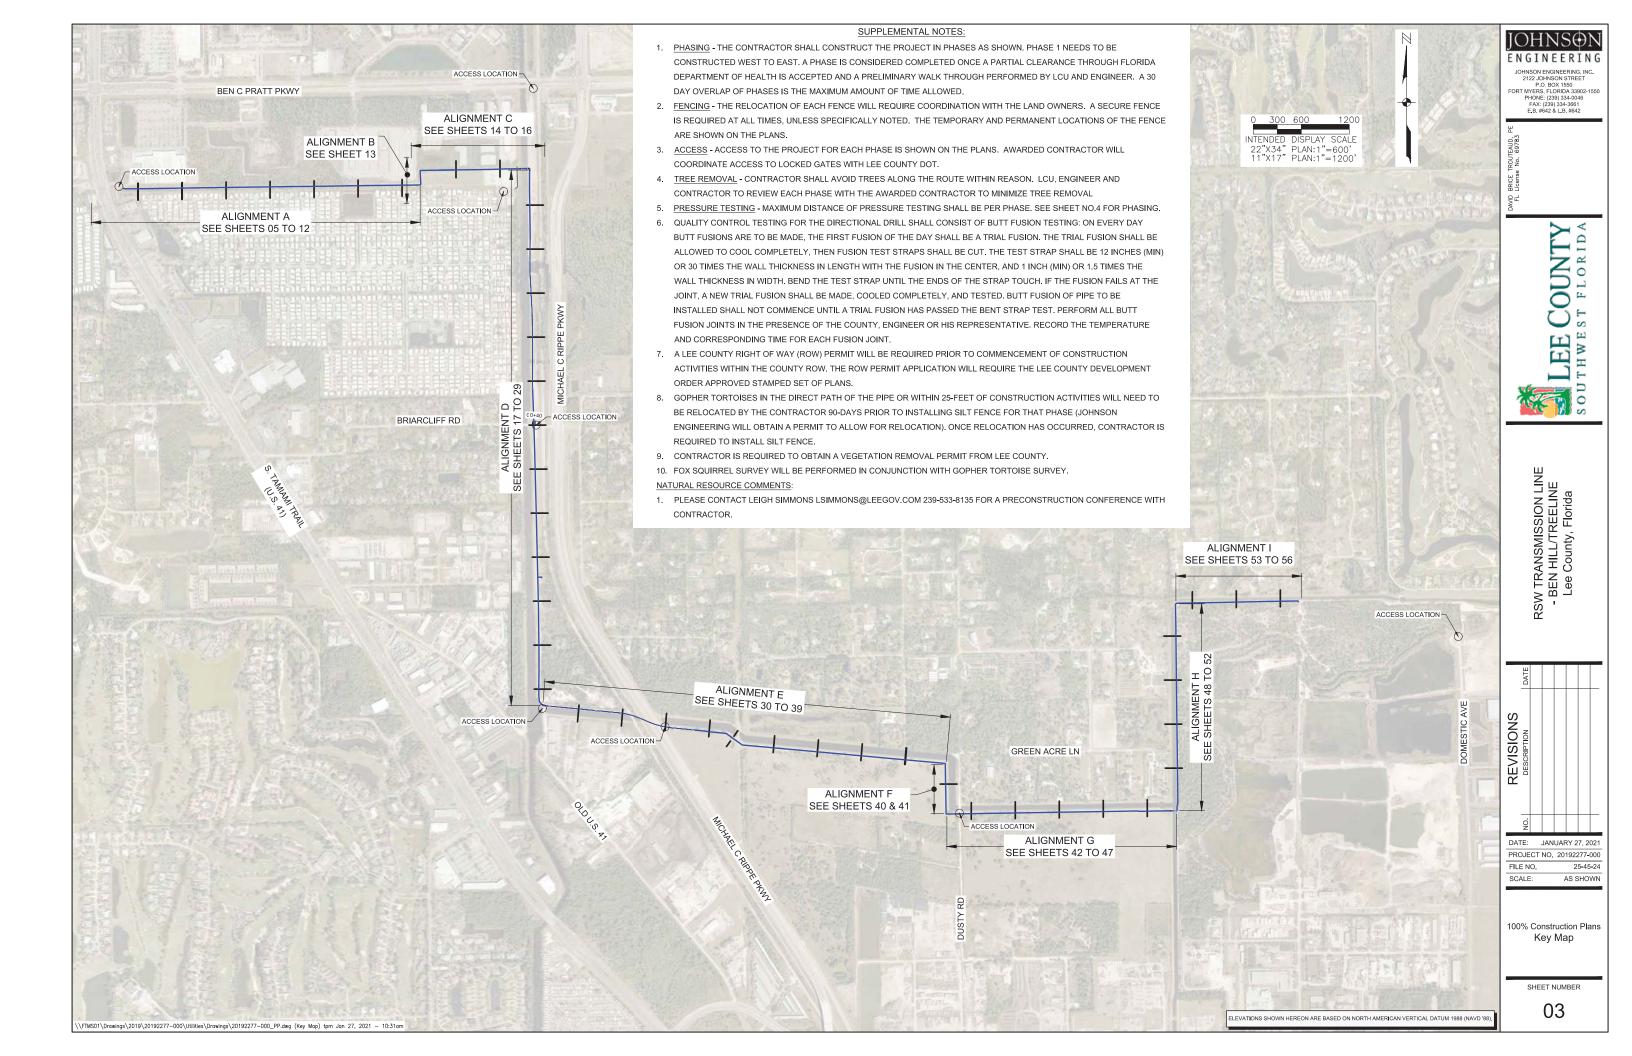


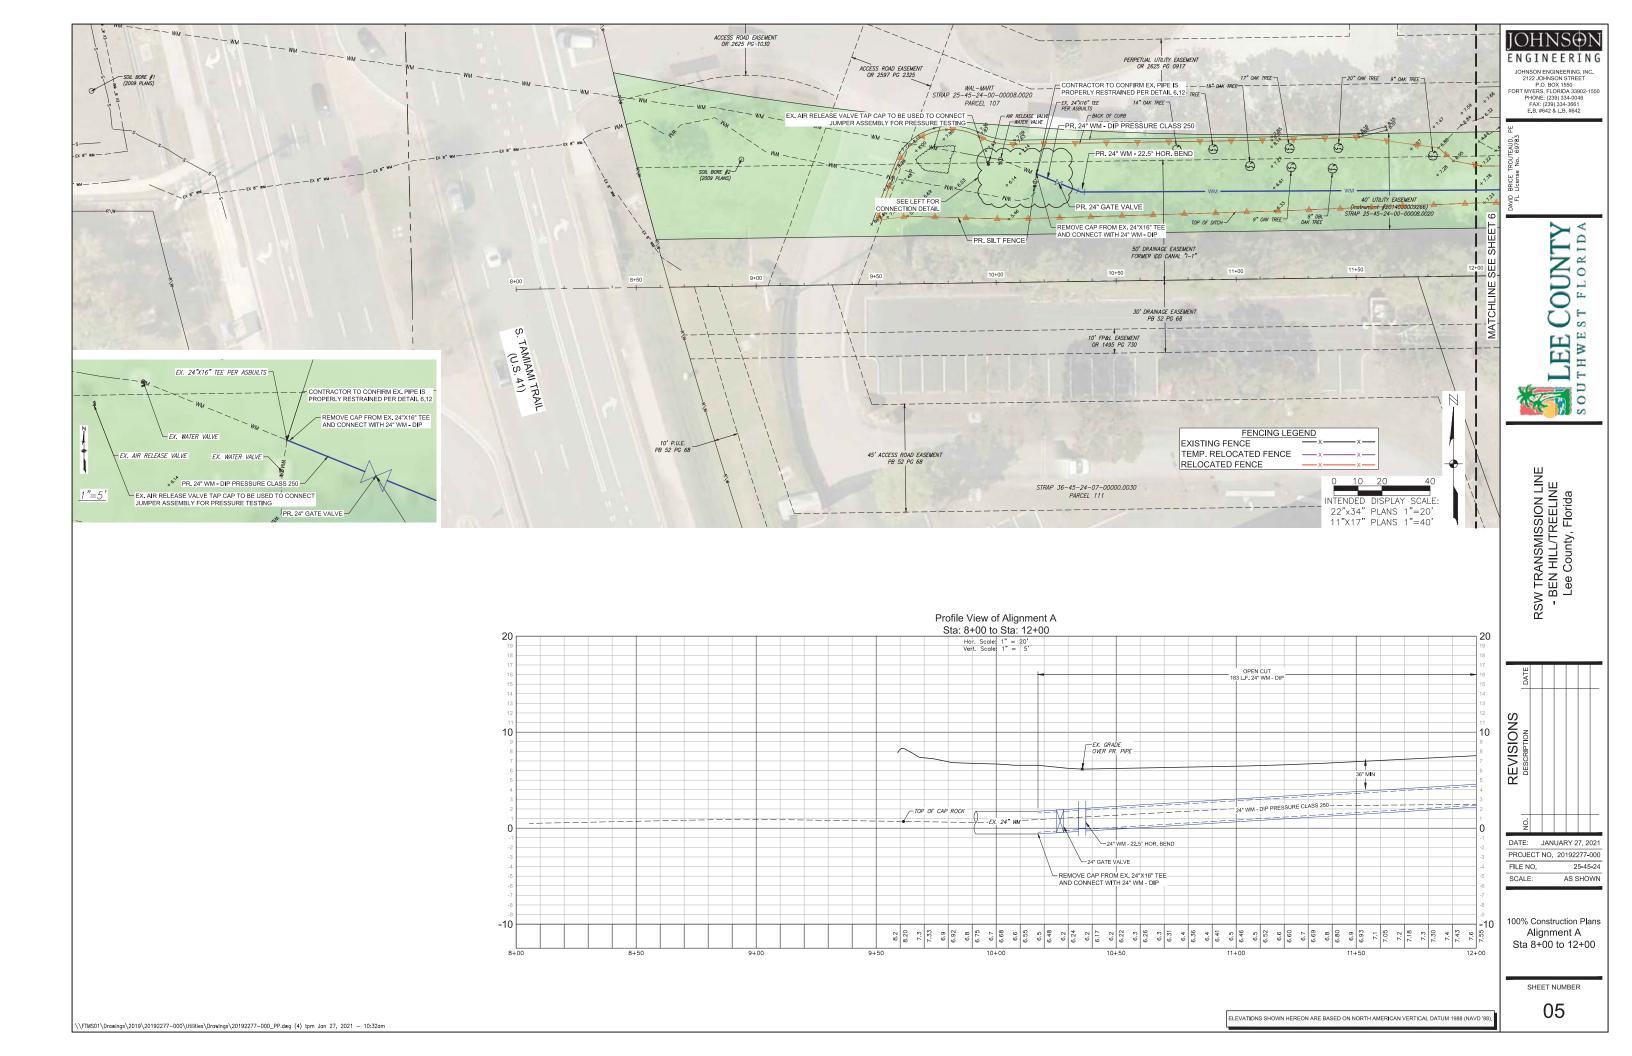


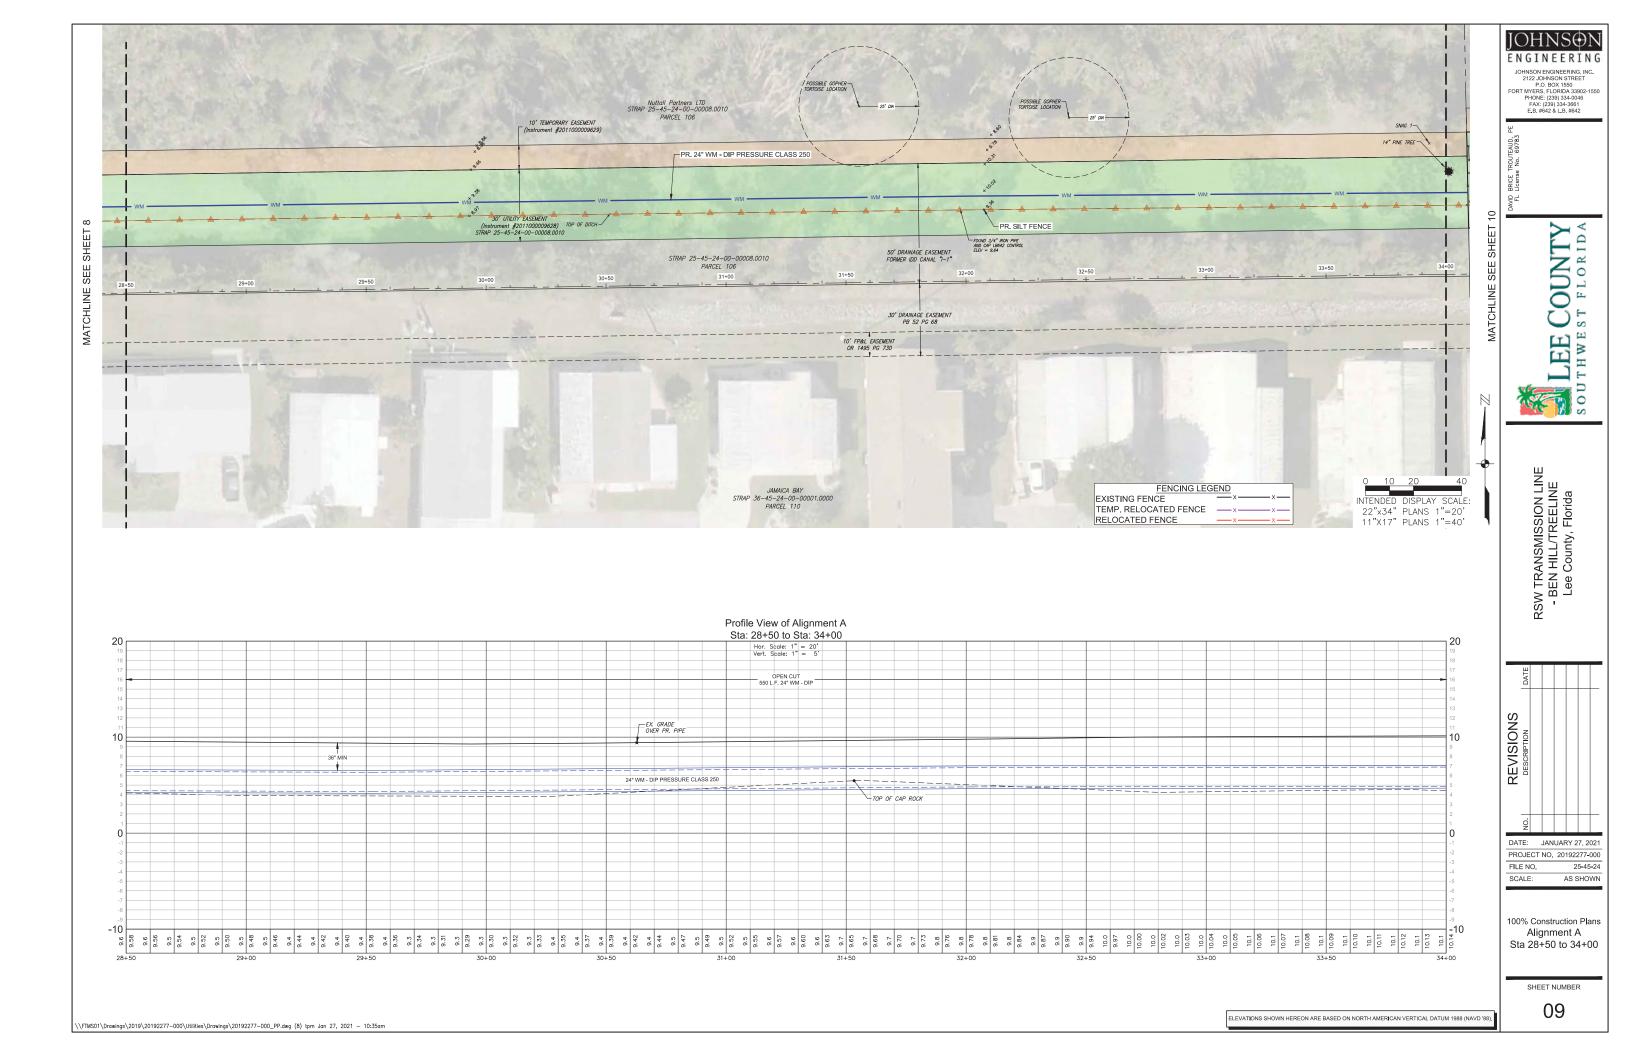

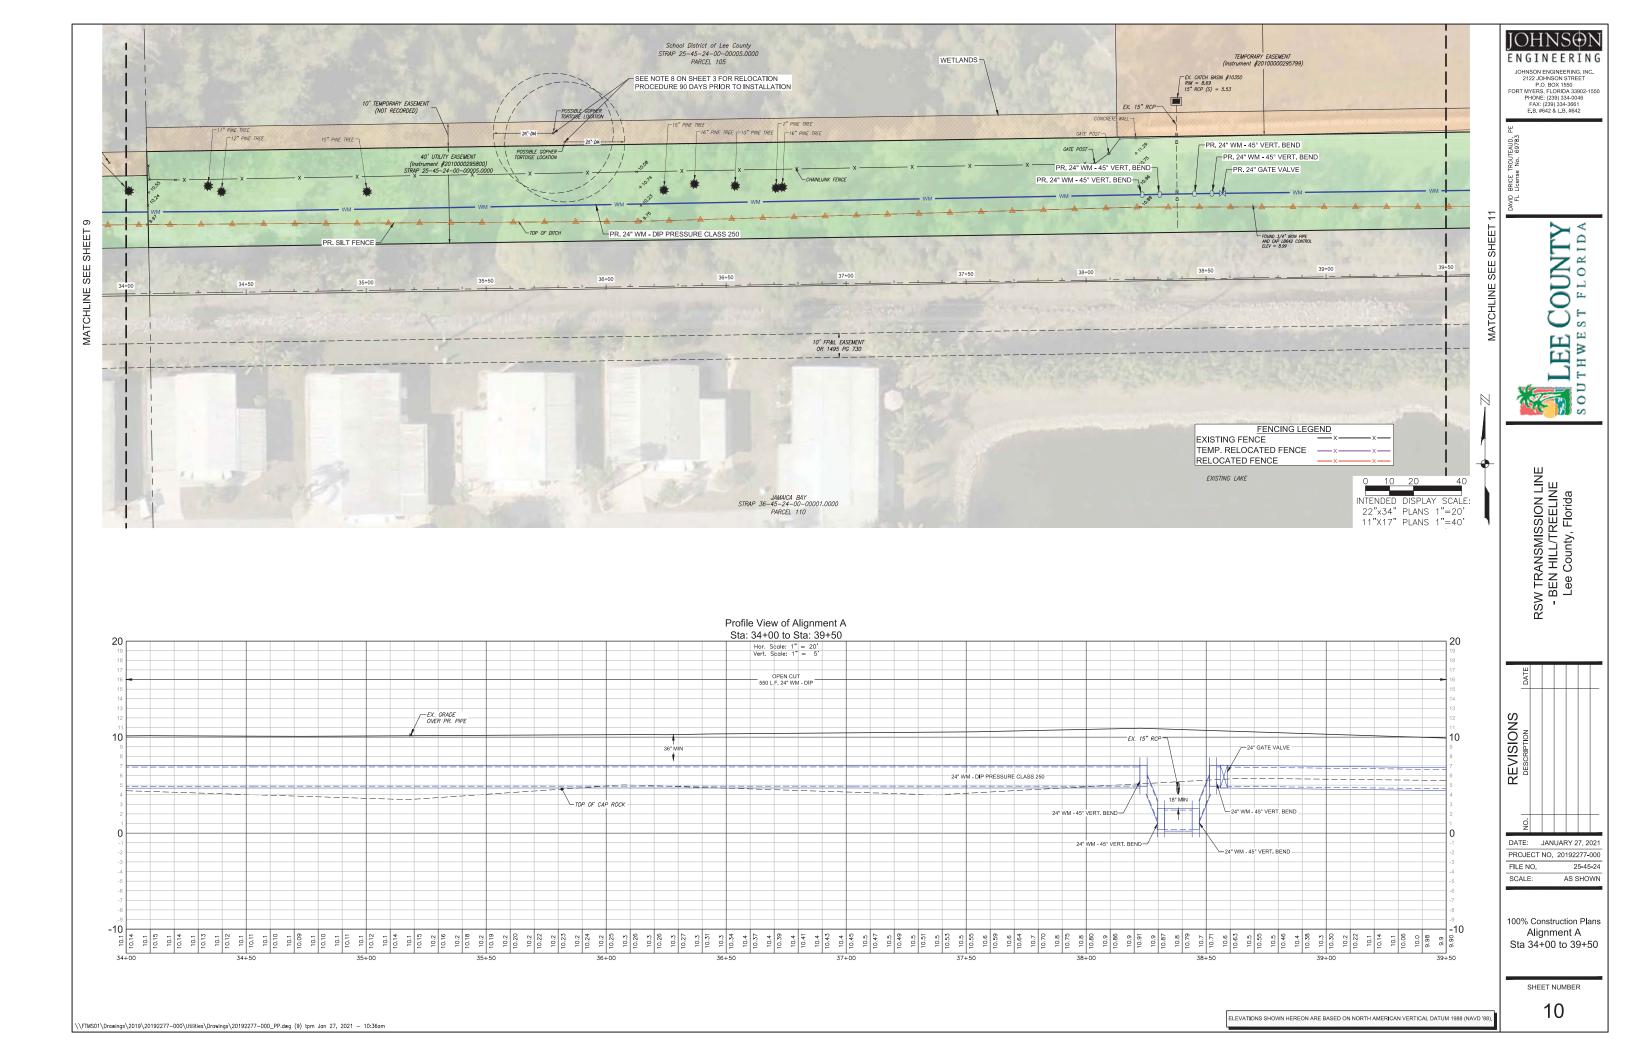

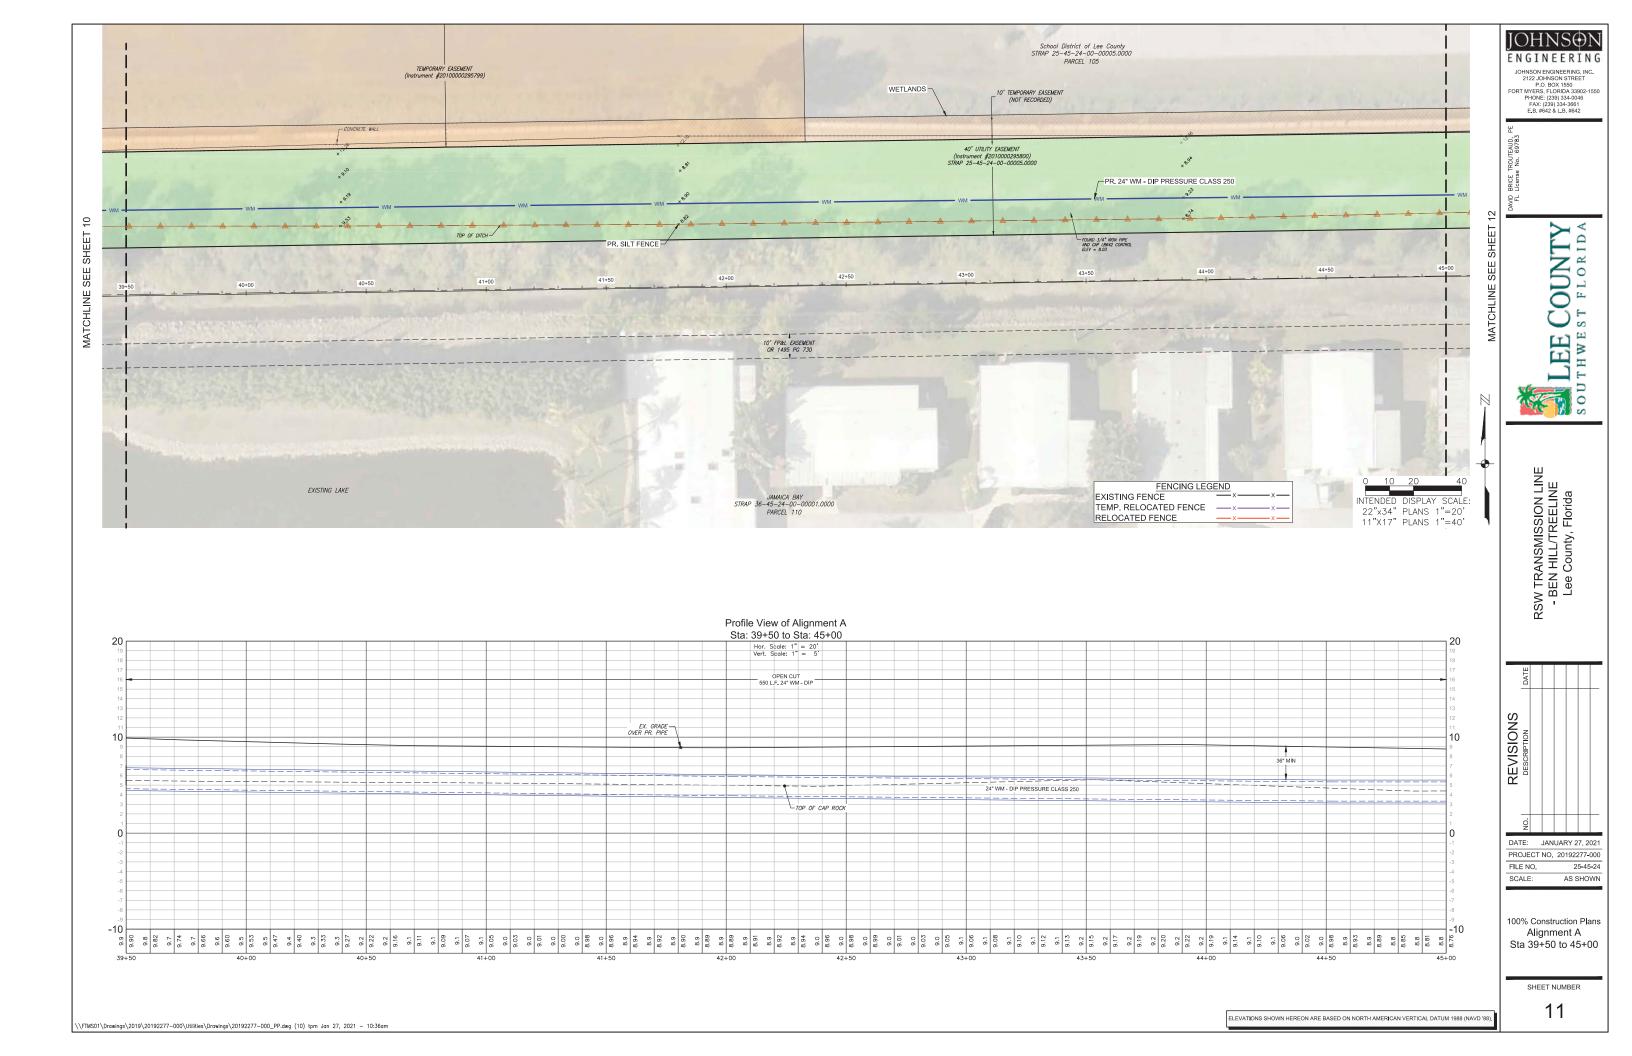

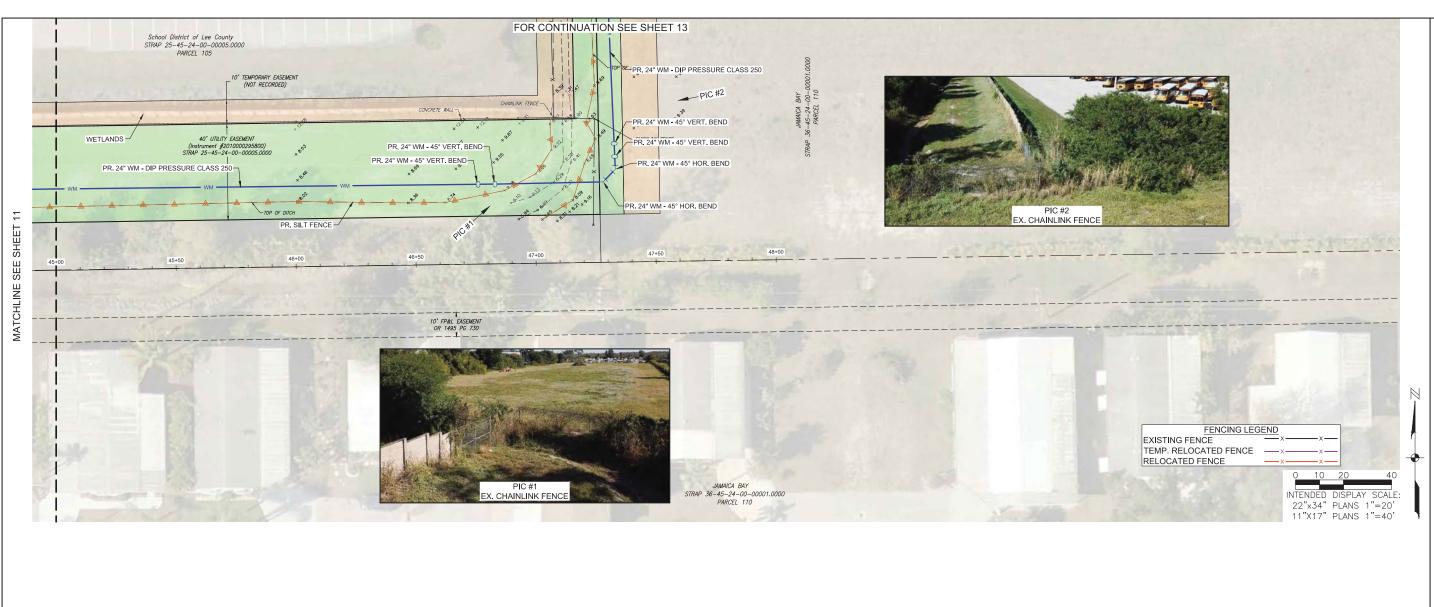

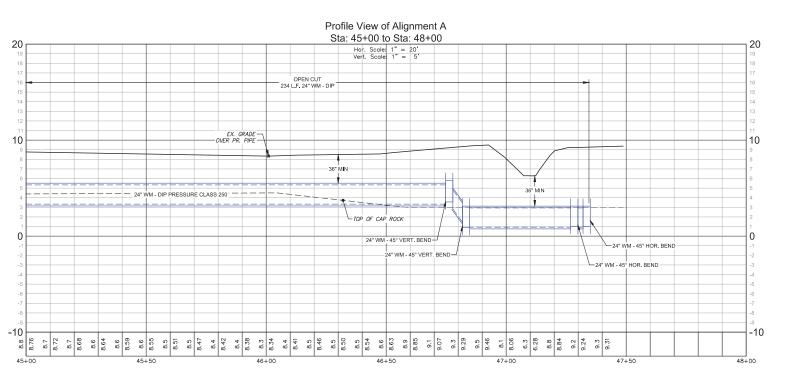



JOHNSON ENGINEERING, INC. 2122 JOHNSON STREET P.O. BOX 1550 FORT MYERS, FLORIDA 33902-1550 PHONE: (239) 334-0046 FAX: (239) 334-3661 E.B. #642 & L.B. #642

TROUTEAUD, No. 69783

LEE COUNTY SOUTHWEST FLORIDA


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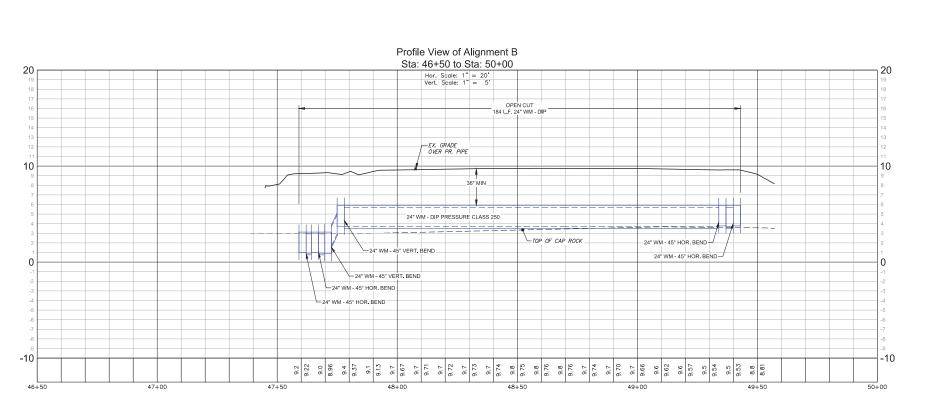


FILE NO. 25-45-24 SCALE: AS SHOWN

100% Construction Plans Alignment A Sta 45+00 to 48+00

SHEET NUMBER



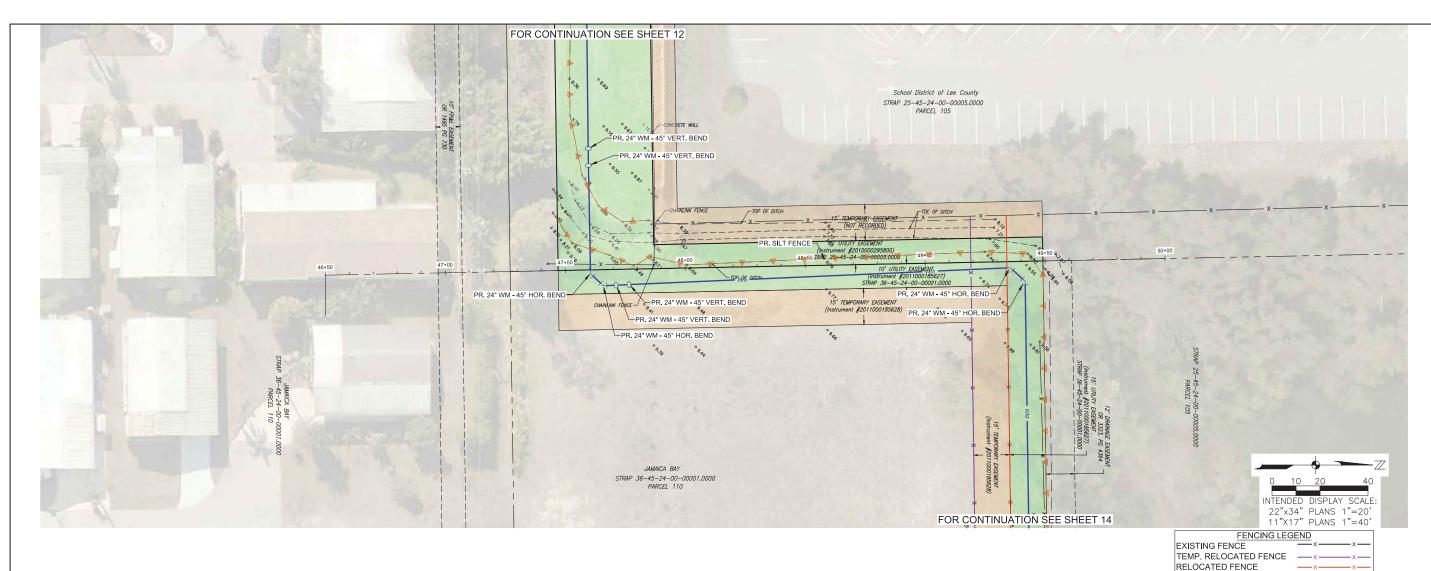

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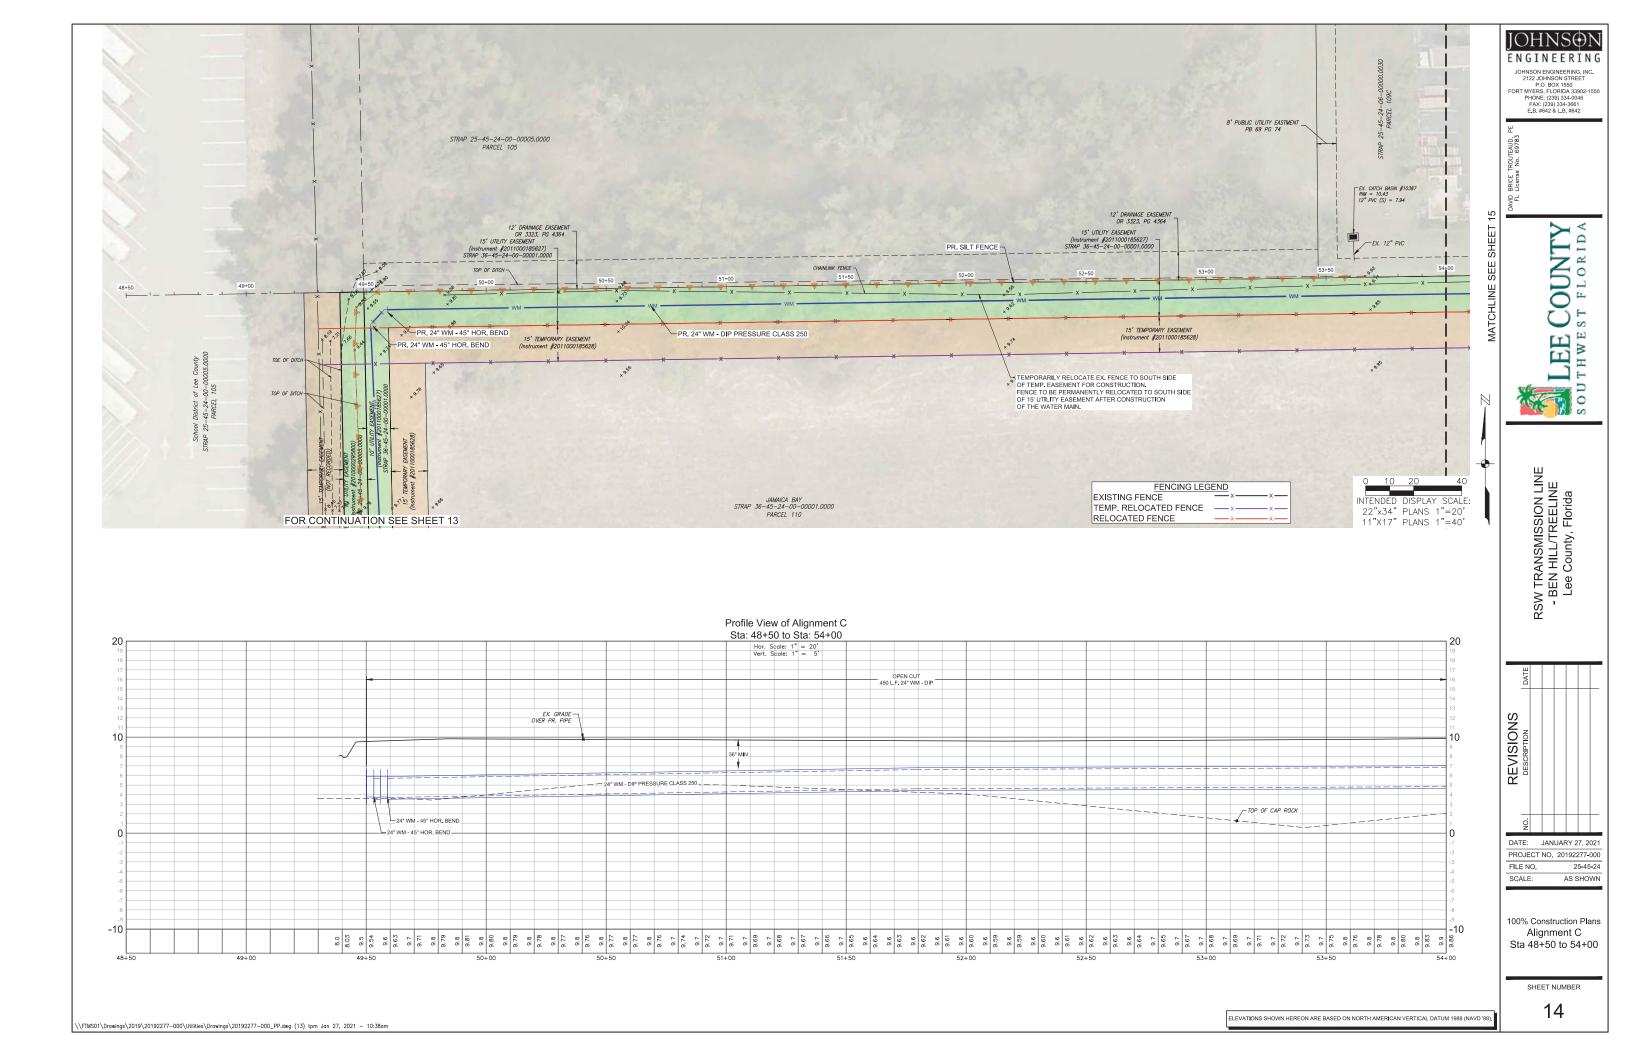
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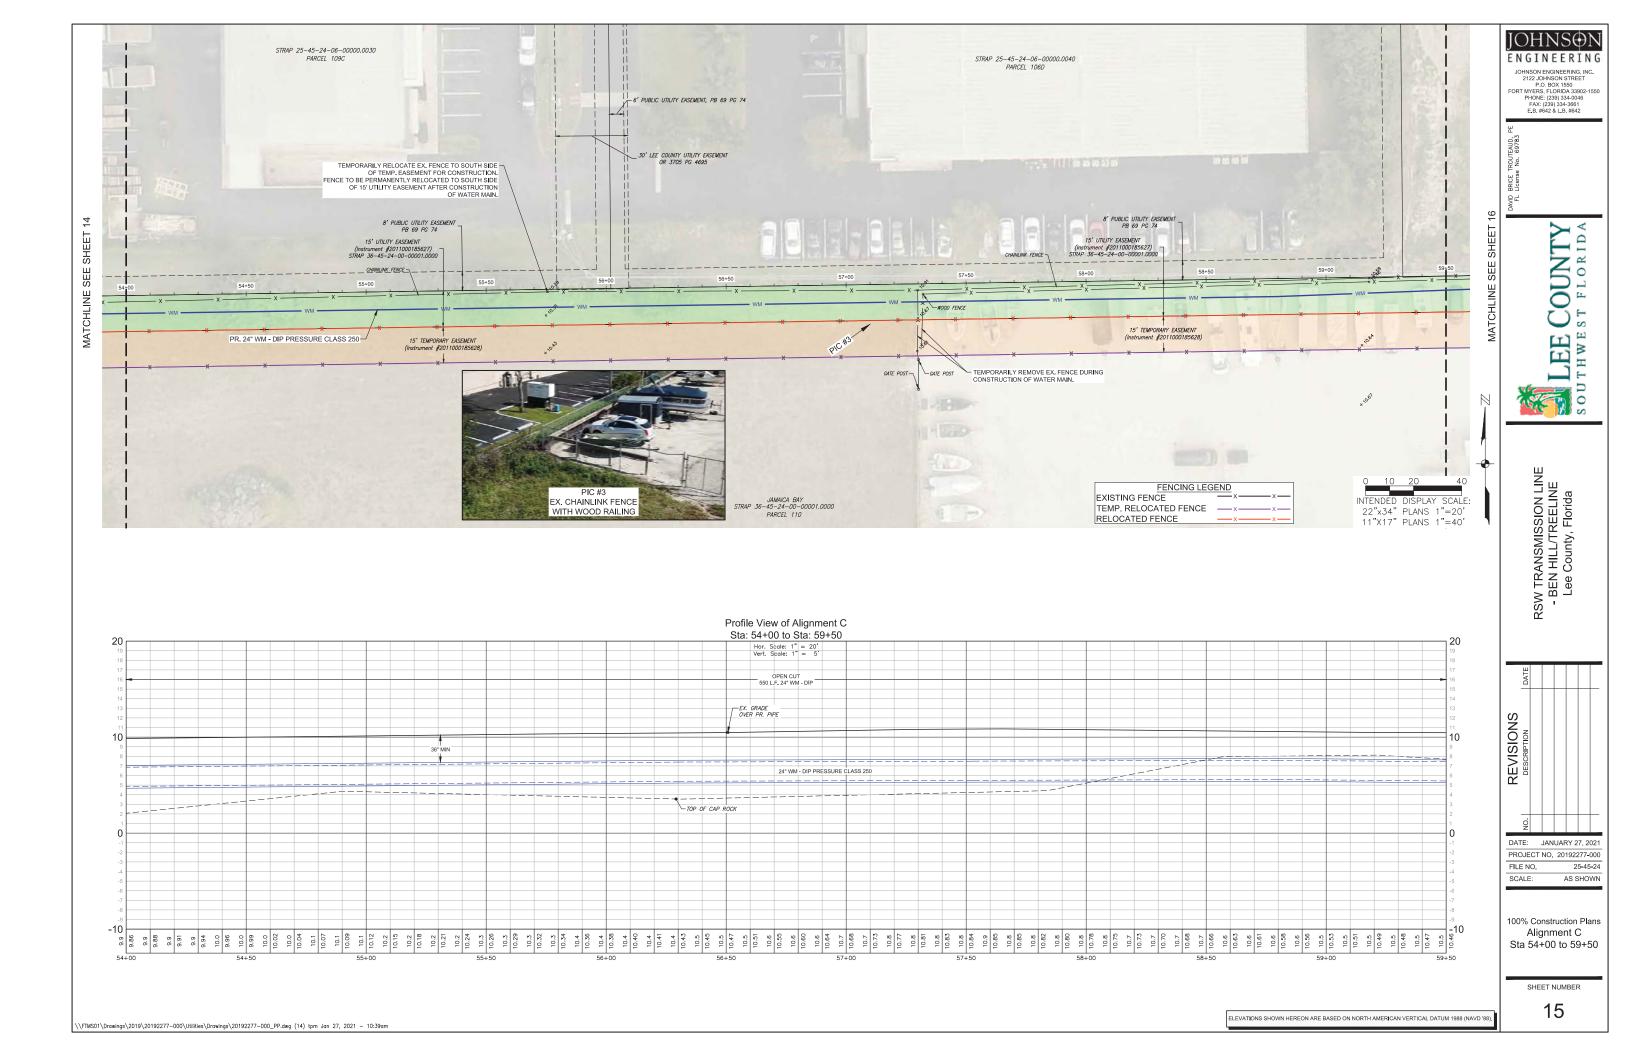
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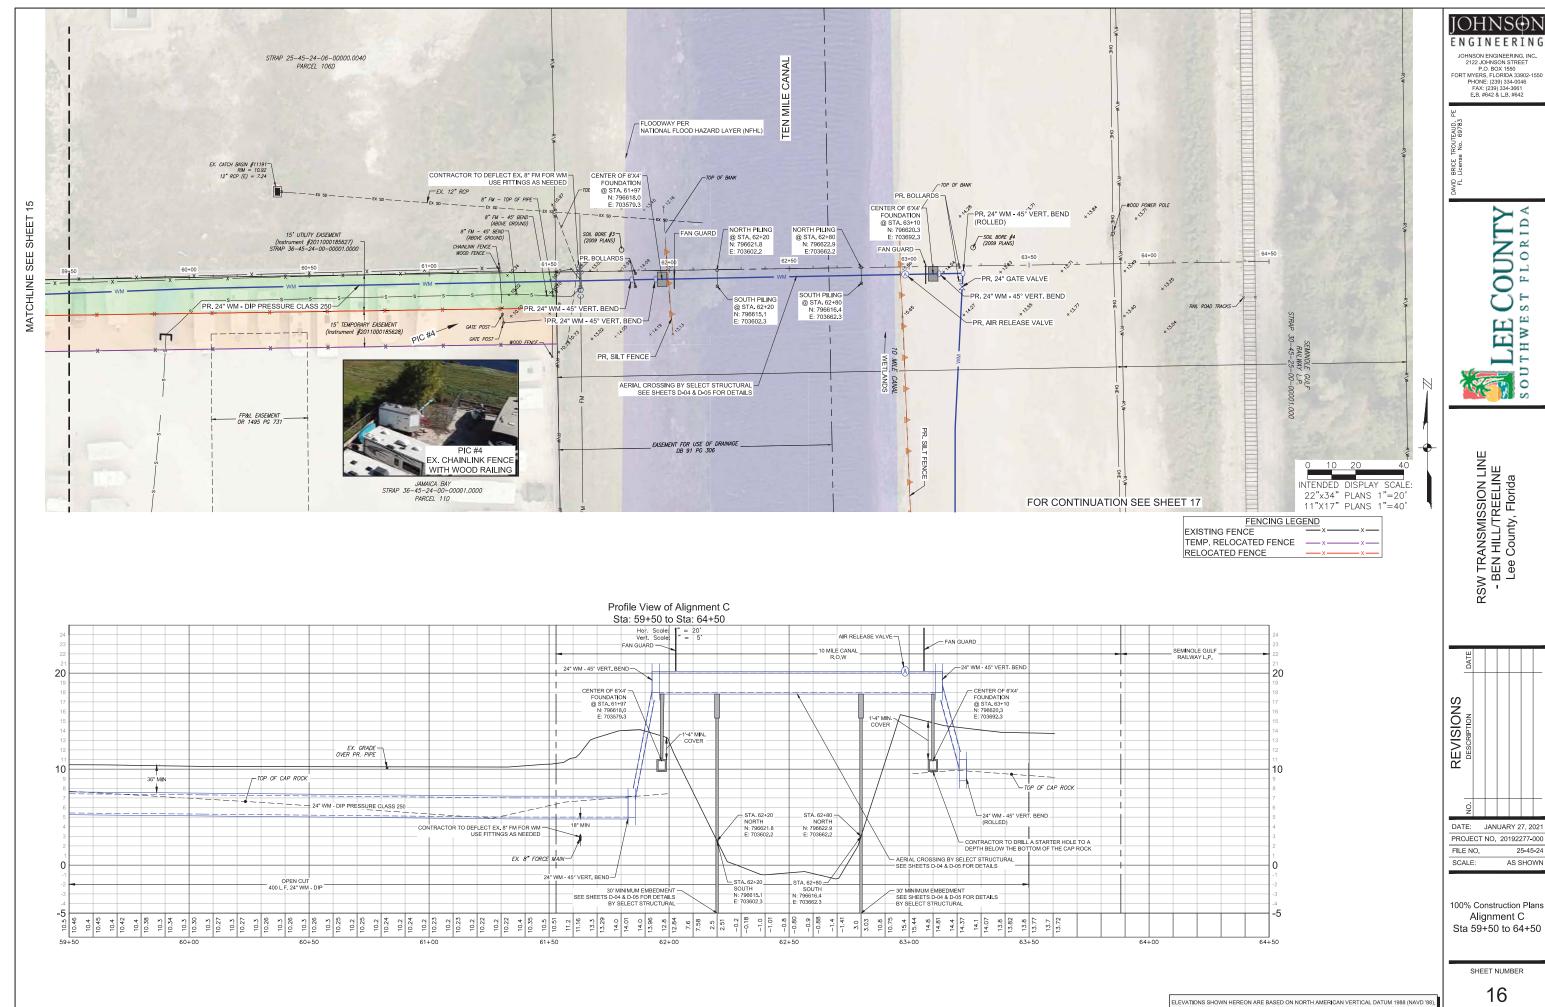
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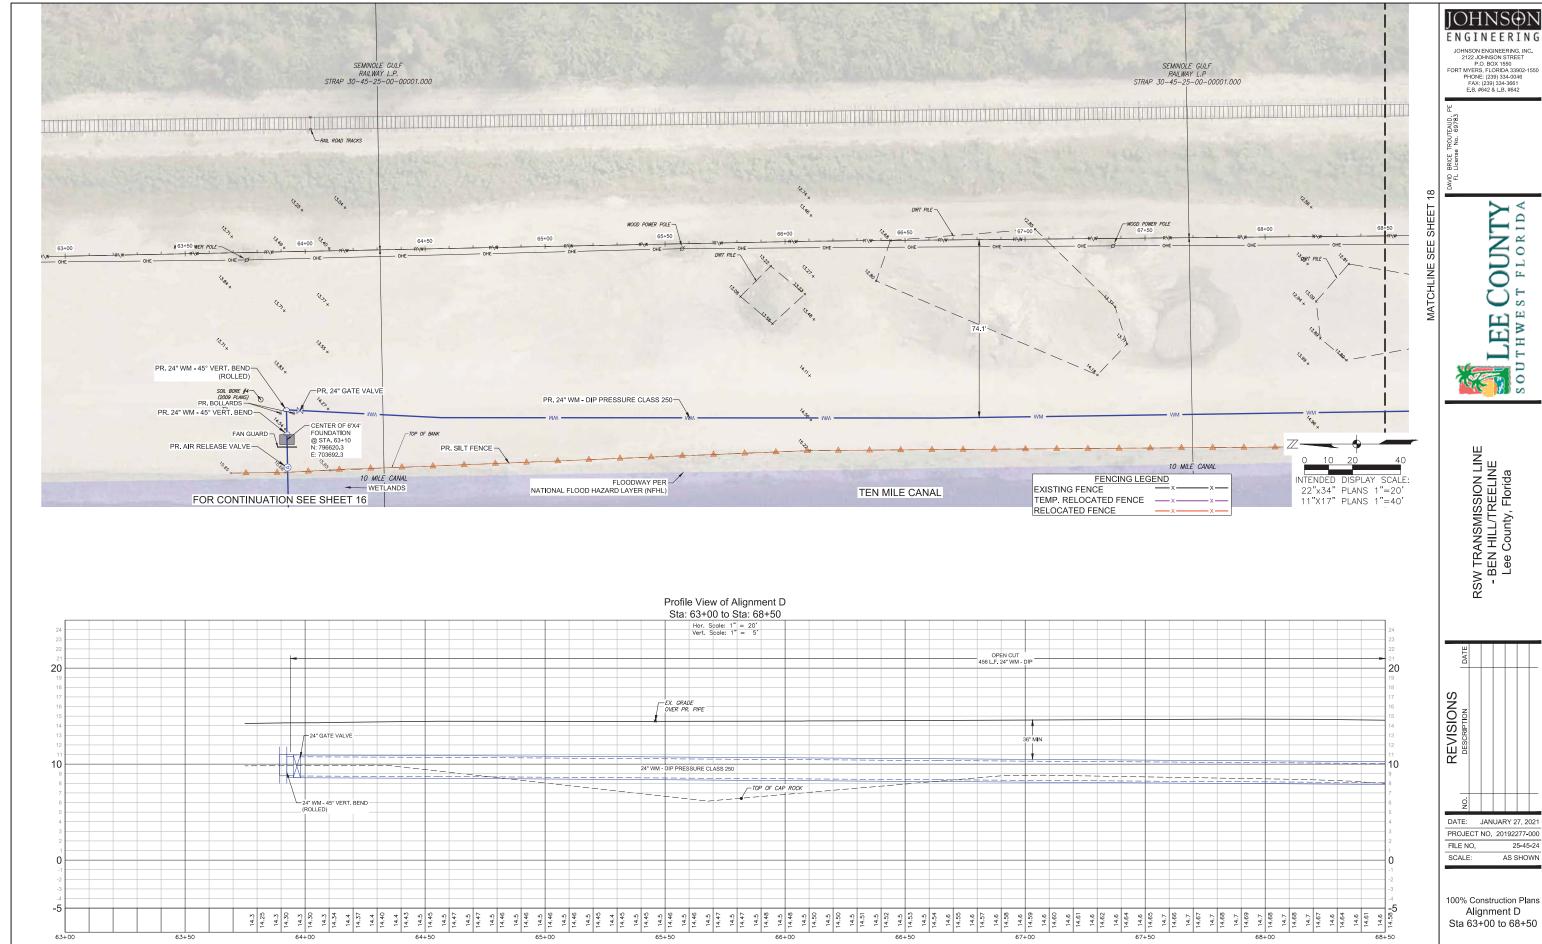




PROJECT NO. 20192277-000 25-45-24

100% Construction Plans

Sta 59+50 to 64+50





PROJECT NO. 20192277-000


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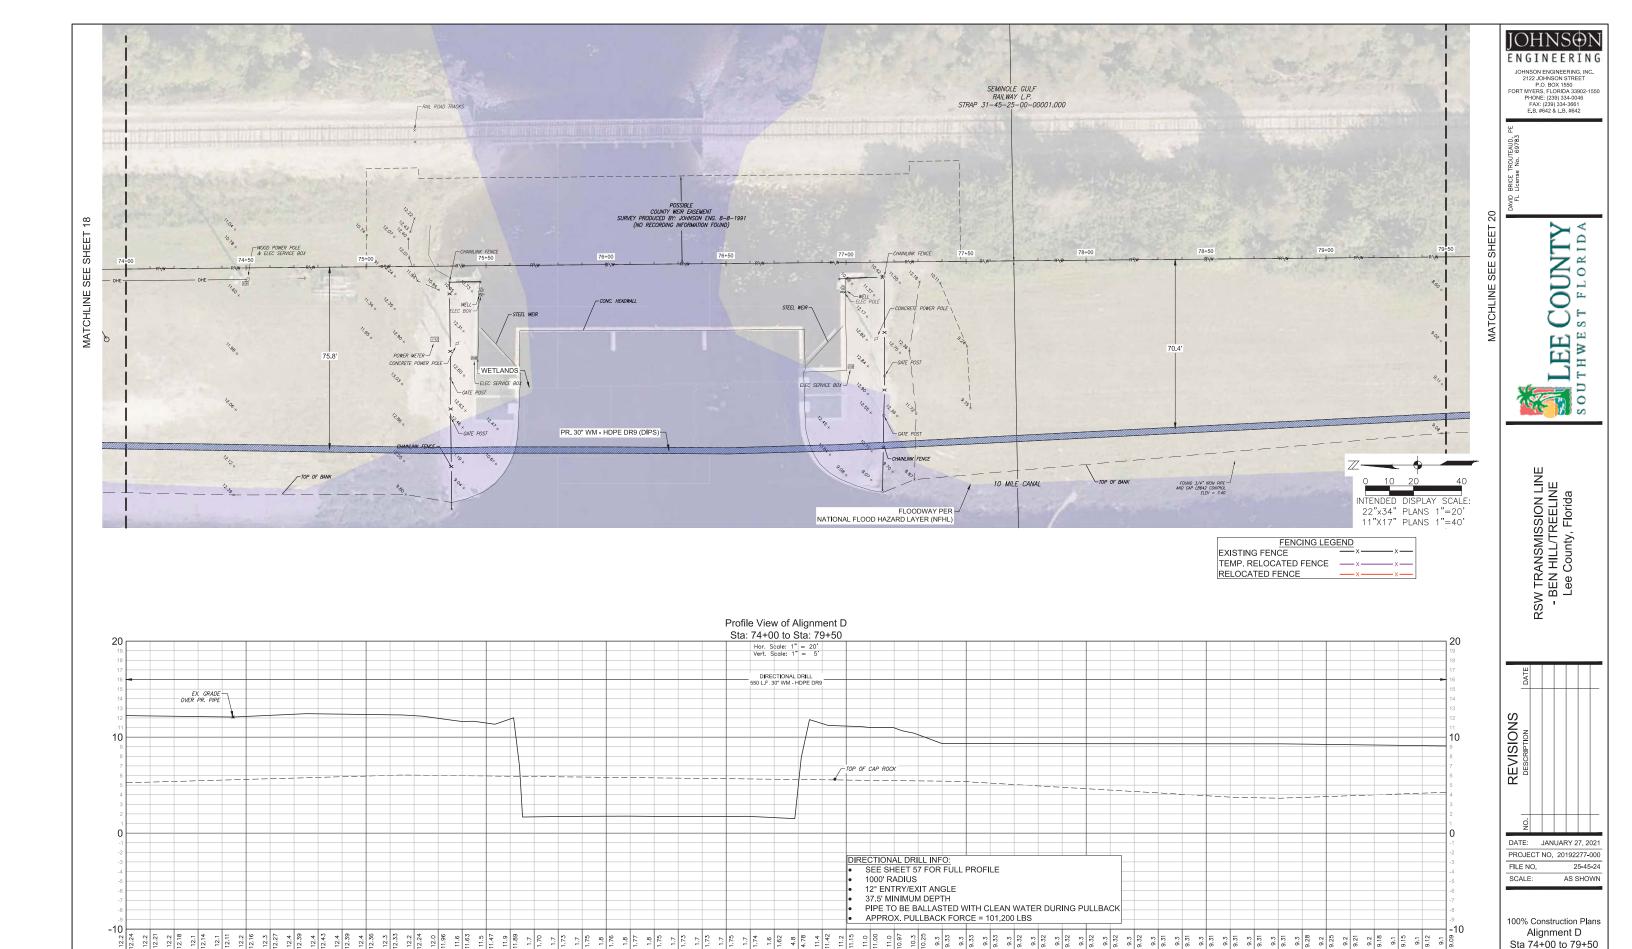
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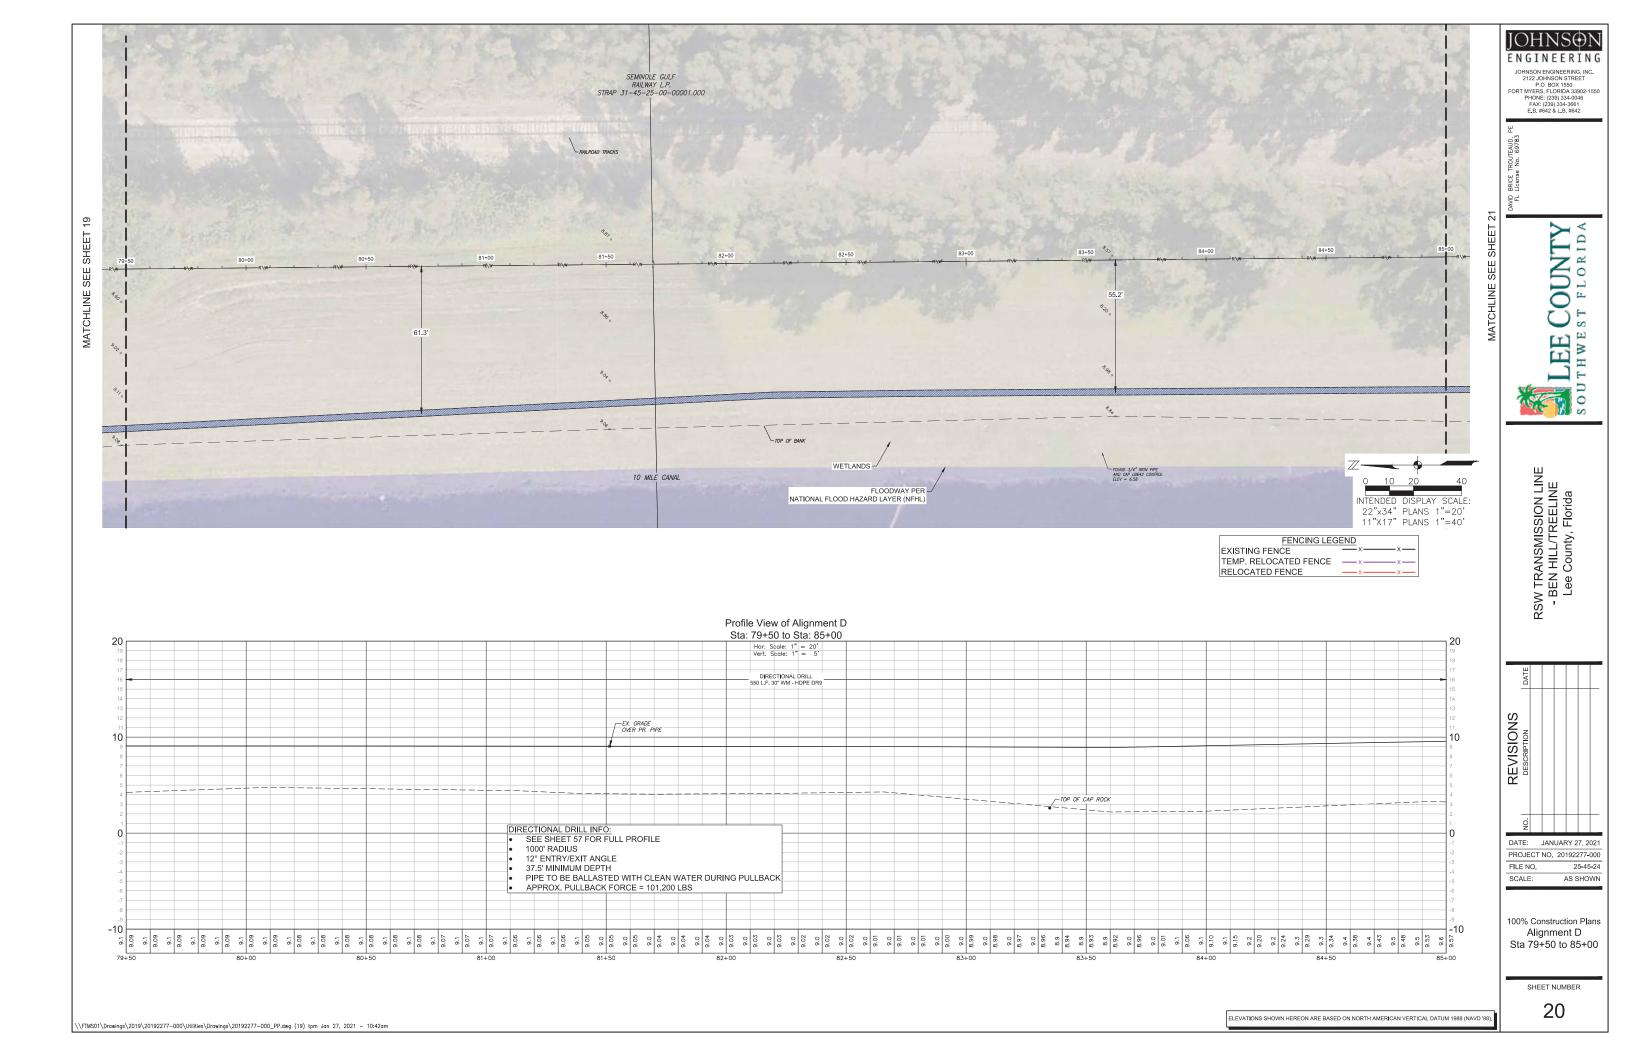






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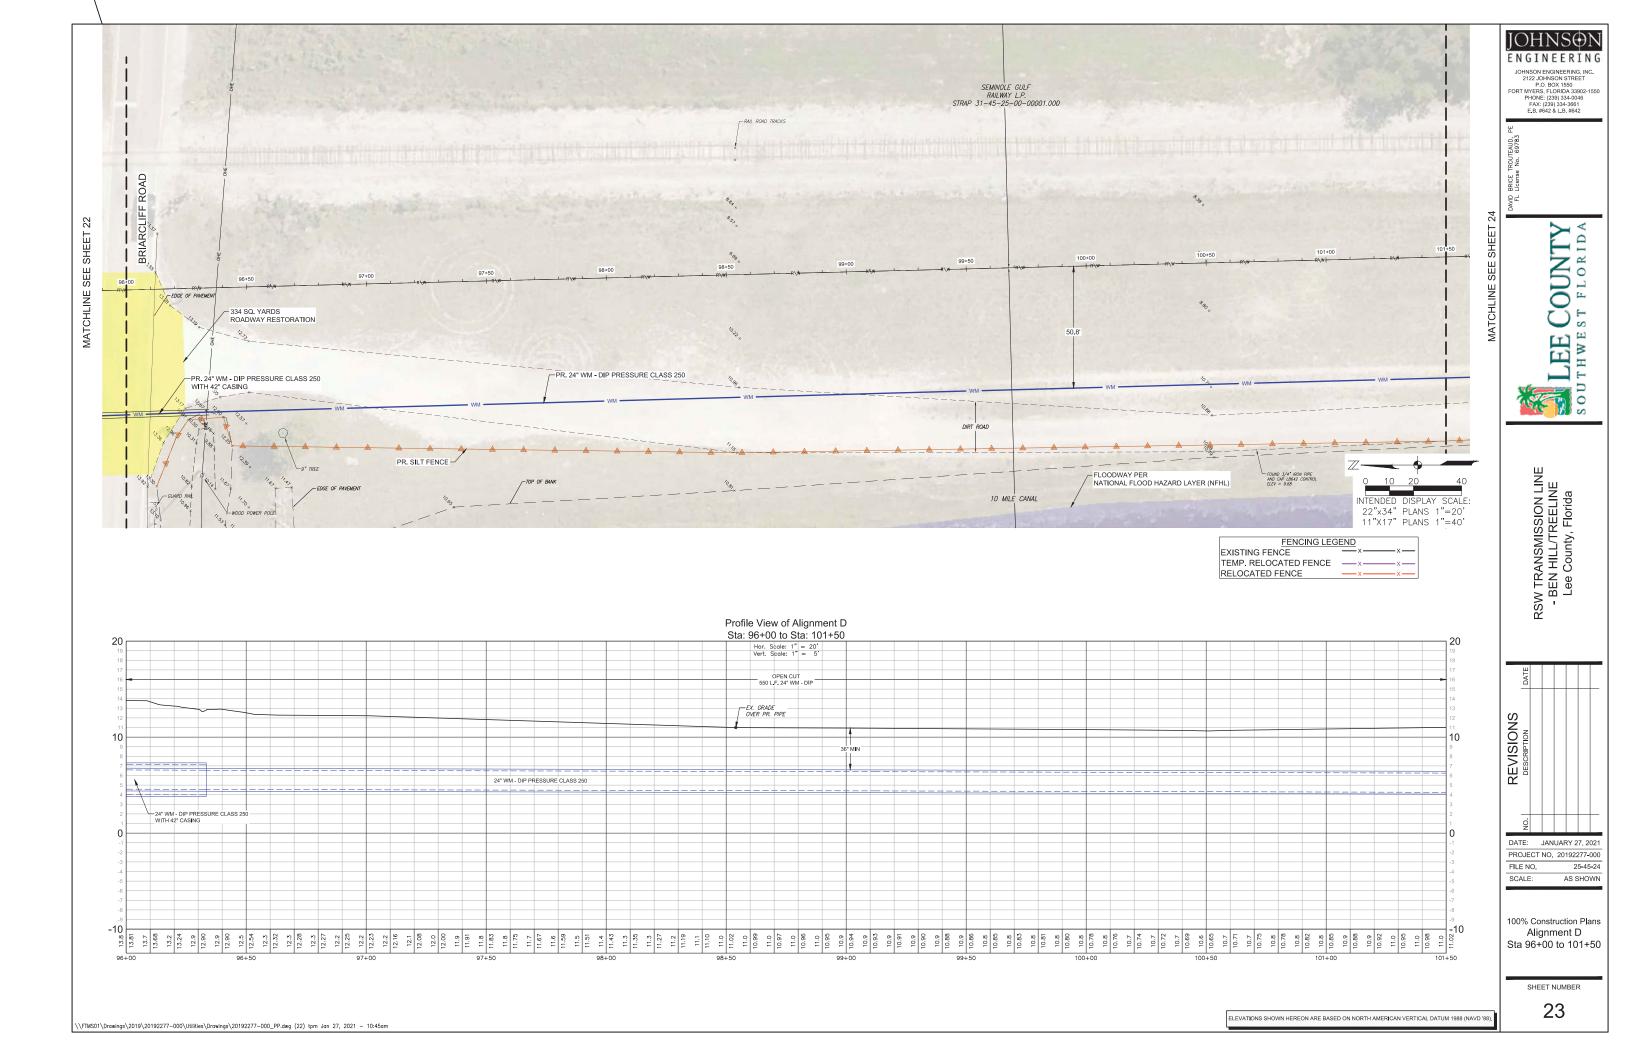
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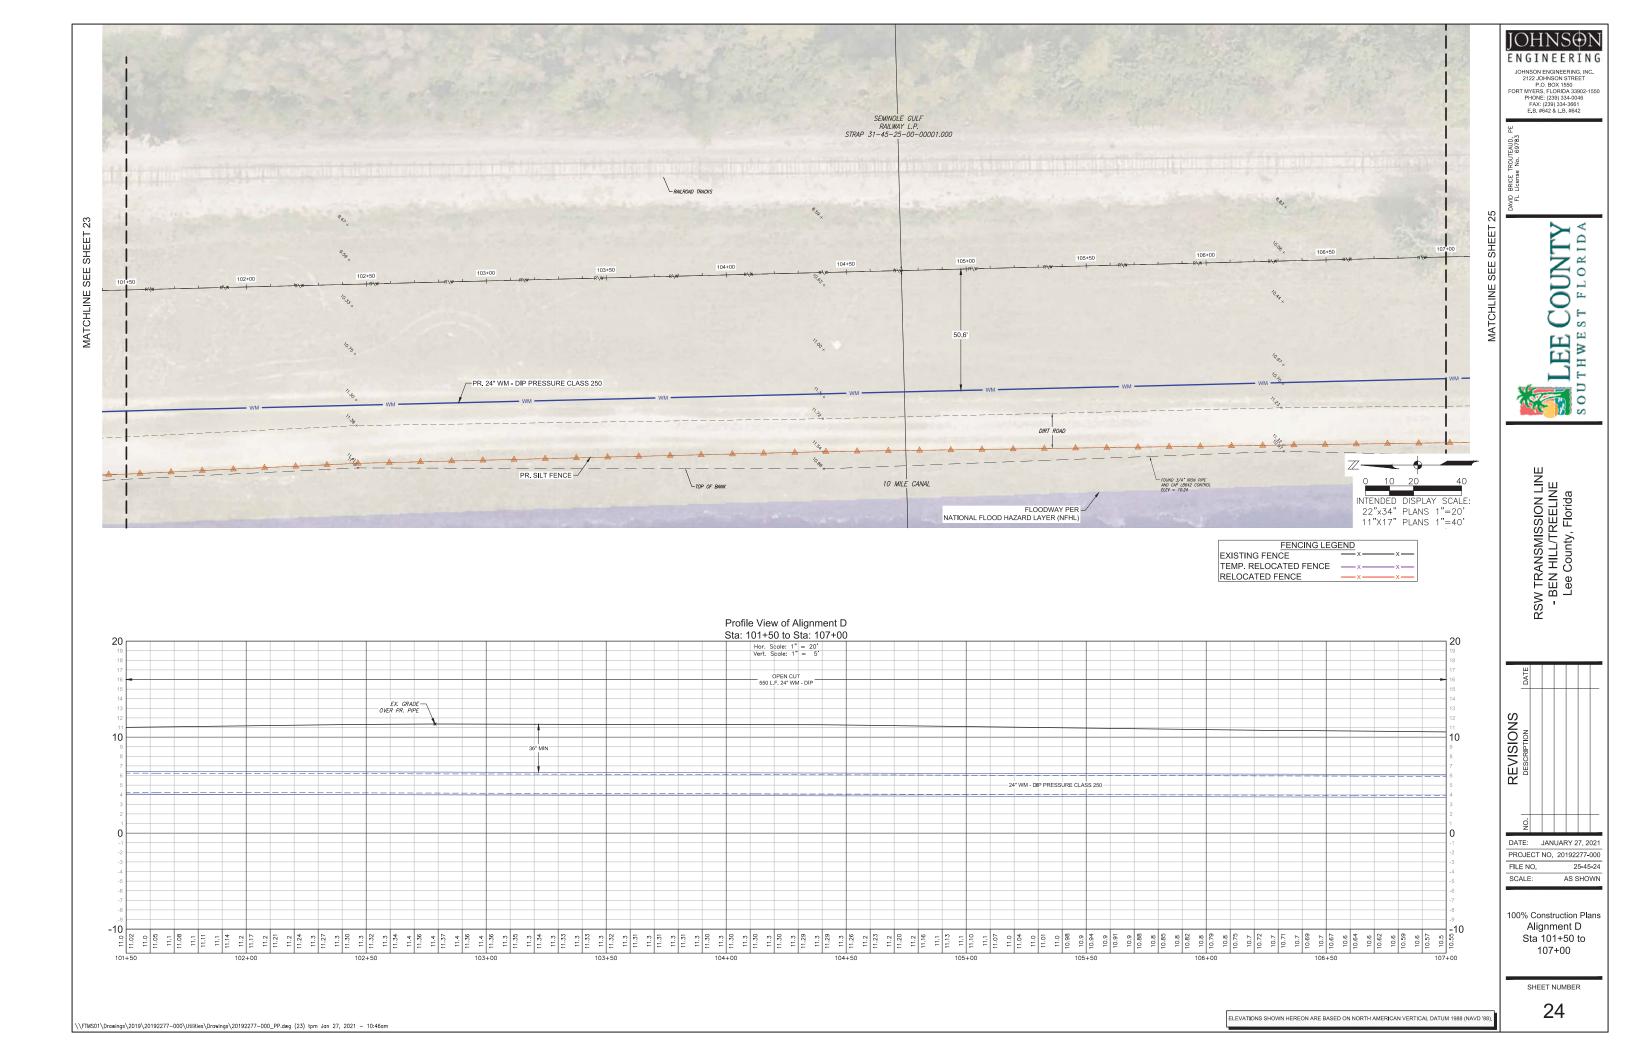
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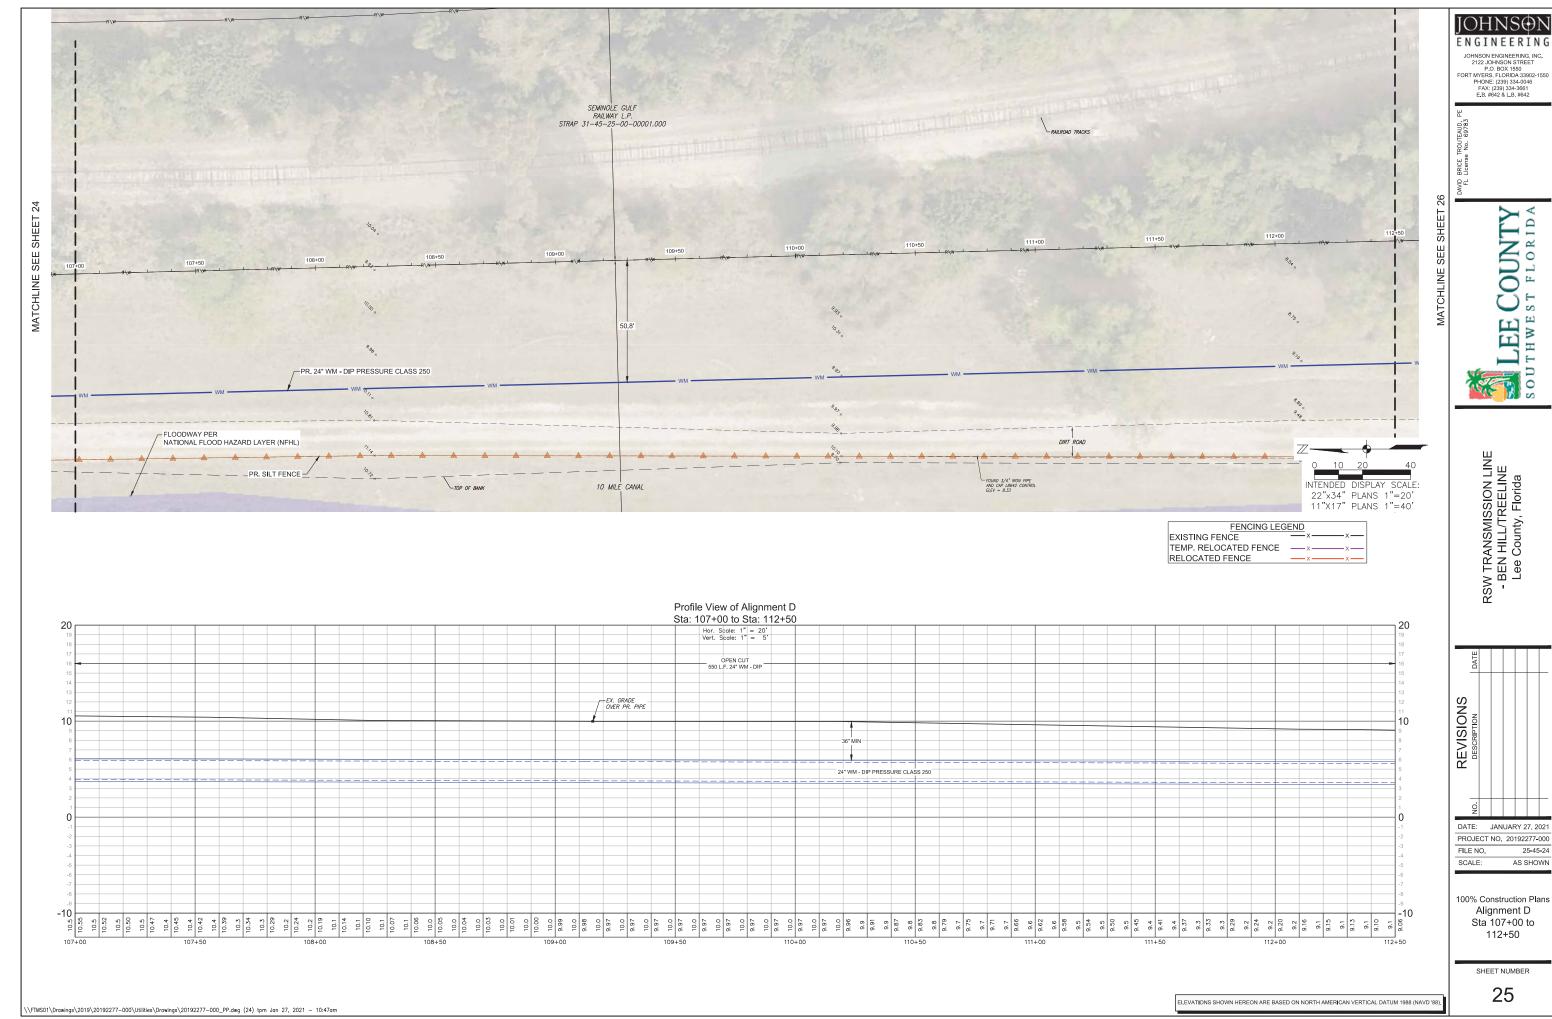







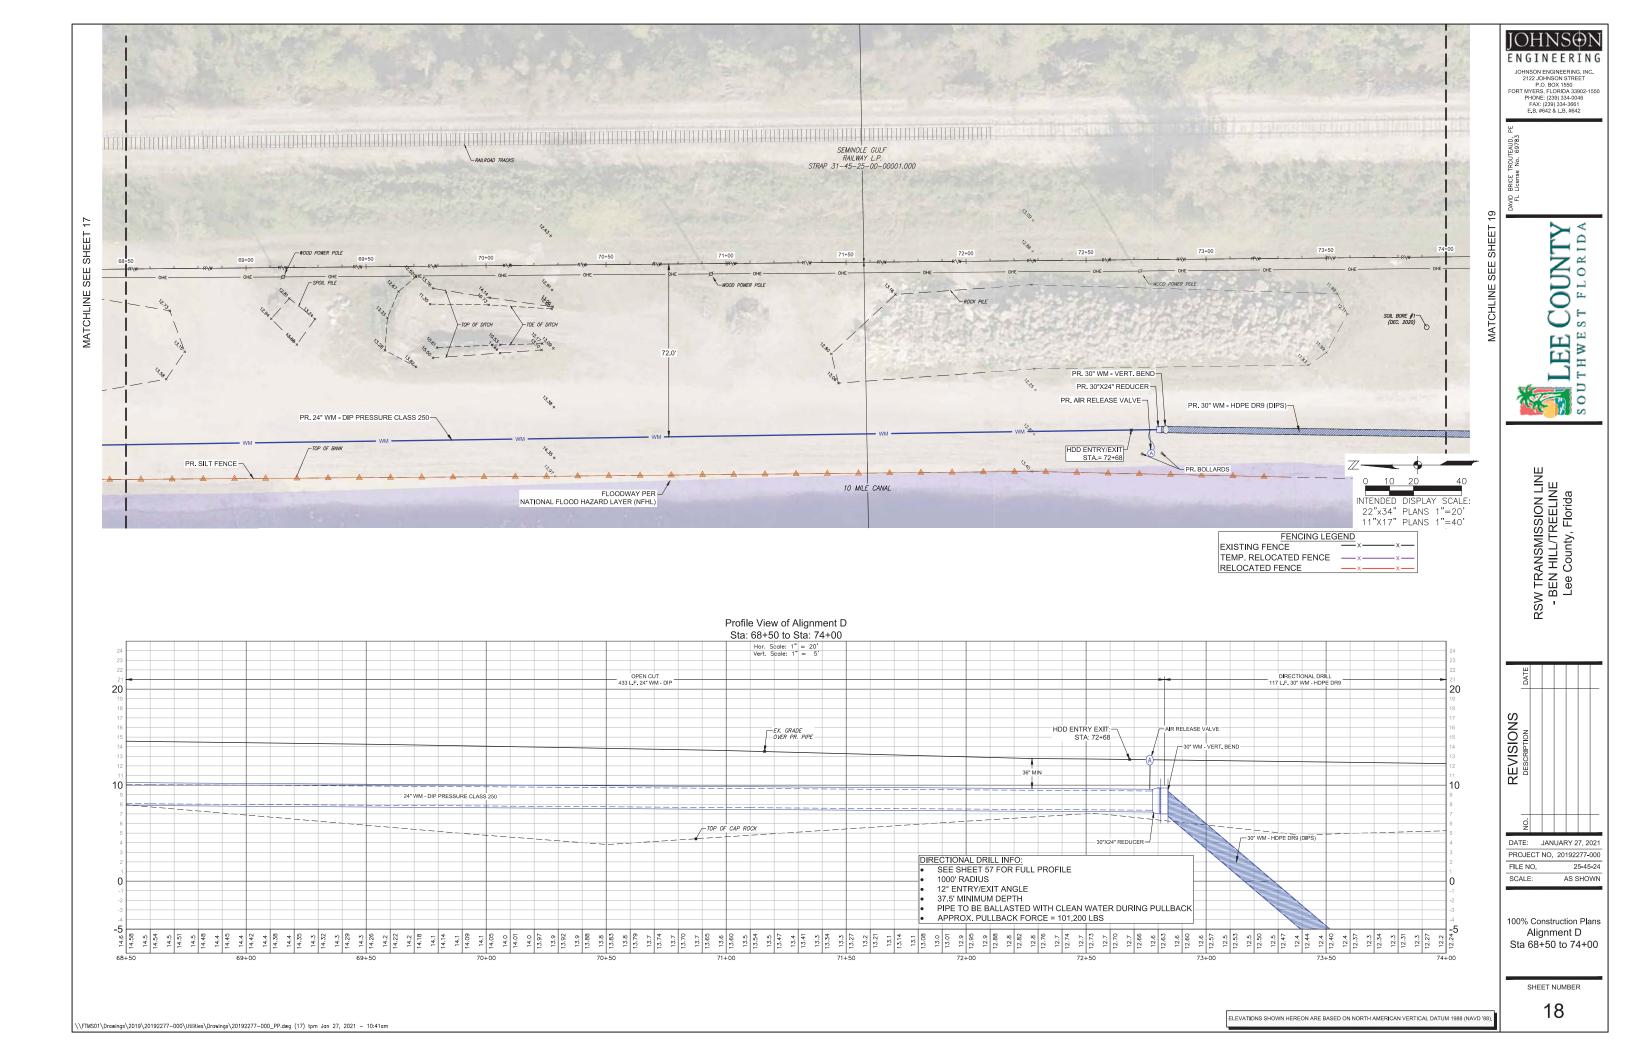


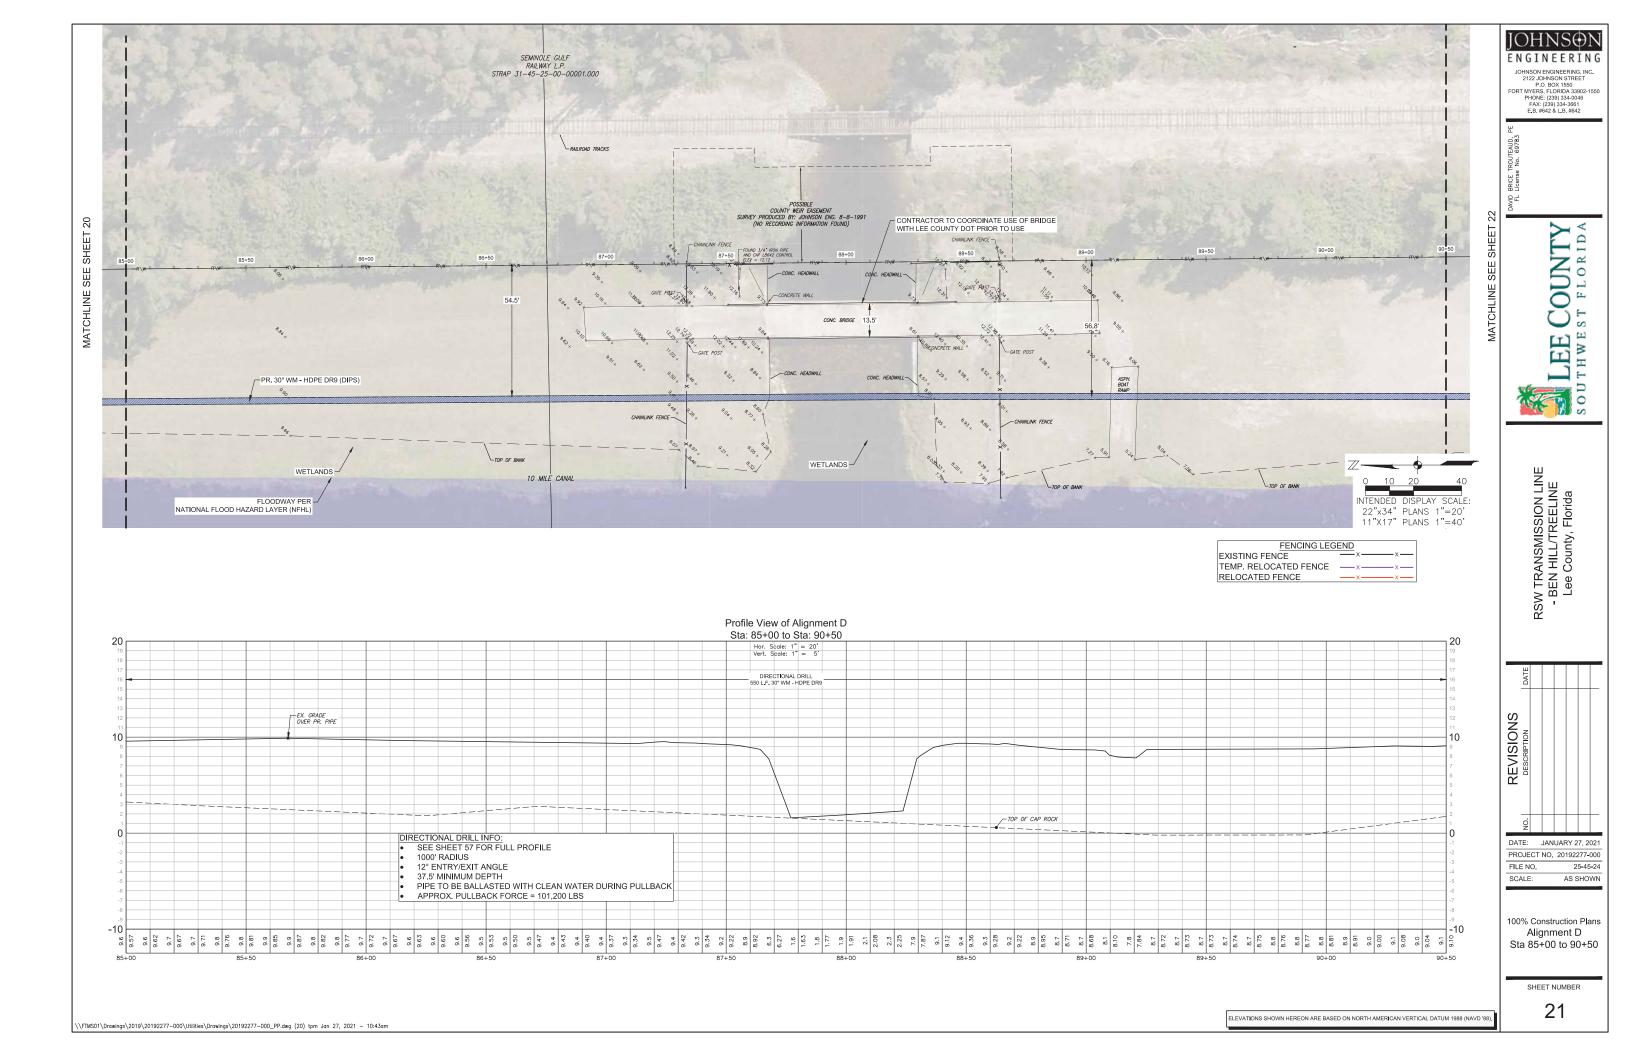


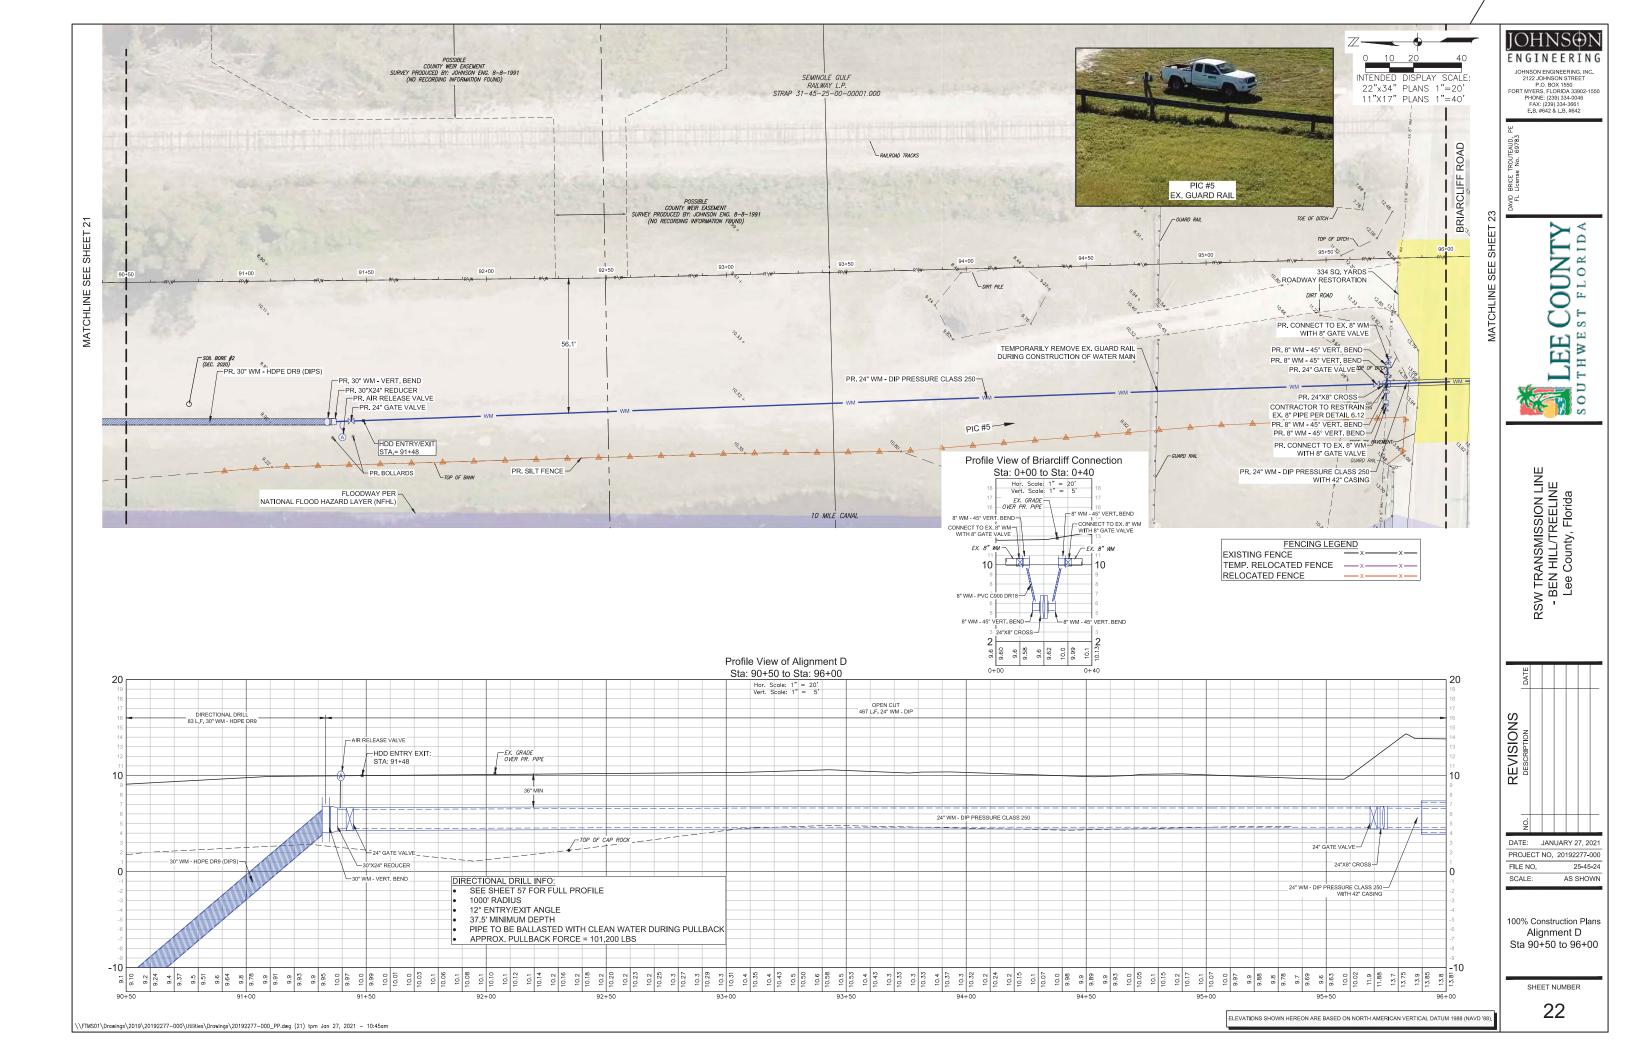


DATE: JANUARY 27, 2021

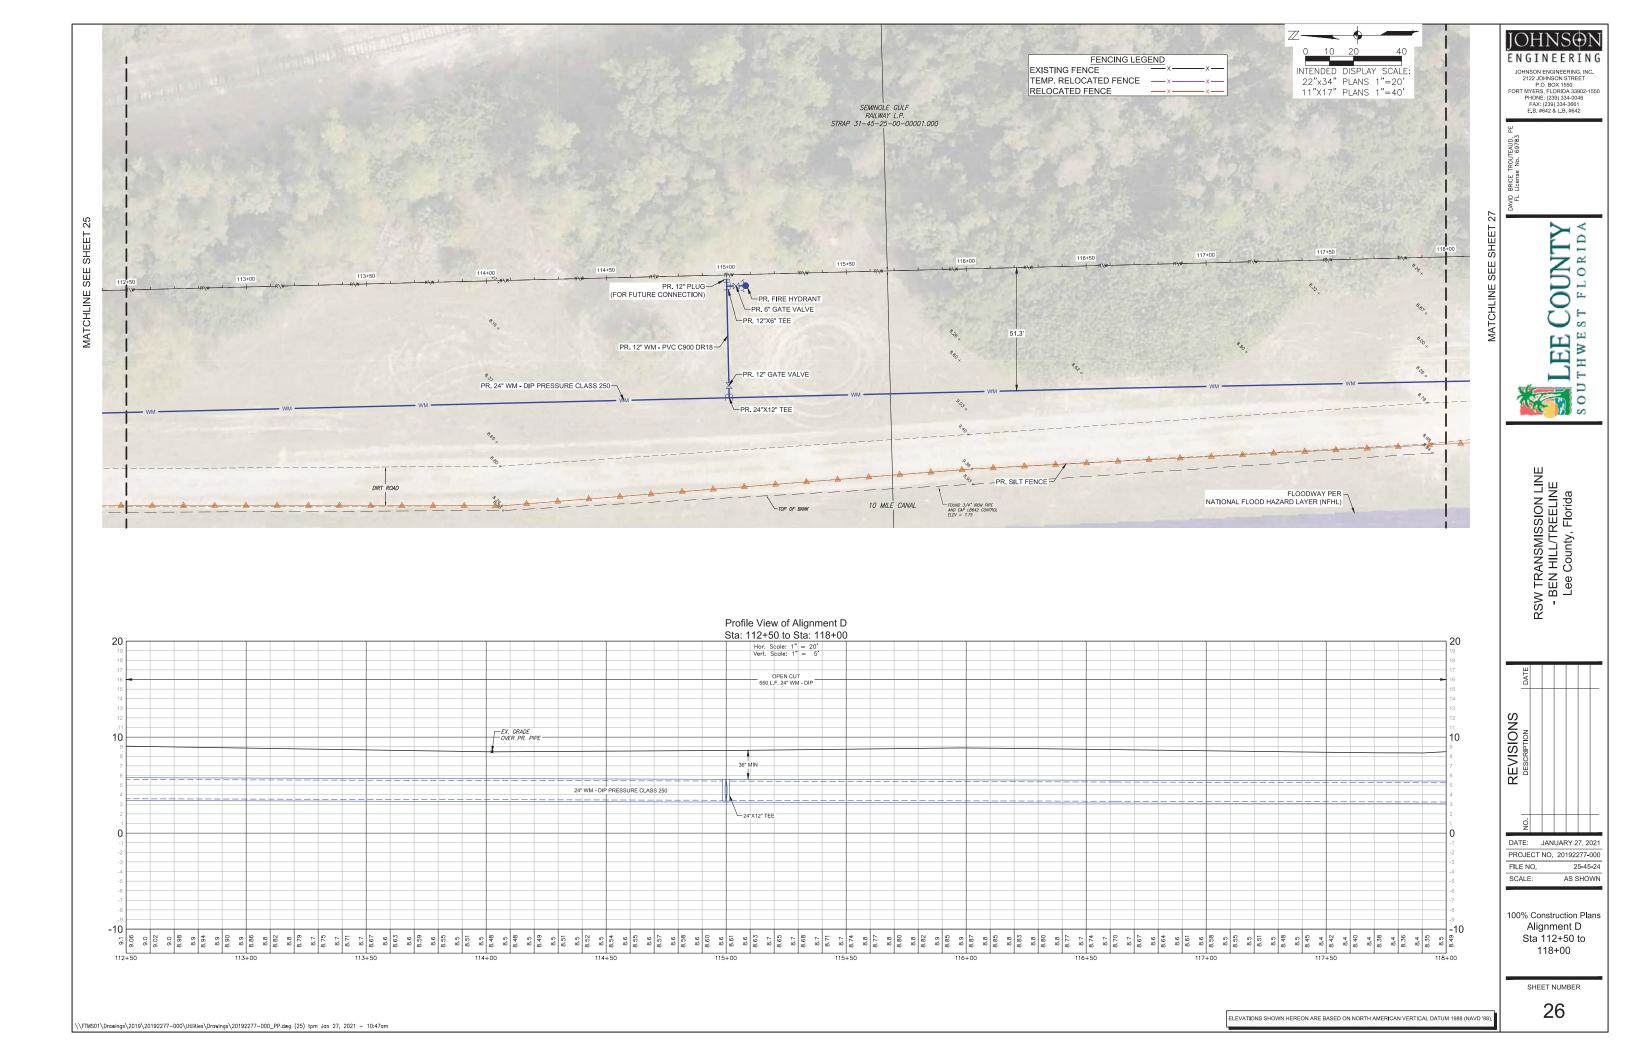


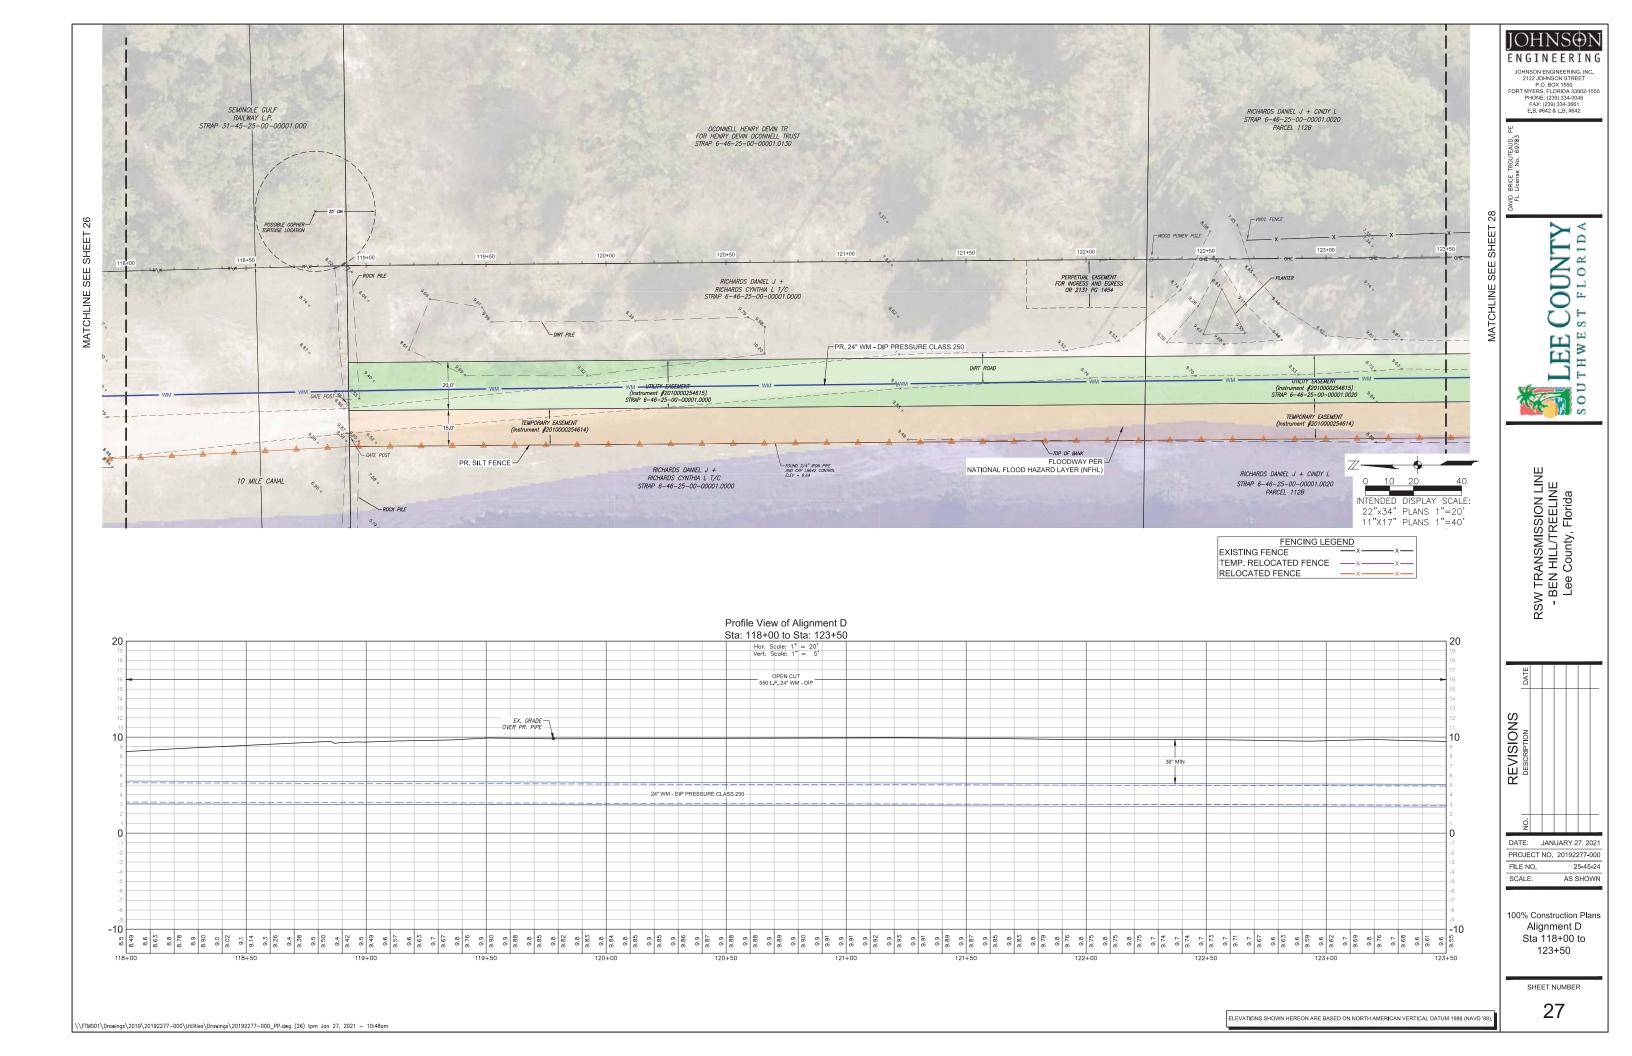

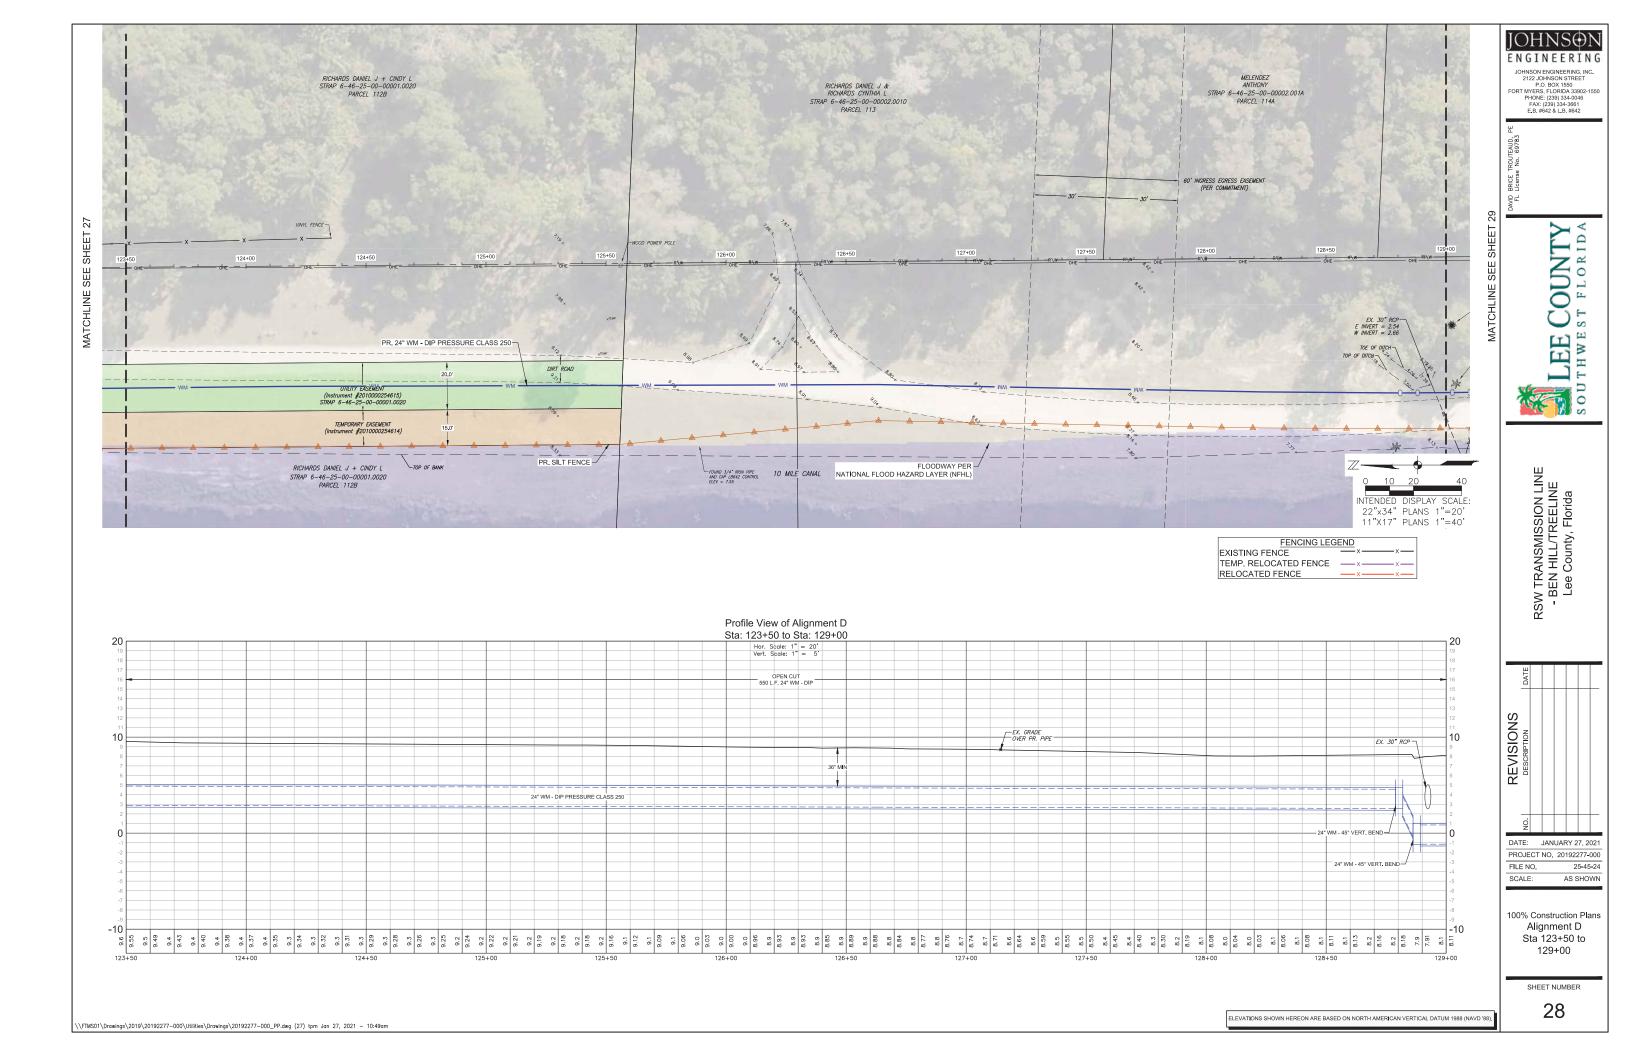

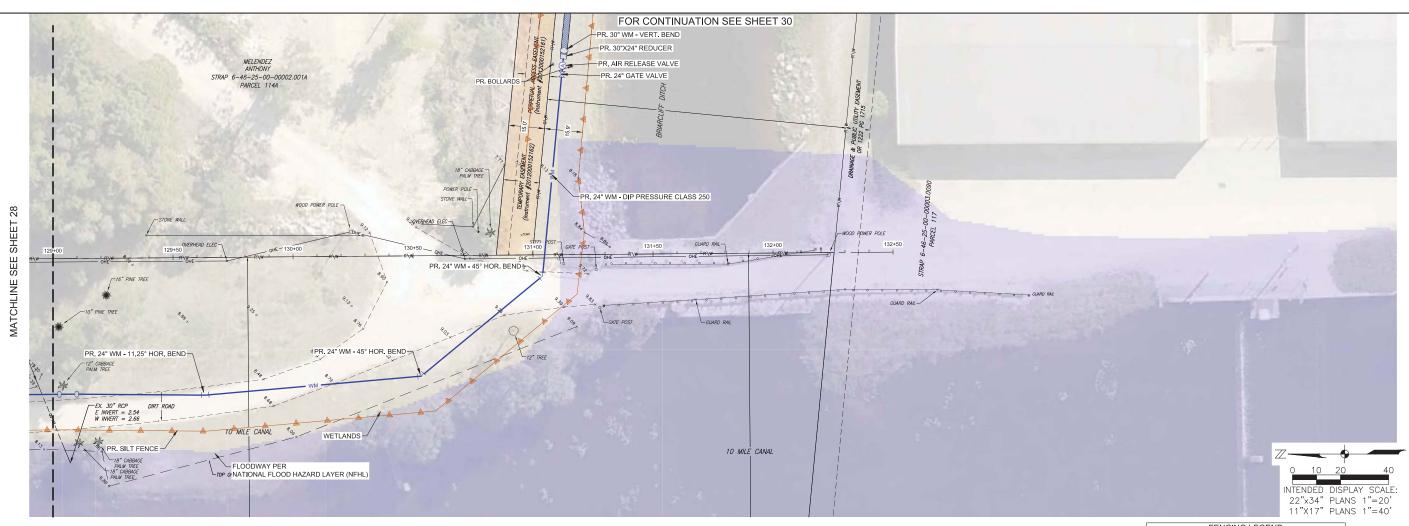



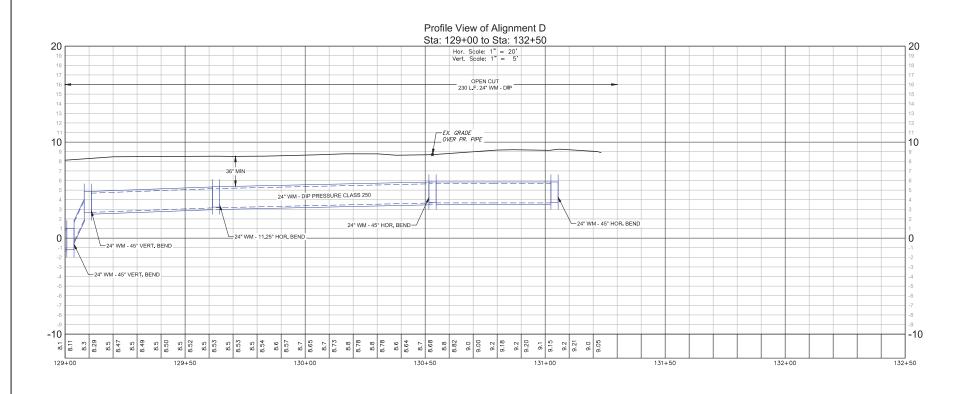

JOHNSON ENGINEERING, INC. 2122 JOHNSON STREET P.O. BOX 1550 FORT MYERS, FLORIDA 33902-1550 PHONE: (239) 334-0046 FAX: (239) 334-3661 E.B. #642 & L.B. #642

TROUTEAUD, No. 69783

LEE COUNTY SOUTHWEST FLORIDA

RSW TRANSMISSION LINE
- BEN HILL/TREELINE
Lee County, Florida





PROJECT NO. 20192277-000 FILE NO. 25-45-24


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100% Construction Plans Alignment D Sta 129+00 to 132+50

SHEET NUMBER




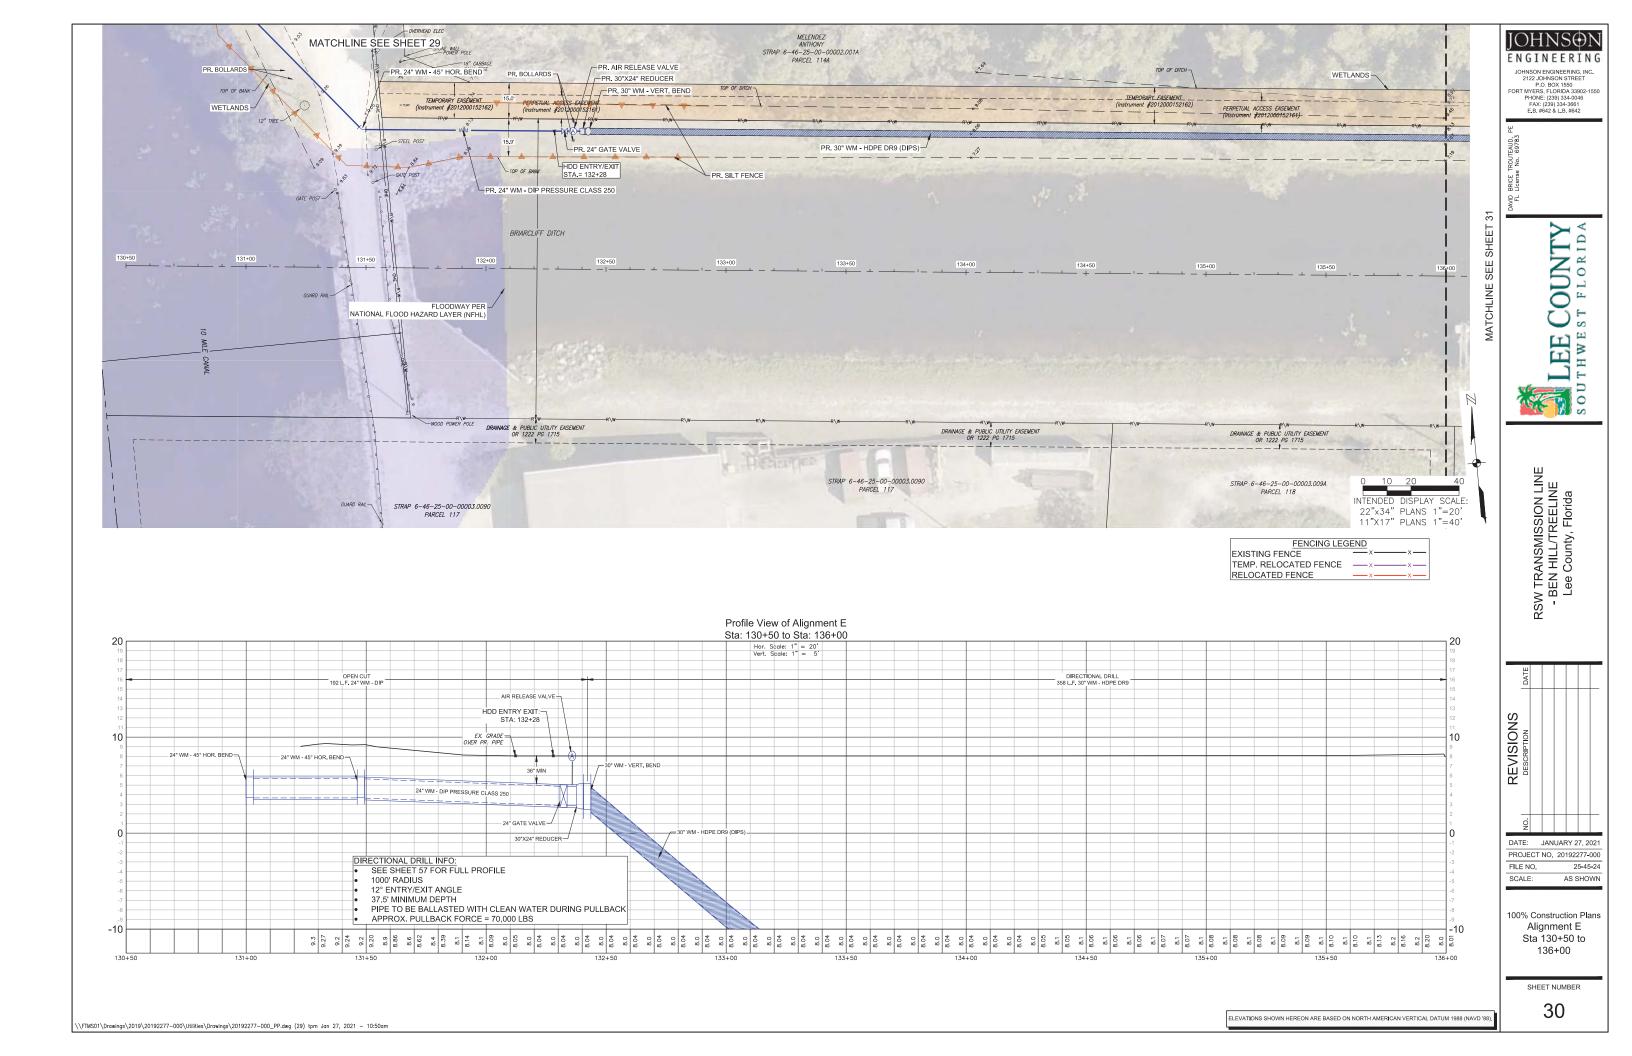


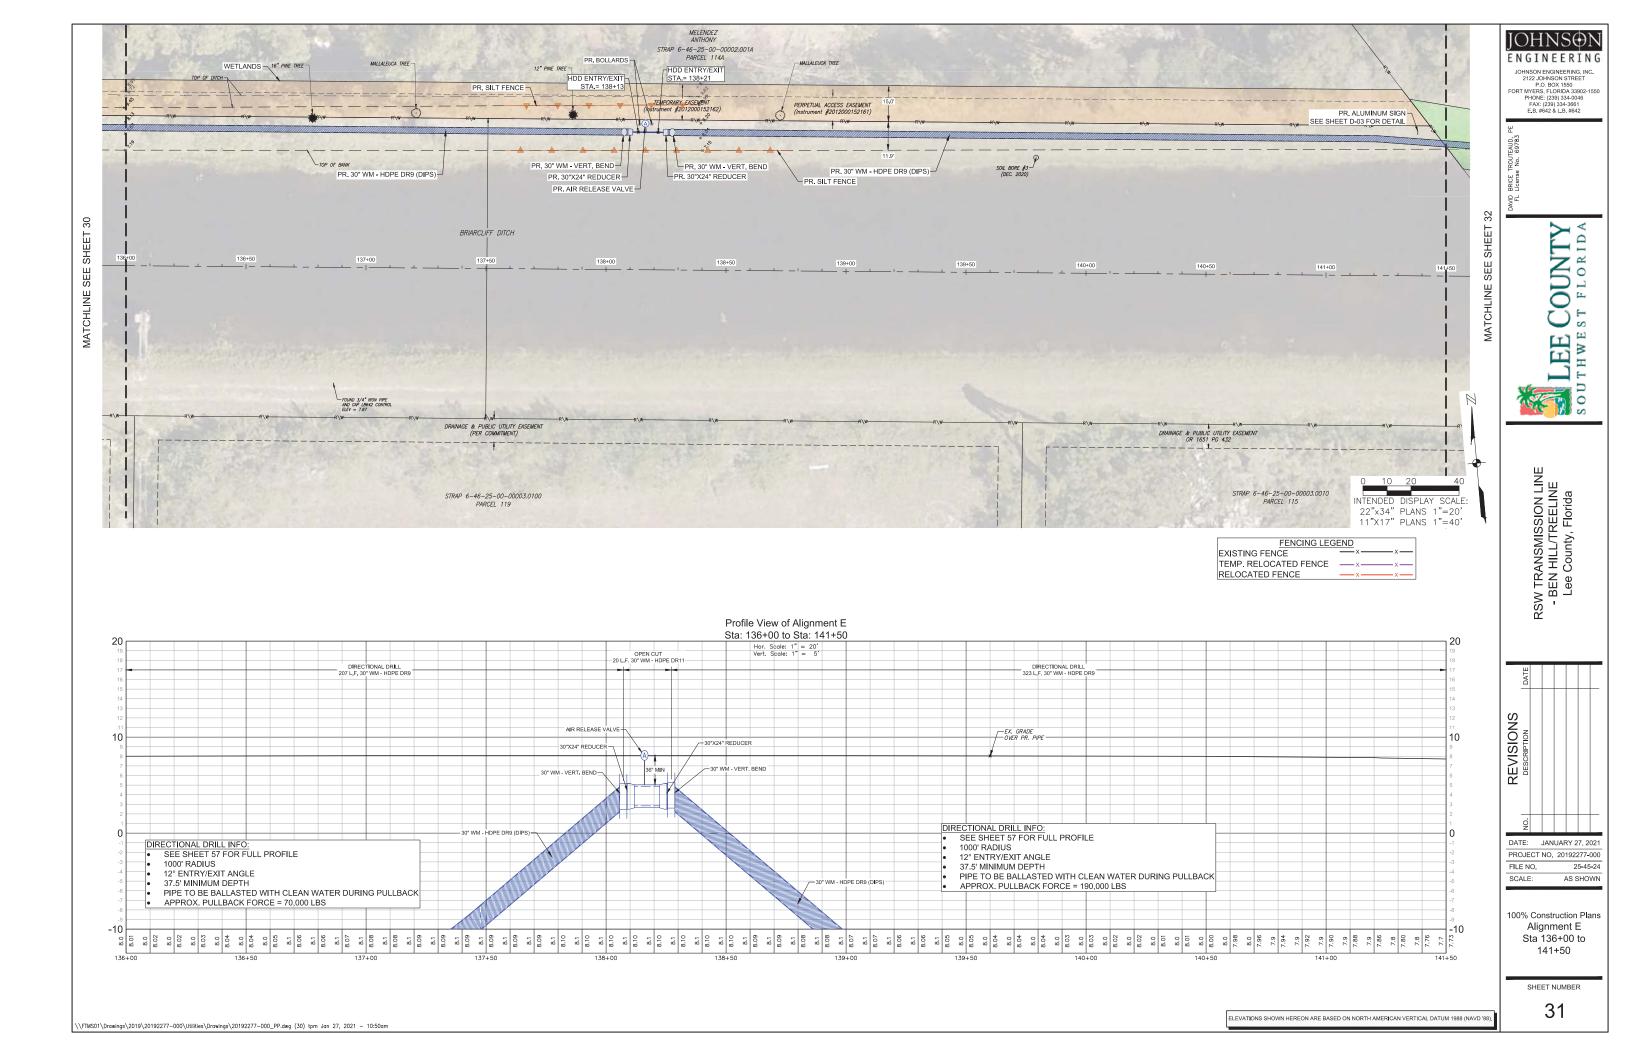


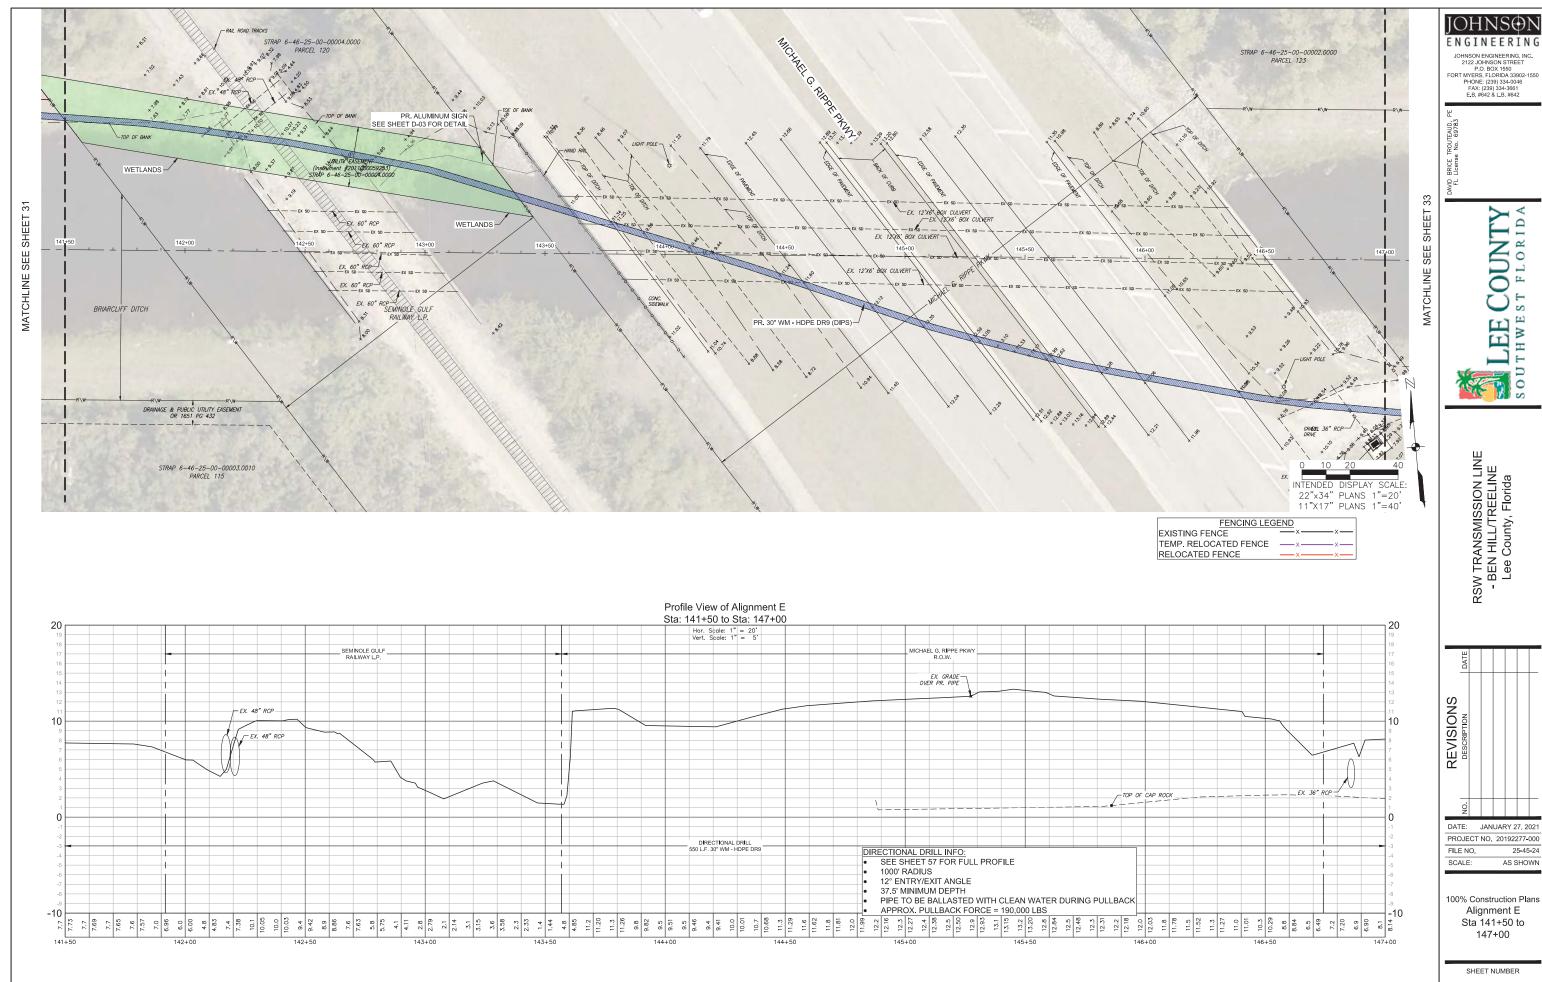\FTMS01\Drawings\2019\20192277-000\Utilities\Drawings\20192277-000\_PP.dwg (31) tpm Jan 27, 2021 - 10:51am

ELEVATIONS SHOWN HEREON ARE BASED ON NORTH AMERICAN VERTICAL DATUM 1988 (NAVD '88).

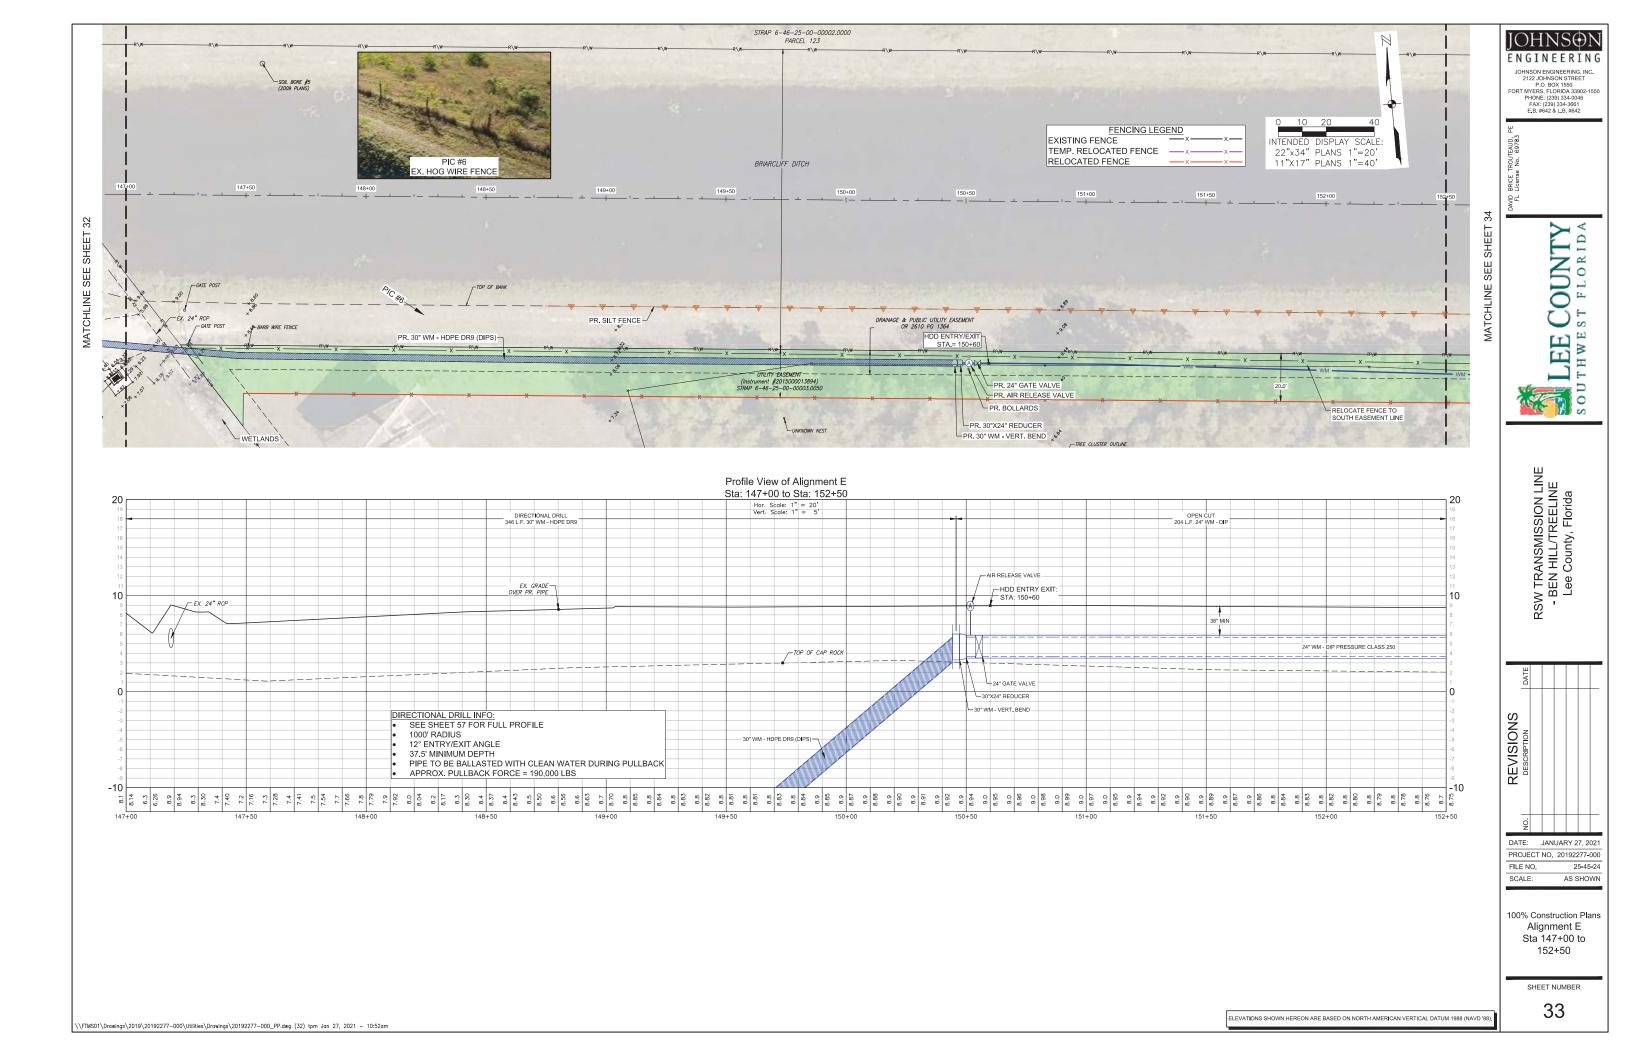

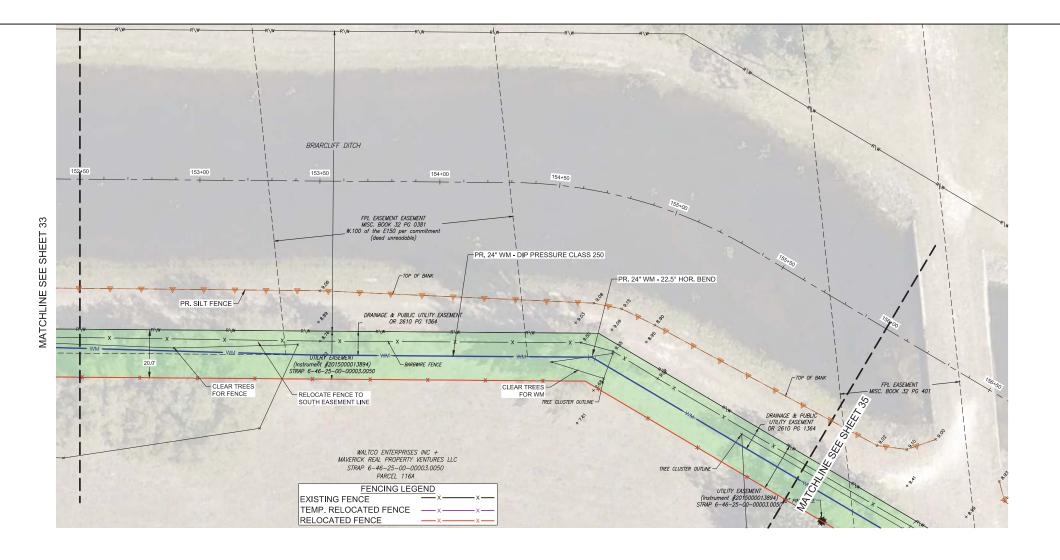

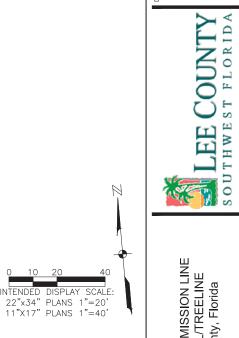

RSW TRANSMISSION LINE - BEN HILL/TREELINE Lee County, Florida

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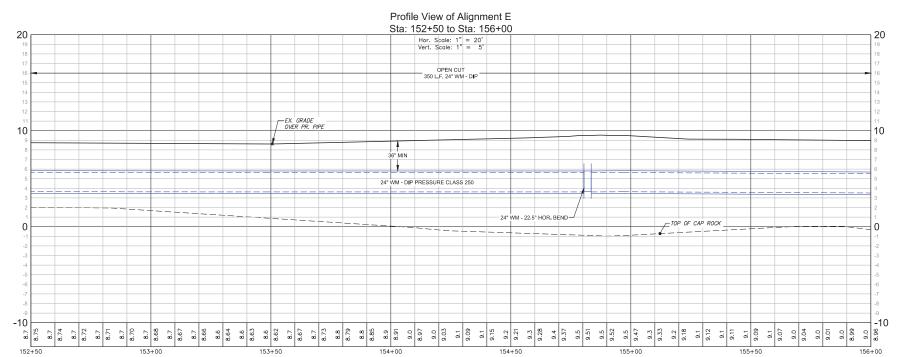



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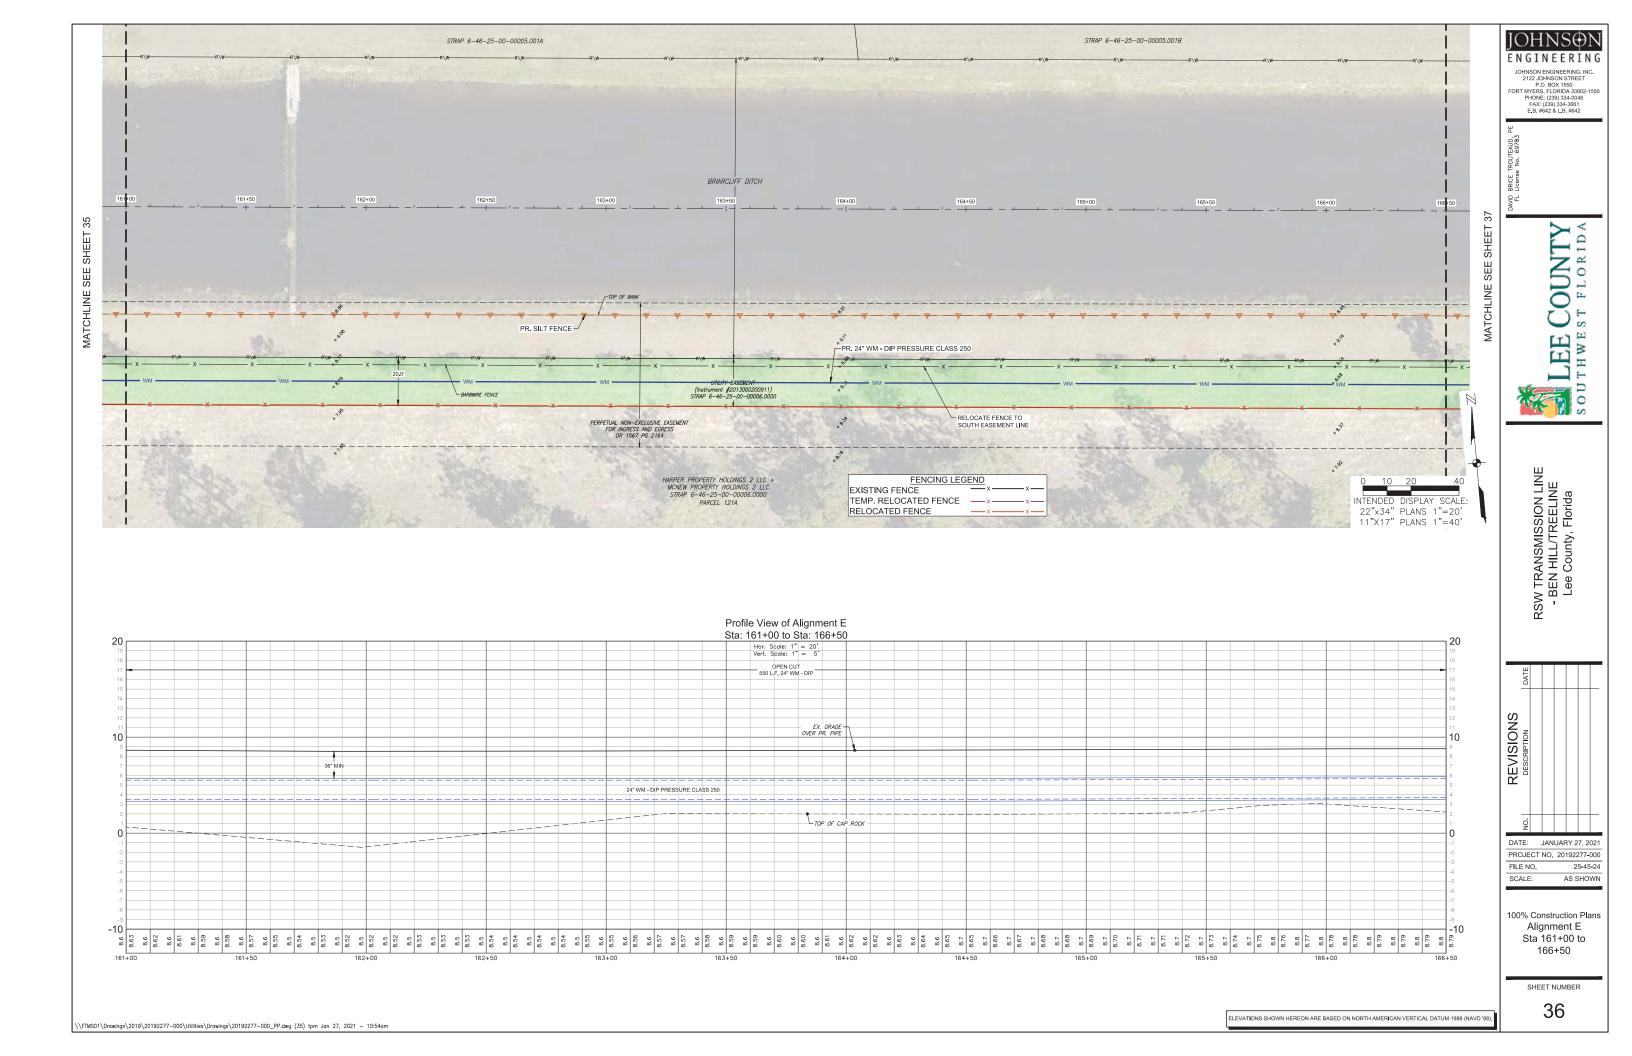
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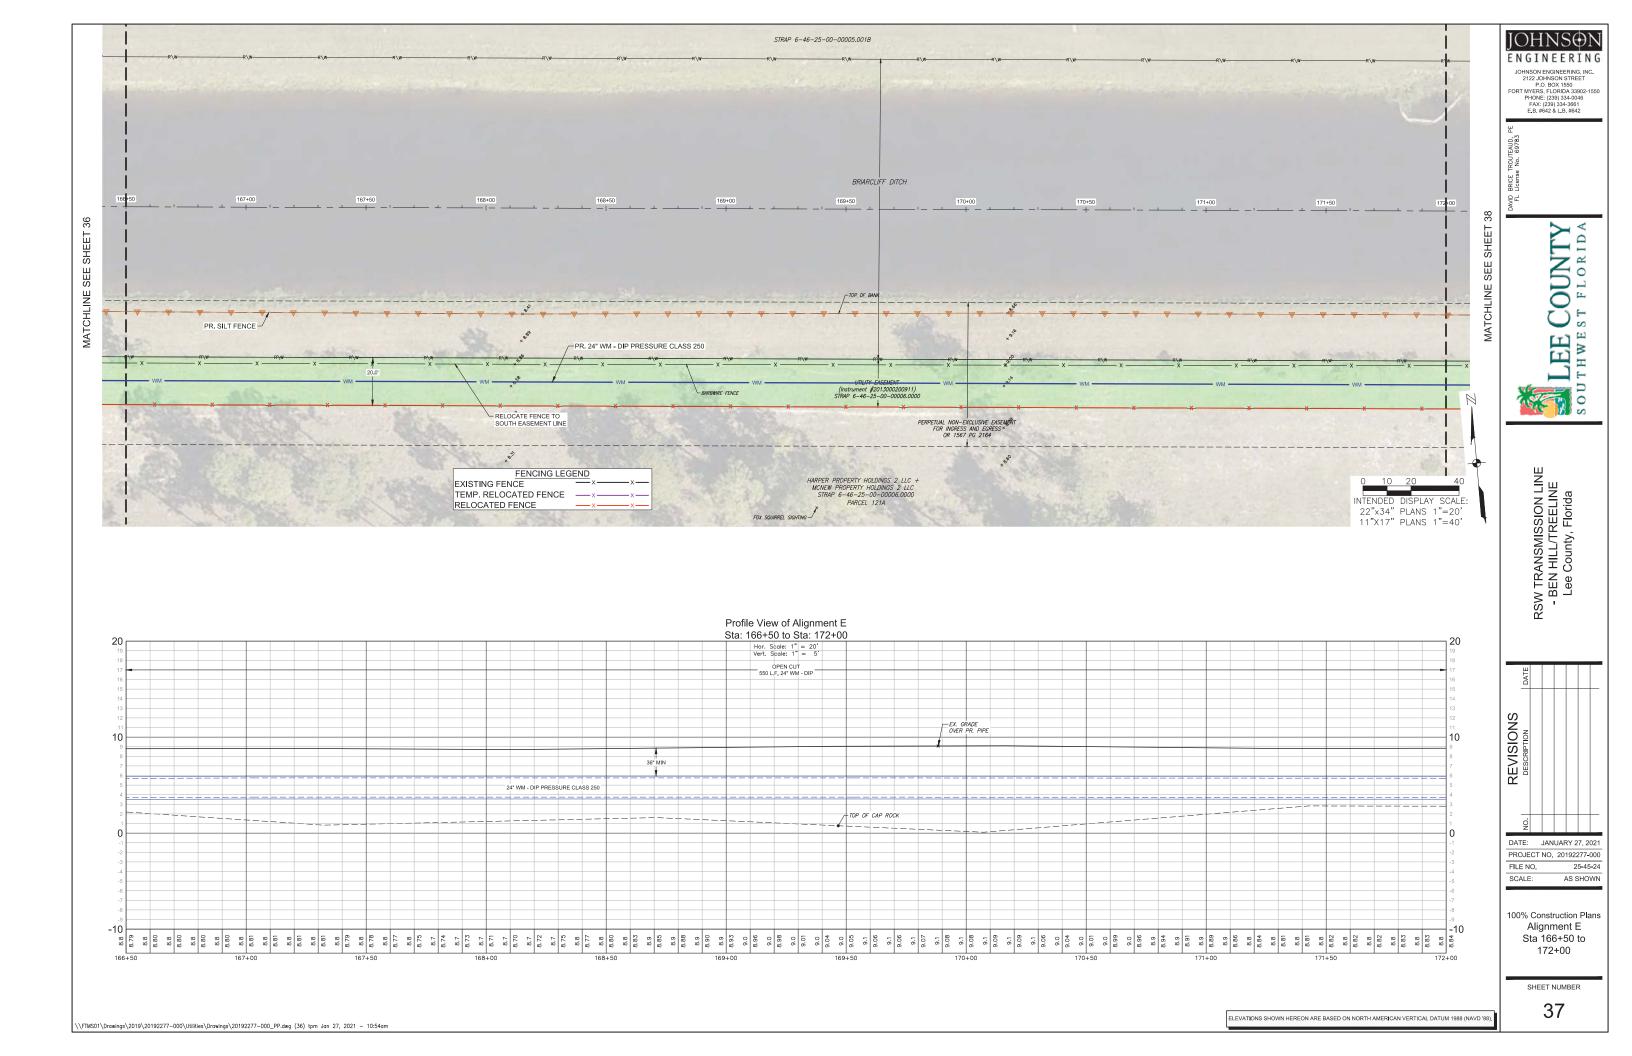
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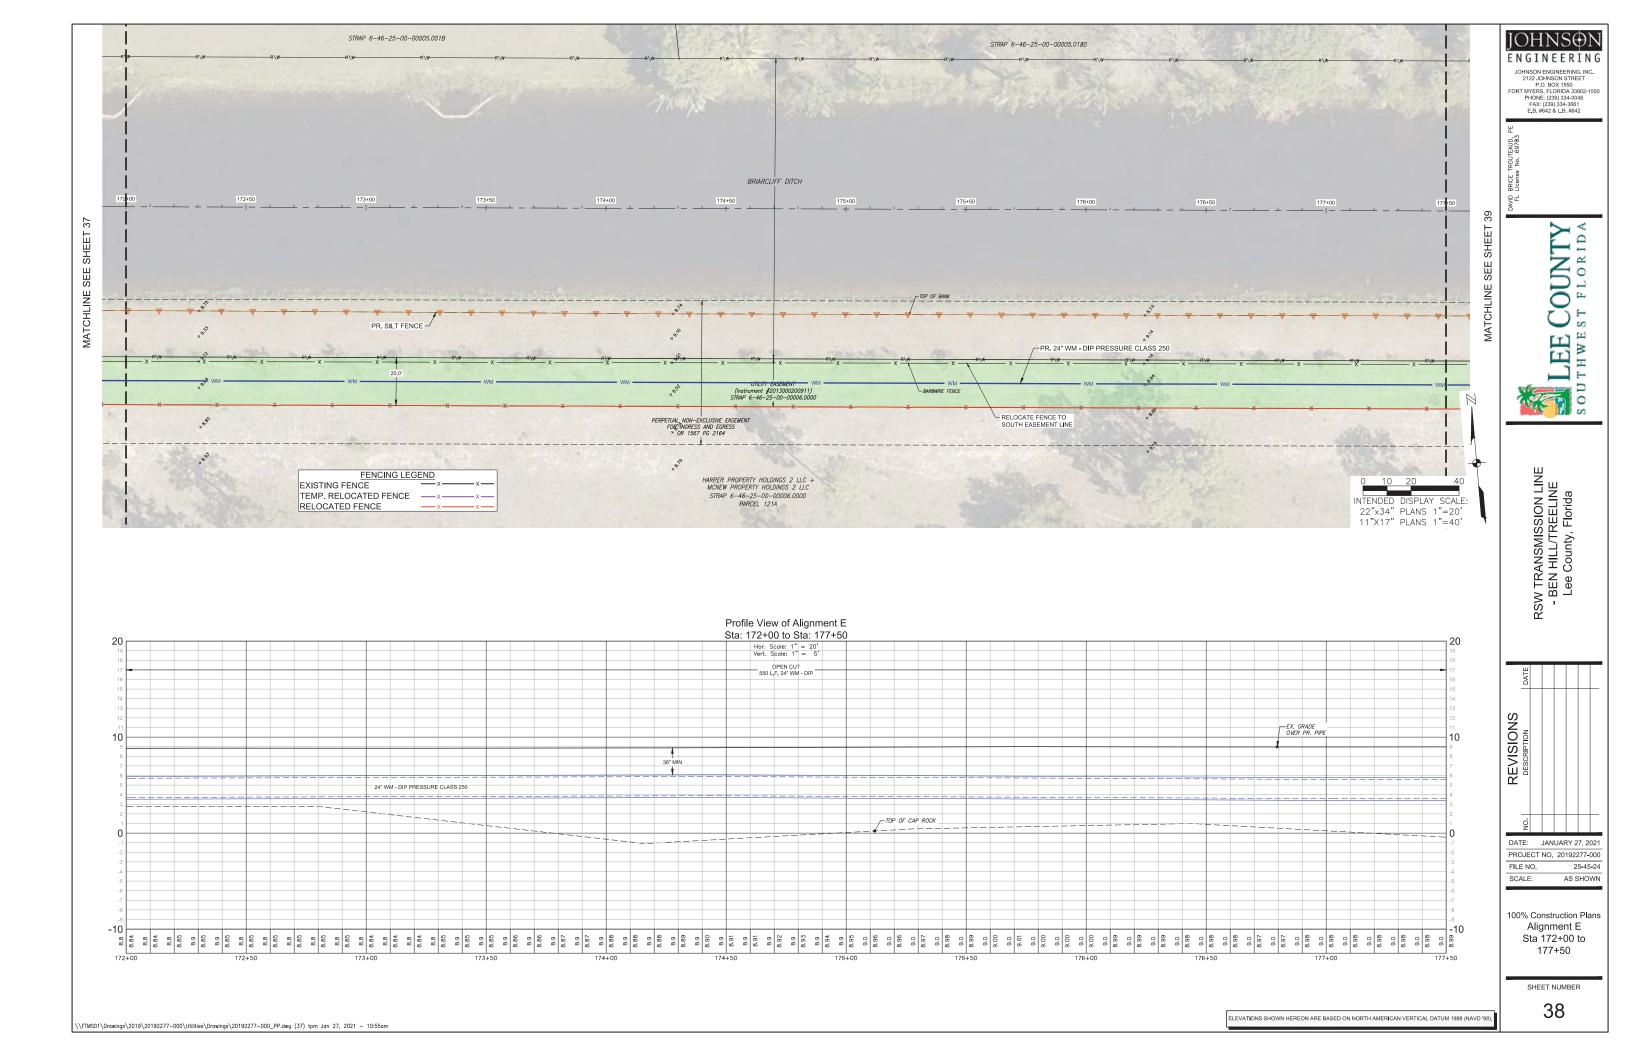
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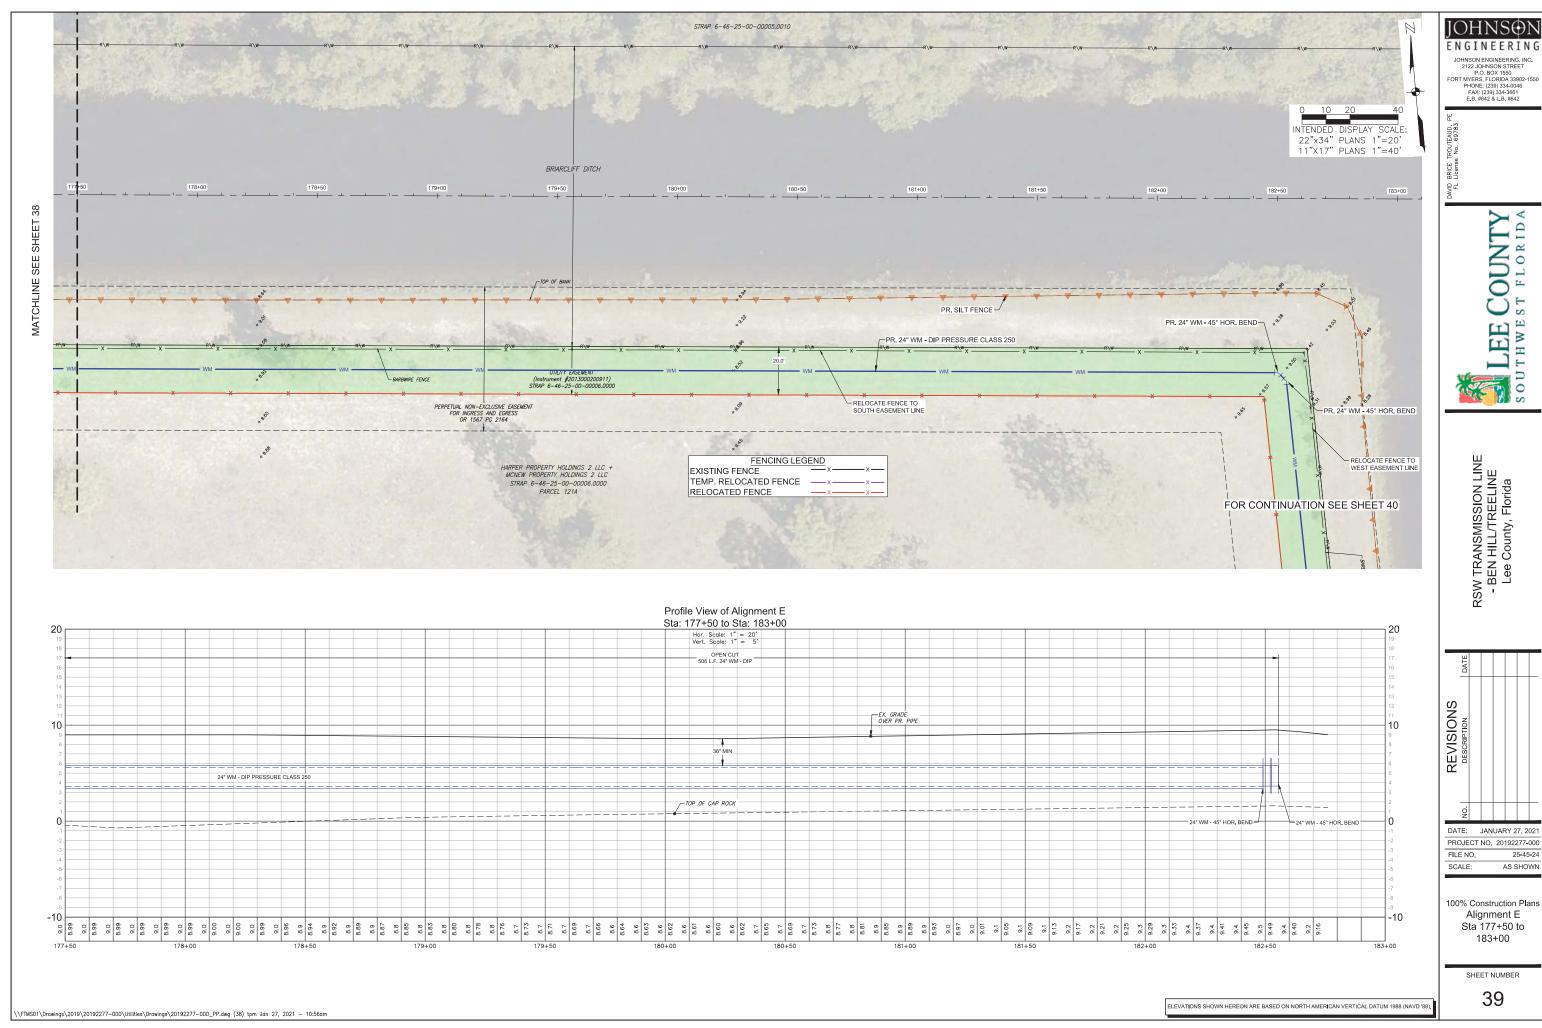












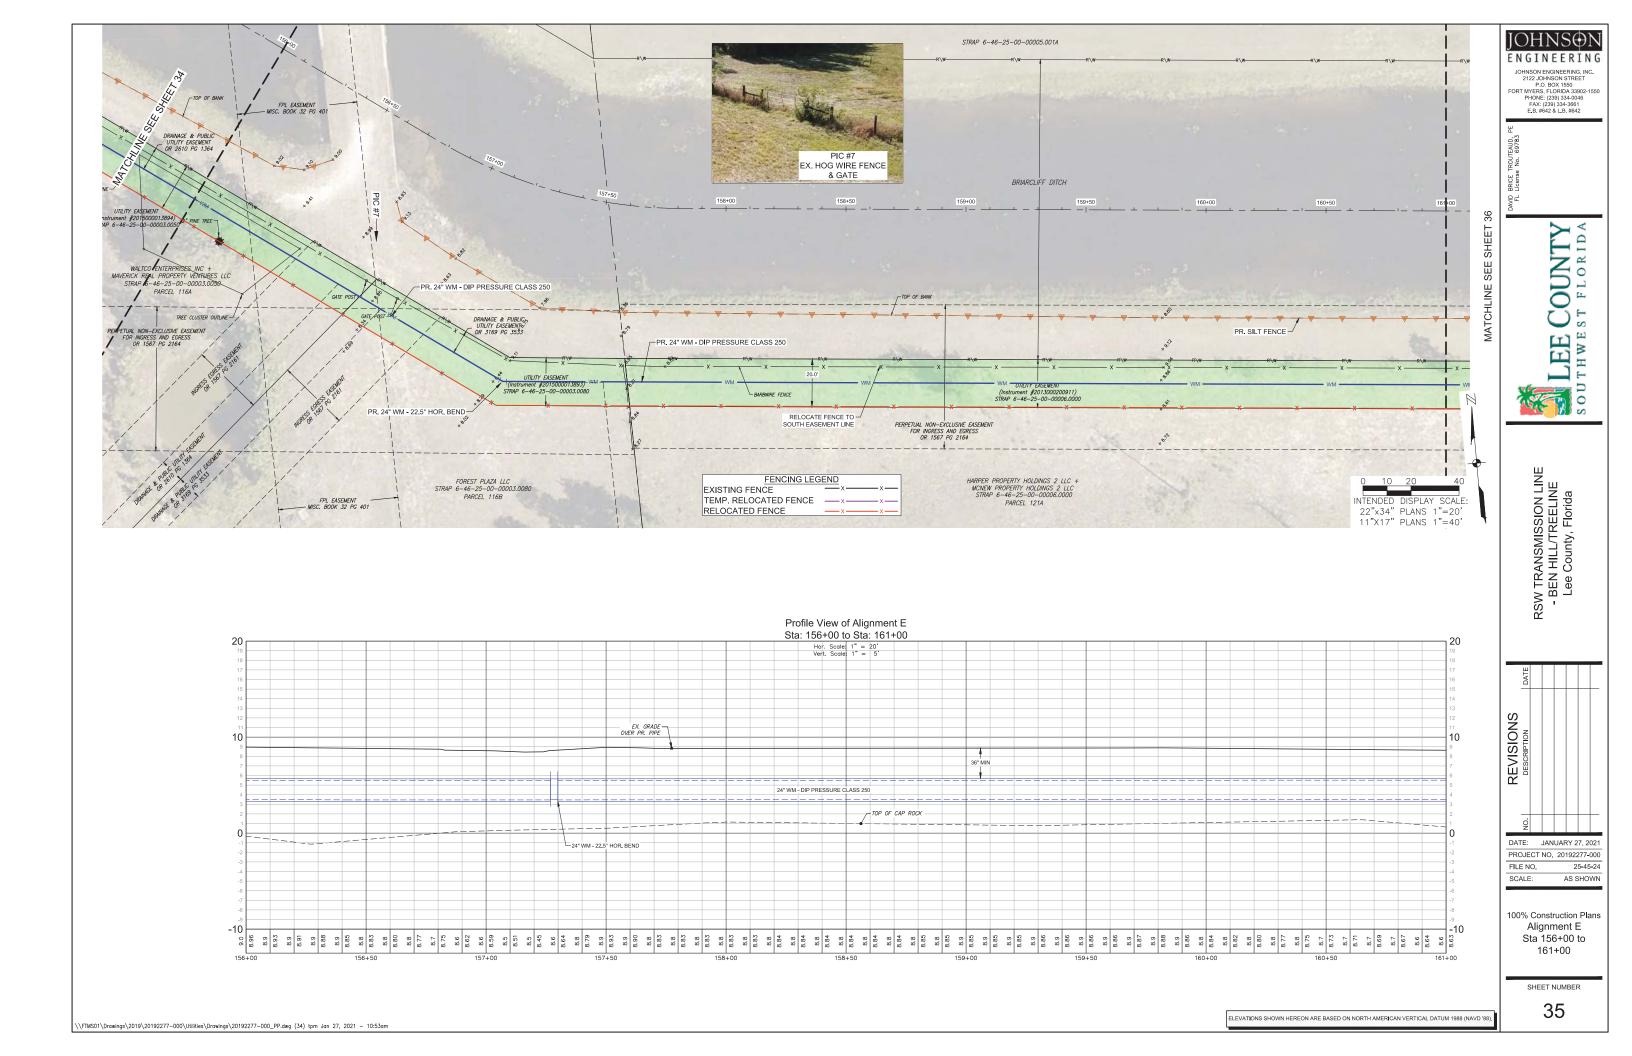



25-45-24

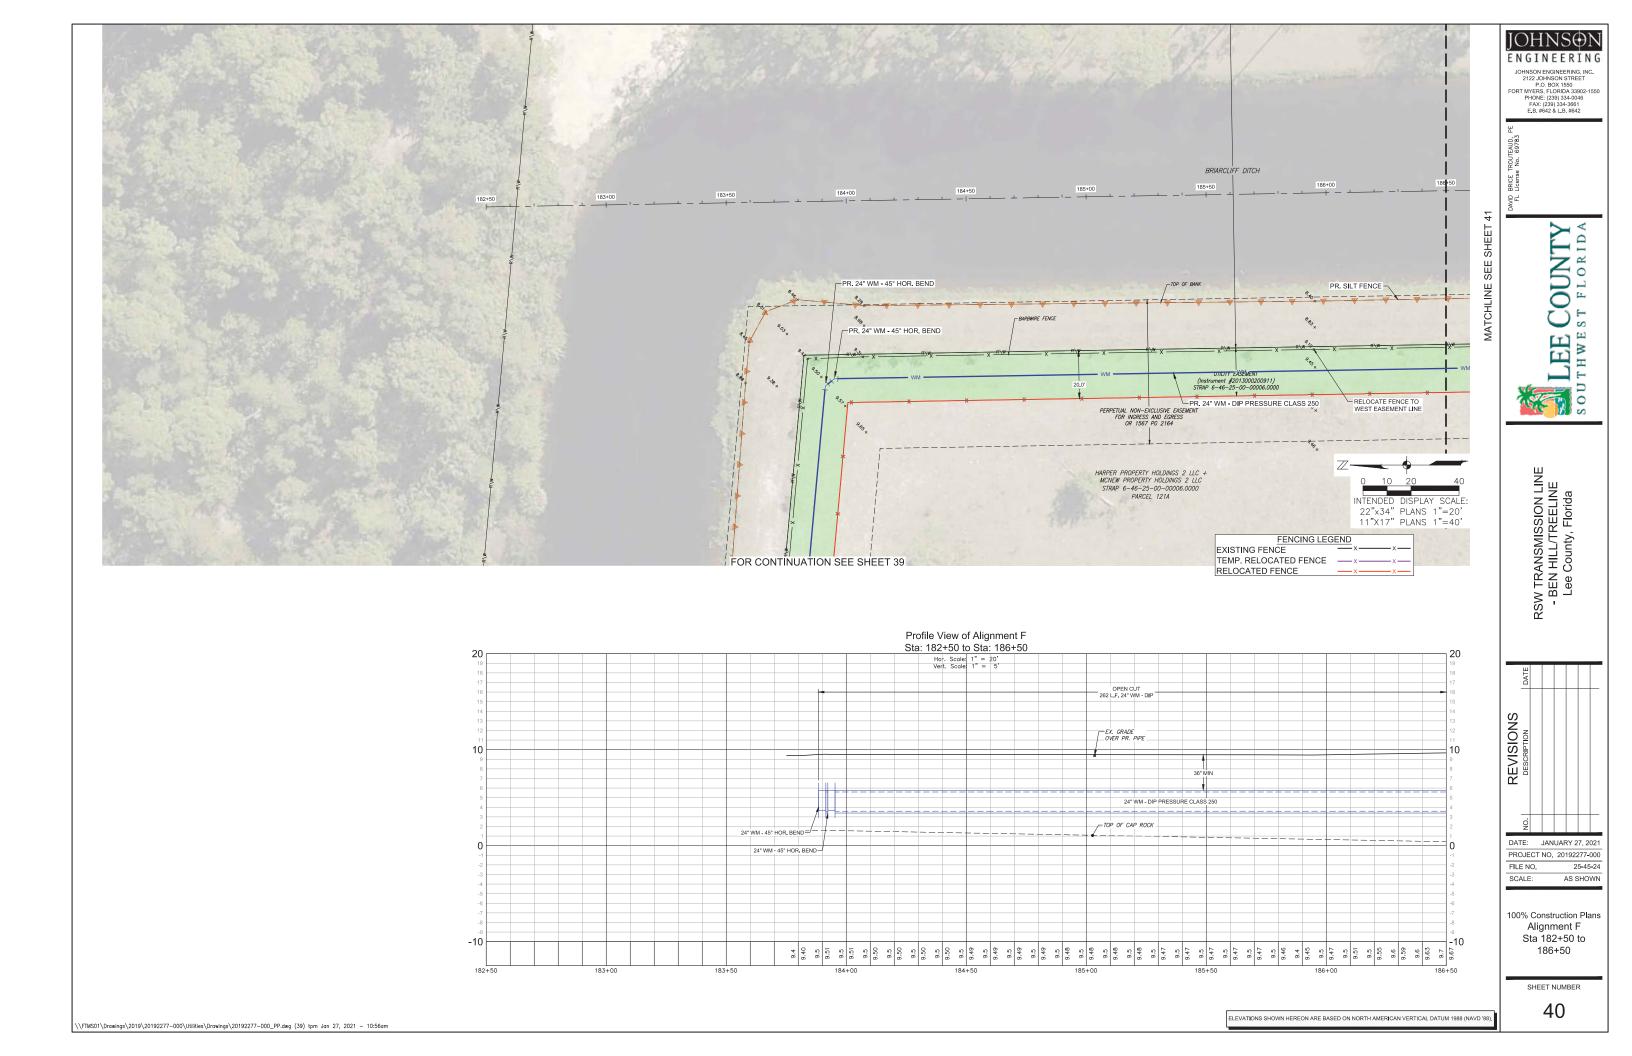

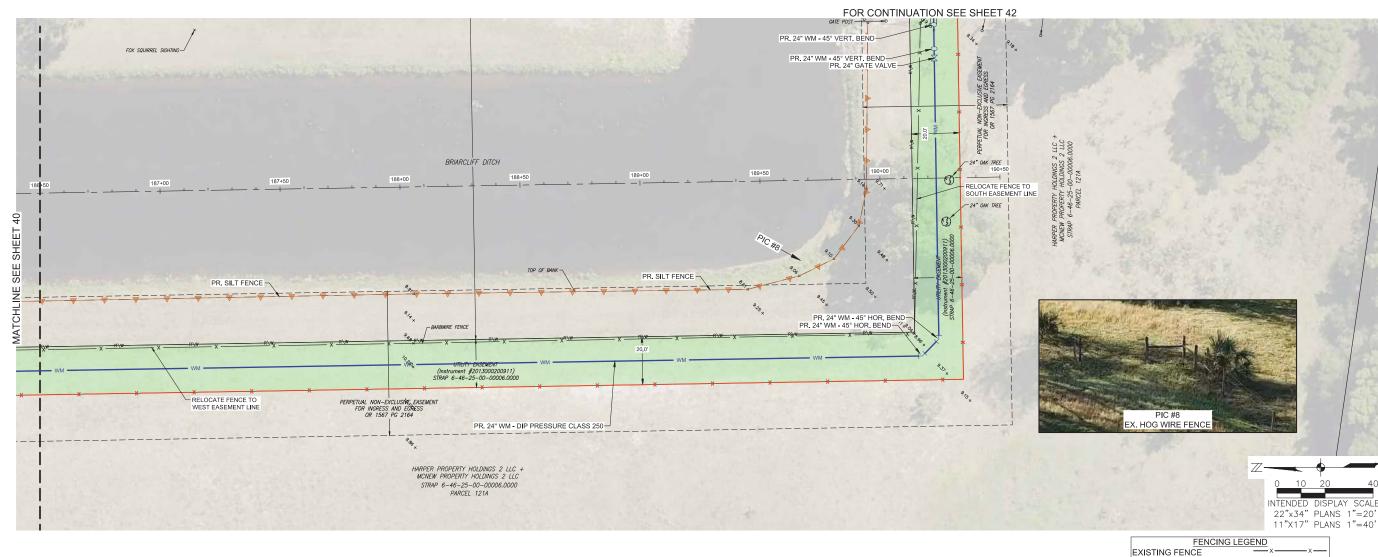



24" WM - 45° HOR, BEND

-10

24" WM - 45° HOR. BEND-

Profile View of Alignment F Sta: 186+50 to Sta: 190+50

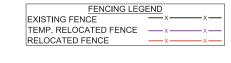

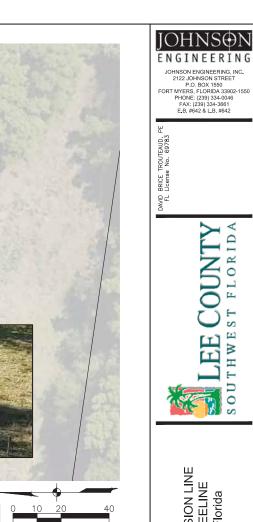

RSW TRANSMISSION LINE
- BEN HILL/TREELINE
Lee County, Florida

LEE COUNTY SOUTHWEST FLORIDA




PROJECT NO. 20192277-000 FILE NO. 25-45-24

SCALE: AS SHOWN

100% Construction Plans Alignment F Sta 186+50 to 190+50

SHEET NUMBER

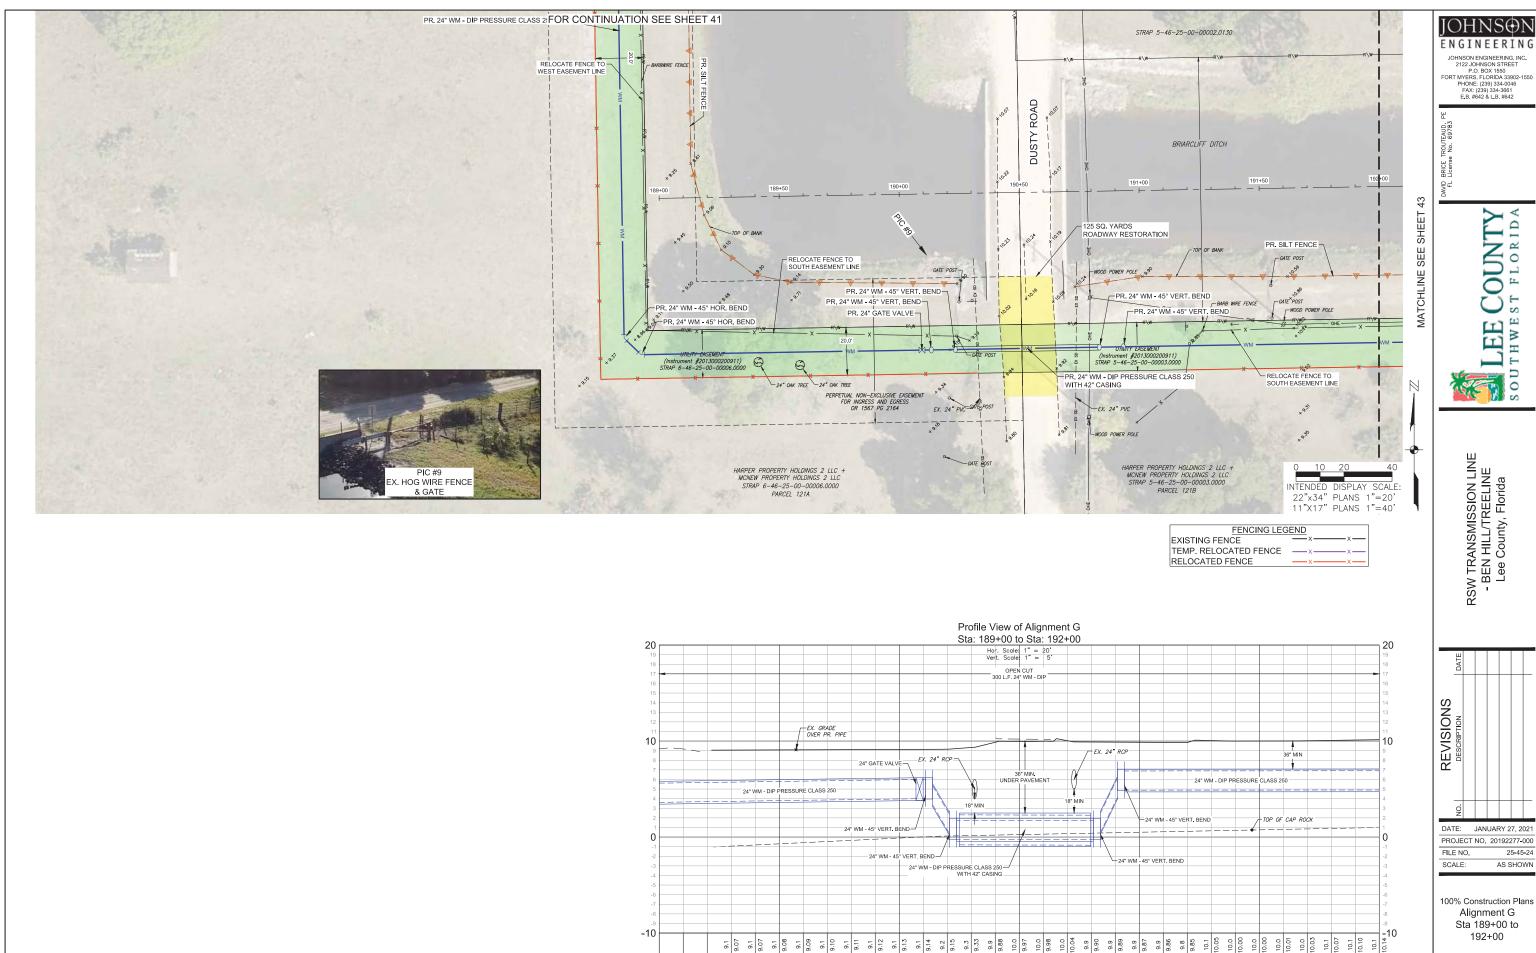

OUNTY FLORIDA





PROJECT NO. 20192277-000


25-45-24 AS SHOWN


100% Construction Plans Alignment G Sta 189+00 to


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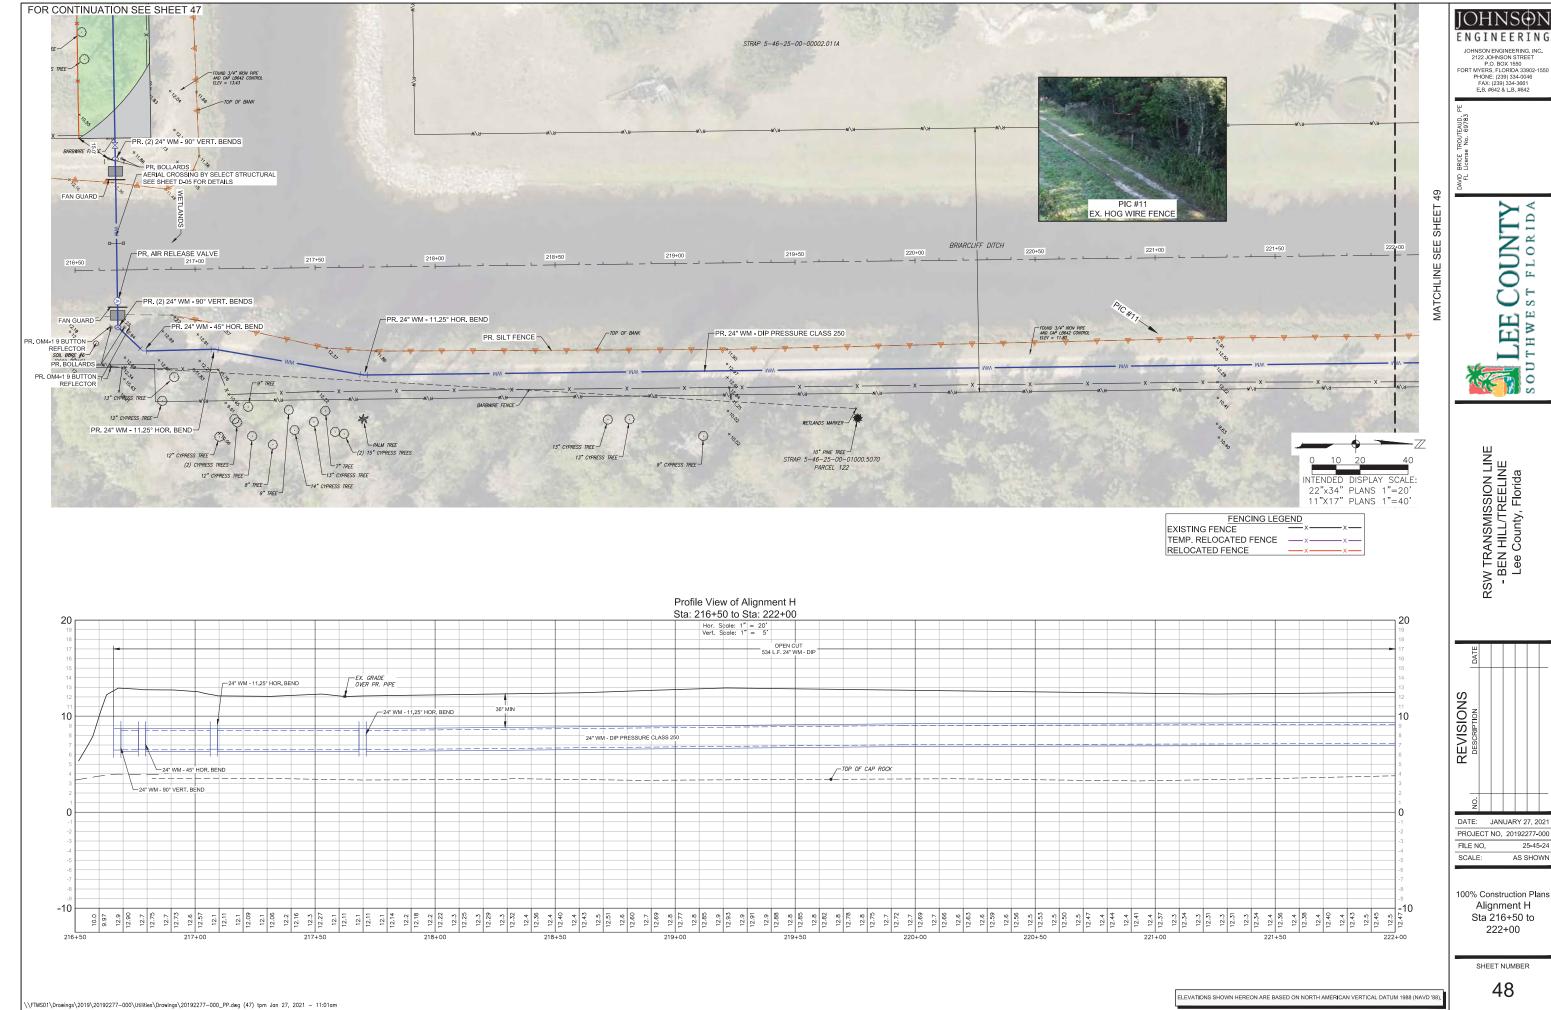
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DATE: JANUARY 27, 2021

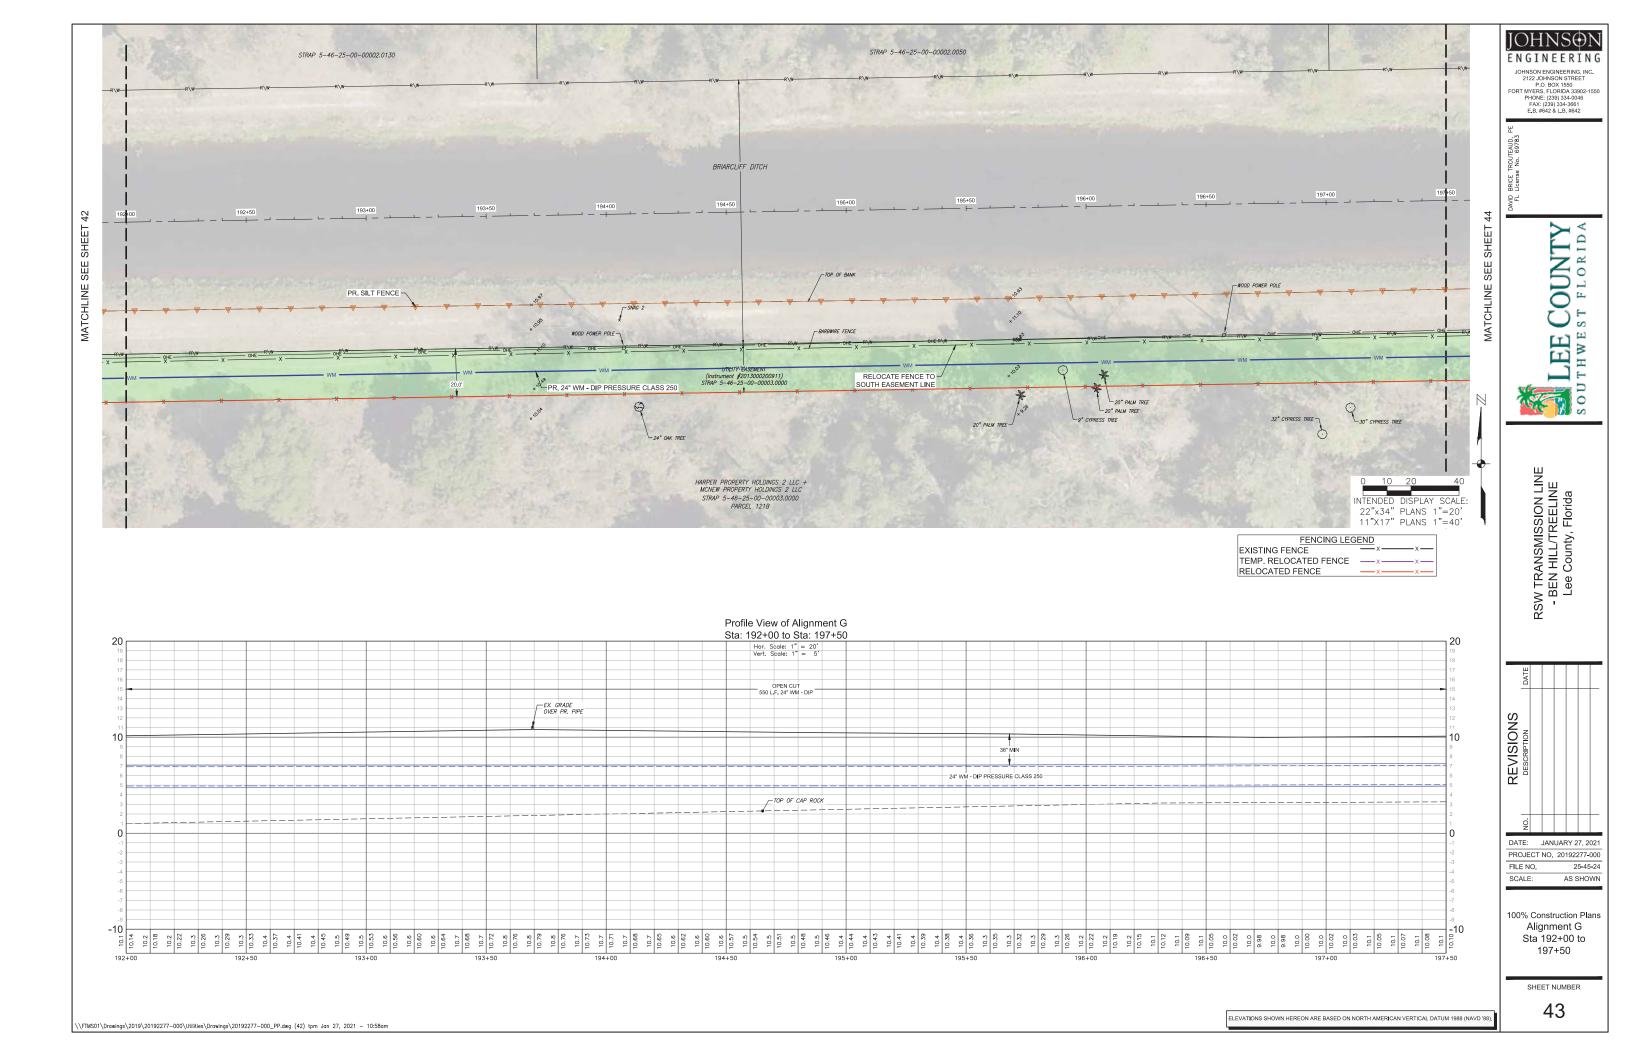PROJECT NO. 20192277-000 25-45-24

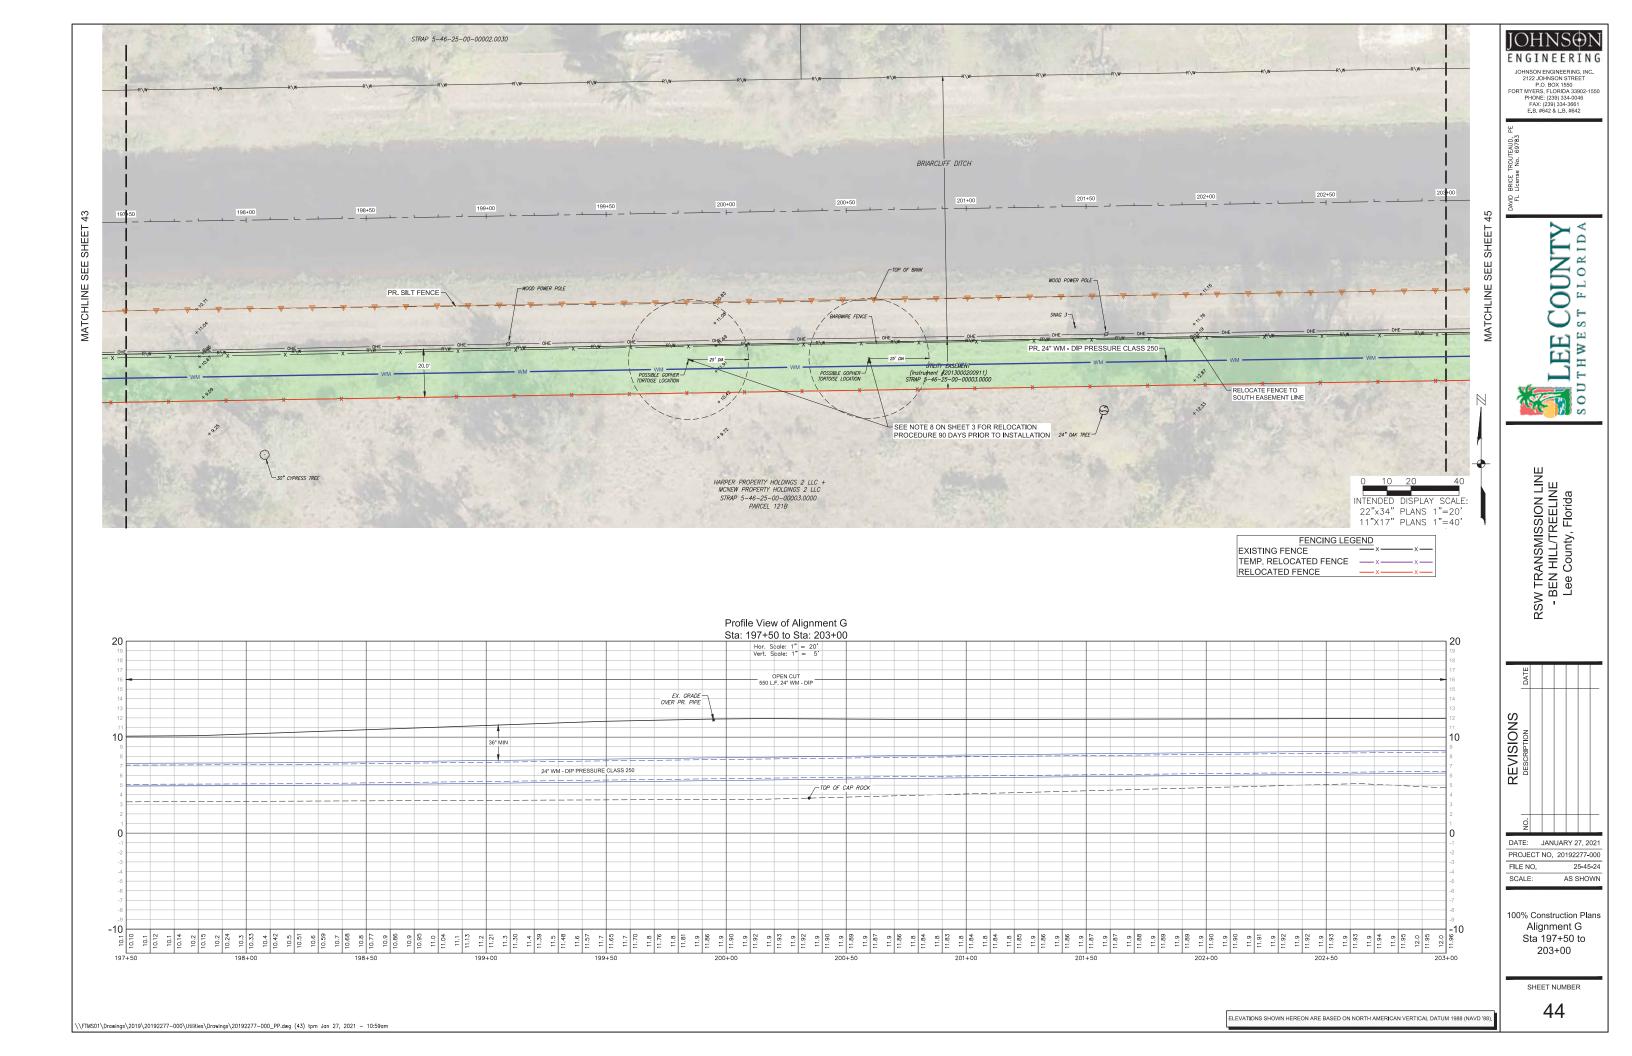
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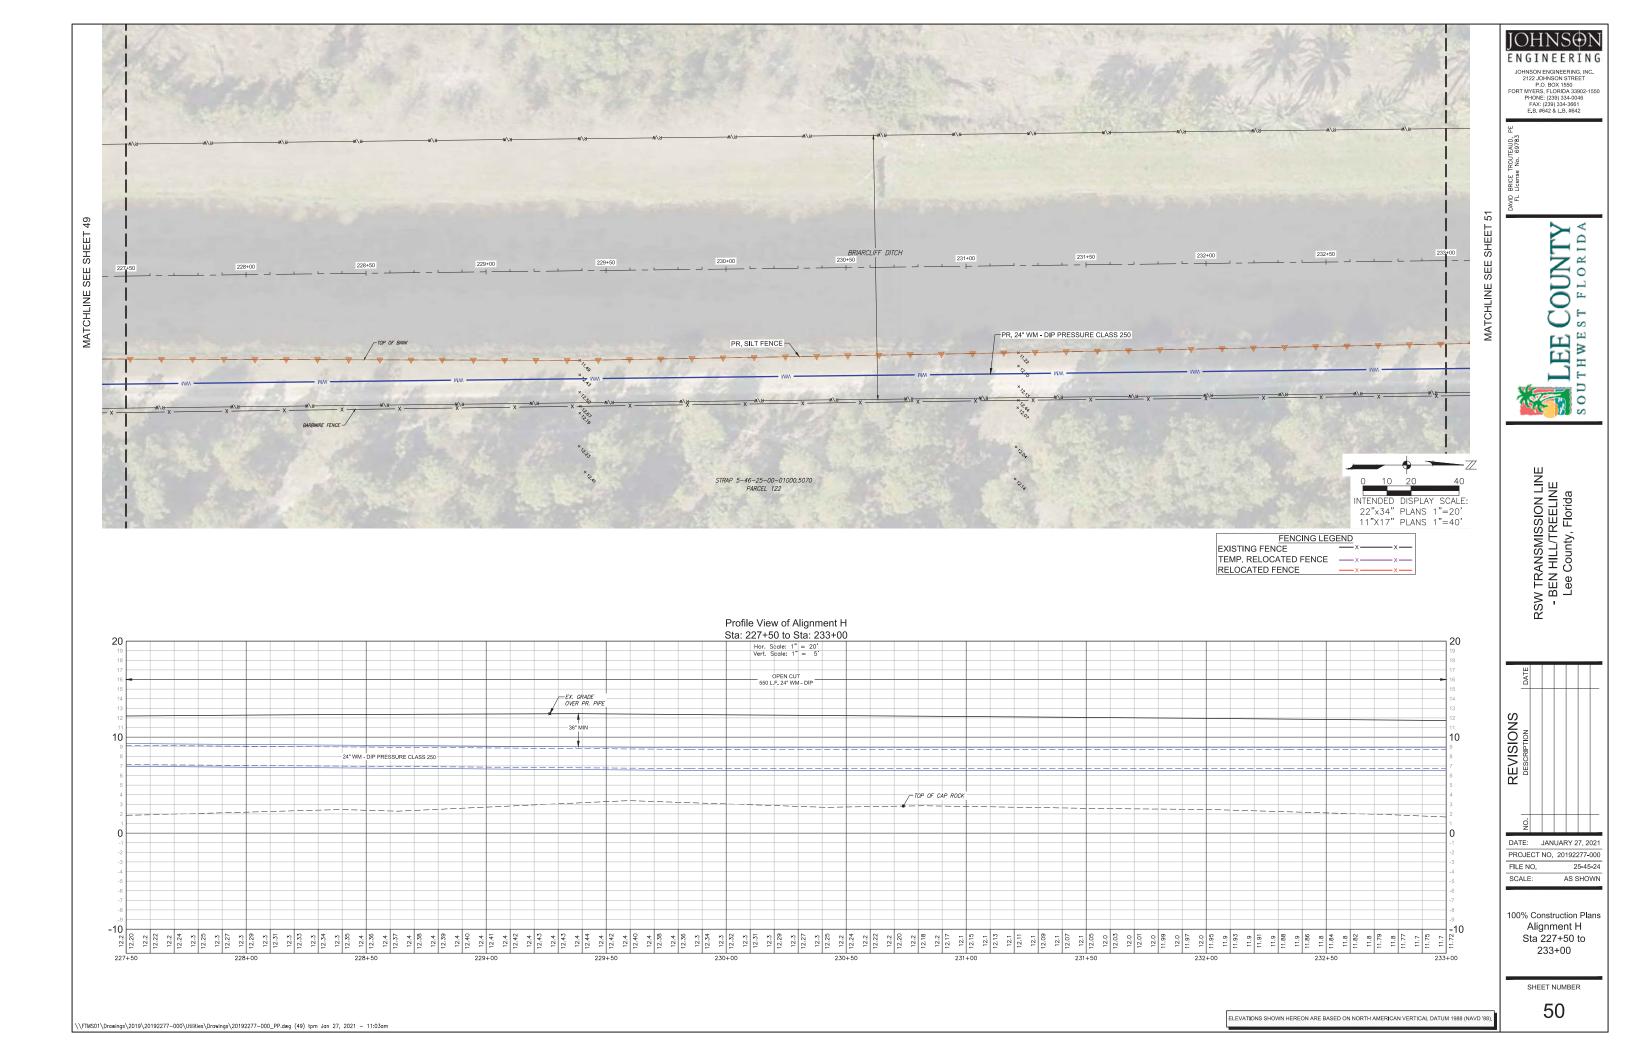
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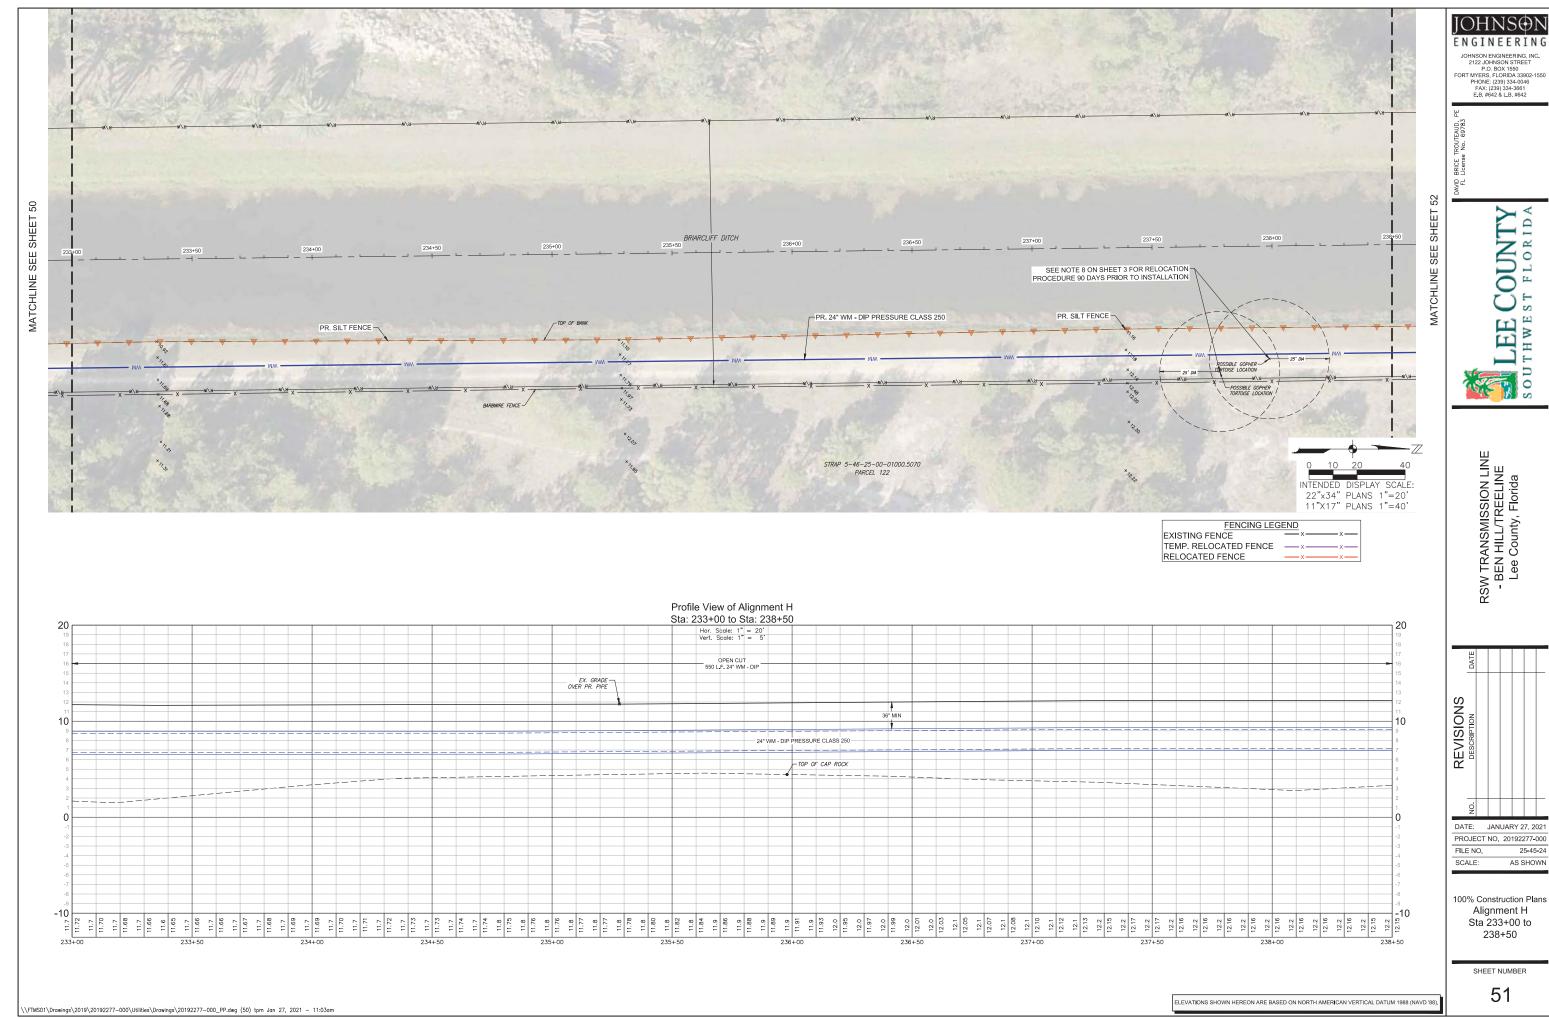


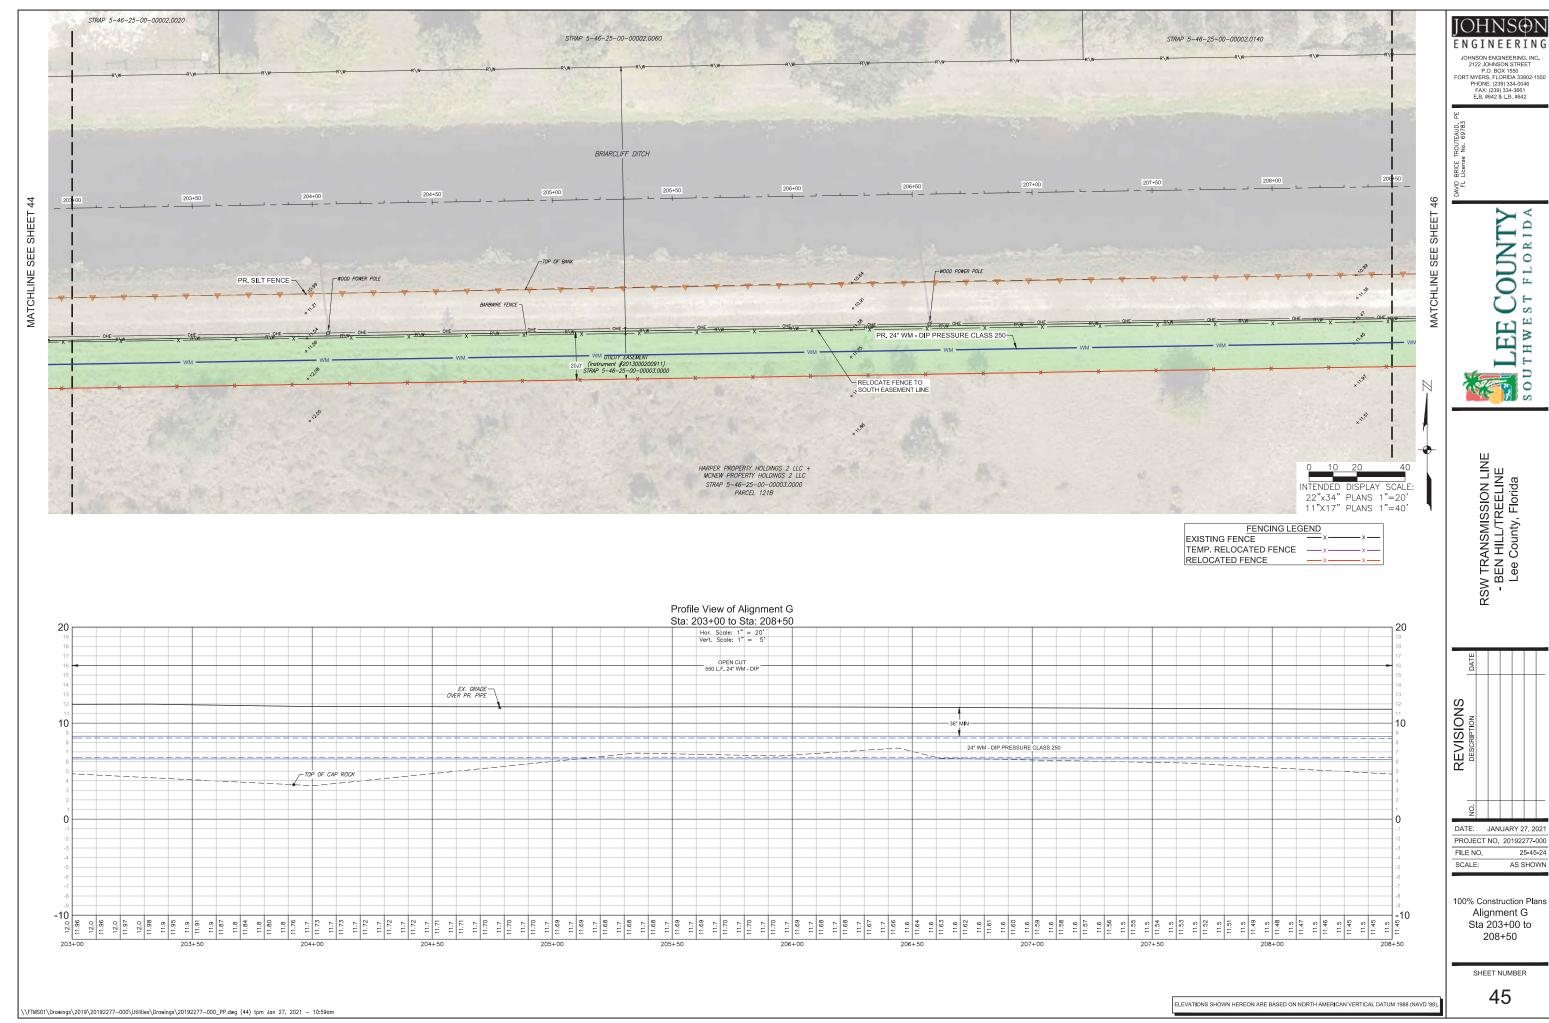
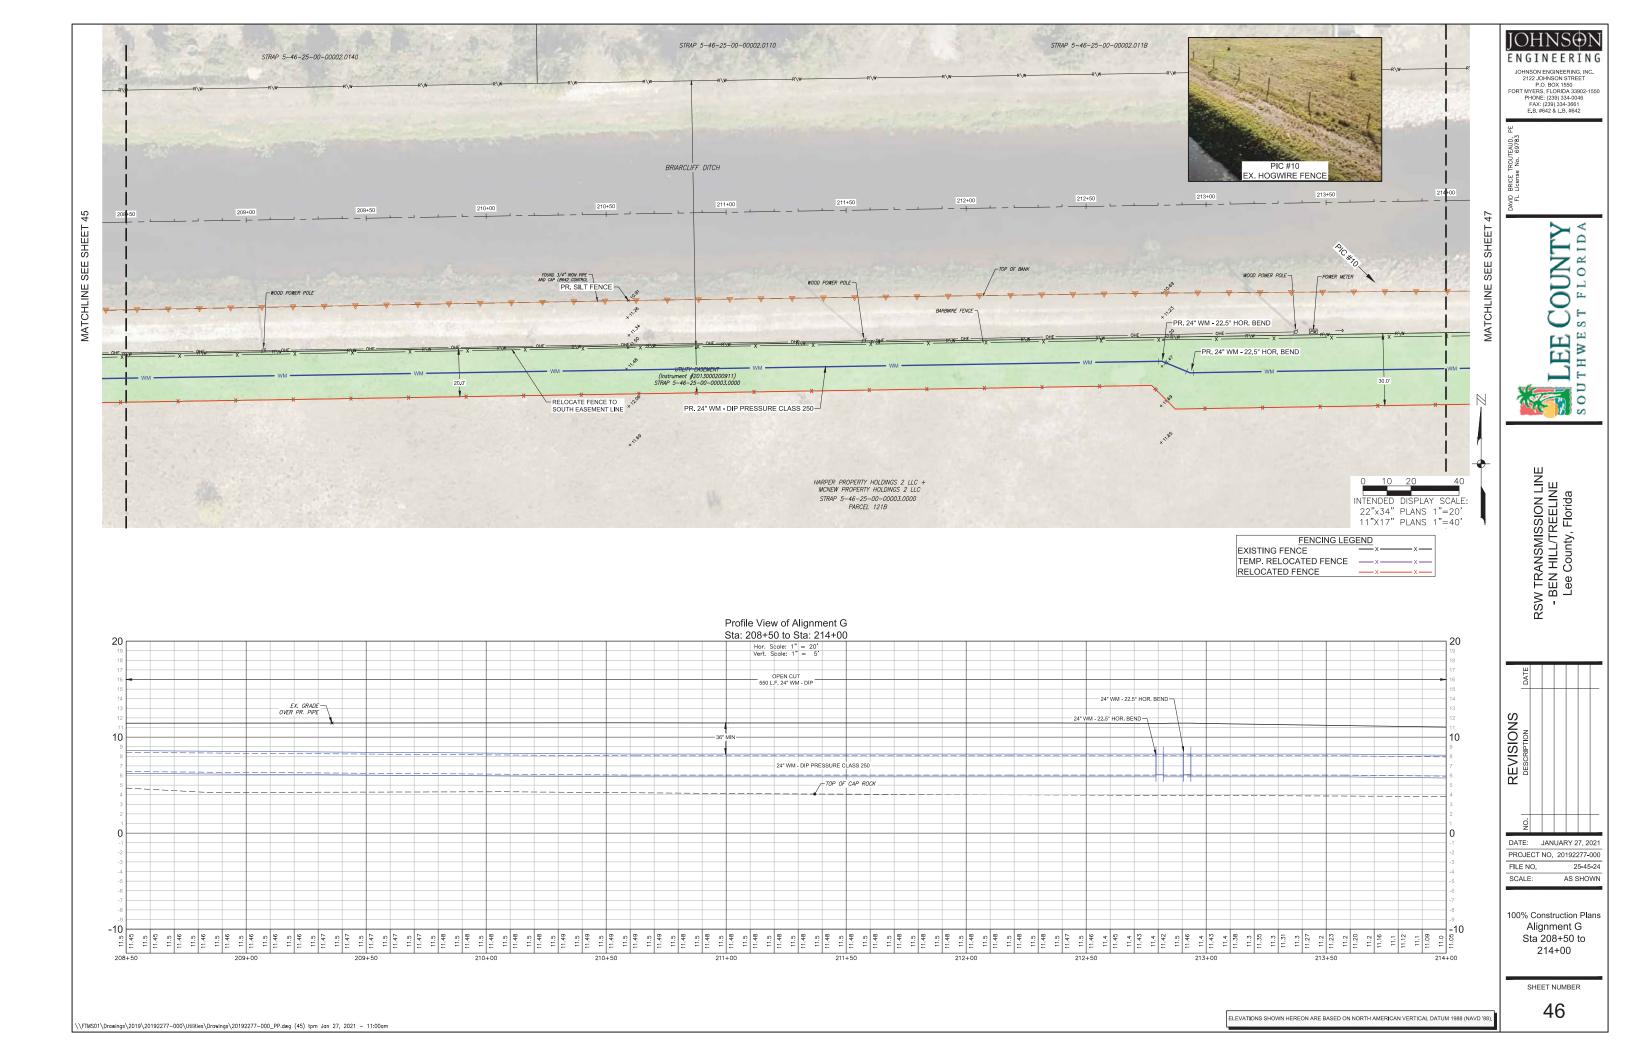
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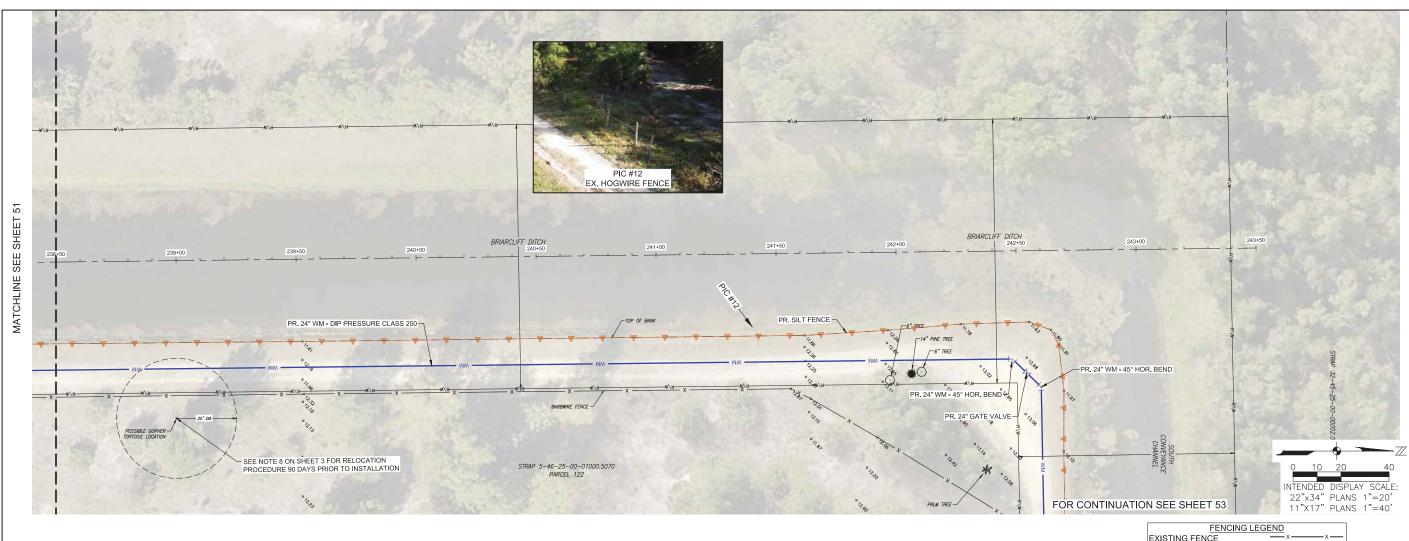


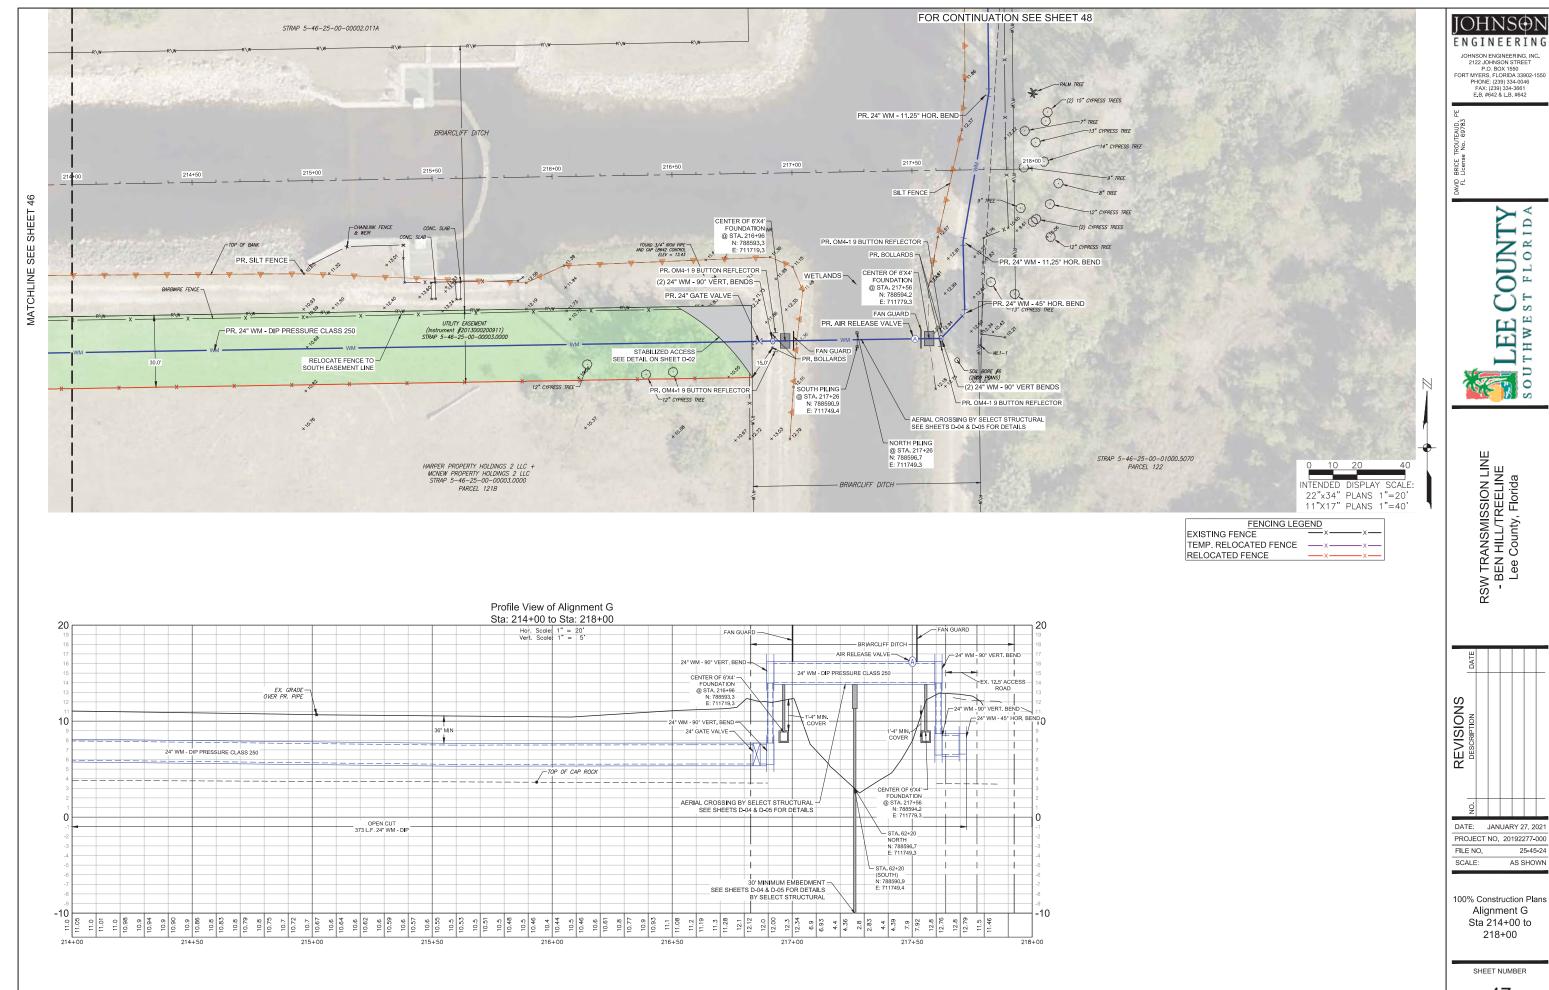


25-45-24

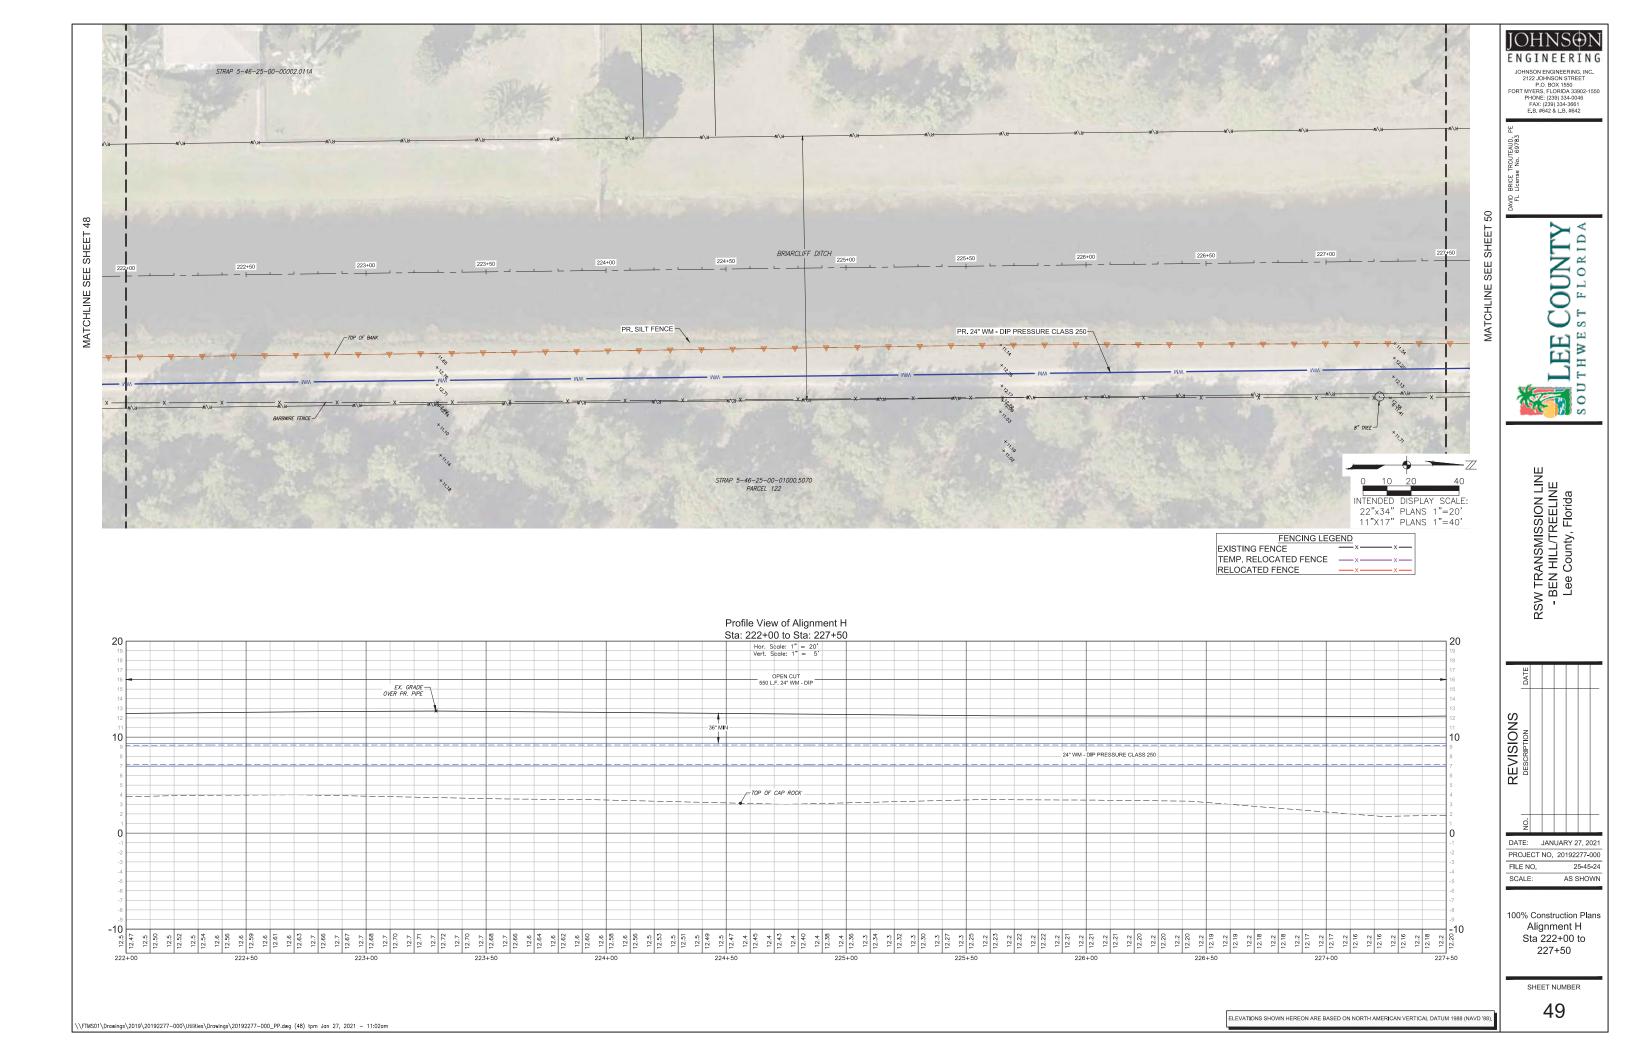AS SHOWN

Sta 233+00 to





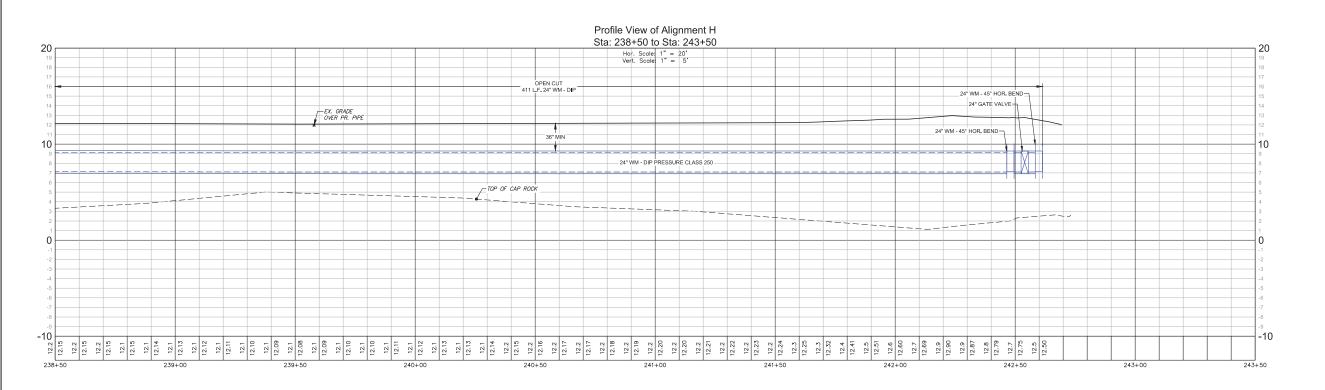

JOHNSON ENGINEERING, INC. 2122 JOHNSON STREET P.O. BOX 1550 FORT MYERS, FLORIDA 33902-1550 PHONE: (239) 334-0046 FAX: (239) 334-3661 E.B. #642 & L.B. #642

TROUTEAUD, No. 69783

LEE COUNTY SOUTHWEST FLORIDA


RSW TRANSMISSION LINE
- BEN HILL/TREELINE
Lee County, Florida



PROJECT NO. 20192277-000 FILE NO. 25-45-24 SCALE: AS SHOWN

100% Construction Plans Alignment H Sta 238+50 to 243+50

SHEET NUMBER

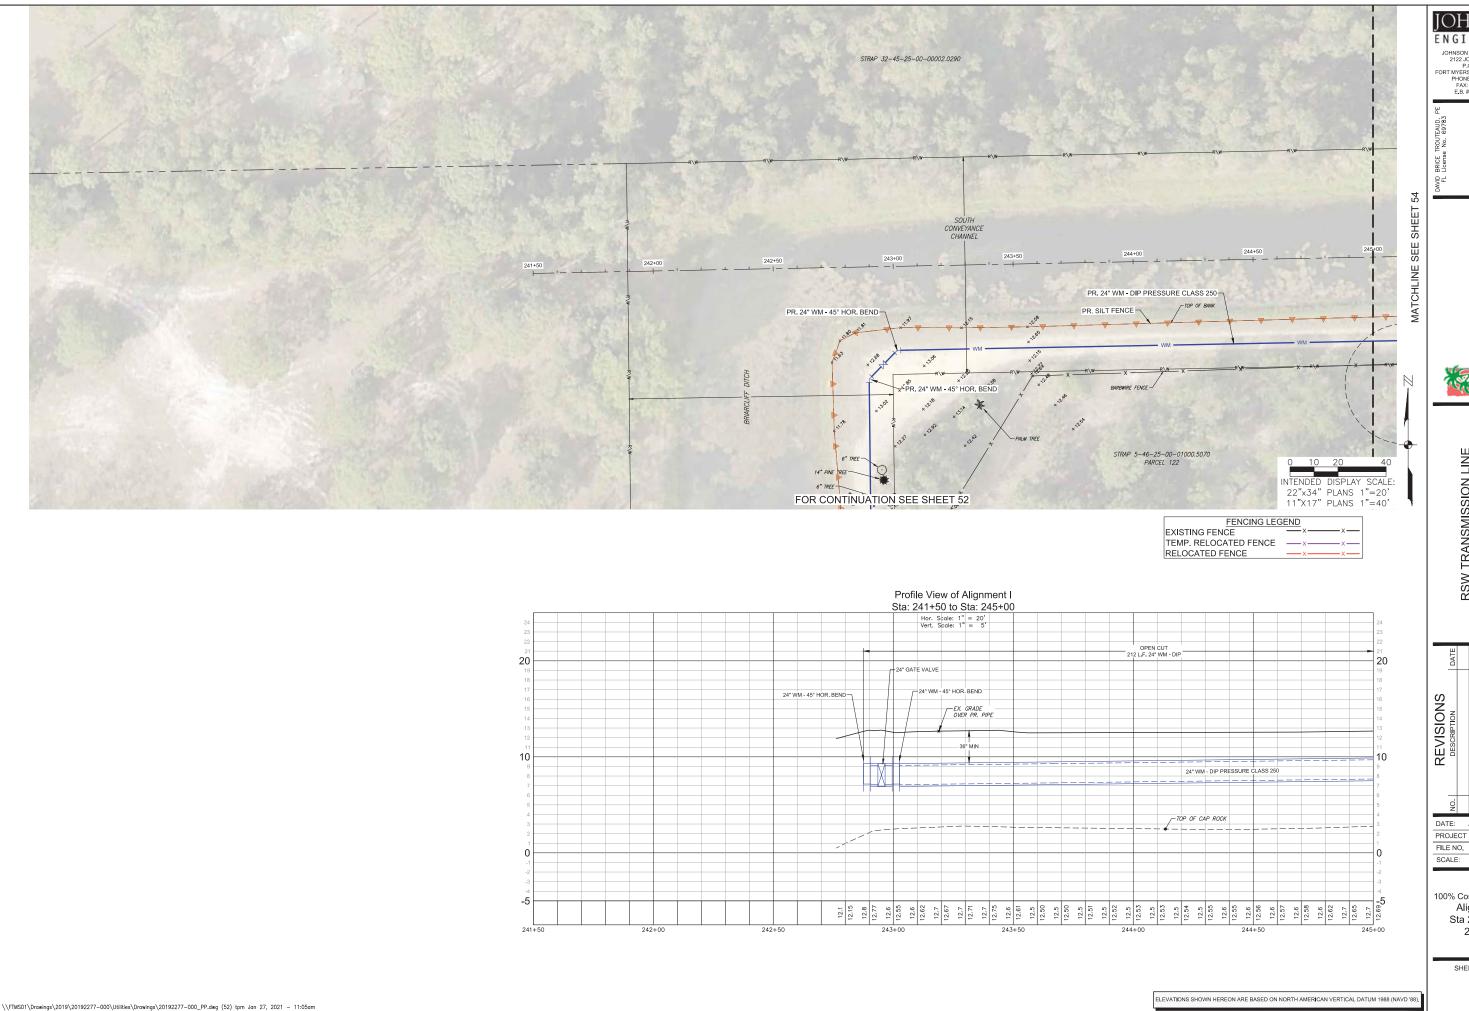

JOHNSON ENGINEERING, INC. 2122 JOHNSON STREET P.O. BOX 1550 FORT MYERS, FLORIDA 33902-1550 PHONE: (239) 334-0046 FAX: (239) 334-3661 E.B. #642 & L.B. #642

LEE COUNTY SOUTHWEST FLORIDA

RSW TRANSMISSION LINE - BEN HILL/TREELINE Lee County, Florida




PROJECT NO. 20192277-000

25-45-24 AS SHOWN


100% Construction Plans Alignment I Sta 241+50 to 245+00


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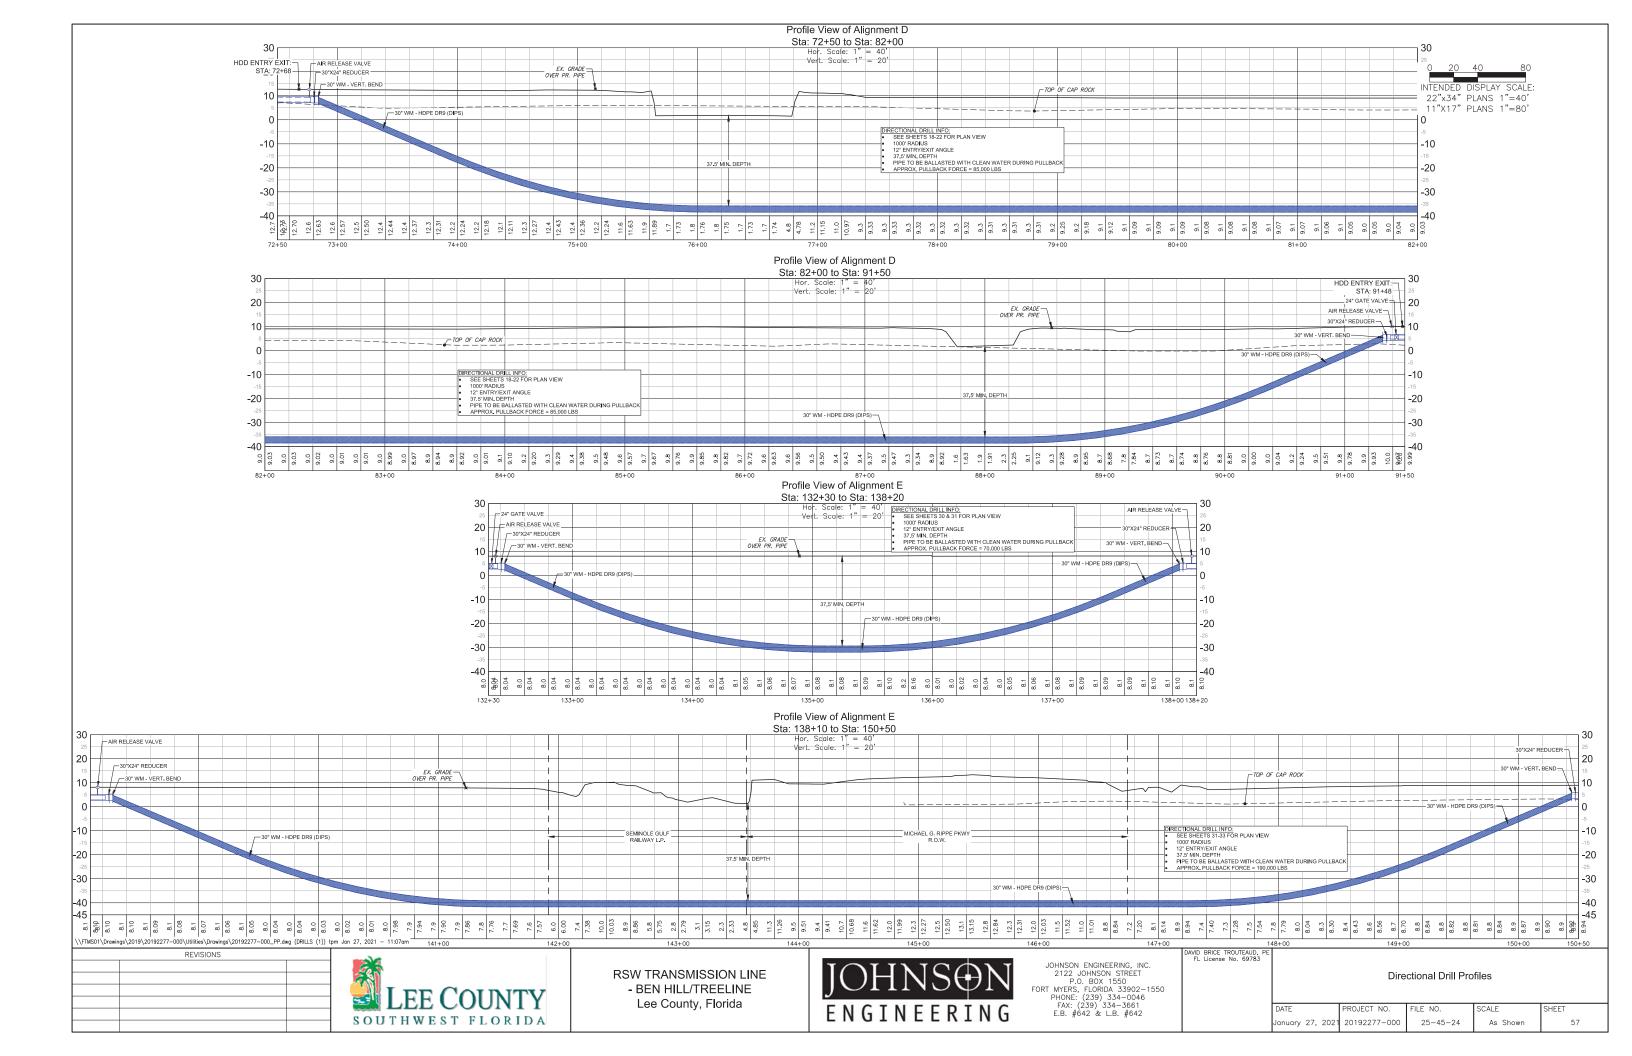


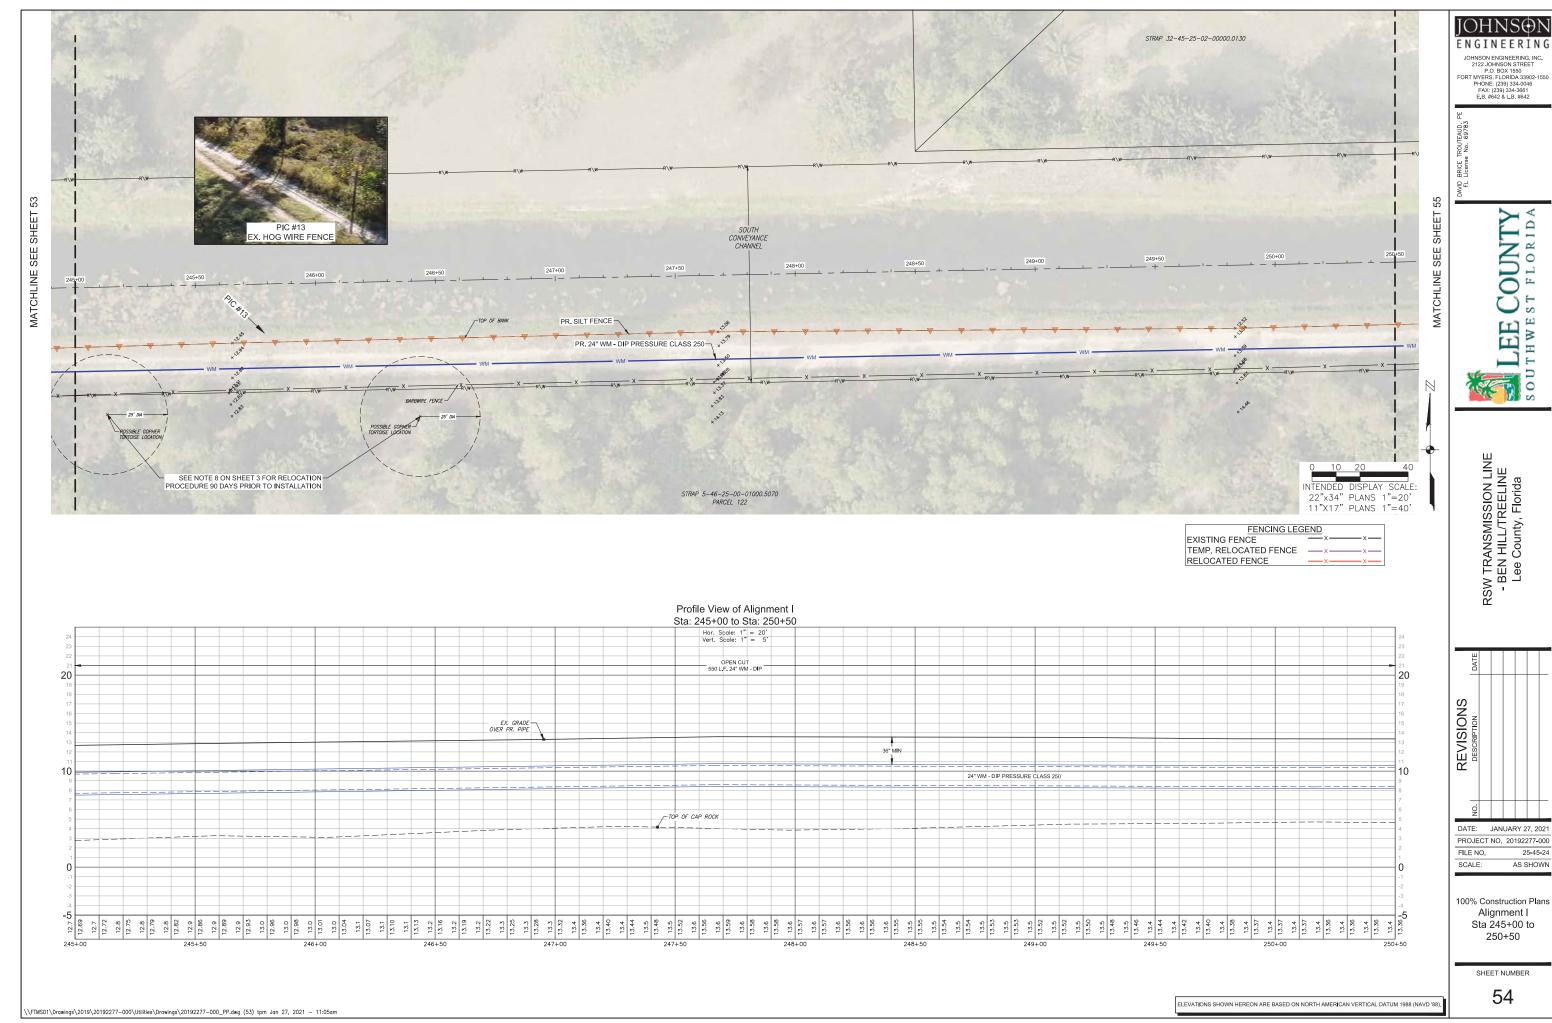



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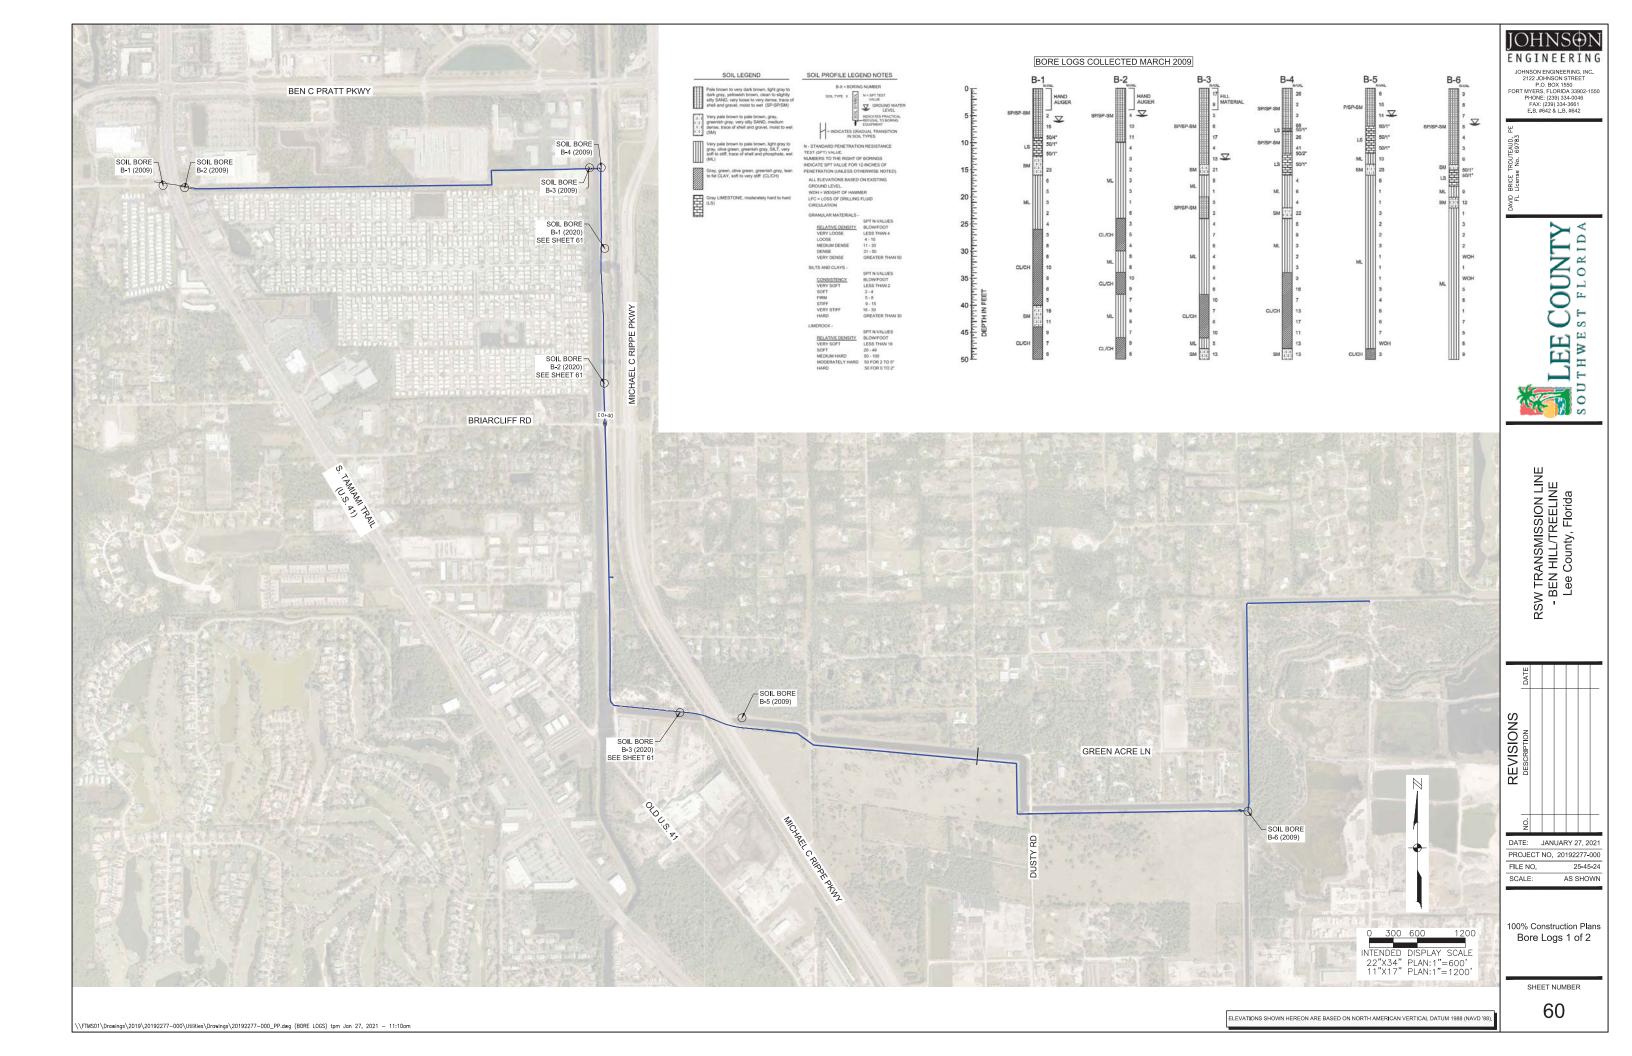




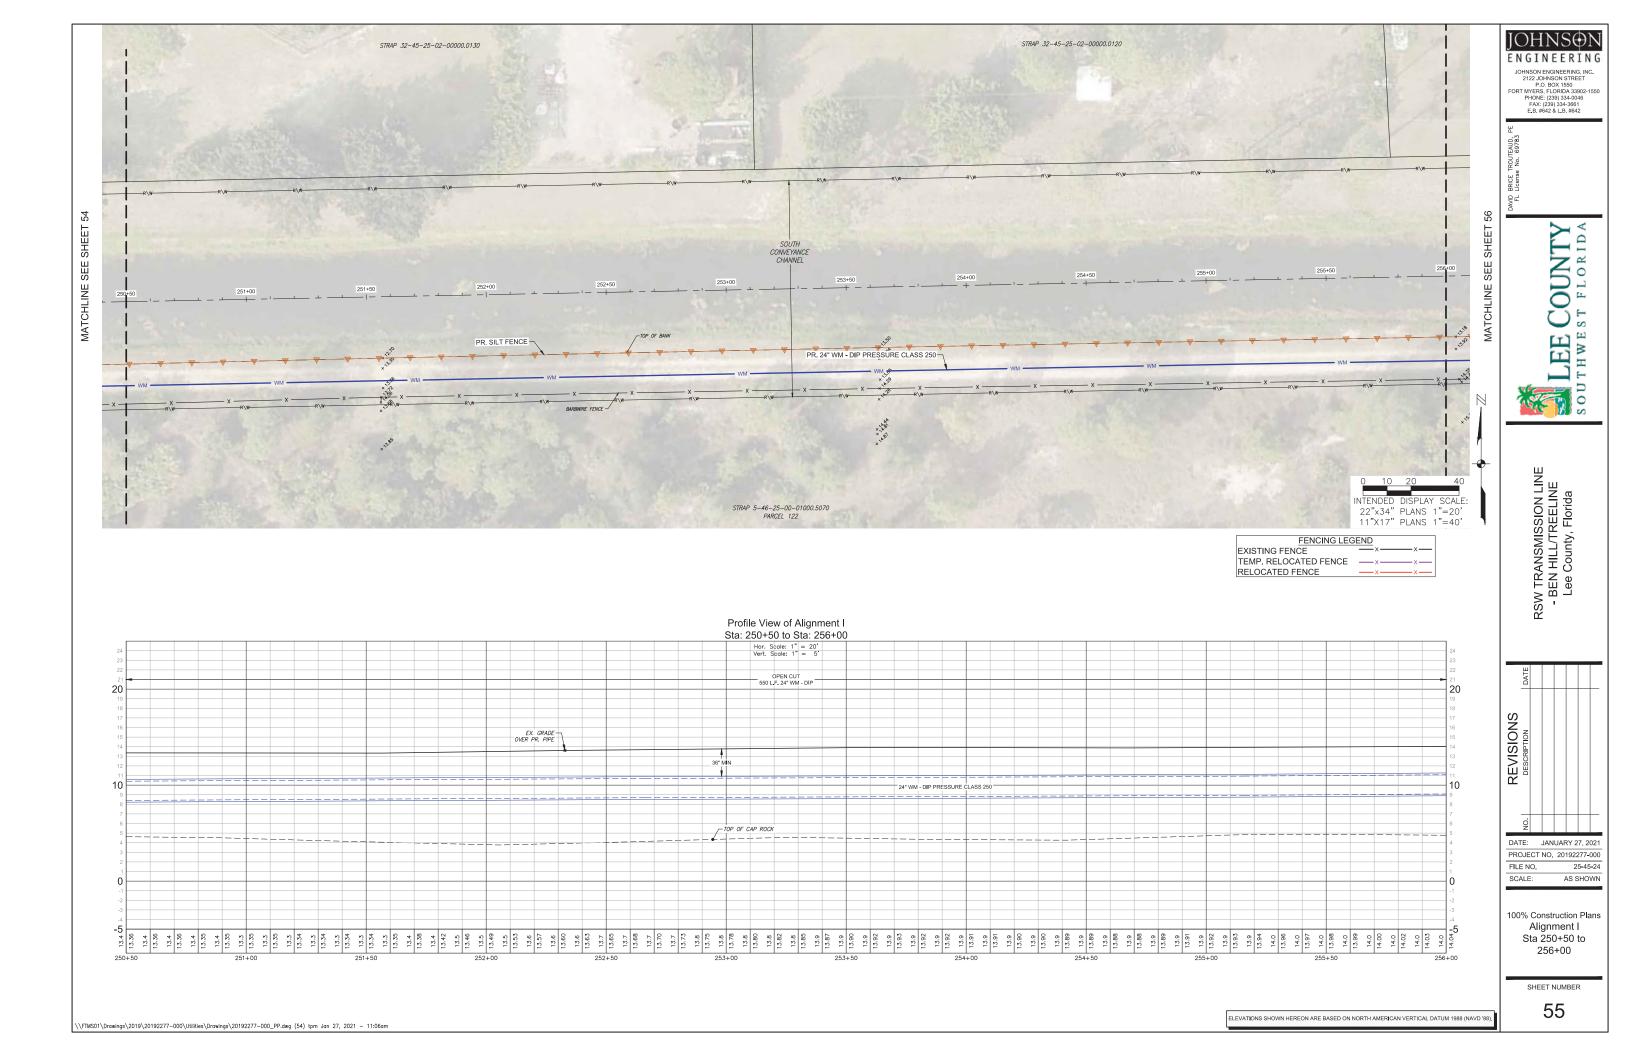

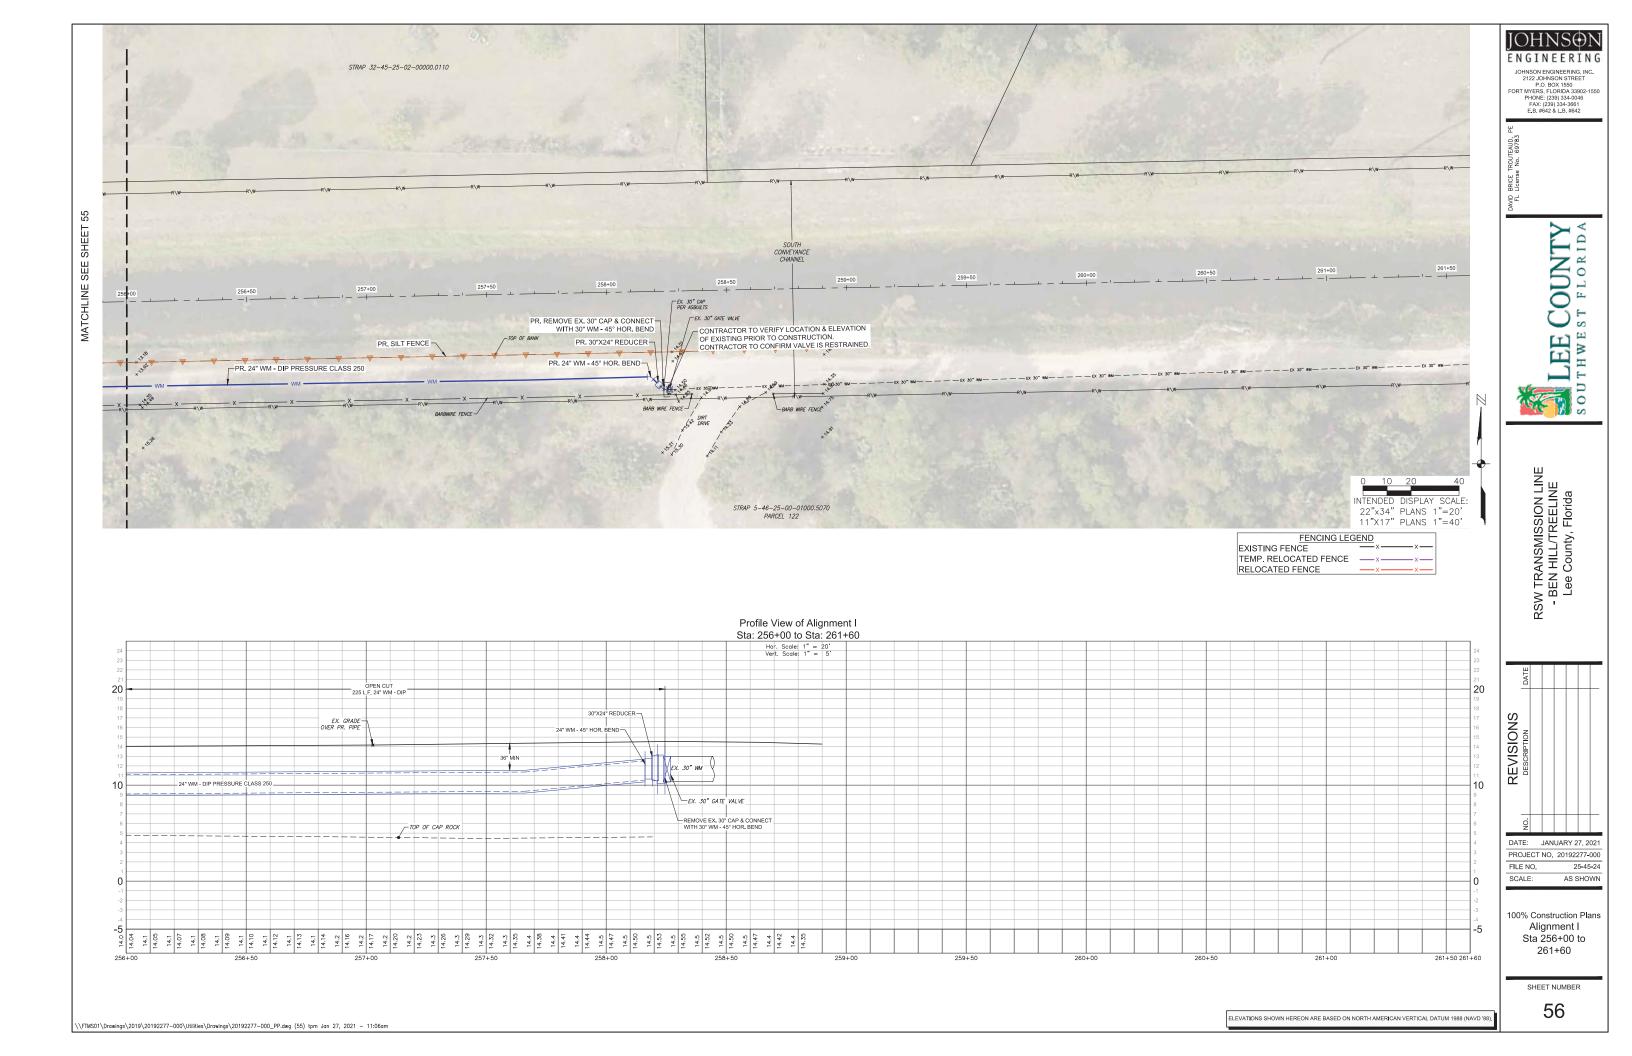

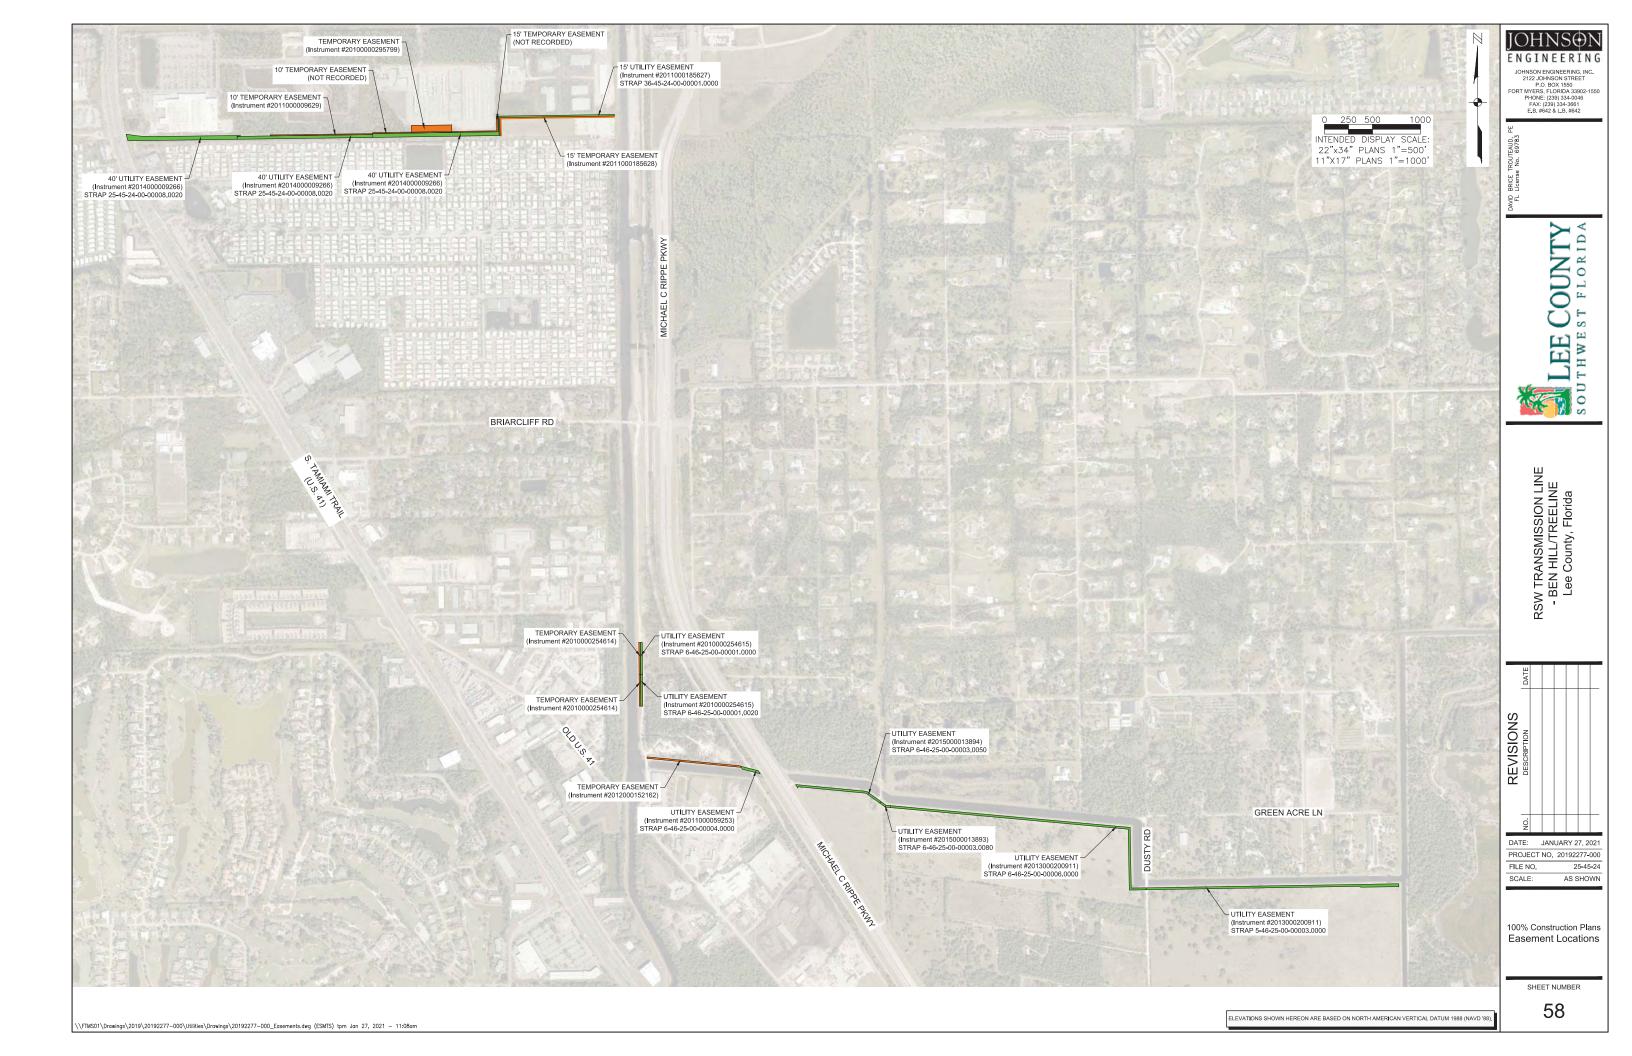

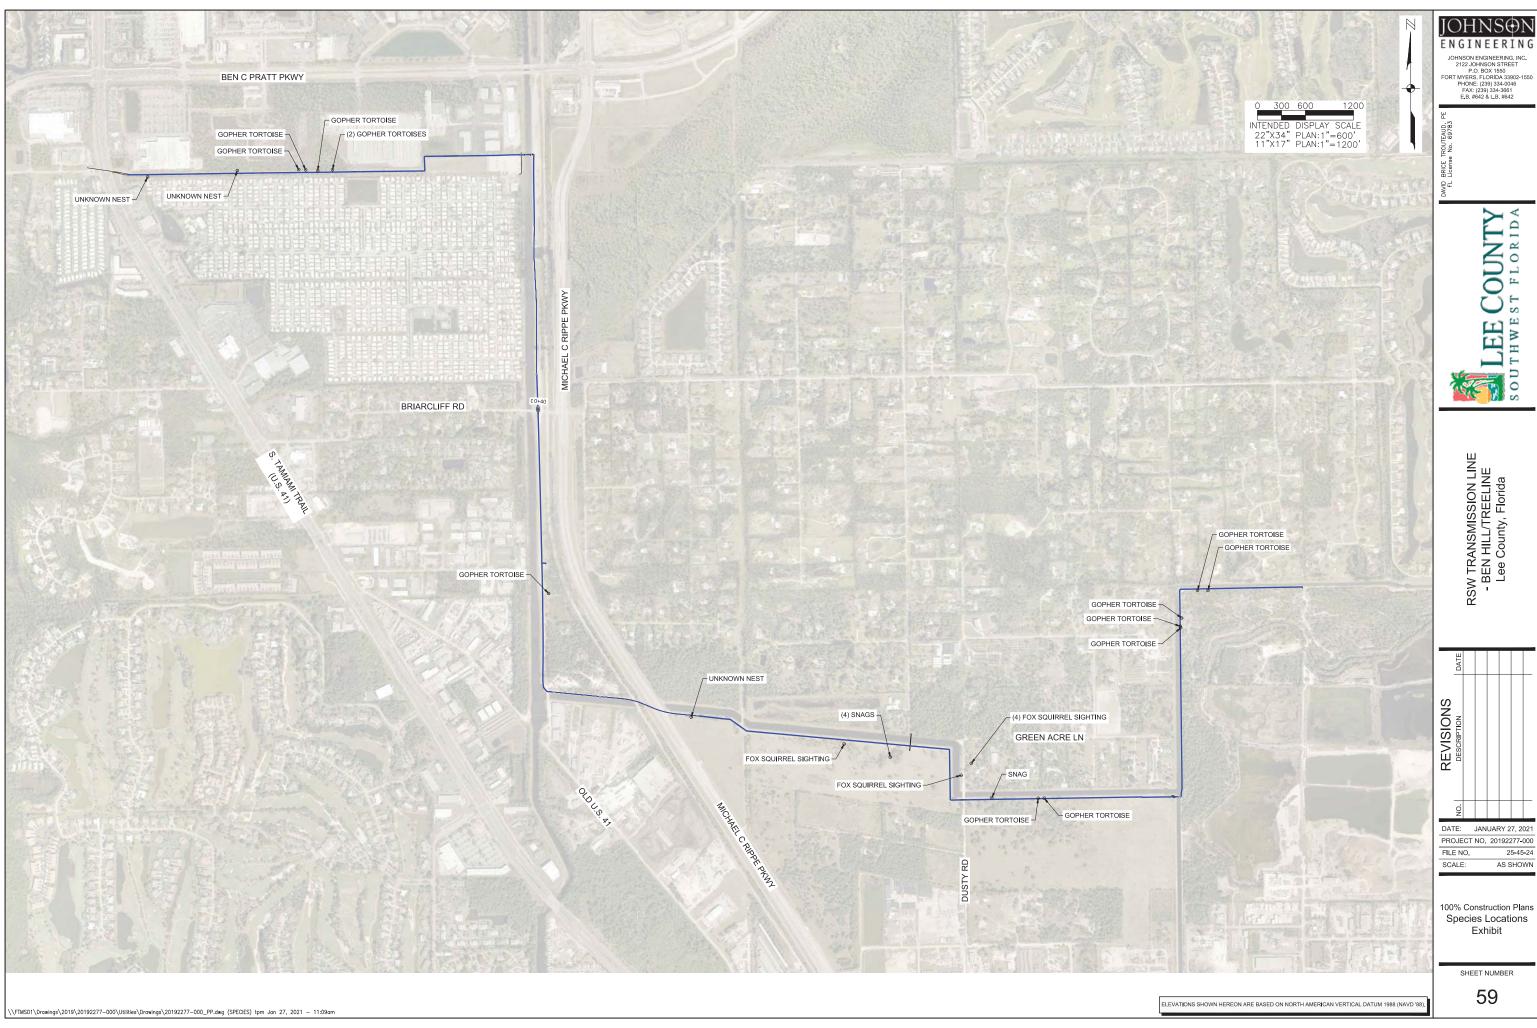

B-2 DEC. 2020 B-3 DEC. 2020 B-1 DEC. 2020 CLIENT: JOHNSON ENGINEERING, INC. CLIENT: JOHNSON ENGINEERING, INC. CLIENT: JOHNSON ENGINEERING, INC. BORING LOCATION: SEE BORING LOCTION PLAN BORING LOCATION: SEE BORING LOCTION PLAN BORING LOCATION: SEE BORING LOCTION PLAN LATITUDE: N 26°31'20.91"

DATE DRILLED: 8-DEC-20

GROUND SURFACE ELEVATION:
WATER TABLE DEPTH (ft): 3.5' LATITUDE: N 26"31"4.23"
DATE DRILLED: 9-DEC-20
GROUND SURFACE ELEVATION: LATITUDE: N 26°30′23.46°
DATE DRILLED: 9-DEC-20
GROUND SURFACE ELEVATION:
WATER TABLE DEPTH (ft): 4.0' LONGITUDE: W 81"51"16.09" PROJECT: RSW TRANSMISSION LINES BEN HILL / TREELINE LONGITUDE: W 81°51'16.18" PROJECT: RSW TRANSMISSION LINES BEN HILL / TREELINE LONGITUDE: W 81"51'5.82" PROJECT: RSW TRANSMISSION LINES BEN HILL / TREELINE FINISH: TIME: DATE: 8-DEC-20 FINISH: TIME: DATE: 9-DEC-20 START: START: START: LOCATION: LEE COUNTY, FLORIDA DRILL CREW: LOCKLEY LOCATION: LEE COUNTY, FLORIDA DRILL CREW: LOCKLEY LOCATION: LEE COUNTY, FLORIDA LOGGED BY: AHSANUZZ LOGGED BY: AHSANUZZI DRILL CREW: LOCKLEY LOGGED BY: AHSANUZ WATER TABLE DEPTH (ft): 4.0' DATE: 9-DEC-20 DRILL MAKE & MODEL: MOBILE 8-57 WIAUTO BIT: 3-7/8" DIA DRAG DRILLING METHOD: ROTARY WASH WITH DRILLING FLUID DRILL MAKE & MODEL: MOBILE 8-57 W/AUTO BIT: 3-7/8" DIA. DRAG DRILLING METHOD; ROTARY WASH WITH DRILLING FLUID DRILLING RODS: NW DRILL MAKE & MODEL: MOBILE B-57 WIAUTO BIT: 3-7/8" DIA, DRAG DRILLING RODS: NW DRILLING RODS: NW WEATHER CONDITIONS: SUN BLOWS SOIL DESCRIPTION SOIL DESCRIPTION SOIL DESCRIPTION SP-SM Slightly silty fine SAND with rock Fine SAND with rock fragments 3-6-6 3-3-4 1-2-3 Hard LIMESTONE. 4-6-7 50/0\*-1-1-2 Fine SAND. 3-1-1 3-4-6 1-1-3 5-1-0-0 5-5-7 5- 2-5-5 1-0-3 5-3-3 4-4-6 3-4-6 50/3"---Hard LIMESTONE. 4-5-5 Hard LIMESTONE. 10 - 15- 50/0"- 65/0" 10 - 3-4-4 loss of circulation at 11.0' Gray sandy SILT with shell. 1-0-0 Gray sandy SILT. SM Light gray to brown silty fine SAND. 1-0-1 2-3-2 SM Light gray silty fine SAND with shell. SM Gray silty fine SAND with shell. 1-2-2 1-1-0 casing was installed to 20.0" 2-2-2 1-1-5 Slightly clayey SAND with shell. 1-0-0 3-3-3 2-1-0 Gray sandy SILT. 1-2-2 3-6-3 1-1-2 3 4-5-5 2-2-3 4-5-3 4-5-5 5-6-5 7-7-8 8-8-9 3-5-5 3-4-4 TERMINATED AT 50.0' TERMINATED AT 50.0' MINATED AT 50.0' Ardaman & Associates, Inc. Geolarchridat, Erwir onwertel a Wi

REVIEWED BY: NAN SCKOLIC, P.E. FILE NO: 20-33-45/1 BORING NO.: B-02

JOHNSON ENGINEERING, INC. 2122 JOHNSON STREET P.O. BOX 1550 FORT MYERS, FLORIDA 33902-1550 PHONE: (239) 334-0046 FAX: (239) 334-3661 E.B. #642 & L.B. #642

ROUTEAUD, No. 69783

COUNTY ST FLORIDA LEE

RSW TRANSMISSION LINE
- BEN HILL/TREELINE
Lee County, Florida



PROJECT NO. 20192277-000 FILE NO. 25-45-24

SCALE: AS SHOWN

100% Construction Plans Bore Logs 2 of 2


SHEET NUMBER

61

REVIEWED BY: IVAN SOKOLIC, P.E. FILE NO: 20-33-4561 BORING NO.:

REVIEWED BY: IVAN SOKOLIC, P.E. FILE NO: 20-33-4551 BORING NO.: 8-01

### STANDARD DETAIL NO. 6.2 LEE COUNTY UTILITIES VALVE INSTALLATION

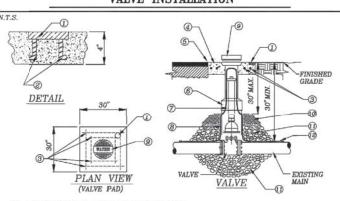


- ① BRASS PLATE: SIZE OF VALVE, VALVE TYPE No. OF TURNS & DIRECTION TO OPEN VALVE M.F.G. & YEAR INSTALL SYSTEM "WATER" OR "SEWER" OR "REUSE" OR "FIRE
- (2) ANCHOR
- (3) EIGHT (8) #4 BARS OVERLAP EACH CORNER BY 2"
- (4) 30"SQ X 4" THK.CONC.PAD SURROUNDING BOX, MIN. 3.000 P.S.I. POURED IN PLACE
- (5) SET TOP OF BOX FLUSH WITH FINISHED GRADE
- (6) HEAVY DUTY TRAFFIC BEARING CAST IRON VALVE BOX, ADJUSTABLE SCREW TYPE, 5 1/4" DIAMETER SHAFT THAT IS LCU APPROVED
- 7 EXTENSION STEM WITH 2" OPERATING NUT AS REQUIRED, IF NUT IS
- MORE THAN 30" BELOW FINISH GRADE (8) RISER NOT TO BEAR ON VALVE OR PIPE
- (9) CAST IRON DROP COVER MARKED "WATER" OR "SEWER" OR "REUSE OR "FIRE"
- (0) COMPACTED SUITABLE EARTH BACKFILL
- 1 3/4" GRANULAR MATERIAL #57 STONE

1. ALL RESTORATION WORK SHALL BE IN ACCORDANCE WITH THE LCU DESIGN MANUAL.

REV: 12/10/2015

(2) 12 GAUGE DOUBLE INSULATED COPPER LOCATING WIRE (SEE LCU STANDARD DETAIL)

### STANDARD DETAIL NO. 6.3 LEE COUNTY UTILITIES LOCATING WIRE FOR PRESSURE MAINS

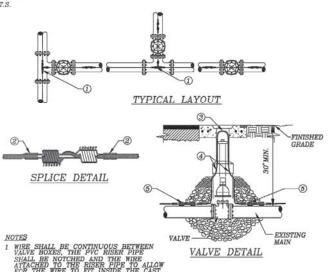

① SPLICE RUN TOGETHER, KEEP CLEAR OF FITTING, TYPICAL

© COVER SPLICE WITH 2 WRAPS OF 10 MIL. POLYETHYLENE TAPE

3 6" LOOP OF BARE WIRE, 9" MAX. DEPTH TO TOP OF BARE WIRE


(6) SPLICE (SEE DETAIL THIS SHEET)

4 12 GAUGE DOUBLE INSULATED COPPER LOCATING WIRE

- REV: 12/10/201

REV: 12/10/2015


### STANDARD DETAIL NO. 6.4 LEE COUNTY UTILITIES AUTOMATIC AIR RELEASE VALVE

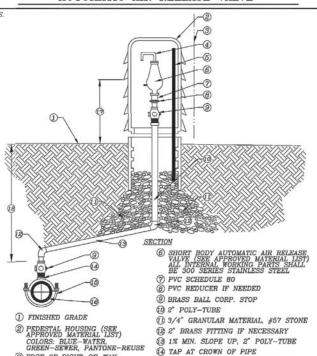

- 3 EDGE OF RIGHT-OF-WAY 4) PVC STREET ELL (5) S.S. POST WITH S.S. HARDWARE AND S.S. LOCKING HASP WITH

#### (6) EXISTING PRESSURE MAIN (7) 24" (8) 30" MIN

### STANDARD DETAIL NO. 6.5 LEE COUNTY UTILITIES TRENCH CROSS SECTION

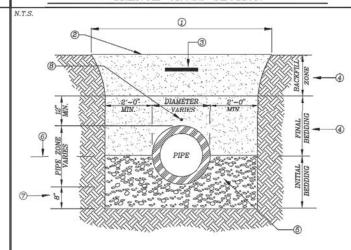


- (1) EXCAVATED TRENCH
- ② FINISHED GRADE

REV: 12/10/2015

- 3 MARKING TAPE 12" DEPTH MAX.
- 4 MATERIALS CLEAN DRY SAND, FINE LIME ROCK OR PIT SHELL MECHANICALLY COMPACTED IN 6" LIFTS TO AT LEAST 95% OF MAX. DENSITY, OR 98% IF UNDER PAVED AREA OF ROADWAY.
- (5) #57 STONE LOCATED UNDER PIPE SUITABLE MATERIAL
- (6) SPRING LINE
- TANDARD 8" MIN TRENCH UNDERCUT STANDARD 8" MIN TRENCH UNDERCUT
  AND BACKPILL WITH #57 STONE
  COMPACTED IN 6" LIFTS
  ADDITIONAL UNDERCUT AND CRUSHED ROCK
  BEDDING FOUNDATION WHEN DIRECTED BY
  L.C.U. THE CONTRACTOR IS TO REMOVE
  UNSTABLE MATERIAL FROM THE TRENCH
  FOUNDATION. THEN INSTALL STABILIZED
  CRUSHED ROCK BACKFILL WITH #57 STONE
  COMPACTED IN 6" LIFTS. COMPACTED IN 6" LIFTS
- LOCATING WIRE IS REQUIRED FOR ALL PRESSURIZED PIPELINES.


THIS DRAWING CONTAINS DETAILS DESIGNED BY, STANDARD TO, AND FURNISHED BY LEE COUNTY UTILITIES SAID DETAILS WERE NOT DESIGNED BY JOHNSON ENGINEERII

### STANDARD DETAIL NO. 6.7 LEE COUNTY UTILITIES HORIZONTAL DIRECTIONAL DRILL UNDER A ROADWAY

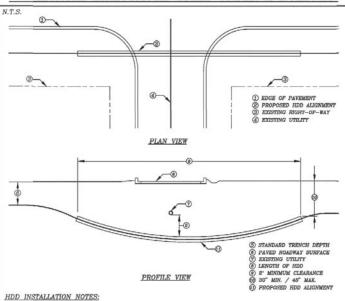


### STANDARD DETAIL NO. 6.8 LEE COUNTY UTILITIES WATER AND SEWER CROSSING DETAIL

18" MINIMUM UNLESS OTHERWISE (I) WATER MAIN SECTION (2) SANITARY SEWER MAIN CROSSINGS NOTE: IF LESS THAN 18" CLEARANCE ENCASE WATER MAIN IN STEEL CASING

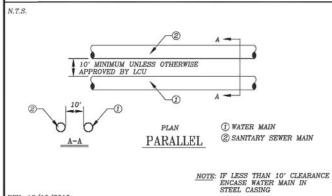

### STANDARD DETAIL NO. 6.14 LEE COUNTY UTILITIES BLOW OFF DETAIL

(SEE APPROVED MATERIAL LIST)

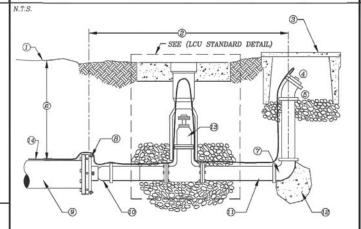


- 1 FINISHED GRADE 2) 5'-0" MAX.
- WATER METER BOX W/GRAVEL BOTTOM (SEE APPROVED MATERIAL LIST) (4) 2" THREADED PLUG (5) 2"-45" BEND

REV: 12/10/2015

- (7) 2"-90" BEND 8) M.J. CAP WITH 2" TAP 9 END OF WATER MAIN, R.J. PER SCHEDULE
- @ 2" THREADED ① 2" P.V.C.(SCH #9).C. MALE ADAPTER ② POURED IN PLACE THRUST BLOCKING (SEE DETAIL 9.20)
- 3 2" DIAMETER GATE VALVE (4) 12 GAUGE DOUBLE INSULATED COPPER LOCATING WIRE (SEE LCU STANDARD DETAIL)

ALL PIPING TO BE 2" P.V.C. (SCH 80) THREADED FITTINGS OR SOLVENT WELDED FITTINGS

### STANDARD DETAIL NO. 6.44 LEE COUNTY UTILITIES BOLLARD POST DETAIL

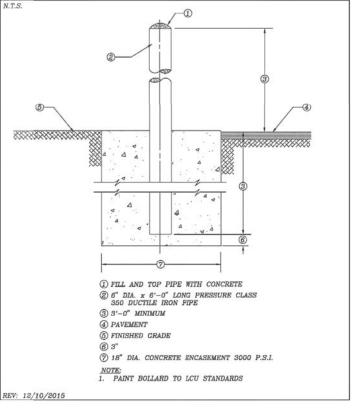

2122 JOHNSON STREET
P.O. BOX 1550
FORT MYERS, FLORIDA 33902-1550
PHONE (239) 334-0046
FAX (239) 334-3661
E.B. #642 & L.B. #642

OUNTY EE HWE

RSW TRANSMISSION LINE - BEN HILL/TREELINE Lee County, Florida

REVISIONS DATE: JANUARY 27, 2021 PROJECT NO. 20192277-000

100% Construction Plans

25-45-24

AS SHOWN

FILE NO.


SCALE

Details 1 of 2


SHEET NUMBER D-01

\FTMS01\Drawings\2019\2019277-000\Utilities\Drawings\20192277-000 Details.dwg (Details (1)) tpm Jan 27, 2021 - 11:10g

# STANDARD DETAIL NO. 6.10 LEE COUNTY UTILITIES WATER PRESSURE LINE VERTICAL OFFSET W/ DUCTILE IRON MJ FITTINGS & PIPE

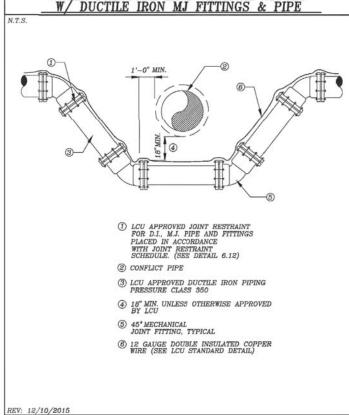

# STANDARD DETAIL NO. 6.11 LEE COUNTY UTILITIES WASTE WATER FORCE MAIN VERTICAL OFFSET

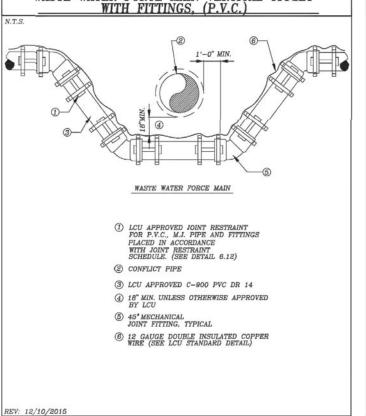

## STANDARD DETAIL NO. 6.12 LEE COUNTY UTILITIES

### DUCTILE IRON PIPE

PIPE	MINIMUM RESTRAINED PIPE LENGTH (FEET)								
SIZE (Inches)		HORIZON	DEAD	HORIZONTAL					
	90°	45*	22-1/2	11-1/4	END	TEE			
4	17	7	4	2	29	6			
6	23	10	5	2	40	17			
8	29	12	6	3	53	29			
10	35	14	7	4	63	38			
12	41	17	8	4	74	49			
16	51	21	11	5	94	68			
24	69	29	14	7	131	105			
30	81	34	17	8	156	129			

### PVC PIPE


PIPE SIZE (inches)	MINIMUM RESTRAINED PIPE LENGTH (FEET)							
		HORIZOI	DEAD	HORIZONTAL				
	90*	45°	22-1/2	11-1/4	END	TEE		
4	20	8	4	2	45	8		
6	29	12	6	3	63	25		
8	36	15	8	4	83	43		
10	44	18	9	5	99	58		
12	51	21	11	5	116	74		
16	63	26	13	7	149	103		
24	87	36	18	9	208	158		
30	102	42	21	10	248	194		

A COMPLETE JOINT RESTRAINING SCHEDULE FOR ALL ENCOUNTERED VERTICAL & HORIZONTAL BENDS, VERTICAL OFFSETS, TEES, AND DEAD ENDS SHALL BE THE RESPONSIBILITY OF THE DESIGN ENGINEER.

LENGTH FIGURES BASED ON FOLLOWING:

Pressure = 150 psi, FS = 1.5, trench type = 3, 30" cover on Bare pipe, Soil type = GP & SP

## RESTRAINED LENGTH SCHEDULE

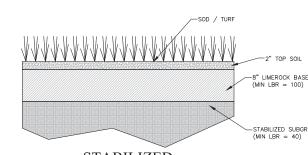


**ACCESS DETAIL** 


-STABILIZED SUBGRADE (MIN LBR = 40) **STABILIZED** 


> IS DRAWING CONTAINS DETAILS DESIGNED BY STANDARD TO AND FURNISHED BY LEE COUNTY UTILITIES SAID DETAILS WERE NOT DESIGNED BY JOHNSON ENGINEERIN

## STANDARD DETAIL NO. 6.44 LEE COUNTY UTILITIES

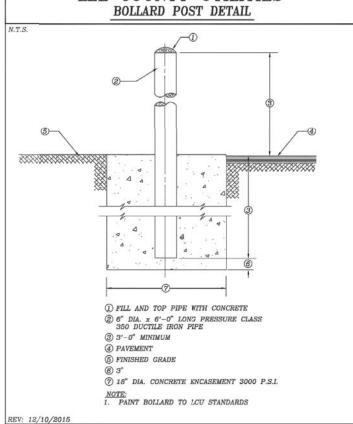

FTMS01\Drawinas\2019\20192277-000\Utilities\Drawinas\20192277-000 Details.dwa (Details (2)) tpm Jan 27, 2021 - 11:10am

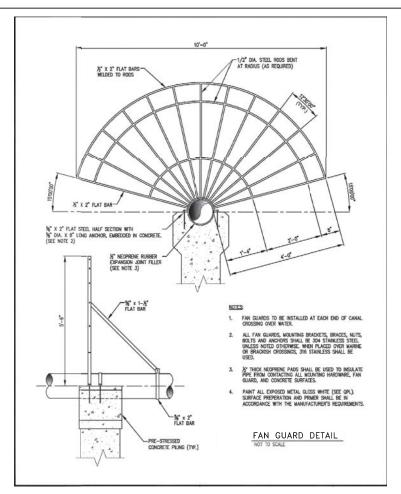

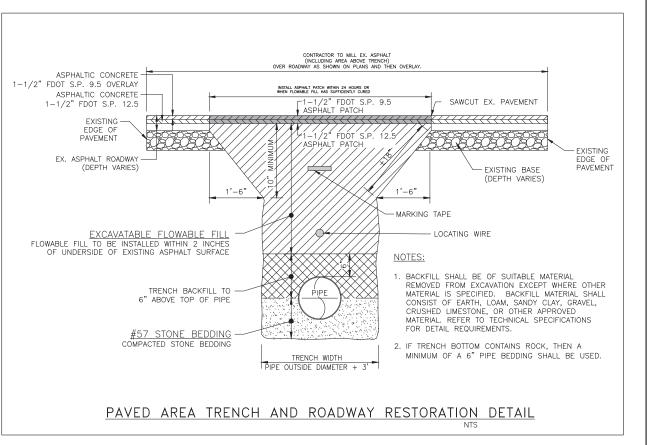

2122 JOHNSON STREET
P.O. BOX 1550
FORT MYERS, FLORIDA 33902-1550
PHONE (239) 334-0046
FAX (239) 334-3661
E.B. #642 & L.B. #642

OUNTY FLORIDA

RSW TRANSMISSION LINE
- BEN HILL/TREELINE
Lee County, Florida


REVISIONS DATE: JANUARY 27, 2021


PROJECT NO. 20192277-000 FILE NO. 25-45-24 SCALE: AS SHOWN

100% Construction Plans Details 2 of 2


SHEET NUMBER

D-02

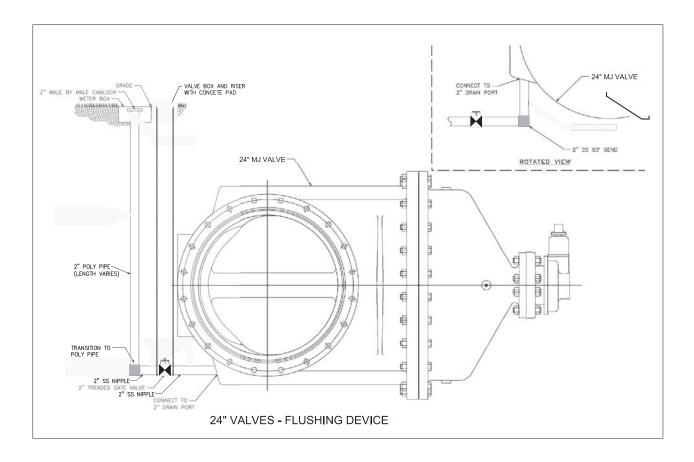

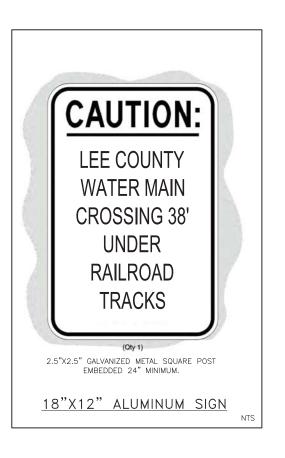

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2122 JOHNSON STREET
P.O. BOX 1550
FORT MYERS, FLORIDA 33902-1550
PHONE (239) 334-0046
FAX (239) 334-3661
E.B. #642 & L.B. #642

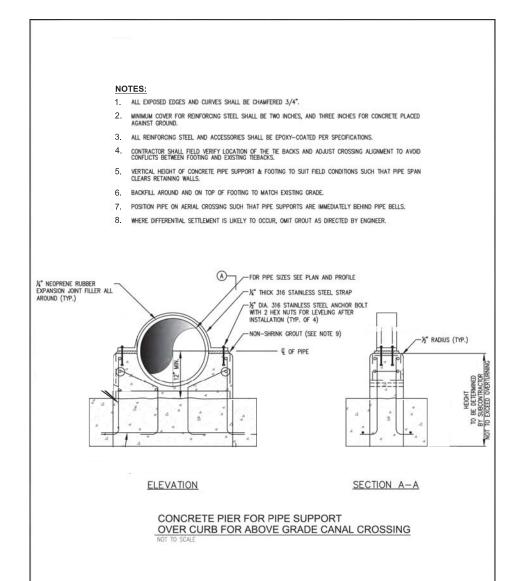COUNTY ST FLORIDA LEE (

RSW TRANSMISSION LINE - BEN HILL/TREELINE Lee County, Florida



PROJECT NO. 20192277-000 25-45-24

FILE NO. SCALE: AS SHOWN

100% Construction Plans Details 3 of 3

SHEET NUMBER

D-03

### GENERAL STRUCTURAL NOTES

GENERAL: STRUCTURAL DRAWINGS SHALL BE USED IN CONJUNCTION WITH JOB SPECIFICATIONS AND CIVIL DRAWINGS. CONSULT THESE DRAWINGS FOR INFORMATION NOT SHOWN ON STRUCTURAL DRAWINGS.

 $\frac{\text{CODE REQUIREMENTS:}}{\text{ACCORDANCE WITH THE 2017 6}^{\text{TH}}} \text{ The BUILDING STRUCTURE IS DESIGNED IN ACCORDANCE WITH THE 2017 6}^{\text{TH}} \text{ EDITION OF THE FLORIDA BUILDING CODE. FOLLOW ALL APPLICABLE PROVISIONS FOR ALL PHASES OF}$ 

DESIGN CRITERIA: DESIGN WAS BASED ON STRENGTH AND DEFLECTION CRITERIA OF THE 2017 FLORIDA BUILDING CODE.

WIND SPEED (ASCE 7-10)

170 MPH

(132 MPH NOMINAL)

RISK CATEGORY

EXPOSURE INTERNAL PRESSURE COEFF0.0

OPEN BUILDING

FOUNDATIONS: FOUNDATIONS ARE DESIGNED FOR AN ALLOWABLE SOIL BEARING PRESSURE OF 2.500 PSF ON COMPACTED FILL. BEFORE CONSTRUCTION COMMENCES, SOIL BEARING CAPACITY SHALL BE VERIFIED BY A SUBSURFACE INVESTIGATION, AS WELL AS FIELD AND LABORATORY TESTS PERFORMED BY A CERTIFIED TESTING LABORATORY, WHOSE REPORT SHALL INCLUDE ANALYSIS AND RECOMMENDATIONS FOR SITE PREPARATION IN ORDER TO BEAR THE FOUNDATION LOADS. ABOVE REPORT SHALL BE SUBMITTED TO THE STRUCTURAL ENGINEER FOR REVIEW BEFORE FOUNDATION CONSTRUCTION BEGINS.

PILE FOUNDATIONS: FOUNDATION DESIGN IS BASED ON THE GEOTECHNICAL RECOMMENDATIONS IN THE REPORT PREPARED BY: ALLIED ENGINEERING & TESTING. PROJECT NUMBER: 48-6657. DATED: MARCH 06, 2009. FOUNDATION DESIGN IS BASED ON 12"X12" PILES. PILES SHALL BE DRIVEN A MINIMUM OF 30 FEET INTO BEARING STRATA AND ACHIEVE A MINIMUM SAFE BEARING CAPACITY OF 10 TONS AS COMPUTED BY AN APPROPRIATE DRIVING FORMULA. PILE DRIVING OPERATIONS SHALL BE PERFORMED UNDER THE SUPERVISION OF A FLORIDA REGISTERED PROFESSIONAL ENGINEER.

SUBMITTALS: SHOP DRAWINGS SHALL BE SUBMITTED TO THE ENGINEER PRIOR TO FABRICATION AND CONSTRUCTION REGARDING ALL STRUCTURAL ITEMS INCLUDING THE FOLLOWING:

CONCRETE MIX DESIGNS, CONCRETE REINFORCING.

SHOP DRAWINGS SHALL BE REVIEWED BY THE CONTRACTOR PRIOR TO SUBMITTAL TO THE ENGINEER. DRAWINGS SUBMITTED WITHOUT REVIEW WILL BE RETURNED UNCHECKED.

IF THE SHOP DRAWINGS DIFFER FROM OR ADD TO THE DESIGN OF THE STRUCTURAL DRAWINGS, THEY SHALL BEAR THE SEAL AND SIGNATURE OF A STRUCTURAL ENGINEER REGISTERED IN THE STATE OF FLORIDA. ANY CHANGES TO THE STRUCTURAL DRAWINGS SHALL BE SUBMITTED TO THE ENGINEER AND ARE SUBJECT TO THE REVIEW AND ACCEPTANCE OF

DESIGN DRAWINGS, SHOP DRAWINGS, AND CALCULATIONS FOR THE DESIGN AND FABRICATION OF ITEMS THAT ARE DESIGNED BY OTHERS. INCLUDING:

### PRECAST PRESTRESSED CONCRETE MEMBERS,

SHALL BEAR THE SEAL AND SIGNATURE OF A STRUCTURAL ENGINEER REGISTERED IN THE STATE OF FLORIDA AND SHALL BE SUBMITTED TO THE ENGINEER PRIOR TO FABRICATION. CALCULATIONS SHALL BE INCLUDED FOR ALL CONNECTIONS TO THE STRUCTURE, CONSIDERING LOCALIZED EFFECTS ON THE STRUCTURAL ELEMENTS INDUCED BY THE CONNECTION LOADS. DESIGN SHALL BE BASED ON THE REQUIREMENTS OF THE 2017 FBC.

SHOP DRAWINGS WILL BE REVIEWED FOR GENERAL COMPLIANCE WITH THE DESIGN INTENT OF THE CONTRACT DOCUMENTS ONLY. IT SHALL BE THE RESPONSIBILITY OF THE CONTRACTOR TO VERIFY COMPLIANCE WITH THE CONTRACT DOCUMENTS AS TO OUANTITY, LENGTH, ELEVATIONS, DIMENSIONS, ETC. CONTRACTOR SHALL NOT BE RELIEVED FROM RESPONSIBILITY FOR ERRORS OR OMISSIONS IN SHOP DRAWINGS OR MIX DESIGNS BY THE ENGINEER'S REVIEW

PRECAST CONCRETE PILES: CONCRETE PILES SHALL BE 12"X12". ALL PILING SHALL BE DRIVEN OR JETTED AND DRIVEN TO A SAFE BEARING CAPACITY OF 10 TONS USING AN APPROPRIATE DRIVING FORMULA AS SPECIFIED IN THE GEOTECHNICAL REPORT. PILES TO BE CUT OFF SQUARE AT PROPER ELEVATIONS. DRILL AND EPOXY (4) #5 HOOKED DOWEL IN TOP OF PILE AND EXTEND INTO THE PILE CAPS.

PILE MONITORING: AN INDEPENDENT GEOTECHNICAL CONSULTANT (ARDAMAN AND ASSOCIATES) SHALL BE RETAINED TO MONITOR PILE INSTALLATION AND VERIFY LOAD CAPACITY.

CONCRETE: REINFORCED CONCRETE CONSTRUCTION SHALL CONFORM TO THE FBC AND ACI 318 "BUILDING CODE REQUIREMENTS FOR REINFORCED CONCRETE". CONCRETE STRENGTHS SHALL BE VERIFIED BY STANDARD 28-DAY CYLINDER TESTS PER ASTM C39, AND SHALL BE AS FOLLOWS:

ALL USES, U.N.O. 4000 PSI

CEMENT SHALL CONFORM TO ASTM C150, TYPE 1. FLY ASH CONFORMING TO ASTM C618, TYPE F OR TYPE C, MAY BE USED TO REPLACE UP TO 20% OF THE CEMENT CONTENT, PROVIDED THAT THE MIX STRENGTH IS SUBSTANTIATED BY TEST DATA. COARSE AGGREGATE SHALL CONFORM TO ASTM C33 WITH A MAXIMUM SIZE OF 3/4". FINE AGGREGATE SHALL BE CLEAN, DURABLE, NATURAL SAND CONFORMING TO ASTM C33.

A WATER-REDUCING ADMIXTURE, IF USED, SHALL CONFORM TO ASTM C494 AND USED IN STRICT ACCORDANCE WITH THE MANUFACTURER'S RECOMMENDATIONS, SHALL BE INCORPORATED IN CONCRETE DESIGN MIXES. A HIGH-RANGE WATER-REDUCING ADMIXTURE CONFORMING TO ASTM C494, TYPE F OR G, MAY BE USED IN CONCRETE MIXES, PROVIDING THAT THE SLUMP DOES NOT EXCEED 8".

PROVIDE 3/4" CHAMFERS ON ALL EXPOSED CONCRETE EDGES

ALL CONCRETE SHALL BE CURED IMMEDIATELY AFTER FINISHING OPERATIONS.

REINFORCING STEEL: REINFORCING STEEL SHALL CONFORM TO ASTM A615, GRADE 60, FOR DEFORMED BAR. REINFORCING STEEL SHALL BE SECURELY TIED IN PLACE WITH #16 ANNEALED IRON WIRE.

ALL DETAILING AND ACCESSORIES SHALL CONFORM TO ACI DETAILING MANUAL SP-66. PROVIDE CHAIRS, SPACERS, BOLSTERS, AND ITEMS IN CONTACT WITH FORMS WITH HOT-DIP GALVANIZED LEGS OR PLASTIC LEGS. ACCURATELY POSITION, SUPPORT, AND SECURE REINFORCEMENT AGAINST DISPLACEMENT BY FORMWORK CONSTRUCTION OR CONCRETE PLACEMENT OPERATIONS. "WET-STICKING" OF REINFORCING IS PROHIBITED

REQUIRED CONCRETE COVER FOR REINFORCING STEEL (UNLESS NOTED OTHERWISE):

3" BOTTOM AND SIDES, 2" TOP

COLUMNS 1-1/2" TO TIES

**BEAMS** 1-1/2" TO STIRRUPS

WALLS

ADHESIVE ANCHORS: ADHESIVE ANCHORS (EPOXY STYLE) SHALL HAVE THE ICC ES EVALUATION REPORT INDICATING CONFORMANCE WITH CURRENT APPLICABLE ICC ES ACCEPTANCE CRITERIA. ADHESIVE SHALL BE MOISTURE INSENSITIVE, ALLOWING INSTALLATIONS IN DAMP OR WATER-FILLED HOLES. ADHESIVE SHALL HAVE A FULL-CURE LOAD OF 2 HOURS OR LESS AT 70°F.

ACCEPTABLE ADHESIVES ARE HILTI RE500 V3, OR DEWALT PURE110+, SIMPSON SET-3G.


INSTALLATION SHALL BE IN CONFORMANCE WITH MANUFACTURER'S PRINTED INSTALLATION INSTRUCTIONS. EMBEDMENT SHALL BE AS INDICATED ON THE STRUCTURAL DRAWINGS

HIS DRAWING CONTAINS DETAILS DESIGNED BY STANDARD TO AND EURNISHED SELECT STRUCTURAL

SAID DETAILS WERE NOT DESIGNED BY JOHNSON ENGINEERIN



RSW TRANSMISSION LINE
- BEN HILL/TREELINE
LEE COUNTY, FLORIDA

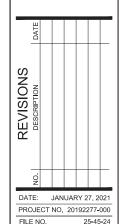

SHAWN ANDERSON, PE, SE FL License No. 53515

**Aerial Crossings** Structural Notes

AS SHOWN

SCALE:

SHEET NUMBER

D-04


SAID DETAILS WERE NOT DESIGNED BY JOHNSON ENGINEERING.


Phone: (239) 210 6 Project No.: 18000 Certification Auth. 3 SELECT STRUCTURAL


> COUNTY ST FLORIDA

LEE (

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- BEN HILL/TREELINE
LEE COUNTY, FLORIDA

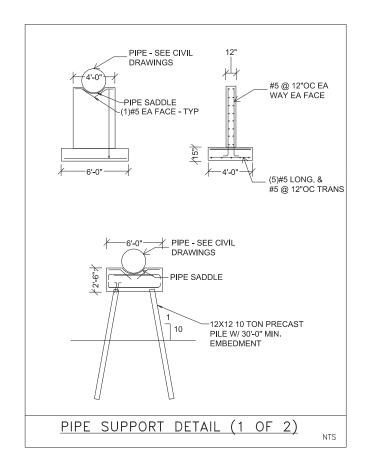


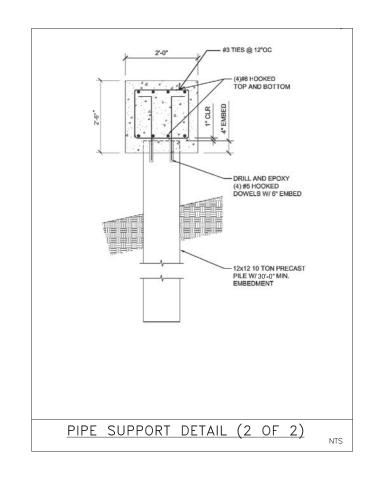

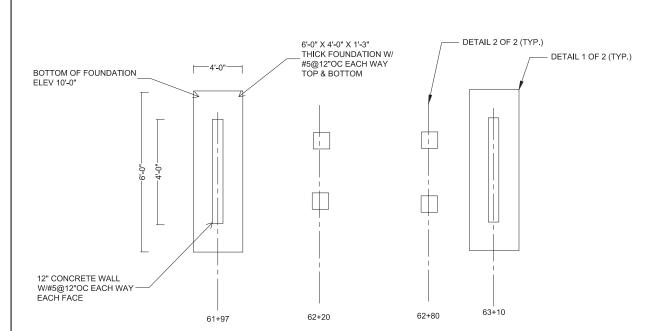

FOUNDATION PLAN

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SHEET NUMBER

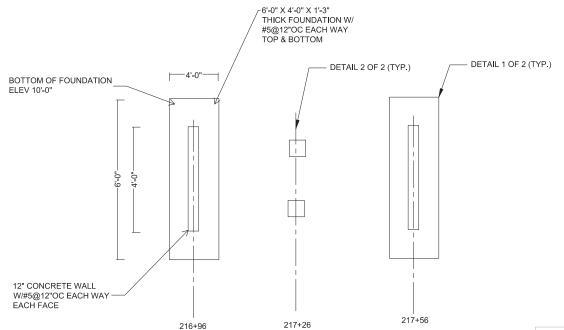REVISIONS DESCRIPTION

FILE NO.

SCALE:

D-05

DATE: JANUARY 27, 2021
PROJECT NO. 20192277-000

Aerial Crossings

Structural Details

25-45-24

AS SHOWN

FOUNDATION PLAN